

NOT TO SCALE

	BREVIATIONS
	ICABLE TO ENTIRE PLAN SET
AC APPROX	ACRE APPROXIMATE
B-B	BACK-TO-BACK
ВМ	BOOK OF MAPS
СВ	CATCH BASIN
CIP	CAST IRON PIPE
CL	CENTERLINE
со	CLEANOUT
CONC	CONCRETE
COR	CITY OF RALEIGH
CP DB	COMPUTED POINT DEED BOOK
DIP	DUCTILE IRON PIPE
DTL	DETAIL
ECM	EX CONC MONUMENT
EIP	EX IRON PIPE
EIR	EX IRON ROD
ELEC	ELECTRIC
ELEV	ELEVATION
EMAG	EX MAG NAIL
EOP	EDGE OF PAVEMENT
ESMT	EASEMENT
FDC	EXISTING
FEMA	FIRE DEPARTMENT CONNECTION FEDERAL EMERGENCY
	MANAGEMENT AGENCY
FH	FIRE HYDRANT
FM	FORCE MAIN
FP	FLOODPLAIN
GIS	GEOGRAPHIC INFORMATION SYSTEM
GM	GAS METER
GP	GALVANIZED PIPE
GW	GUY ANCHOR
НВ	нот вох
HDPE	HIGH DENSITY POLYETHYLENE
IPS	IRON PIPE SET
LF LP	LINEAR FEET
LOC	LIGHT POLE LOCATION
MAGS	MAG NAIL SET
MH	MANHOLE
MW	MONITORING WELL
N/F	NOW OR FORMERLY
NCDOT	NORTH CAROLINA DEPARTMENT
PG	OF TRANSPORTATION PAGE
PP	POWER POLE
PROP	PROPOSED
PVC	POLYVINYL CHLORIDE
RCP	REINFORCED CONC PIPE
ROW	BIO. 17 AF
R/W	RIGHT-OF-WAY
RSDM	RALEIGH STREET DESIGN
SF	MANUAL SQUARE FEET
SS	SANITARY SEWER
STD	STANDARD
SWM	STORMWATER MANAGEMENT
TBD	TO BE DETERMINED
TBR	TO BE REMOVED
TBRL	TO BE RELOCATED
TF	ELECTRIC TRANSFORMER
TP	TELEPHONE PEDESTAL
TYP	TYPICAL
UDO	UNIFIED DEVELOPMENT ORDINANCE
UNK	UNKNOWN

VITRIFIED CLAY PIPE

WATER VALVE

WATER LINE ESMT

WATER METER

	SPOT KEY
ВС	BOTTOM OF CURB
BR	BOTTOM OF RISER
BW	BOTTOM OF WALL
FFE	FINISHED FLOOR ELEVATION
G	GRADE
HP	HIGH POINT
LP	LOW POINT
TC	TOP OF CURB
TR	TOP OF RISER
TW	TOP OF WALL

A-MASTER TEAM TOWNHOMES

CONSTRUCTION DOCUMENTS

151 GRAND ROCK WAY ROLESVILLE, NORTH CAROLINA 27571


> JUNE 22, 2020 SEPTEMBER 29, 2020 JANUARY 21, 2021



OWNER:

A-MASTER TEAM, LLC

6200 FALLS OF NEUSE ROAD; SUITE 10 RALEIGH, NC 27609 W. HAROLD PERRY - MANAGER E-mail: HALPERRY@REMC.US

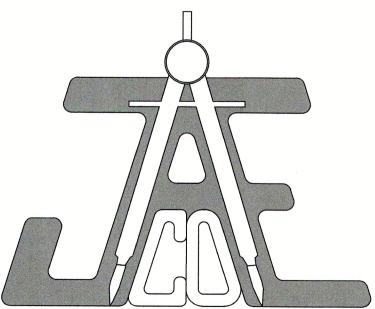

CIVIL ENGINEER:

JAECO

Consulting Engineers
NC License F-0289
333 Wade Ave., Raleigh, N.C. 27605
Phone: (919) 828-4428
Fax: (919) 828-4711
E-mail: info@jaeco.com

		SI	TE DAT	TA TABLE		
ADDRESS		151 GRAND ROCK WAY ROLESVILLE, NC 27571				
W	AKE COUN	TY PIN		1759.20-70-7093		
PR	OPOSED Z	ONING	v v	CO-SUD	***************************************	
TC	TAL TRAC	ΓAREA		324,170 SF (7.4419 AC)		
PR	OPOSED R	ESIDENTIAL AF	REA*	261,043 SF (5.9927 AC)		
MA	X. ALLOWE	ED UNITS*		59		
PR	OPOSED U	NITS		47		ENGINE TO THE PARTY OF THE PART
			PARKING CA	ALCULATIONS	A Paper Speed House, State of Management	
					S	SPACE
Ω	TOWNHO	MES	2	SPACES / 2 BR UNIT * 47 UNIT	S =	94
JRE	VISITOR		1 SPACE / 4 UNITS * 47 UNITS		S =	12
REQUIRED	MAIL KIOS	SK	4 SPACES (INCLUDING 1 ADA VA		AN)	4
22				тот	AL	110
			PROPOS	ED	111	
		В	ASE DIMENSIO	NAL STANDARDS		
FRONT YARD SETBACK			20'			
SIDE YARD SETBACK			15'			
CC	CORNER YARD SETBACK		25'			
RE	REAR YARD SETBACK		35'			
			RECREATION	& OPEN SPACE		
			REQUIRED PROV		VIDE	
ΛP	EN SDACE		15% * 261,043 SF = 39,157 SF		42,566 SF	
OPEN SPACE			UNIMPROVED	28,8	345 SI	
RE	RECREATION SPACE 35%		35%	* 39,157 = 13,705 SF	13,7	721 SI
			UTIL	ITIES		
STUBS		STUBS		49		
			GTH (SIZE) 1,150 LF (6")			
	WATER	PUBLIC LENG	TH (SIZE)	1,150 LF (6")		

OLF

770 LF (8")

	SHEET INDEX
SHEET NUMBER	SHEET TITLE
C-0.0	COVER
C-1.0	EXISTING CONDITIONS & DEMOLITION PLAN
C-2.0	SITE PLAN
C-3.1	EROSION AND SEDIMENT CONTROL PLAN - PHASE I
C-3.2	EROSION AND SEDIMENT CONTROL PLAN - PHASE II
C-4.1	UTILITY PLAN
C-4.2	ROLESVILLE RIDGE RD PLAN & PROFILE
C-5.0	SHORT RIDGE WAY PLAN & PROFILE
C-6.0	GRADING PLAN
C-7.0	STORMDRAIN & STORMWATER MANAGEMENT PLAN
C-8.1	OUTFALL PROFILES
C-8.2	LANDSCAPE PLAN
C-9.1	POND PLANTING, DETAILS, & PLANT LIST
C-9.2	SITE DETAILS
C-9.3	NCG01 NOTES AND DETAILS
C-9.4	NCG01 NOTES AND DETAILS
C-9.5	EROSION CONTROL DETAILS
C-9.6	STORMDRAIN DETAILS
C-9.7	SANITARY DETAILS
C-9.7	WATER DETAILS


PRIVATE LENGTH (SIZE)


PUBLIC LENGTH (SIZE)

PRIVATE LENGTH (SIZE)

SEWER

*PER SUP 19-02

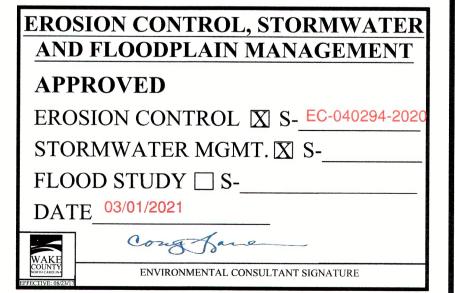


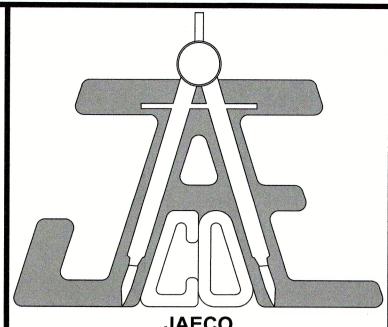

JAECO
Consulting Engineers and Land Surveyors

NC License F-0289
333 Wade Ave., Raleigh, N.C. 27605
Phone: (919) 828-4428
Fax: (919) 828-4711
E-mail: info@jaeco.com

www.jaeco.com

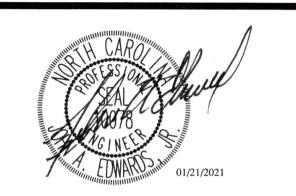

A-MASTER TEAM
TOWNHOMES
151 GRAND ROAD WAY
ROLESVILLE, NC 27571

A-MASTER TEAM, LLC 6200 FALLS OF NEUSE ROAD SUITE 10 RALEIGH, NC 27609

Call W before you dig.

LEGEND



APPROVED FOR COMPLIANCE

By: Dany Date: 3/4/202 |
These plans have been approved for compliance with the Town Code of Ordinance, UDO, and Standard Specifications & Construction Details, subject to statements & conditions hereby incorporated by reference.

PLANS NOT APPROVED FOR CONSTRUCTION UNLESS SIGNED BY CITY OF RALEIGH

The City of Raleigh consents to the connection and extension of the City's **Public Water System** as shown on this plan. The material and Construction methods used for this project shall conform to the standards and specifications of the City's Public Utilities Handbook.

City of Raleigh Public Utilities Department Permit # W-3745

The City of Raleigh consents to the connection to its public sewer system and extension of the **private sewer collection** system as shown on this plan. The material and constructions methods used for this project shall conform to the standards and specifications of the City's Public Utilities Handbook.

City of Raleigh Public Utilities Department Permit # S-4760(P)

CITY OF RALEIGH - PLANS AUTHORIZED FOR CONSTRUCTION

Electronic Approval: This approval is being issued electronically. This approval is valid only upon the signature of a City of Raleigh Review Officer below. The City will retain a copy of the approved plans. Any work authorized by this approval must proceed in accordance with the plans kept on file with the City. This electronic approval may not be edited once issued. Any modification to this approval once issued will invalidate this approval.

Raleigh Water Review Officer

City of Raleigh Development Approval


RAWN BY: TT


CHECKED BY: JAE, JR.


COVER


Number	Description	Date
1	PER TRC COMMENTS	09/29/2
2	PER TRC COMMENTS	01/21/2

C = 0.0

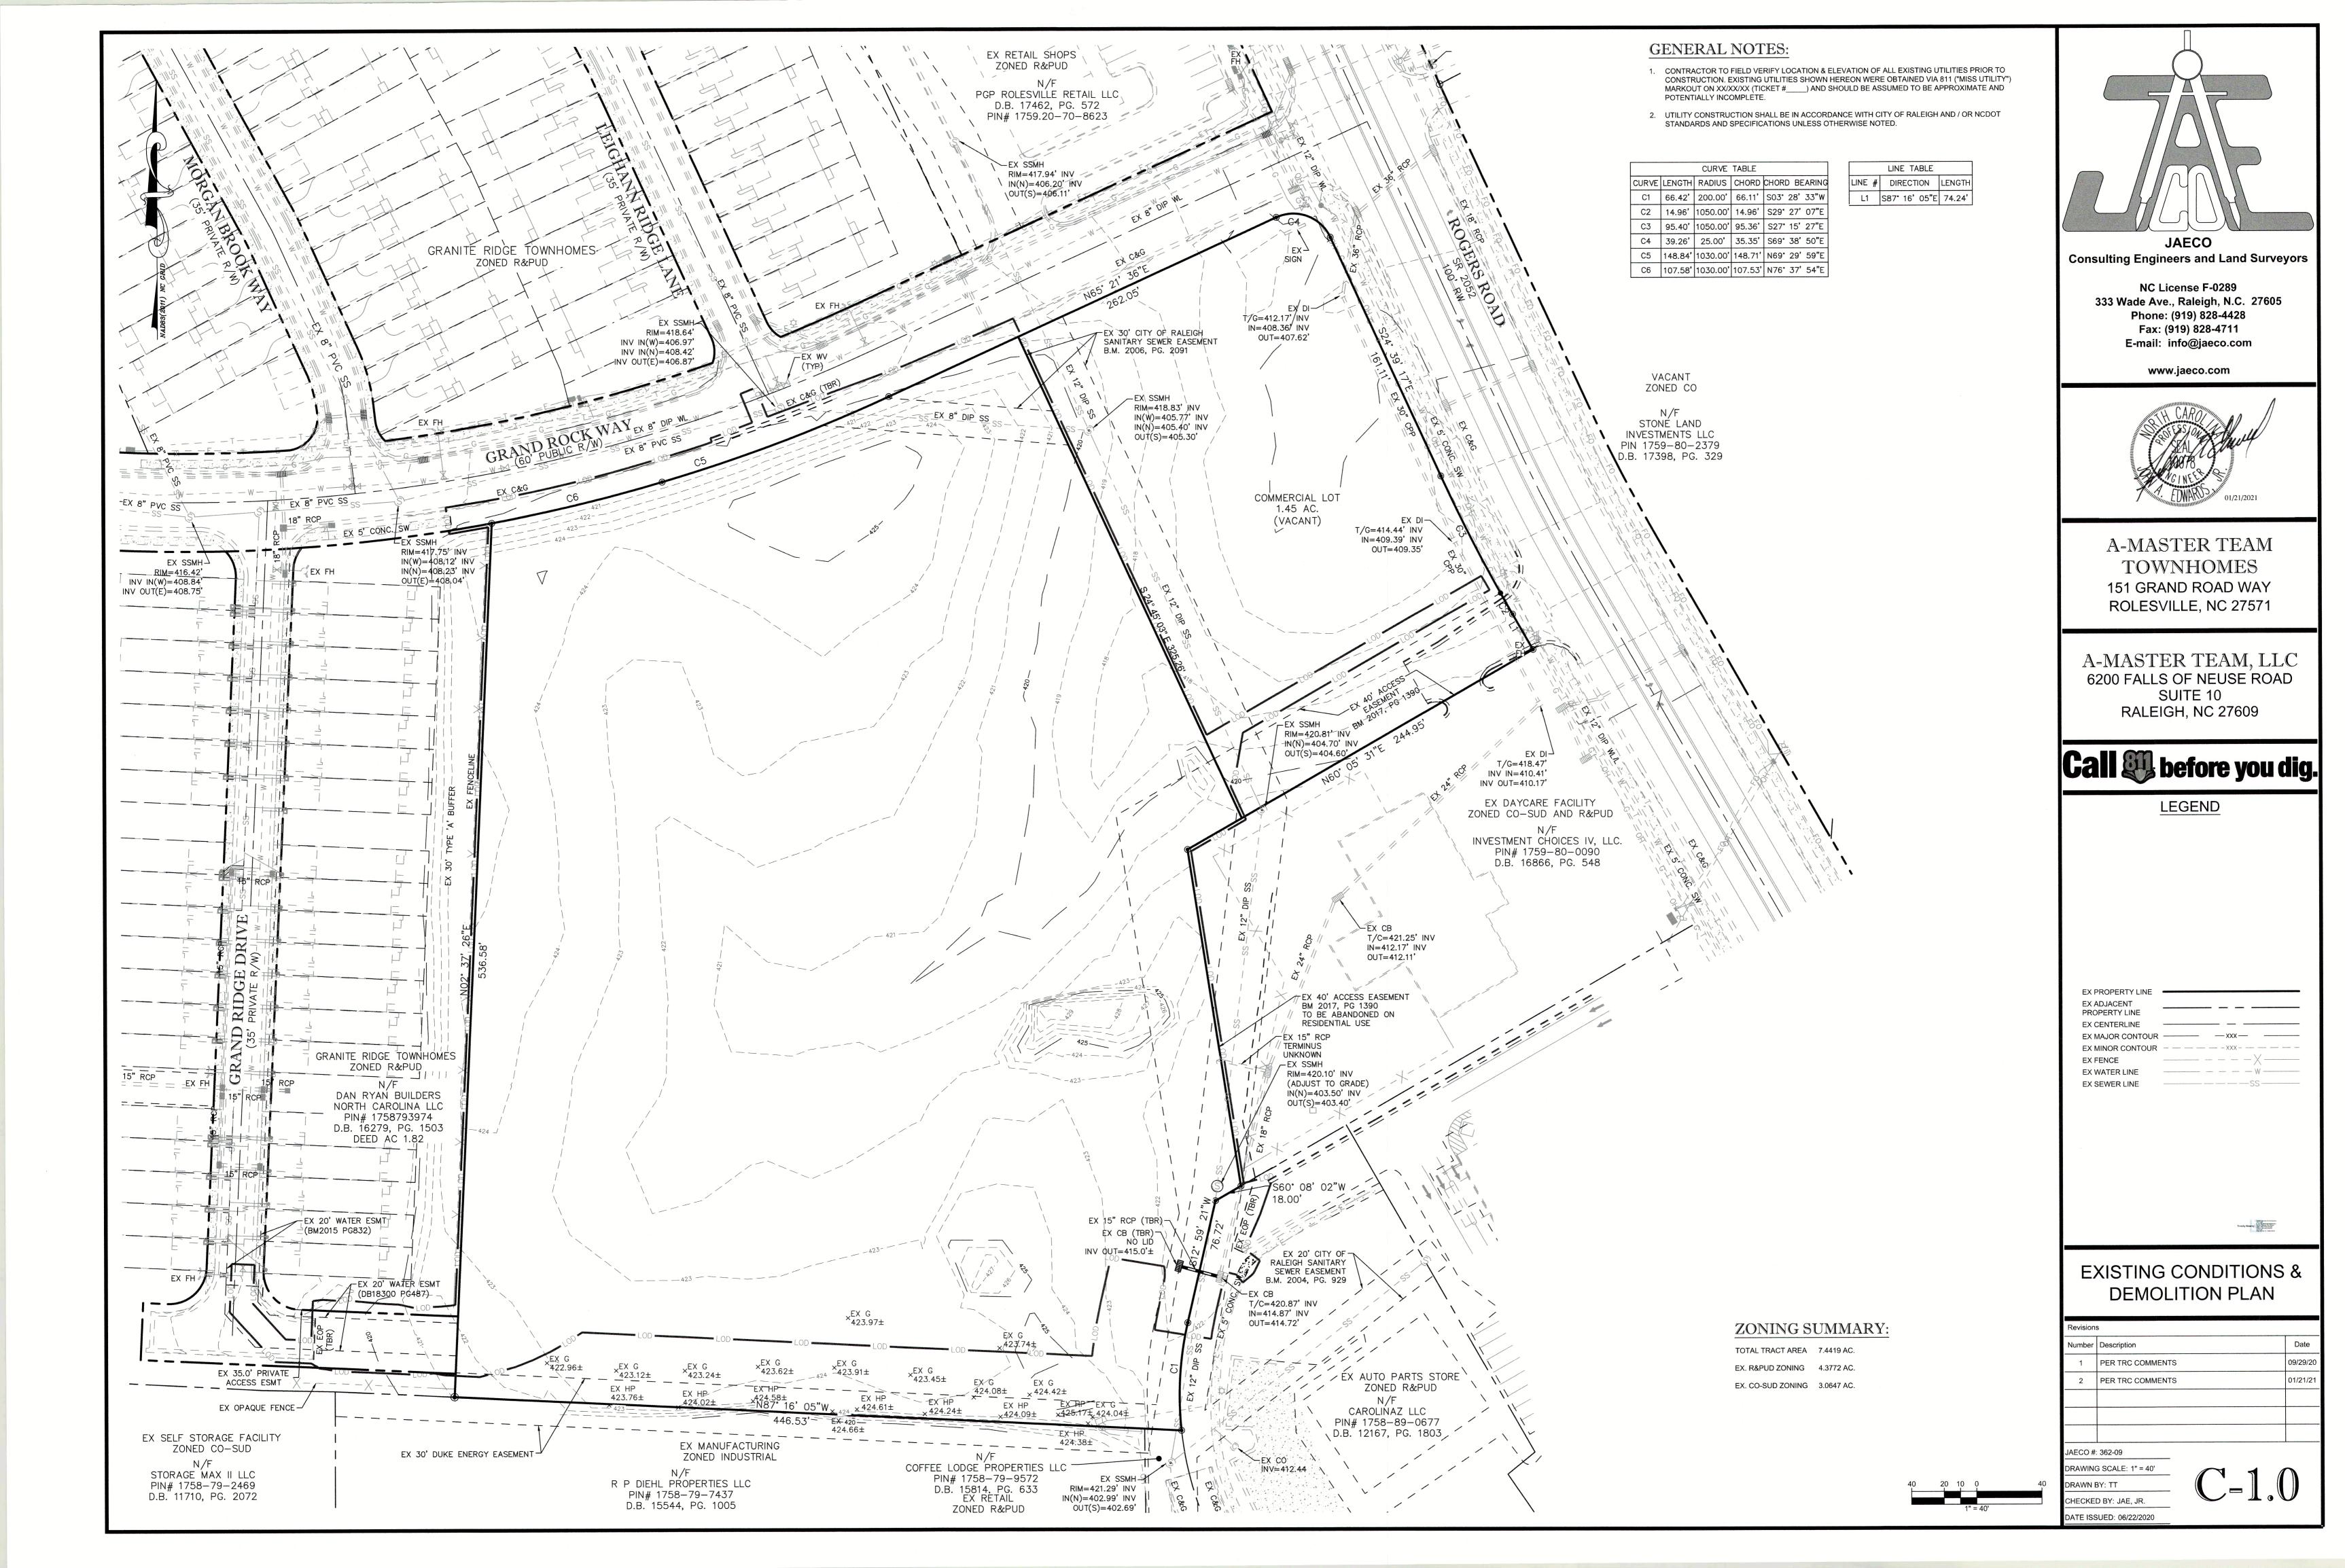

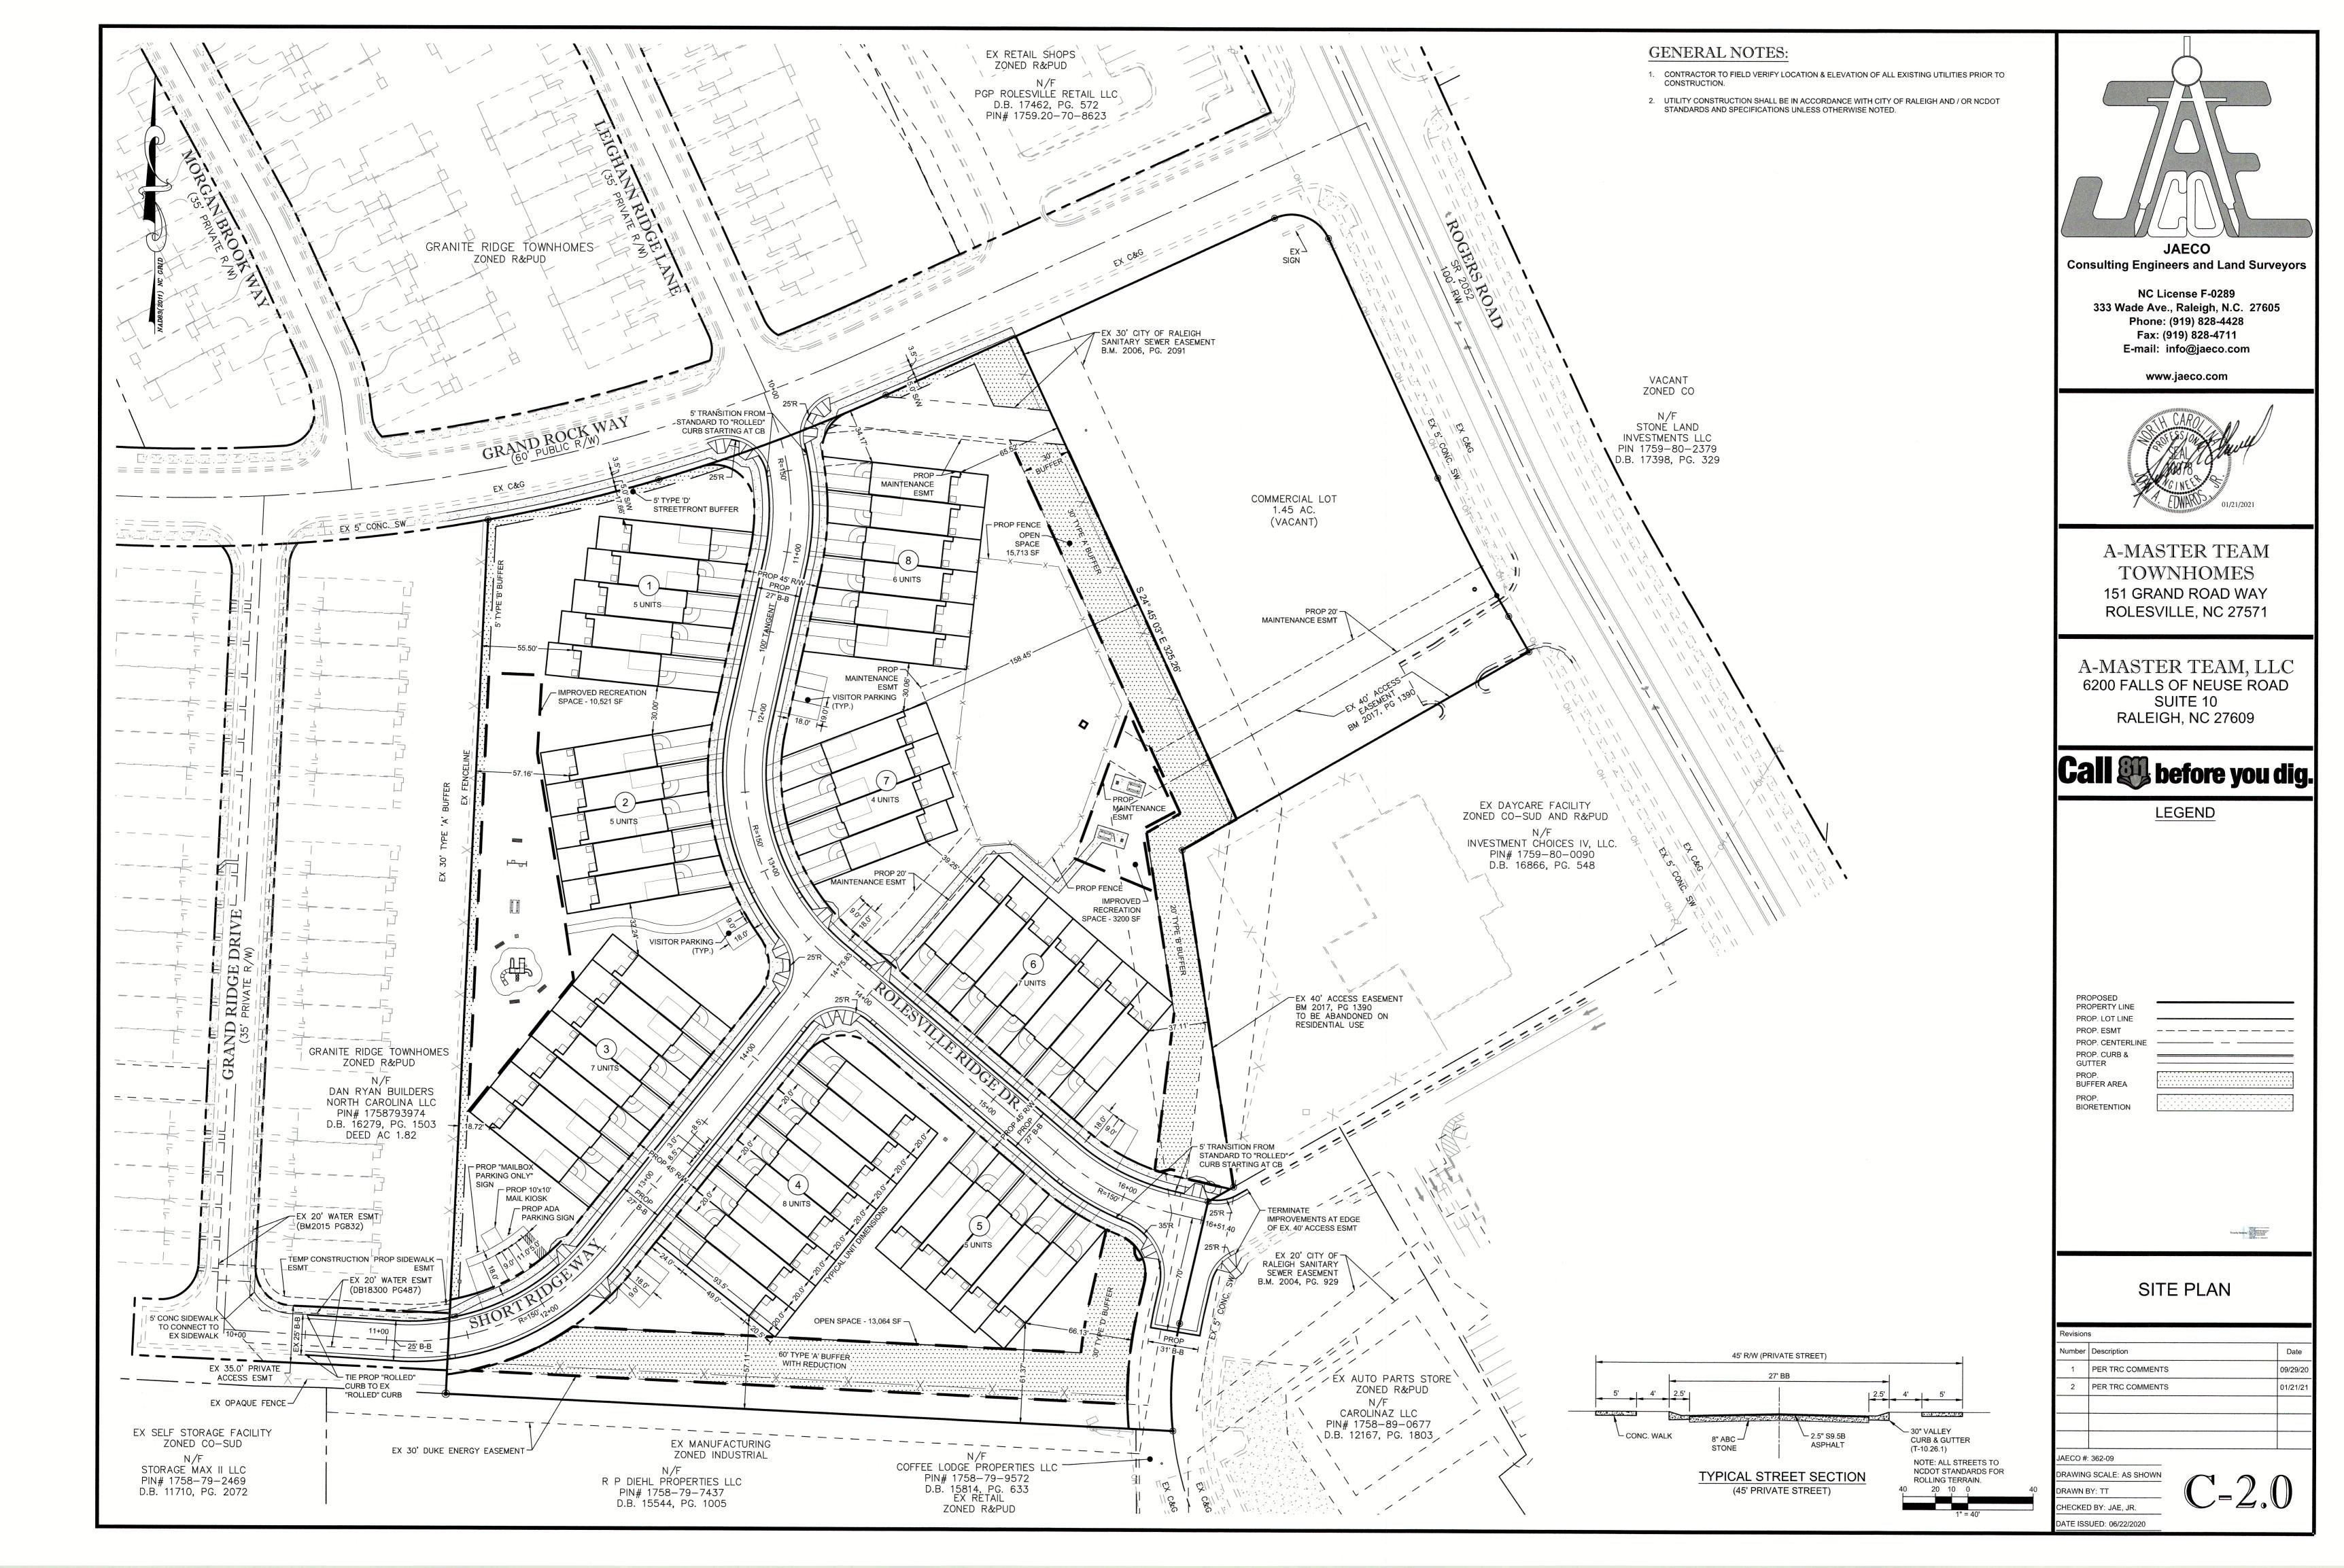

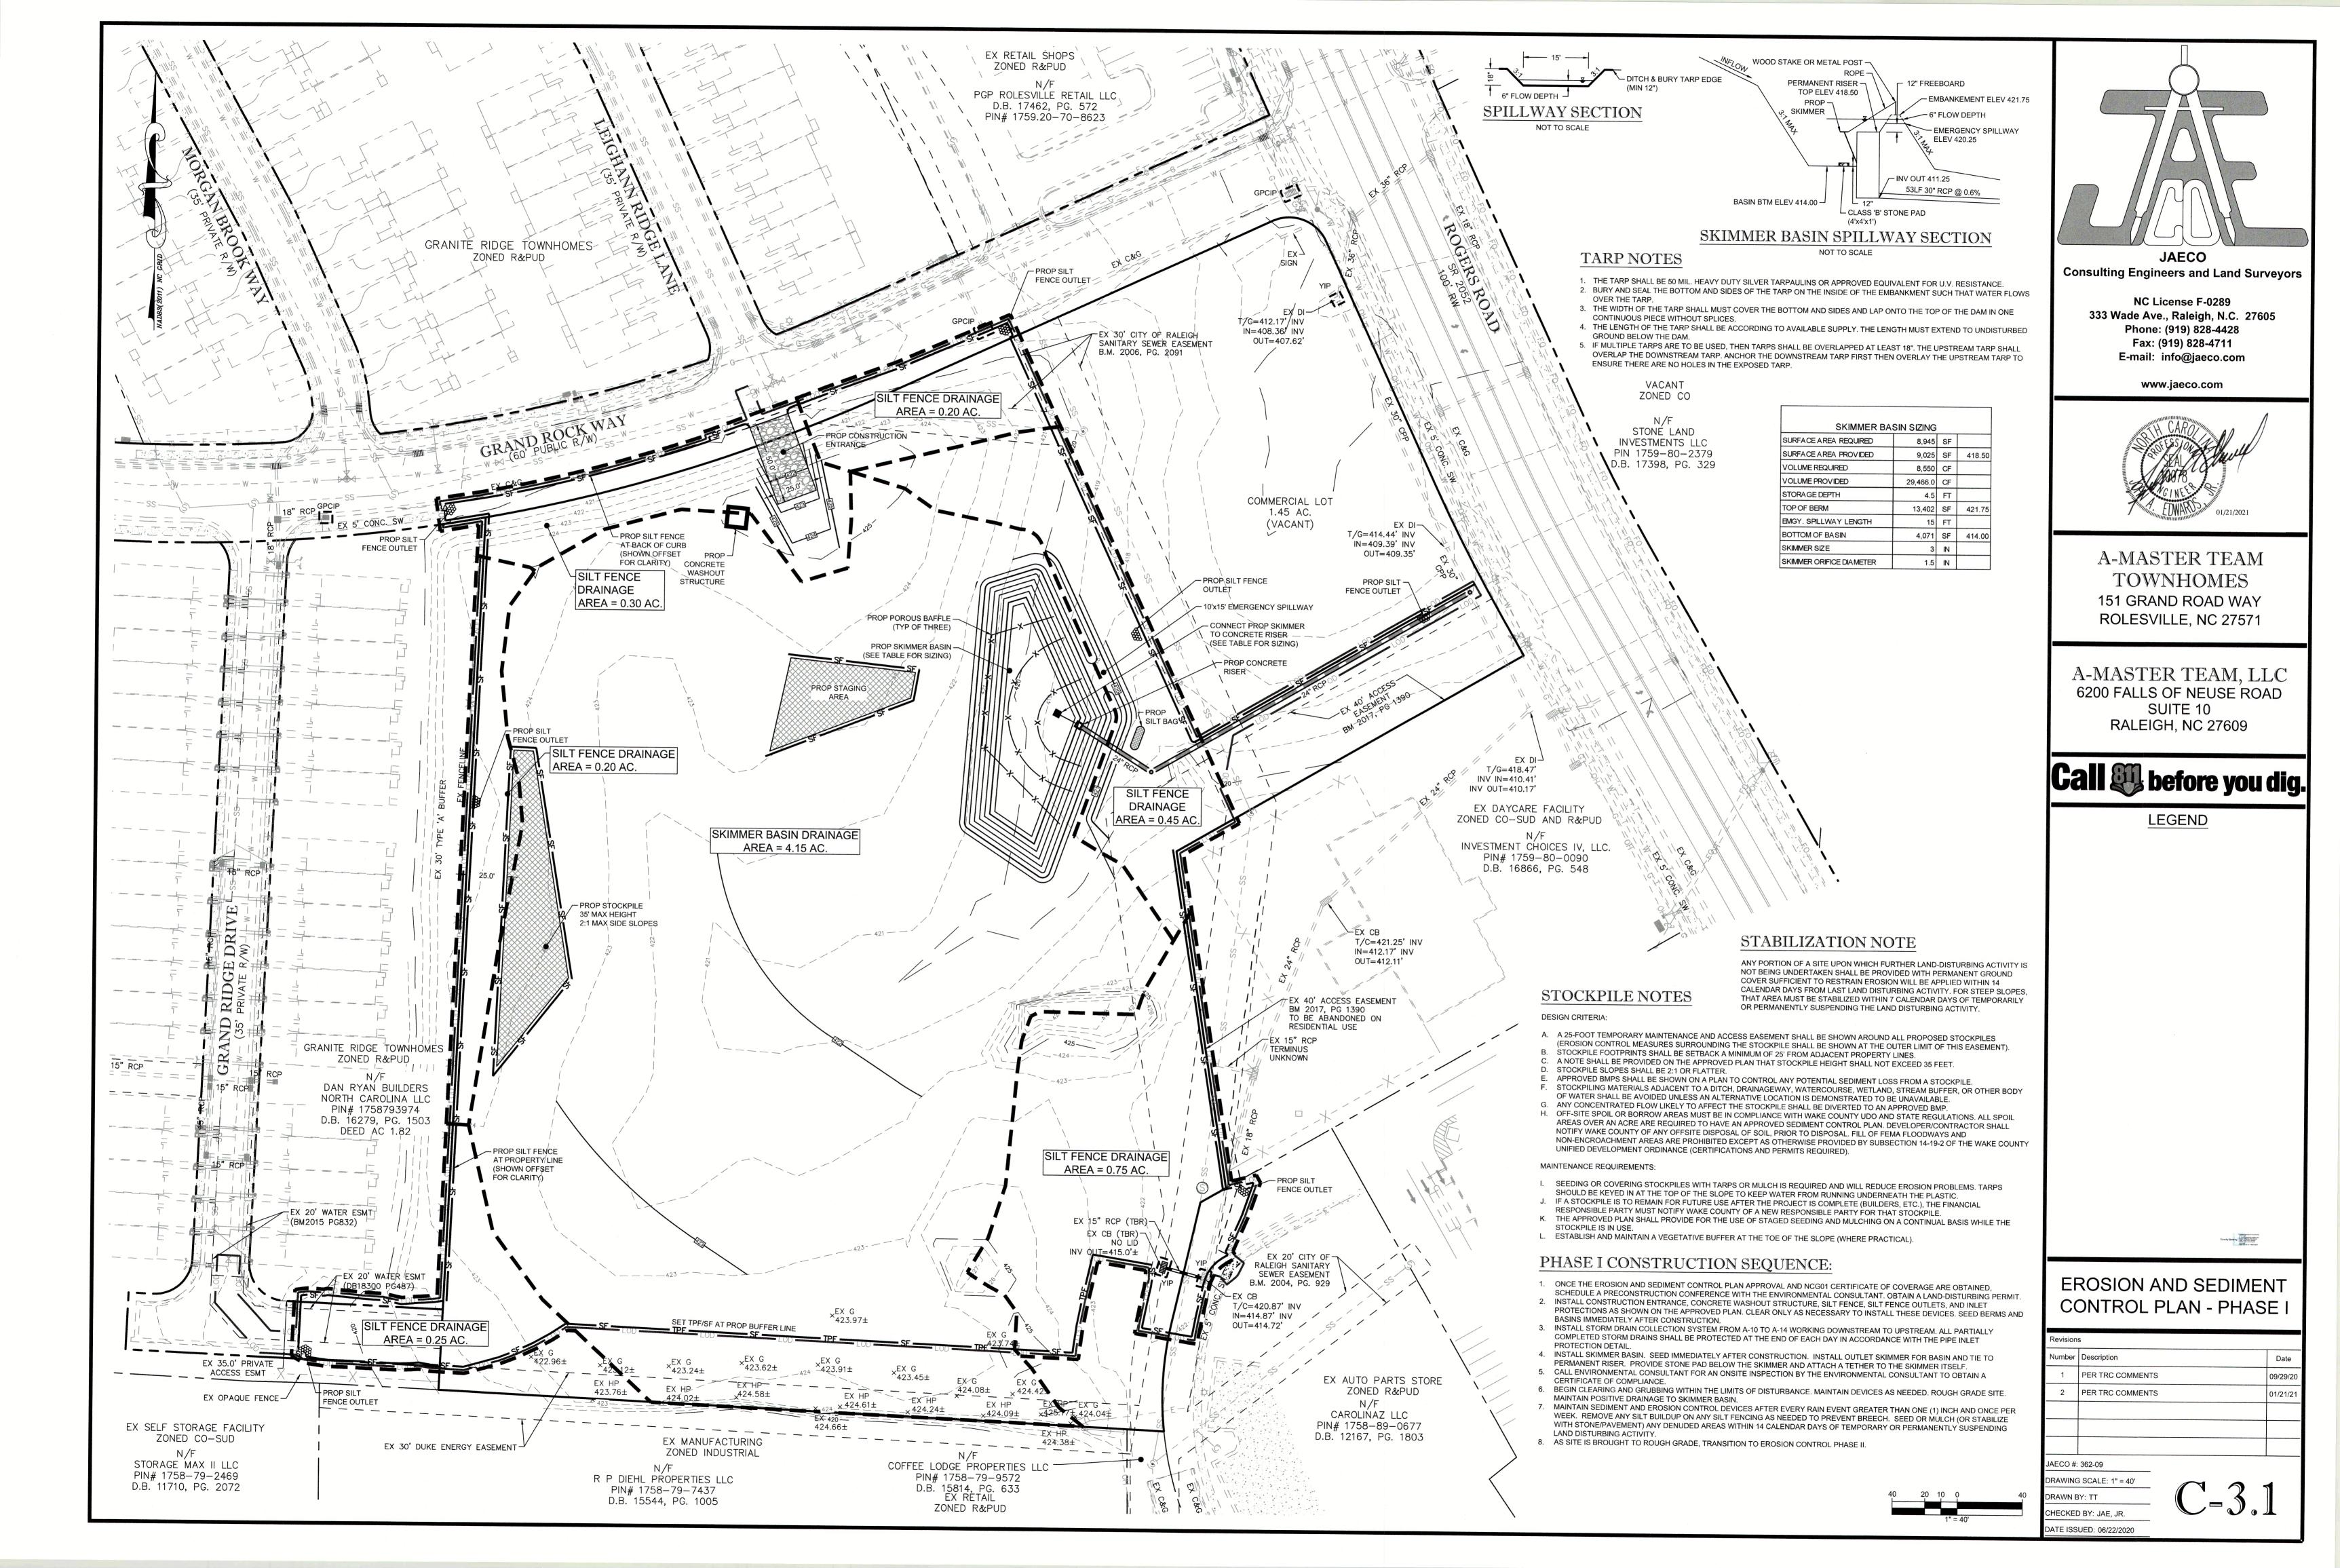

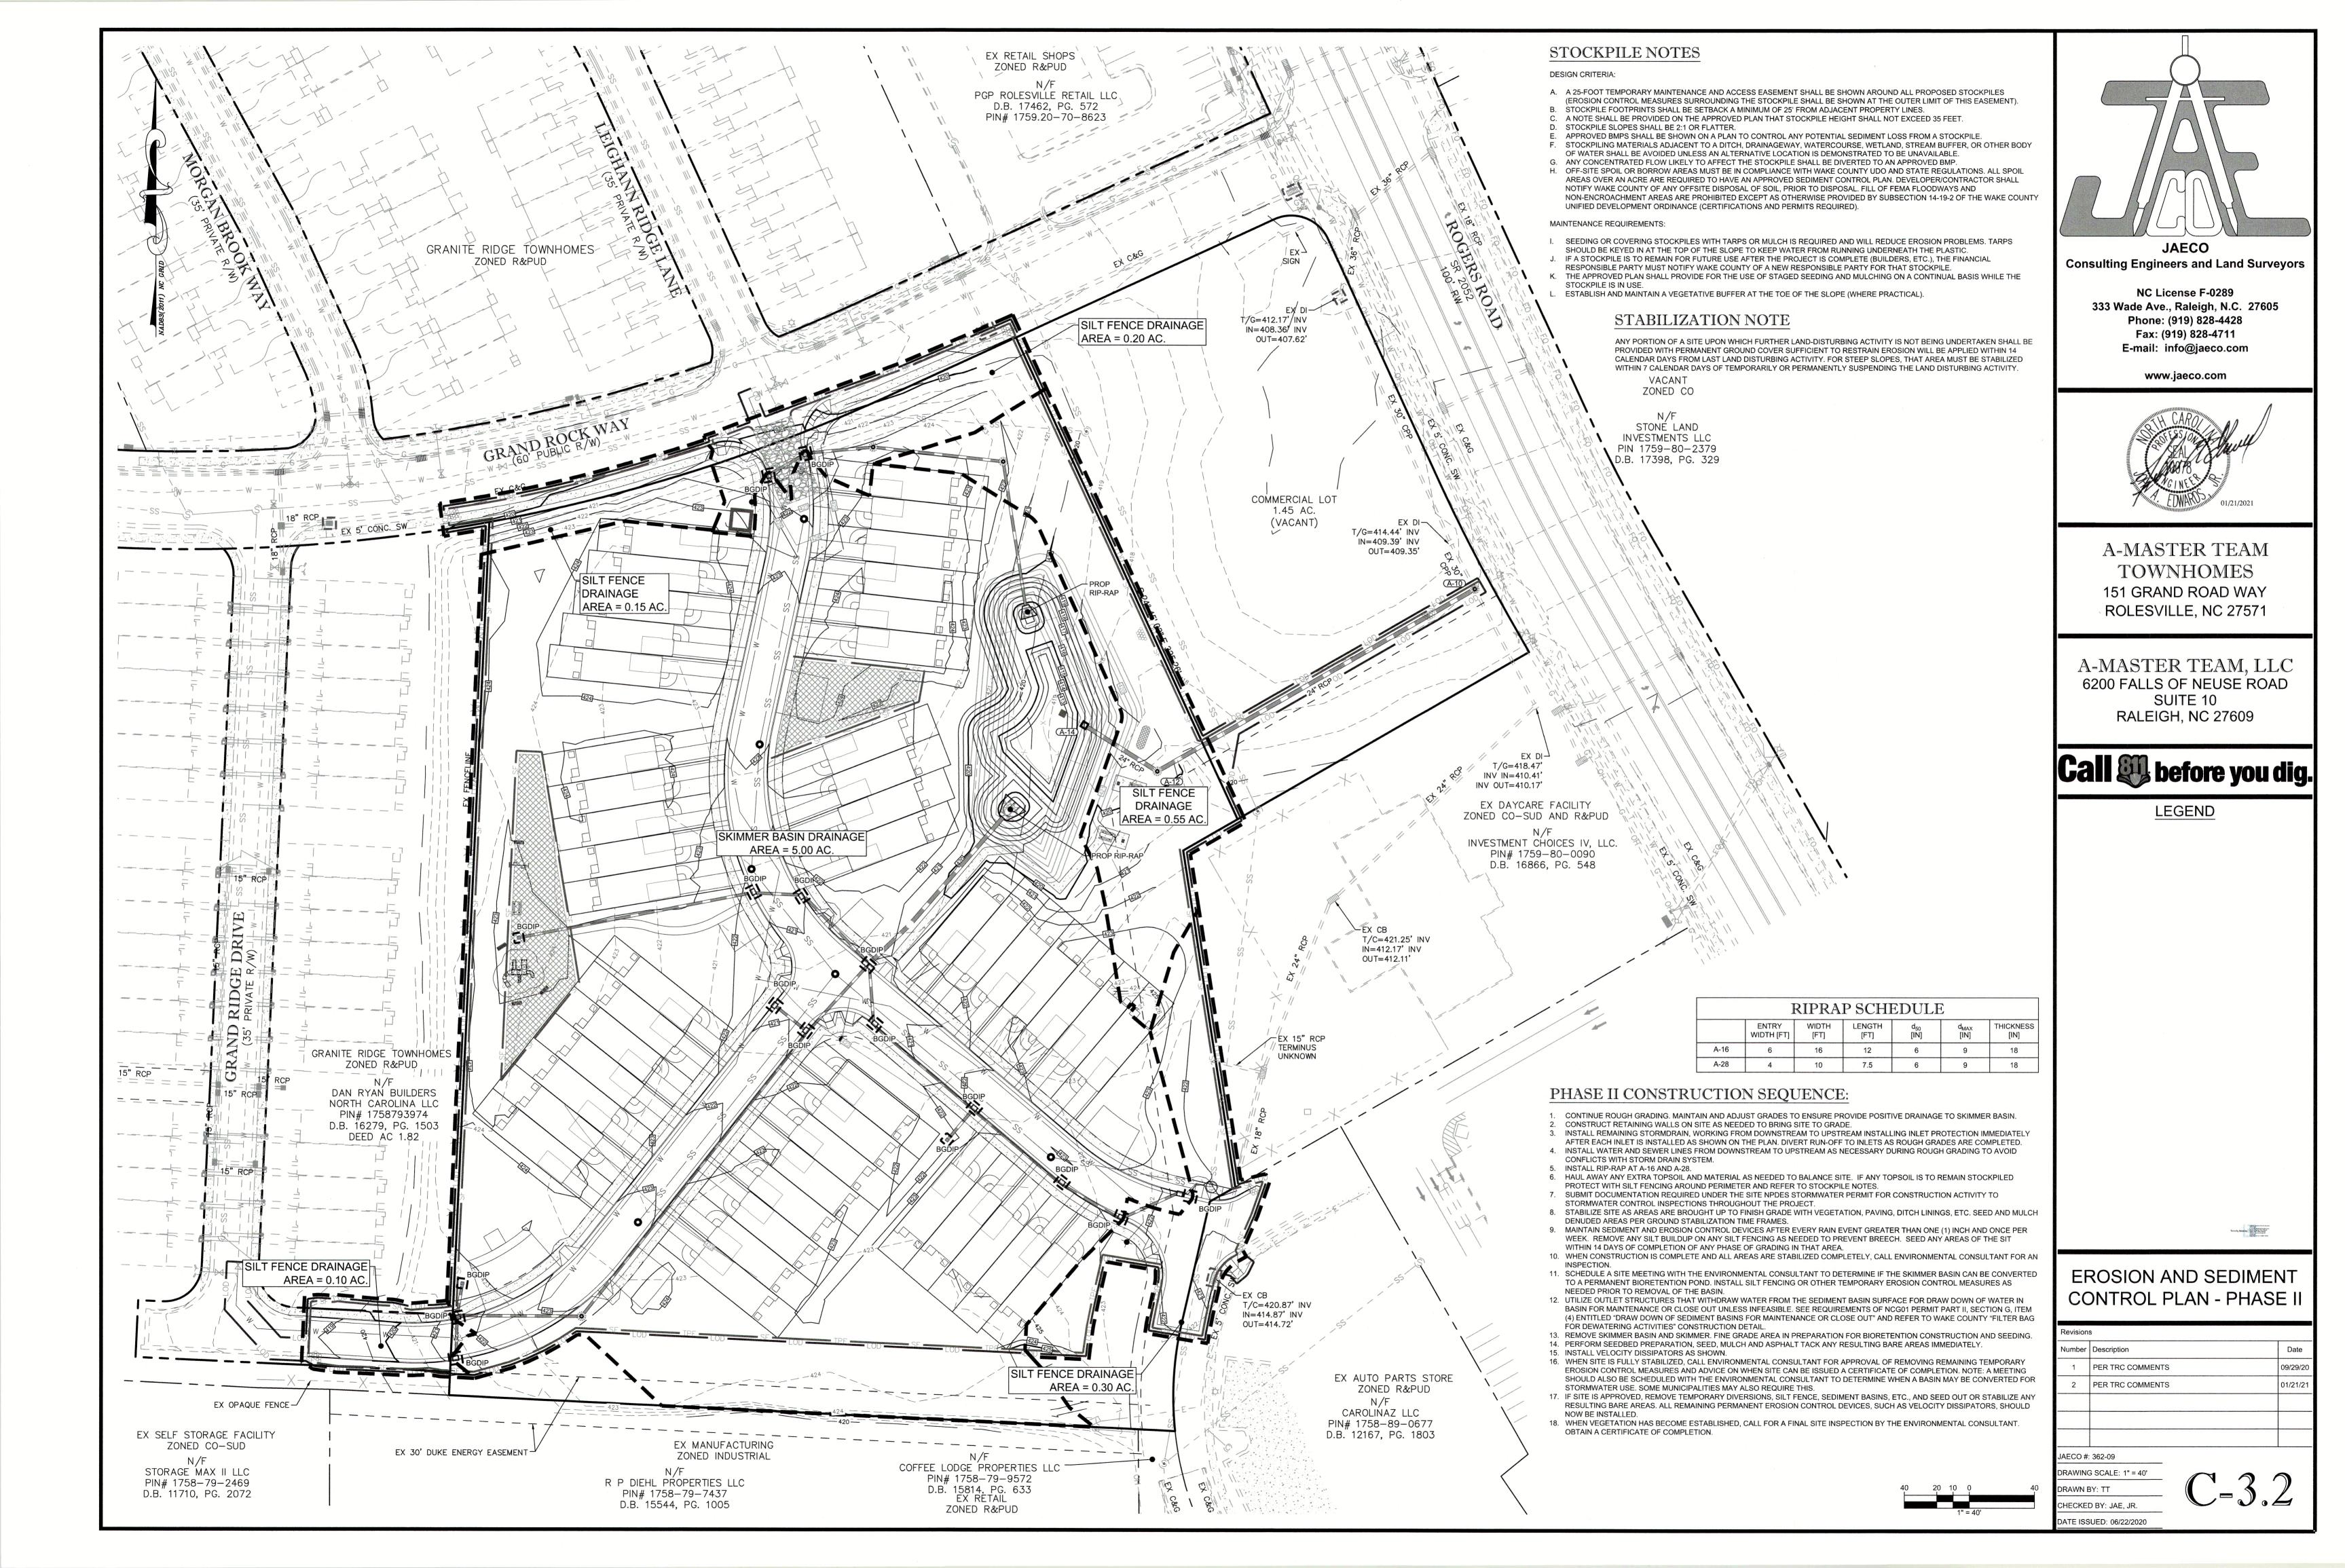



NOT TO SCALE

	BREVIATIONS
	ICABLE TO ENTIRE PLAN SET
AC APPROX	ACRE APPROXIMATE
B-B	BACK-TO-BACK
ВМ	BOOK OF MAPS
СВ	CATCH BASIN
CIP	CAST IRON PIPE
CL	CENTERLINE
со	CLEANOUT
CONC	CONCRETE
COR	CITY OF RALEIGH
CP DB	COMPUTED POINT DEED BOOK
DIP	DUCTILE IRON PIPE
DTL	DETAIL
ECM	EX CONC MONUMENT
EIP	EX IRON PIPE
EIR	EX IRON ROD
ELEC	ELECTRIC
ELEV	ELEVATION
EMAG	EX MAG NAIL
EOP	EDGE OF PAVEMENT
ESMT	EASEMENT
FDC	EXISTING
FEMA	FIRE DEPARTMENT CONNECTION FEDERAL EMERGENCY
	MANAGEMENT AGENCY
FH	FIRE HYDRANT
FM	FORCE MAIN
FP	FLOODPLAIN
GIS	GEOGRAPHIC INFORMATION SYSTEM
GM	GAS METER
GP	GALVANIZED PIPE
GW	GUY ANCHOR
НВ	нот вох
HDPE	HIGH DENSITY POLYETHYLENE
IPS	IRON PIPE SET
LF LP	LINEAR FEET
LOC	LIGHT POLE LOCATION
MAGS	MAG NAIL SET
MH	MANHOLE
MW	MONITORING WELL
N/F	NOW OR FORMERLY
NCDOT	NORTH CAROLINA DEPARTMENT
PG	OF TRANSPORTATION PAGE
PP	POWER POLE
PROP	PROPOSED
PVC	POLYVINYL CHLORIDE
RCP	REINFORCED CONC PIPE
ROW	BIO. 17 AF
R/W	RIGHT-OF-WAY
RSDM	RALEIGH STREET DESIGN
SF	MANUAL SQUARE FEET
SS	SANITARY SEWER
STD	STANDARD
SWM	STORMWATER MANAGEMENT
TBD	TO BE DETERMINED
TBR	TO BE REMOVED
TBRL	TO BE RELOCATED
TF	ELECTRIC TRANSFORMER
TP	TELEPHONE PEDESTAL
TYP	TYPICAL
UDO	UNIFIED DEVELOPMENT ORDINANCE
UNK	UNKNOWN

VITRIFIED CLAY PIPE

WATER VALVE

WATER LINE ESMT

WATER METER

	SPOT KEY
ВС	BOTTOM OF CURB
BR	BOTTOM OF RISER
BW	BOTTOM OF WALL
FFE	FINISHED FLOOR ELEVATION
G	GRADE
HP	HIGH POINT
LP	LOW POINT
TC	TOP OF CURB
TR	TOP OF RISER
TW	TOP OF WALL

A-MASTER TEAM TOWNHOMES

CONSTRUCTION DOCUMENTS

151 GRAND ROCK WAY ROLESVILLE, NORTH CAROLINA 27571


> JUNE 22, 2020 SEPTEMBER 29, 2020 JANUARY 21, 2021



OWNER:

A-MASTER TEAM, LLC

6200 FALLS OF NEUSE ROAD; SUITE 10 RALEIGH, NC 27609 W. HAROLD PERRY - MANAGER E-mail: HALPERRY@REMC.US

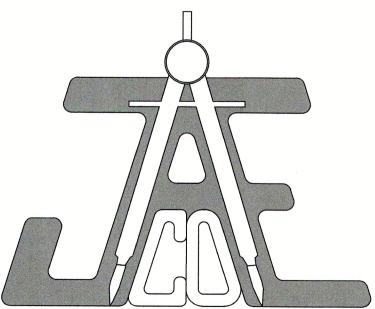

CIVIL ENGINEER:

JAECO

Consulting Engineers
NC License F-0289
333 Wade Ave., Raleigh, N.C. 27605
Phone: (919) 828-4428
Fax: (919) 828-4711
E-mail: info@jaeco.com

		SI	TE DAT	TA TABLE		
ADDRESS		151 GRAND ROCK WAY ROLESVILLE, NC 27571				
W	AKE COUN	TY PIN		1759.20-70-7093		
PR	OPOSED Z	ONING	v v	CO-SUD	***************************************	
TC	TAL TRAC	ΓAREA		324,170 SF (7.4419 AC)		
PR	OPOSED R	ESIDENTIAL AF	REA*	261,043 SF (5.9927 AC)		
MA	X. ALLOWE	ED UNITS*		59		
PR	OPOSED U	NITS		47		ENGINE TO THE PARTY OF THE PART
			PARKING CA	ALCULATIONS	A Paper Speed House, State of Management	
					S	SPACE
Ω	TOWNHO	MES	2	SPACES / 2 BR UNIT * 47 UNIT	S =	94
JRE	VISITOR		1 SPACE / 4 UNITS * 47 UNITS		S =	12
REQUIRED	MAIL KIOS	SK	4 SPACES (INCLUDING 1 ADA VA		AN)	4
22				тот	AL	110
			PROPOS	ED	111	
		В	ASE DIMENSIO	NAL STANDARDS		
FRONT YARD SETBACK			20'			
SIDE YARD SETBACK			15'			
CC	CORNER YARD SETBACK		25'			
RE	REAR YARD SETBACK		35'			
			RECREATION	& OPEN SPACE		
			REQUIRED PROV		VIDE	
ΛP	EN SDACE		15% * 261,043 SF = 39,157 SF		42,566 SF	
OPEN SPACE			UNIMPROVED	28,8	345 SI	
RE	RECREATION SPACE 35%		35%	* 39,157 = 13,705 SF	13,7	721 SI
			UTIL	ITIES		
STUBS		STUBS		49		
			GTH (SIZE) 1,150 LF (6")			
	WATER	PUBLIC LENG	TH (SIZE)	1,150 LF (6")		

OLF

770 LF (8")

	SHEET INDEX
SHEET NUMBER	SHEET TITLE
C-0.0	COVER
C-1.0	EXISTING CONDITIONS & DEMOLITION PLAN
C-2.0	SITE PLAN
C-3.1	EROSION AND SEDIMENT CONTROL PLAN - PHASE I
C-3.2	EROSION AND SEDIMENT CONTROL PLAN - PHASE II
C-4.1	UTILITY PLAN
C-4.2	ROLESVILLE RIDGE RD PLAN & PROFILE
C-5.0	SHORT RIDGE WAY PLAN & PROFILE
C-6.0	GRADING PLAN
C-7.0	STORMDRAIN & STORMWATER MANAGEMENT PLAN
C-8.1	OUTFALL PROFILES
C-8.2	LANDSCAPE PLAN
C-9.1	POND PLANTING, DETAILS, & PLANT LIST
C-9.2	SITE DETAILS
C-9.3	NCG01 NOTES AND DETAILS
C-9.4	NCG01 NOTES AND DETAILS
C-9.5	EROSION CONTROL DETAILS
C-9.6	STORMDRAIN DETAILS
C-9.7	SANITARY DETAILS
C-9.7	WATER DETAILS


PRIVATE LENGTH (SIZE)


PUBLIC LENGTH (SIZE)

PRIVATE LENGTH (SIZE)

SEWER

*PER SUP 19-02

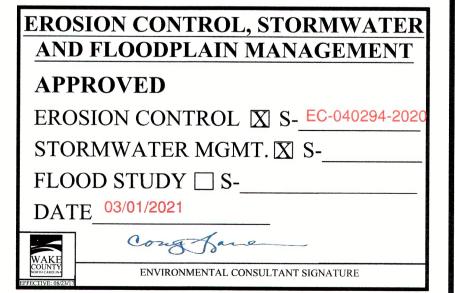


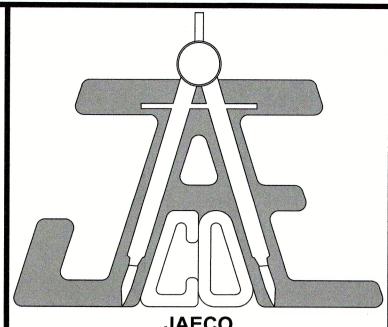

JAECO
Consulting Engineers and Land Surveyors

NC License F-0289
333 Wade Ave., Raleigh, N.C. 27605
Phone: (919) 828-4428
Fax: (919) 828-4711
E-mail: info@jaeco.com

www.jaeco.com

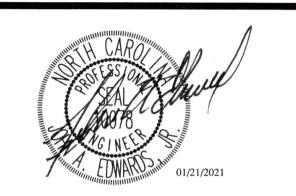

A-MASTER TEAM
TOWNHOMES
151 GRAND ROAD WAY
ROLESVILLE, NC 27571

A-MASTER TEAM, LLC 6200 FALLS OF NEUSE ROAD SUITE 10 RALEIGH, NC 27609

Call W before you dig.

LEGEND



APPROVED FOR COMPLIANCE

By: Dany Date: 3/4/202 |
These plans have been approved for compliance with the Town Code of Ordinance, UDO, and Standard Specifications & Construction Details, subject to statements & conditions hereby incorporated by reference.

PLANS NOT APPROVED FOR CONSTRUCTION UNLESS SIGNED BY CITY OF RALEIGH

The City of Raleigh consents to the connection and extension of the City's **Public Water System** as shown on this plan. The material and Construction methods used for this project shall conform to the standards and specifications of the City's Public Utilities Handbook.

City of Raleigh Public Utilities Department Permit # W-3745

The City of Raleigh consents to the connection to its public sewer system and extension of the **private sewer collection** system as shown on this plan. The material and constructions methods used for this project shall conform to the standards and specifications of the City's Public Utilities Handbook.

City of Raleigh Public Utilities Department Permit # S-4760(P)

CITY OF RALEIGH - PLANS AUTHORIZED FOR CONSTRUCTION

Electronic Approval: This approval is being issued electronically. This approval is valid only upon the signature of a City of Raleigh Review Officer below. The City will retain a copy of the approved plans. Any work authorized by this approval must proceed in accordance with the plans kept on file with the City. This electronic approval may not be edited once issued. Any modification to this approval once issued will invalidate this approval.

Raleigh Water Review Officer

City of Raleigh Development Approval


RAWN BY: TT


CHECKED BY: JAE, JR.


COVER


Number	Description	Date
1	PER TRC COMMENTS	09/29/2
2	PER TRC COMMENTS	01/21/2


C = 0.0

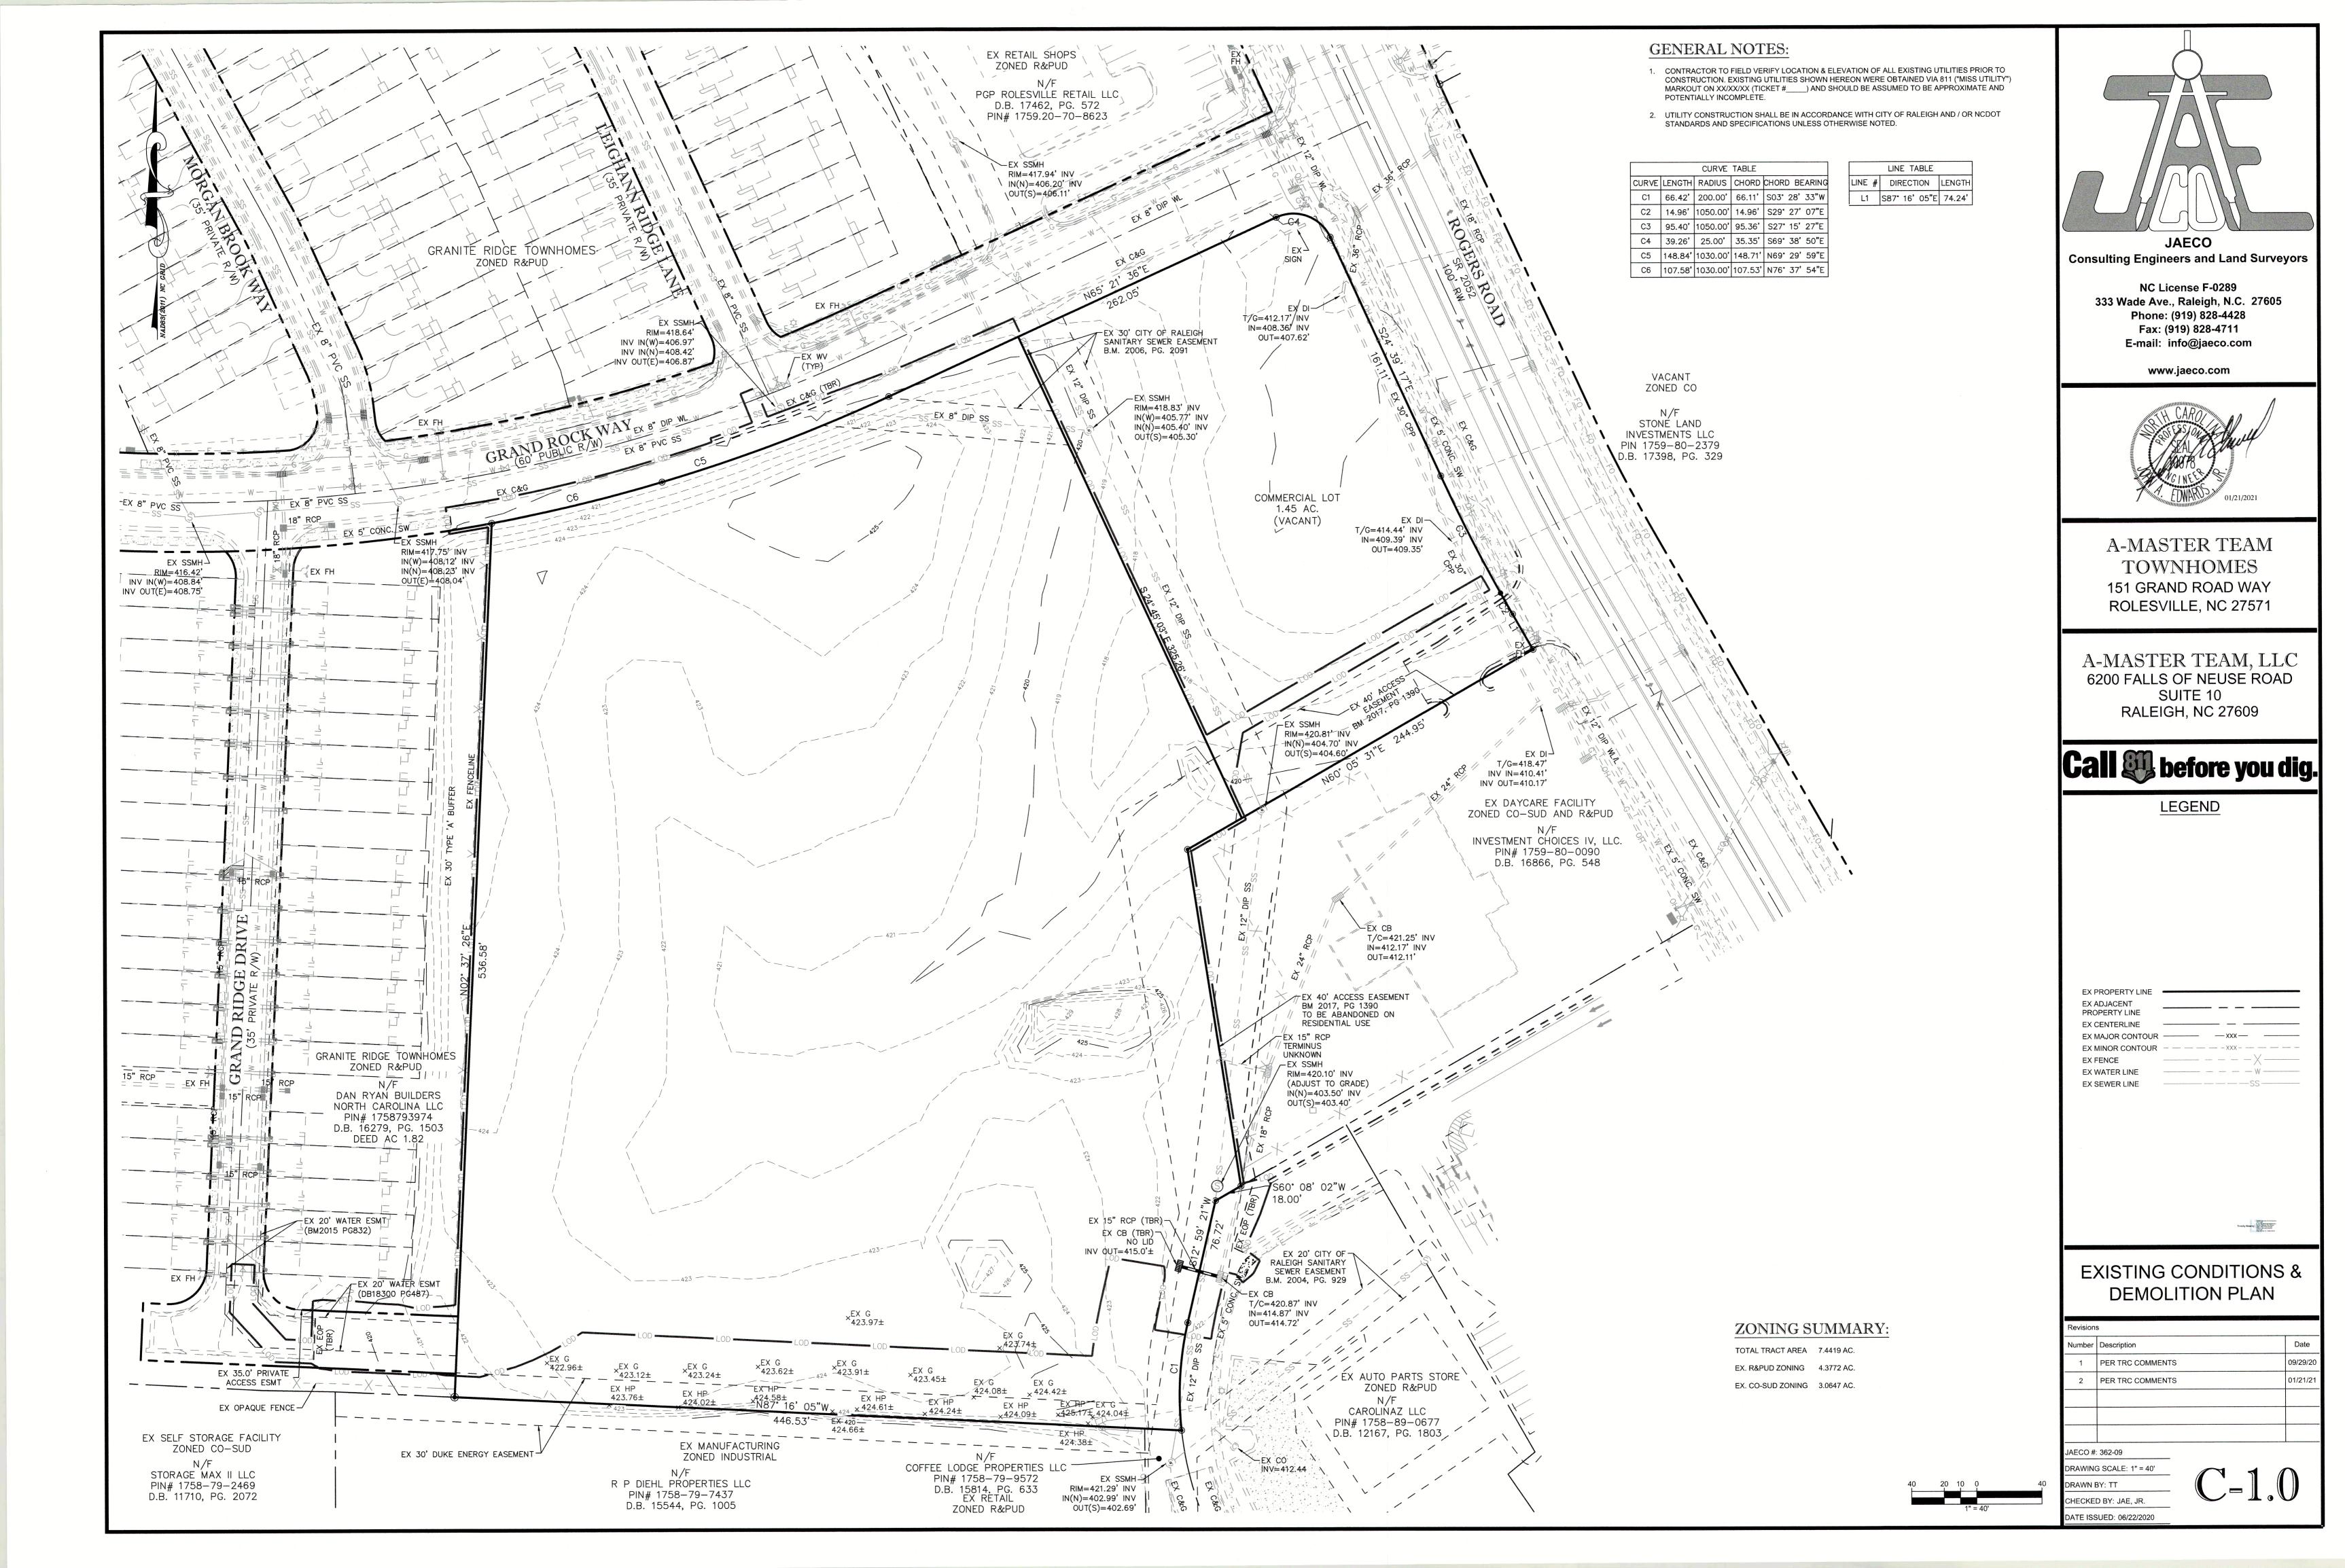


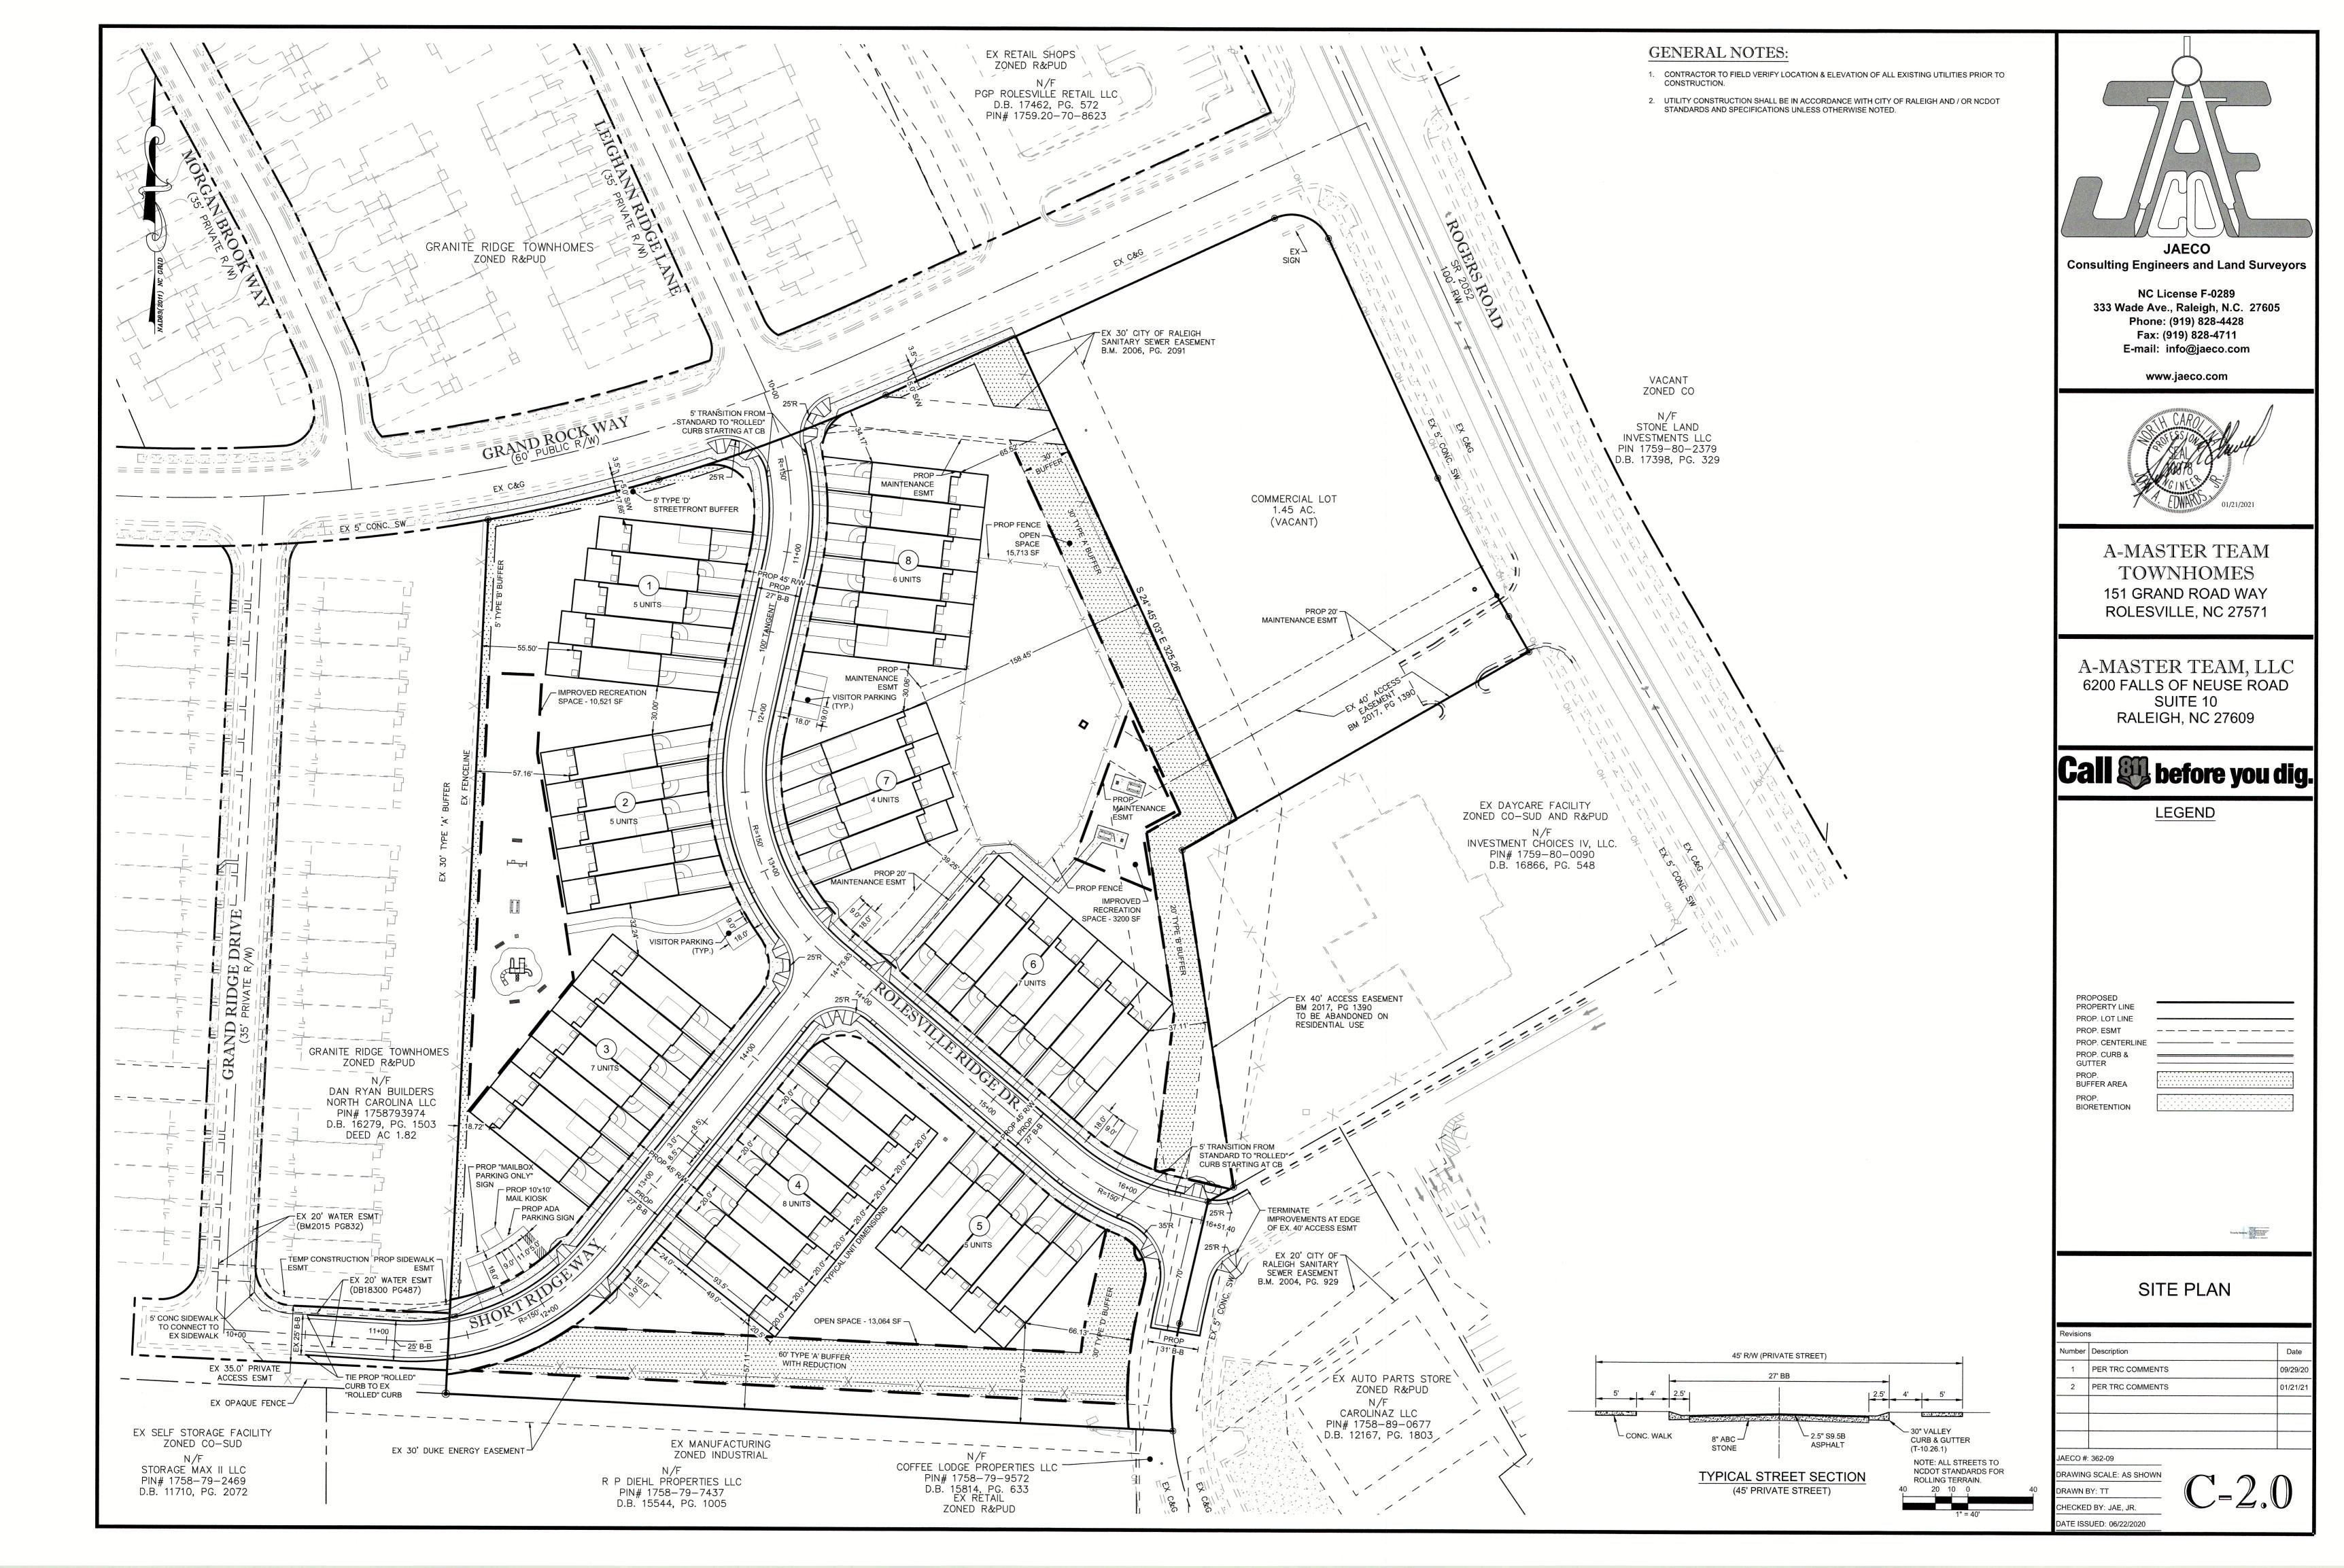


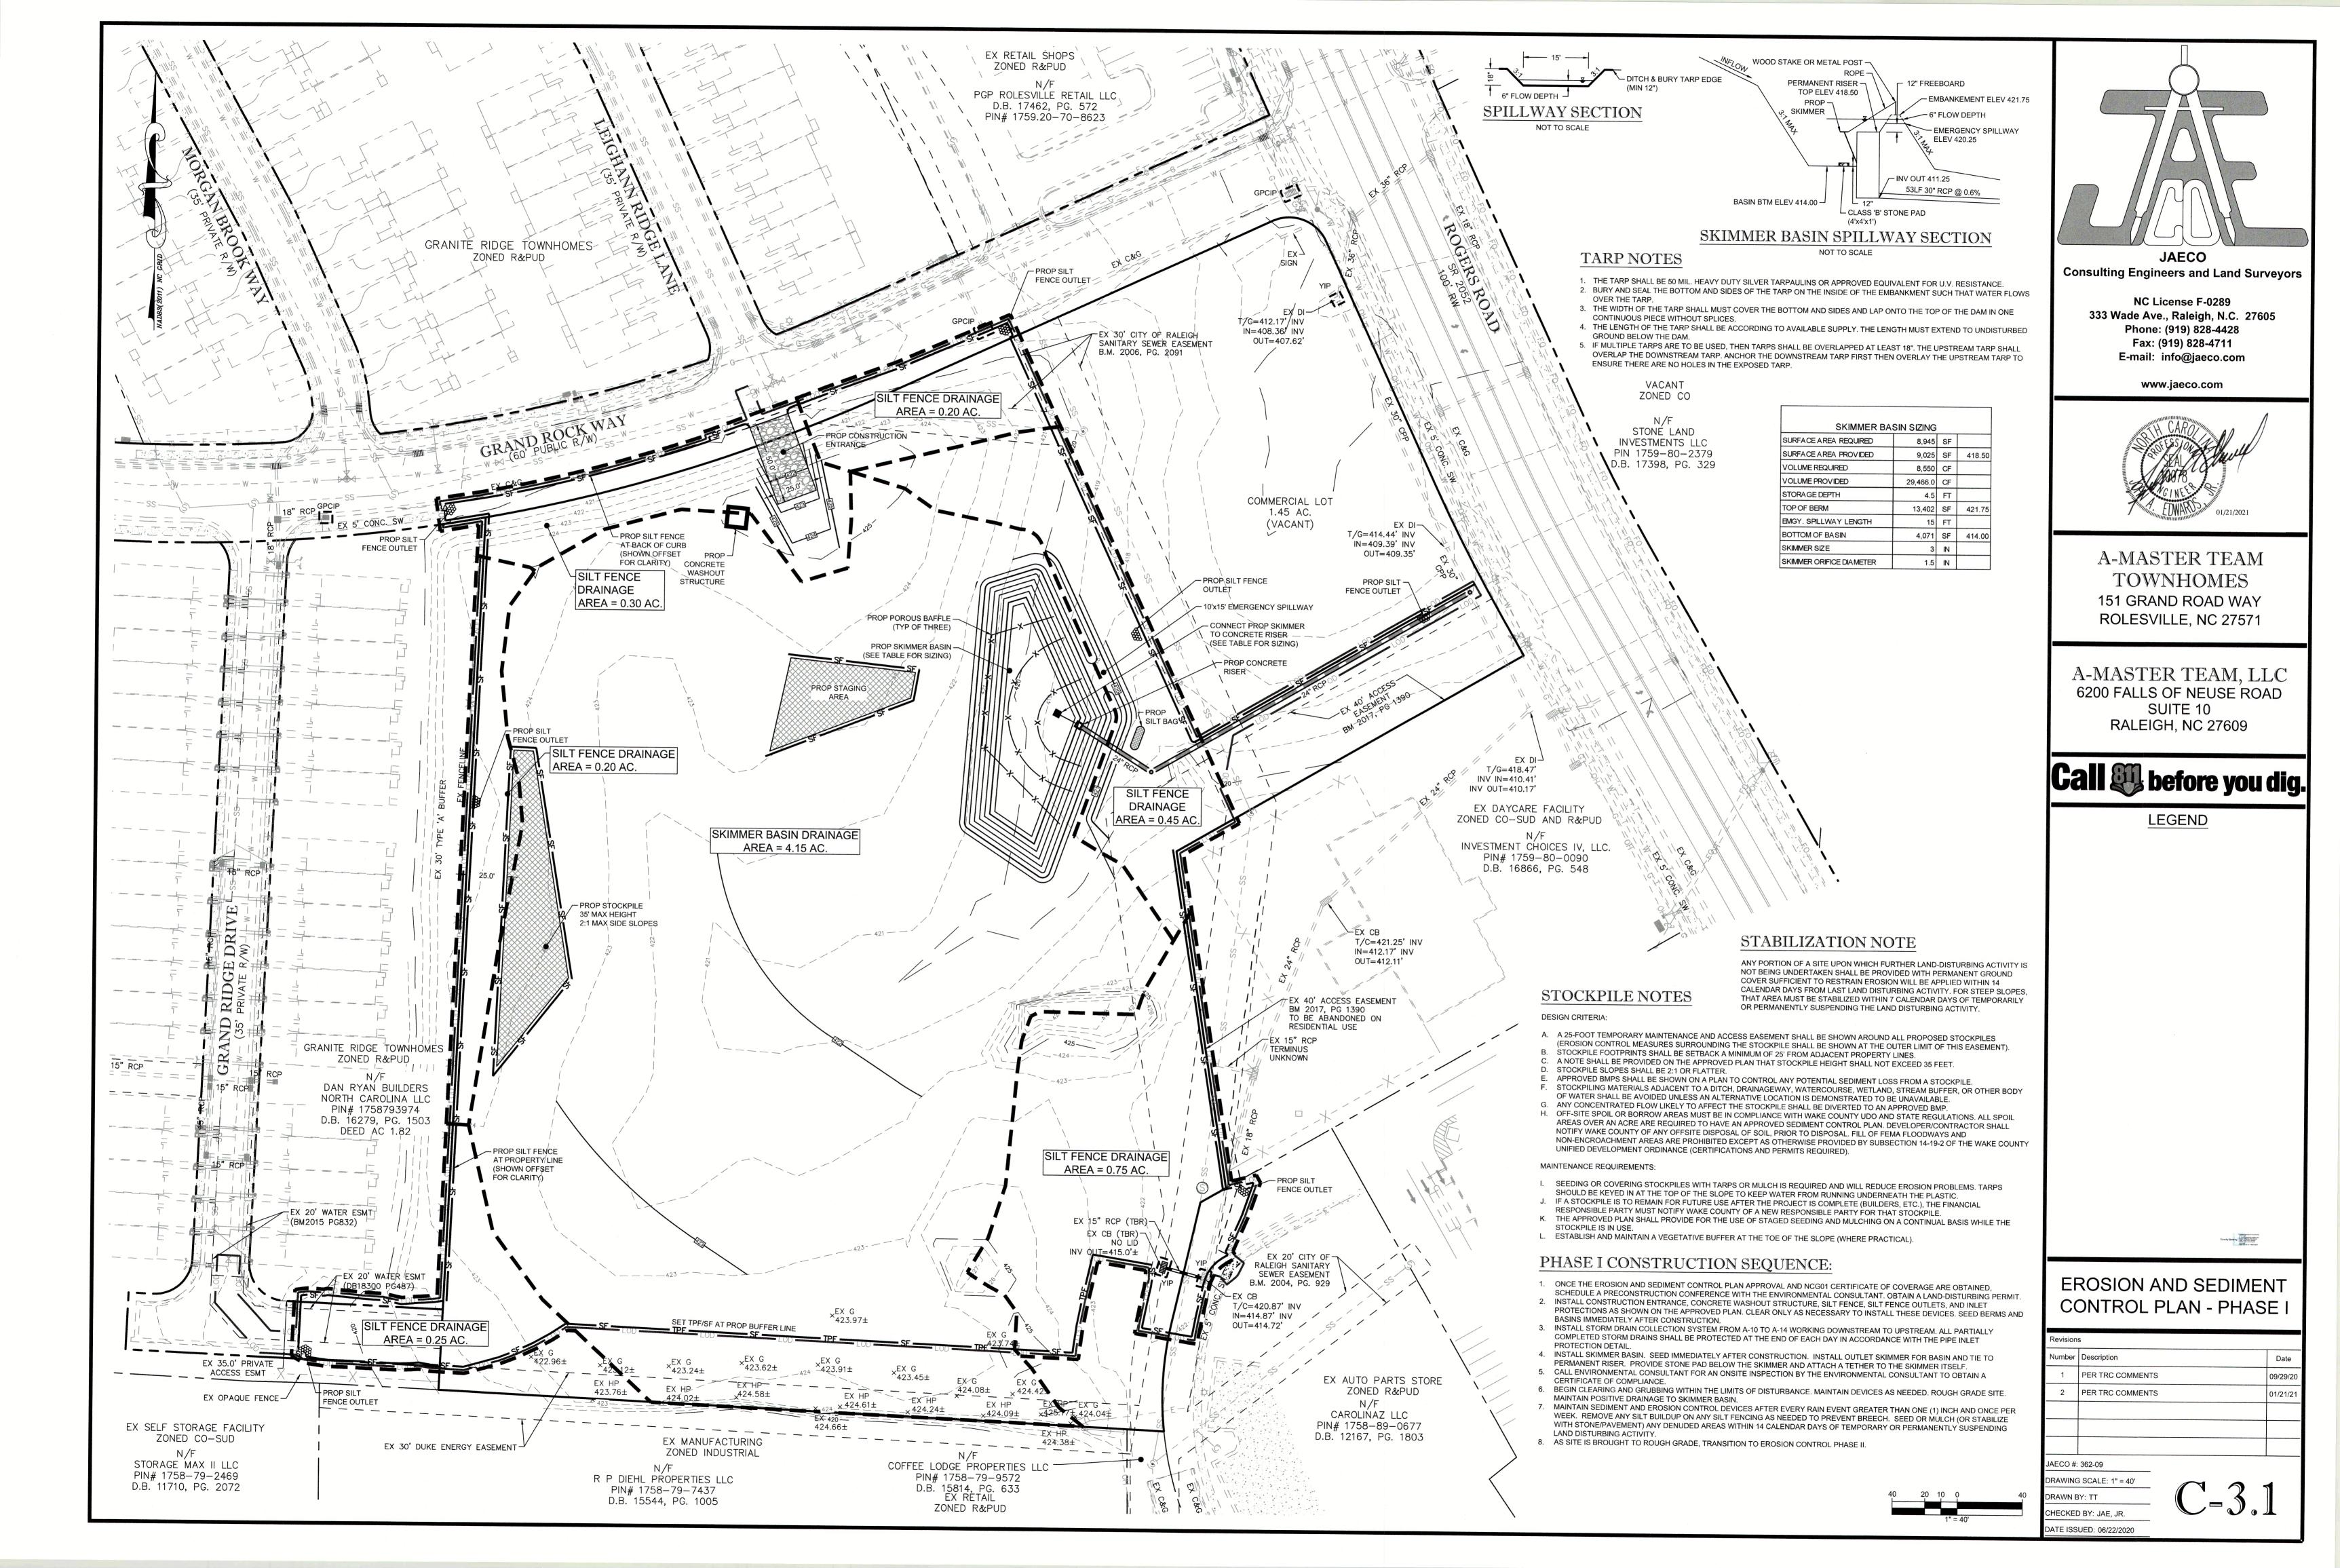


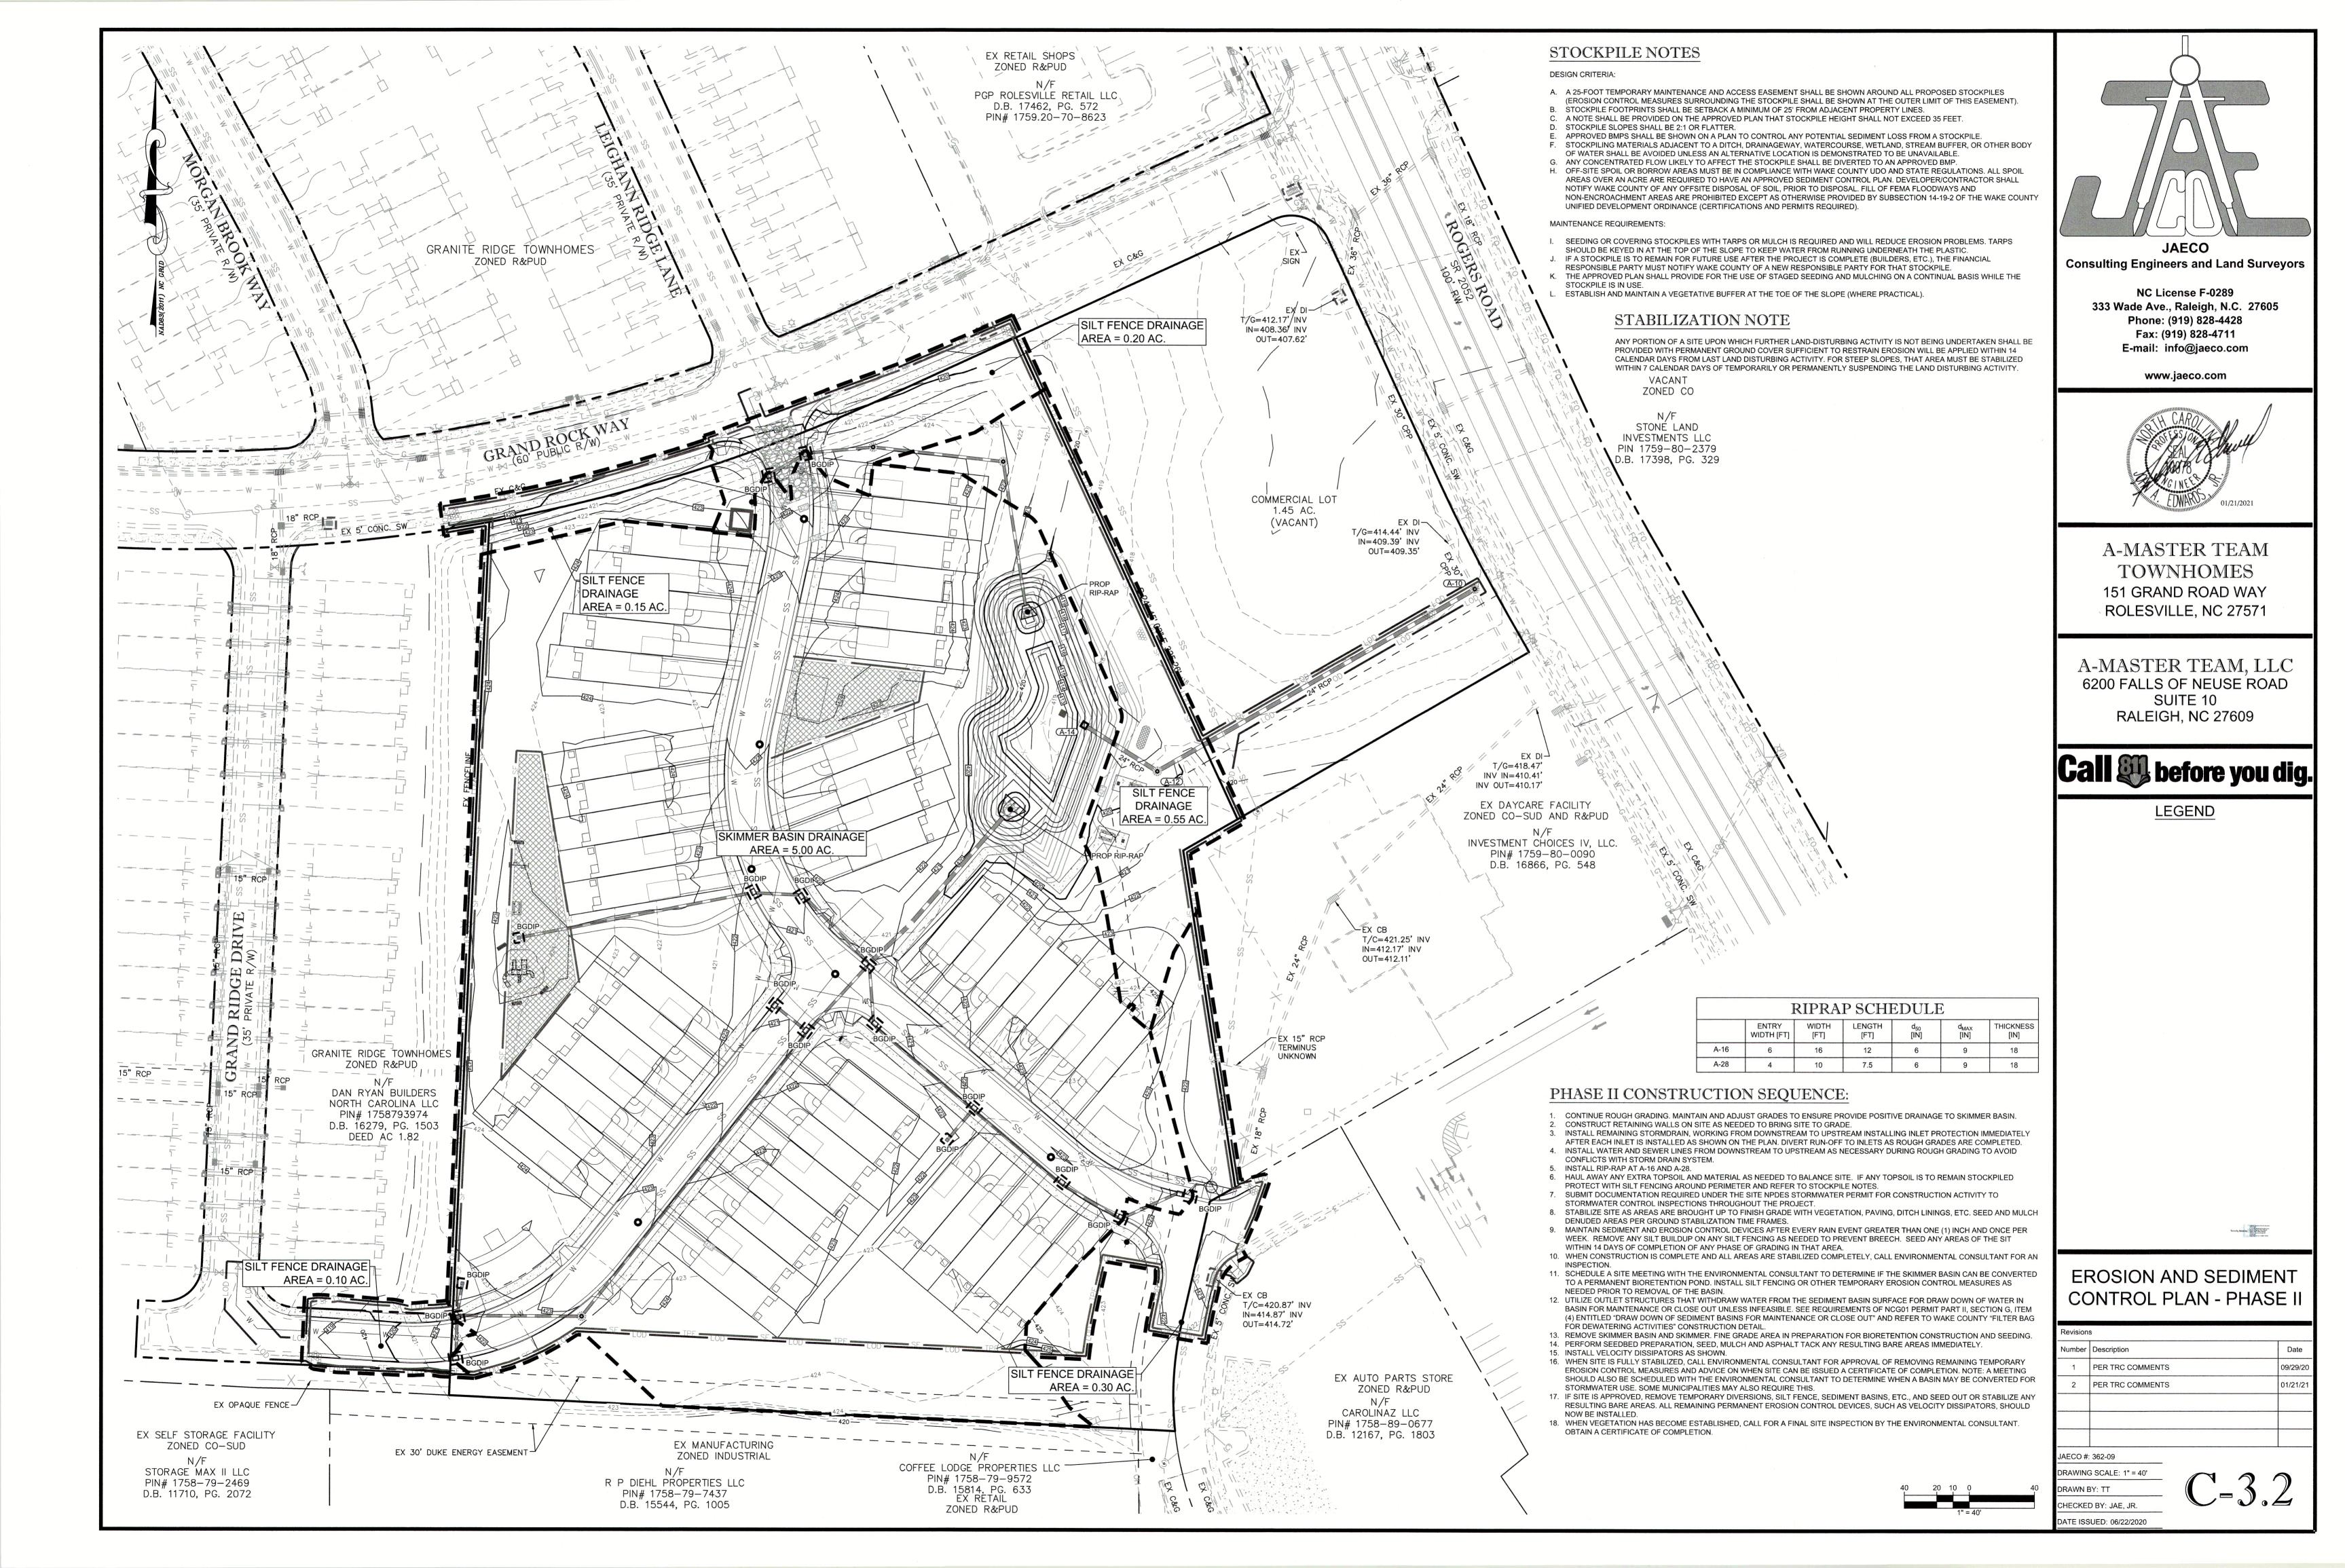

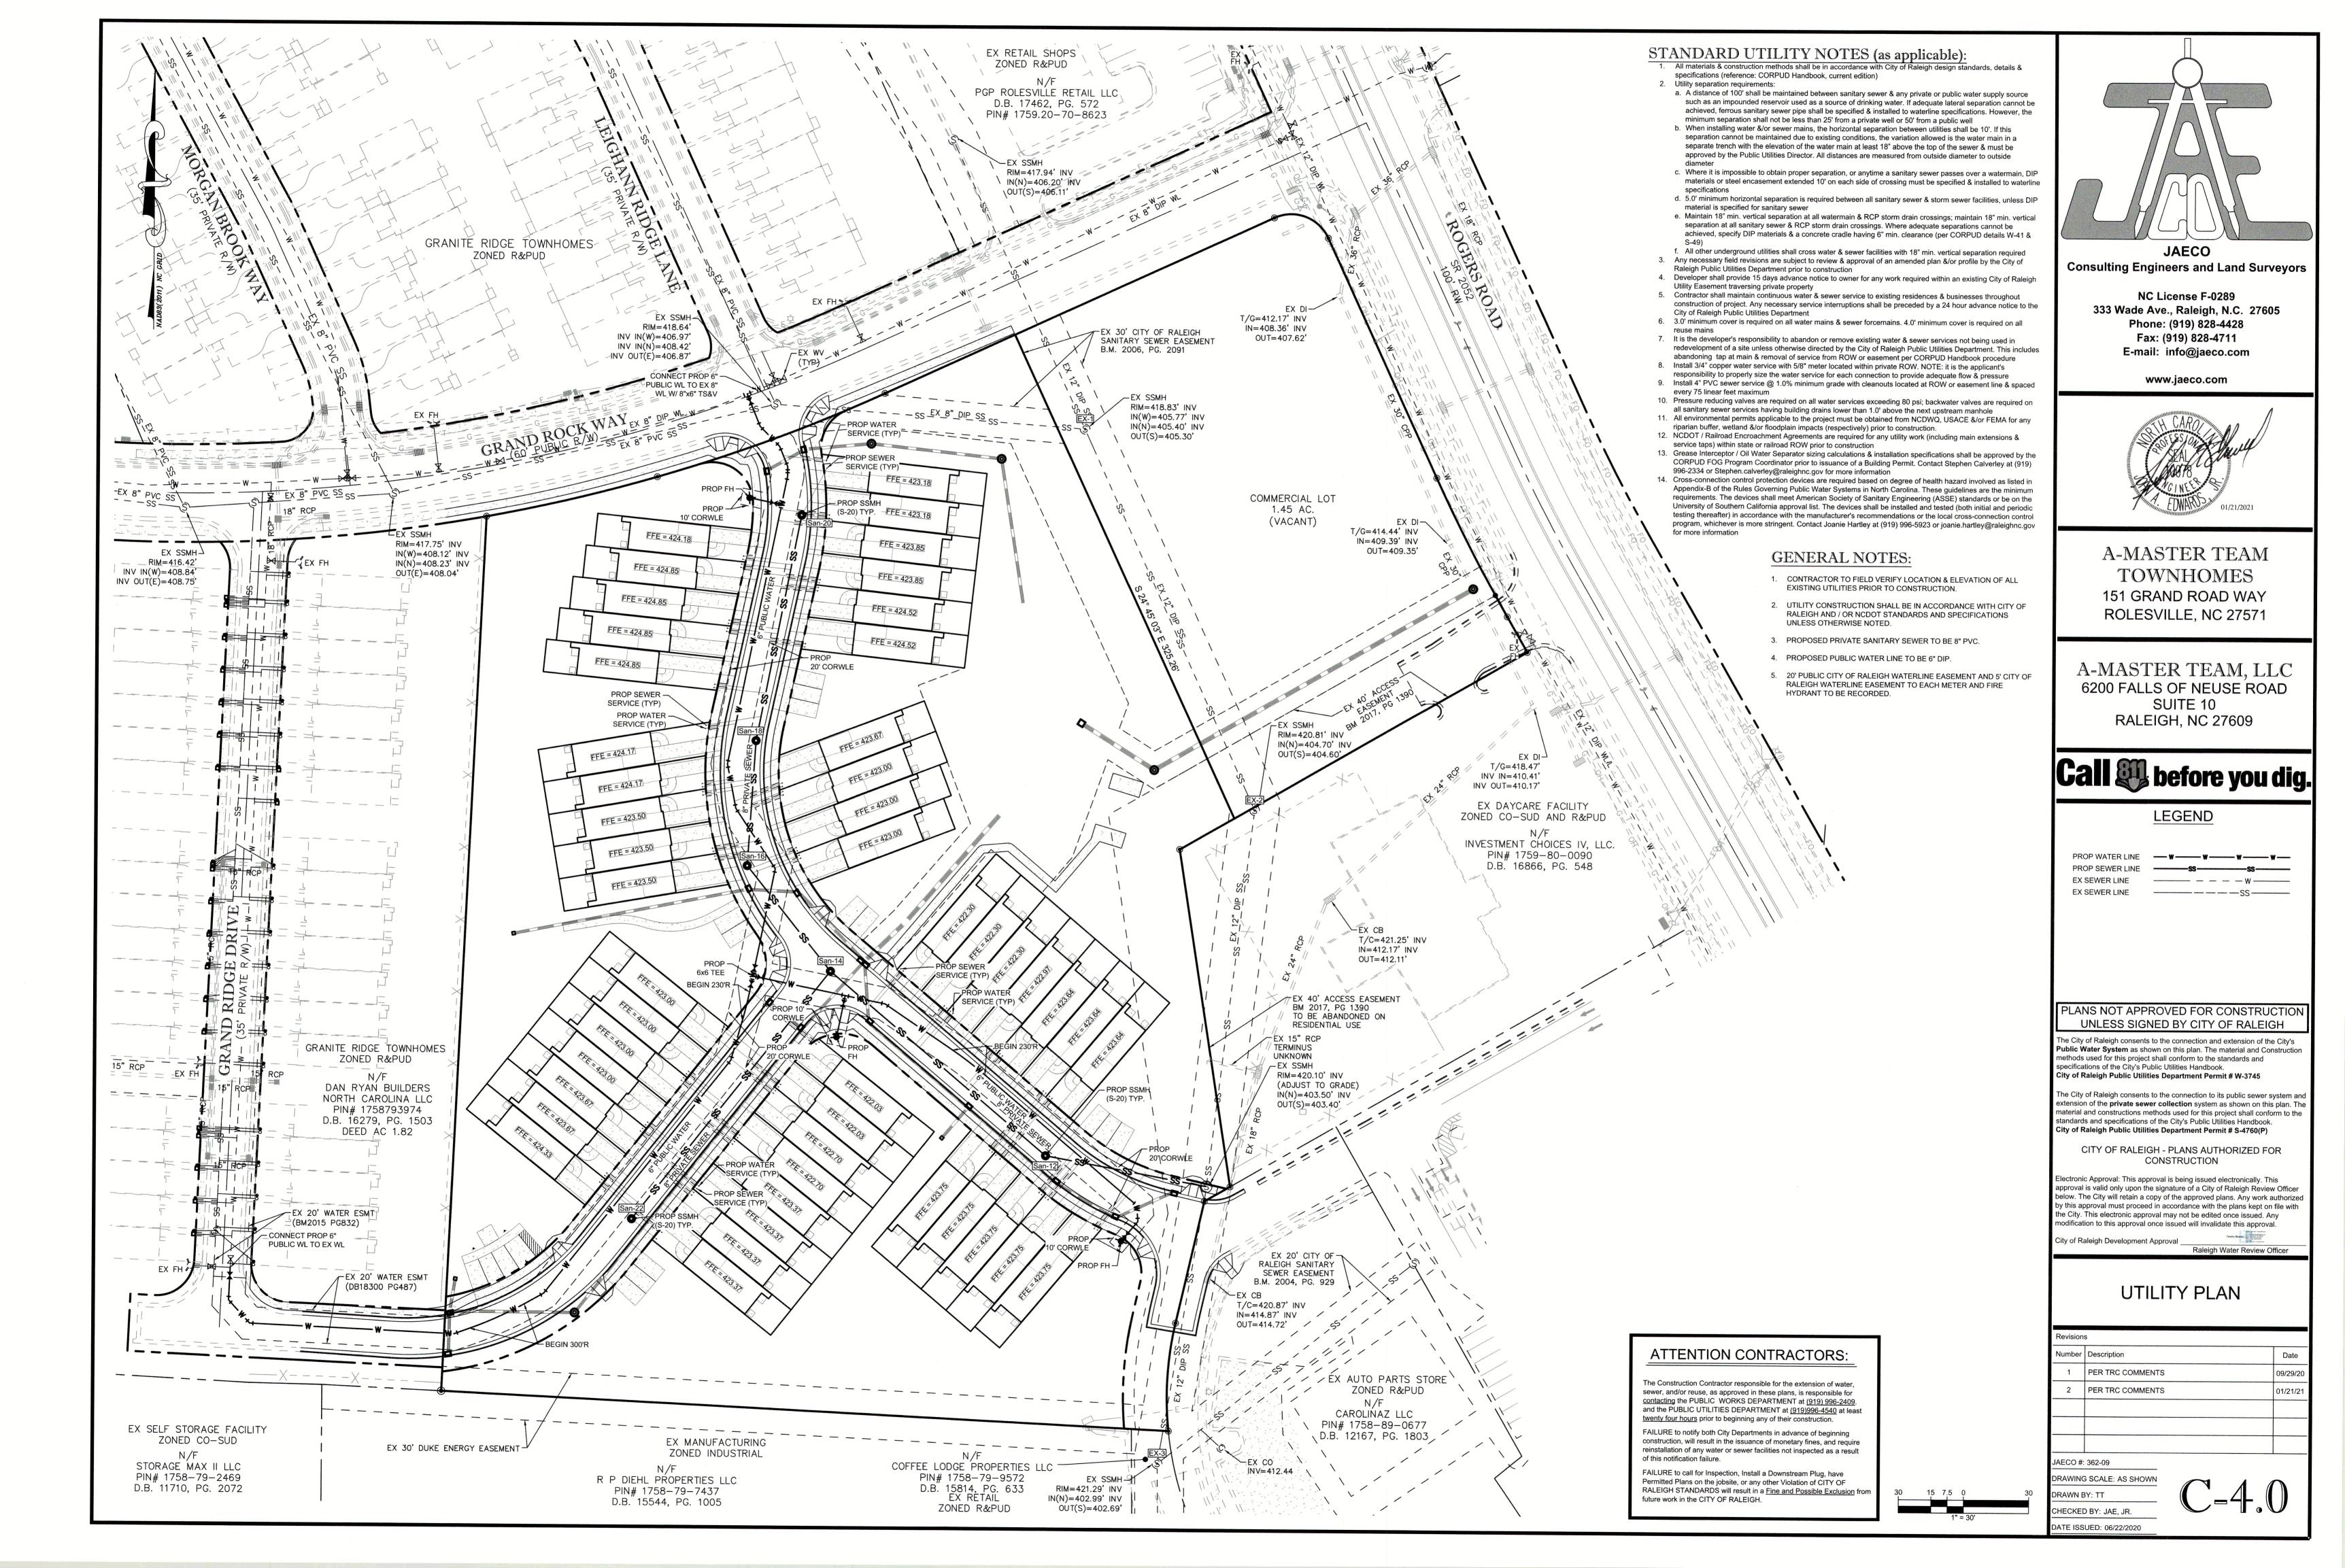

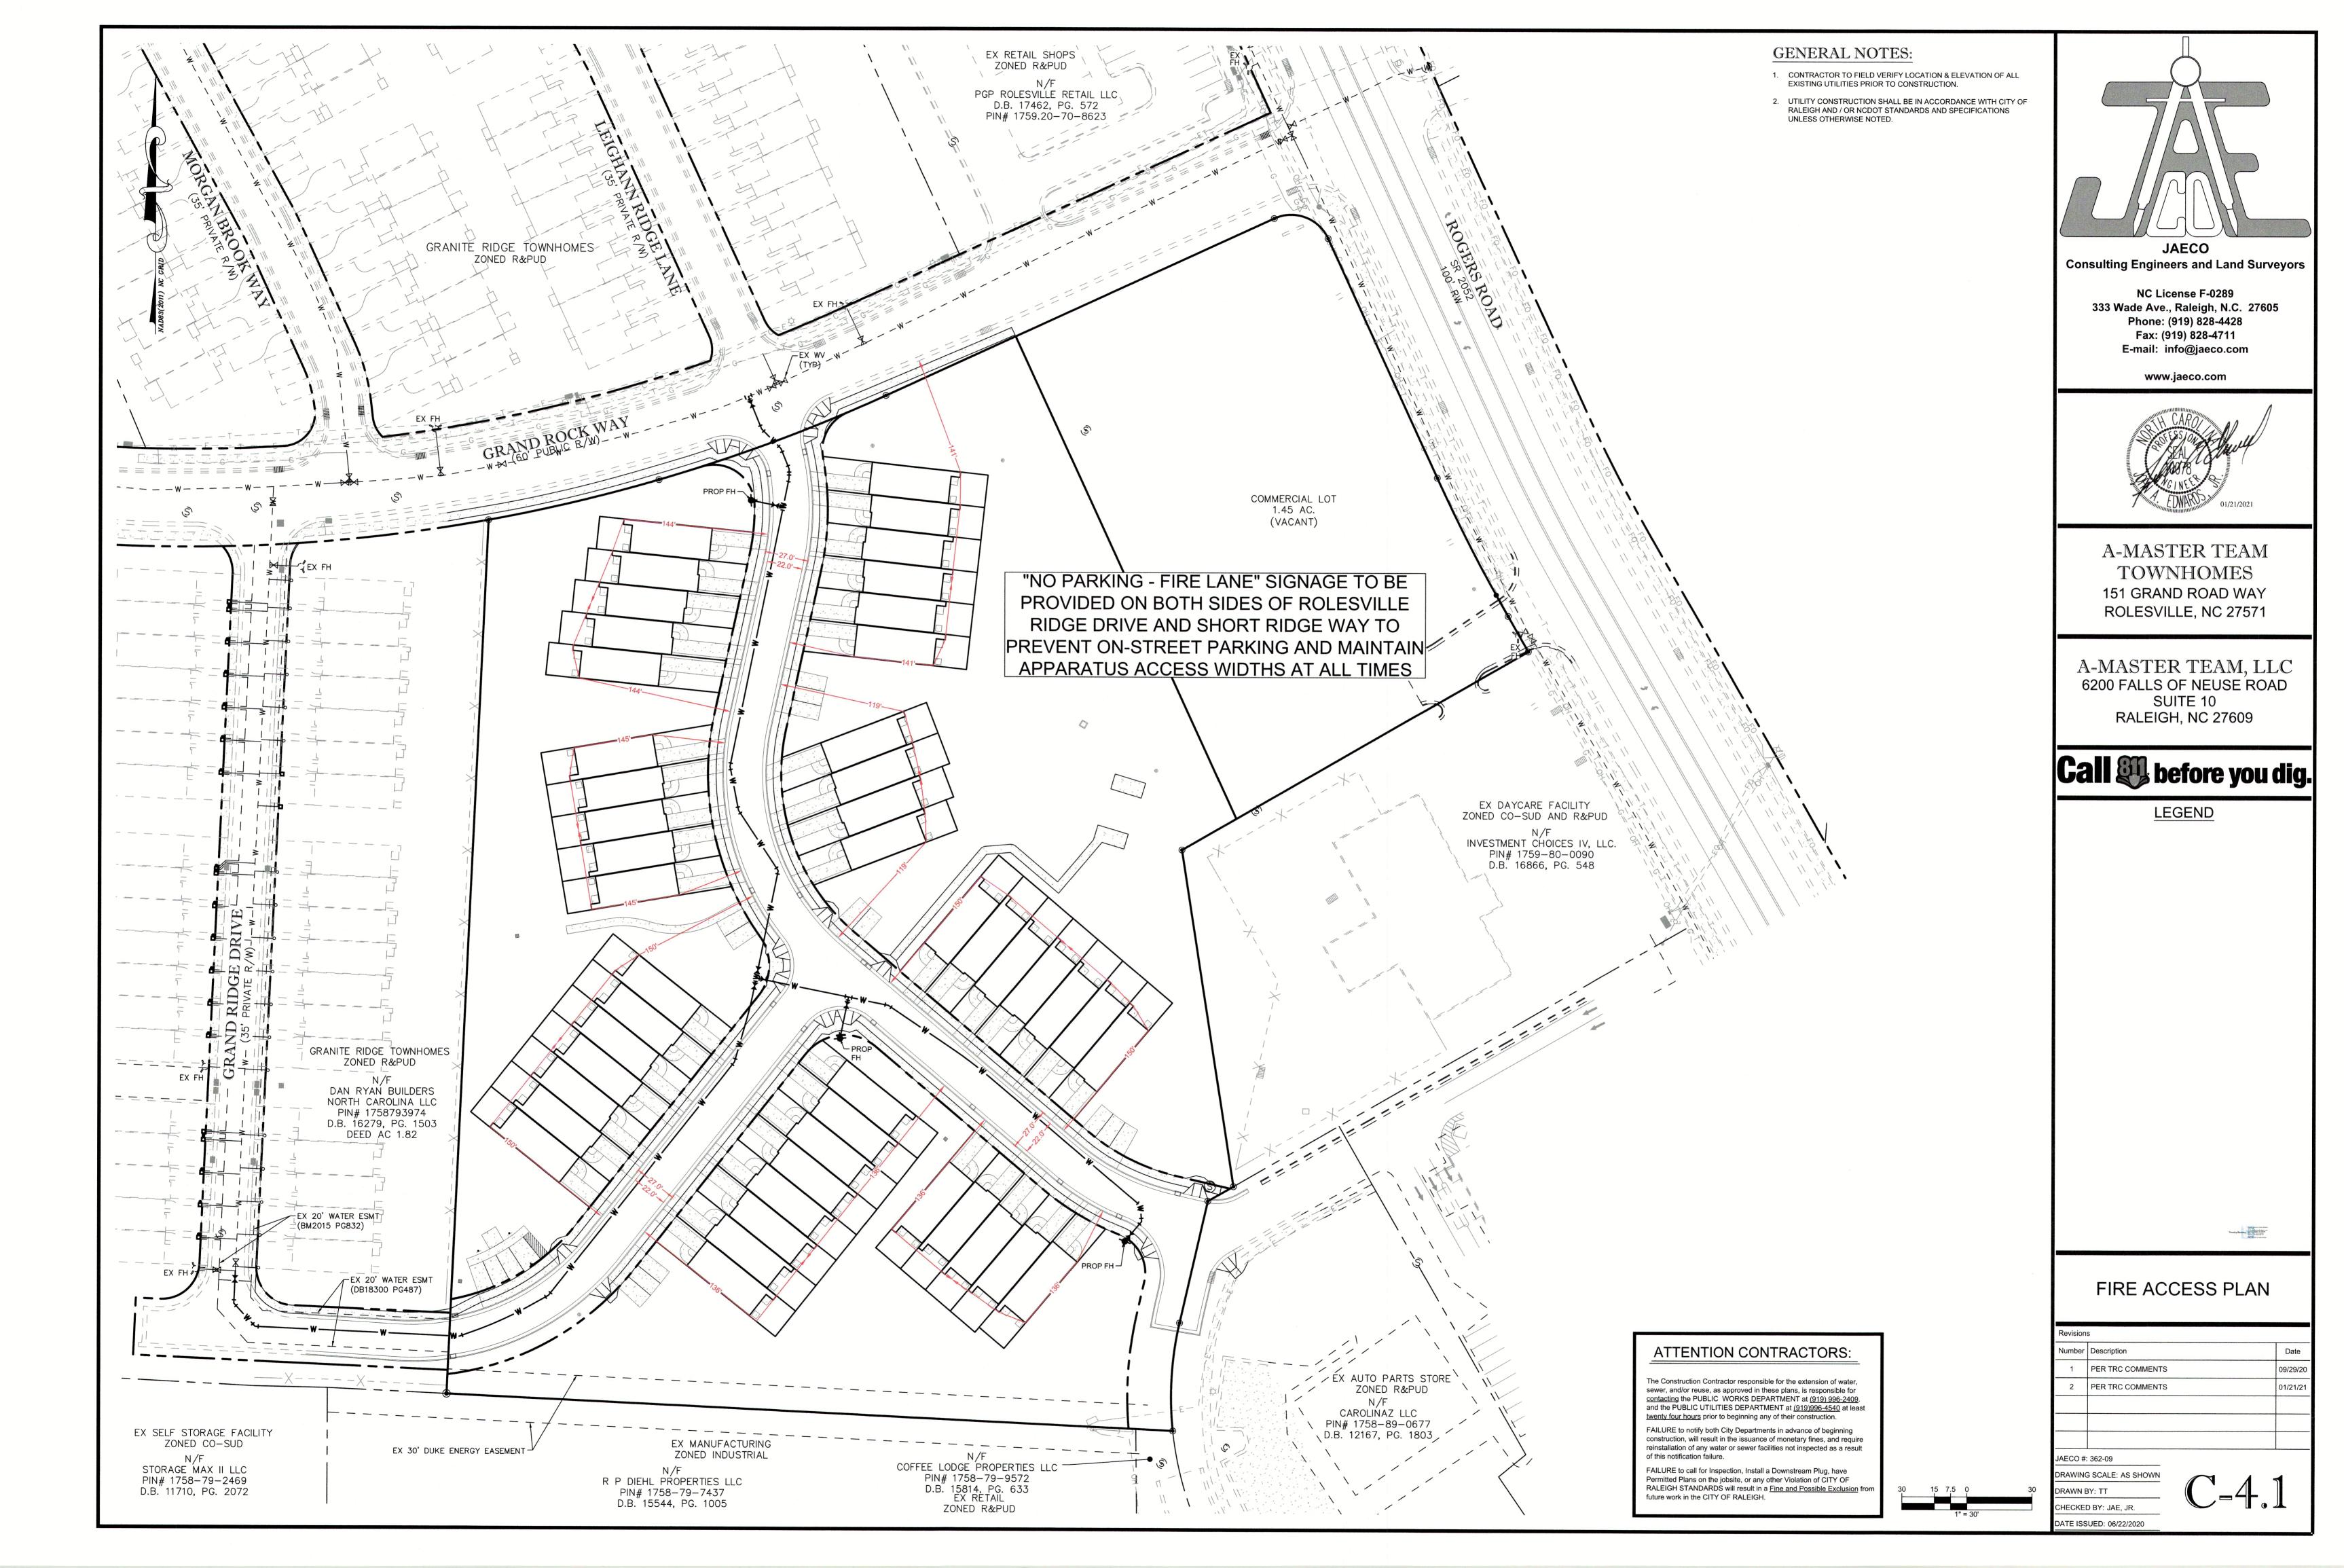

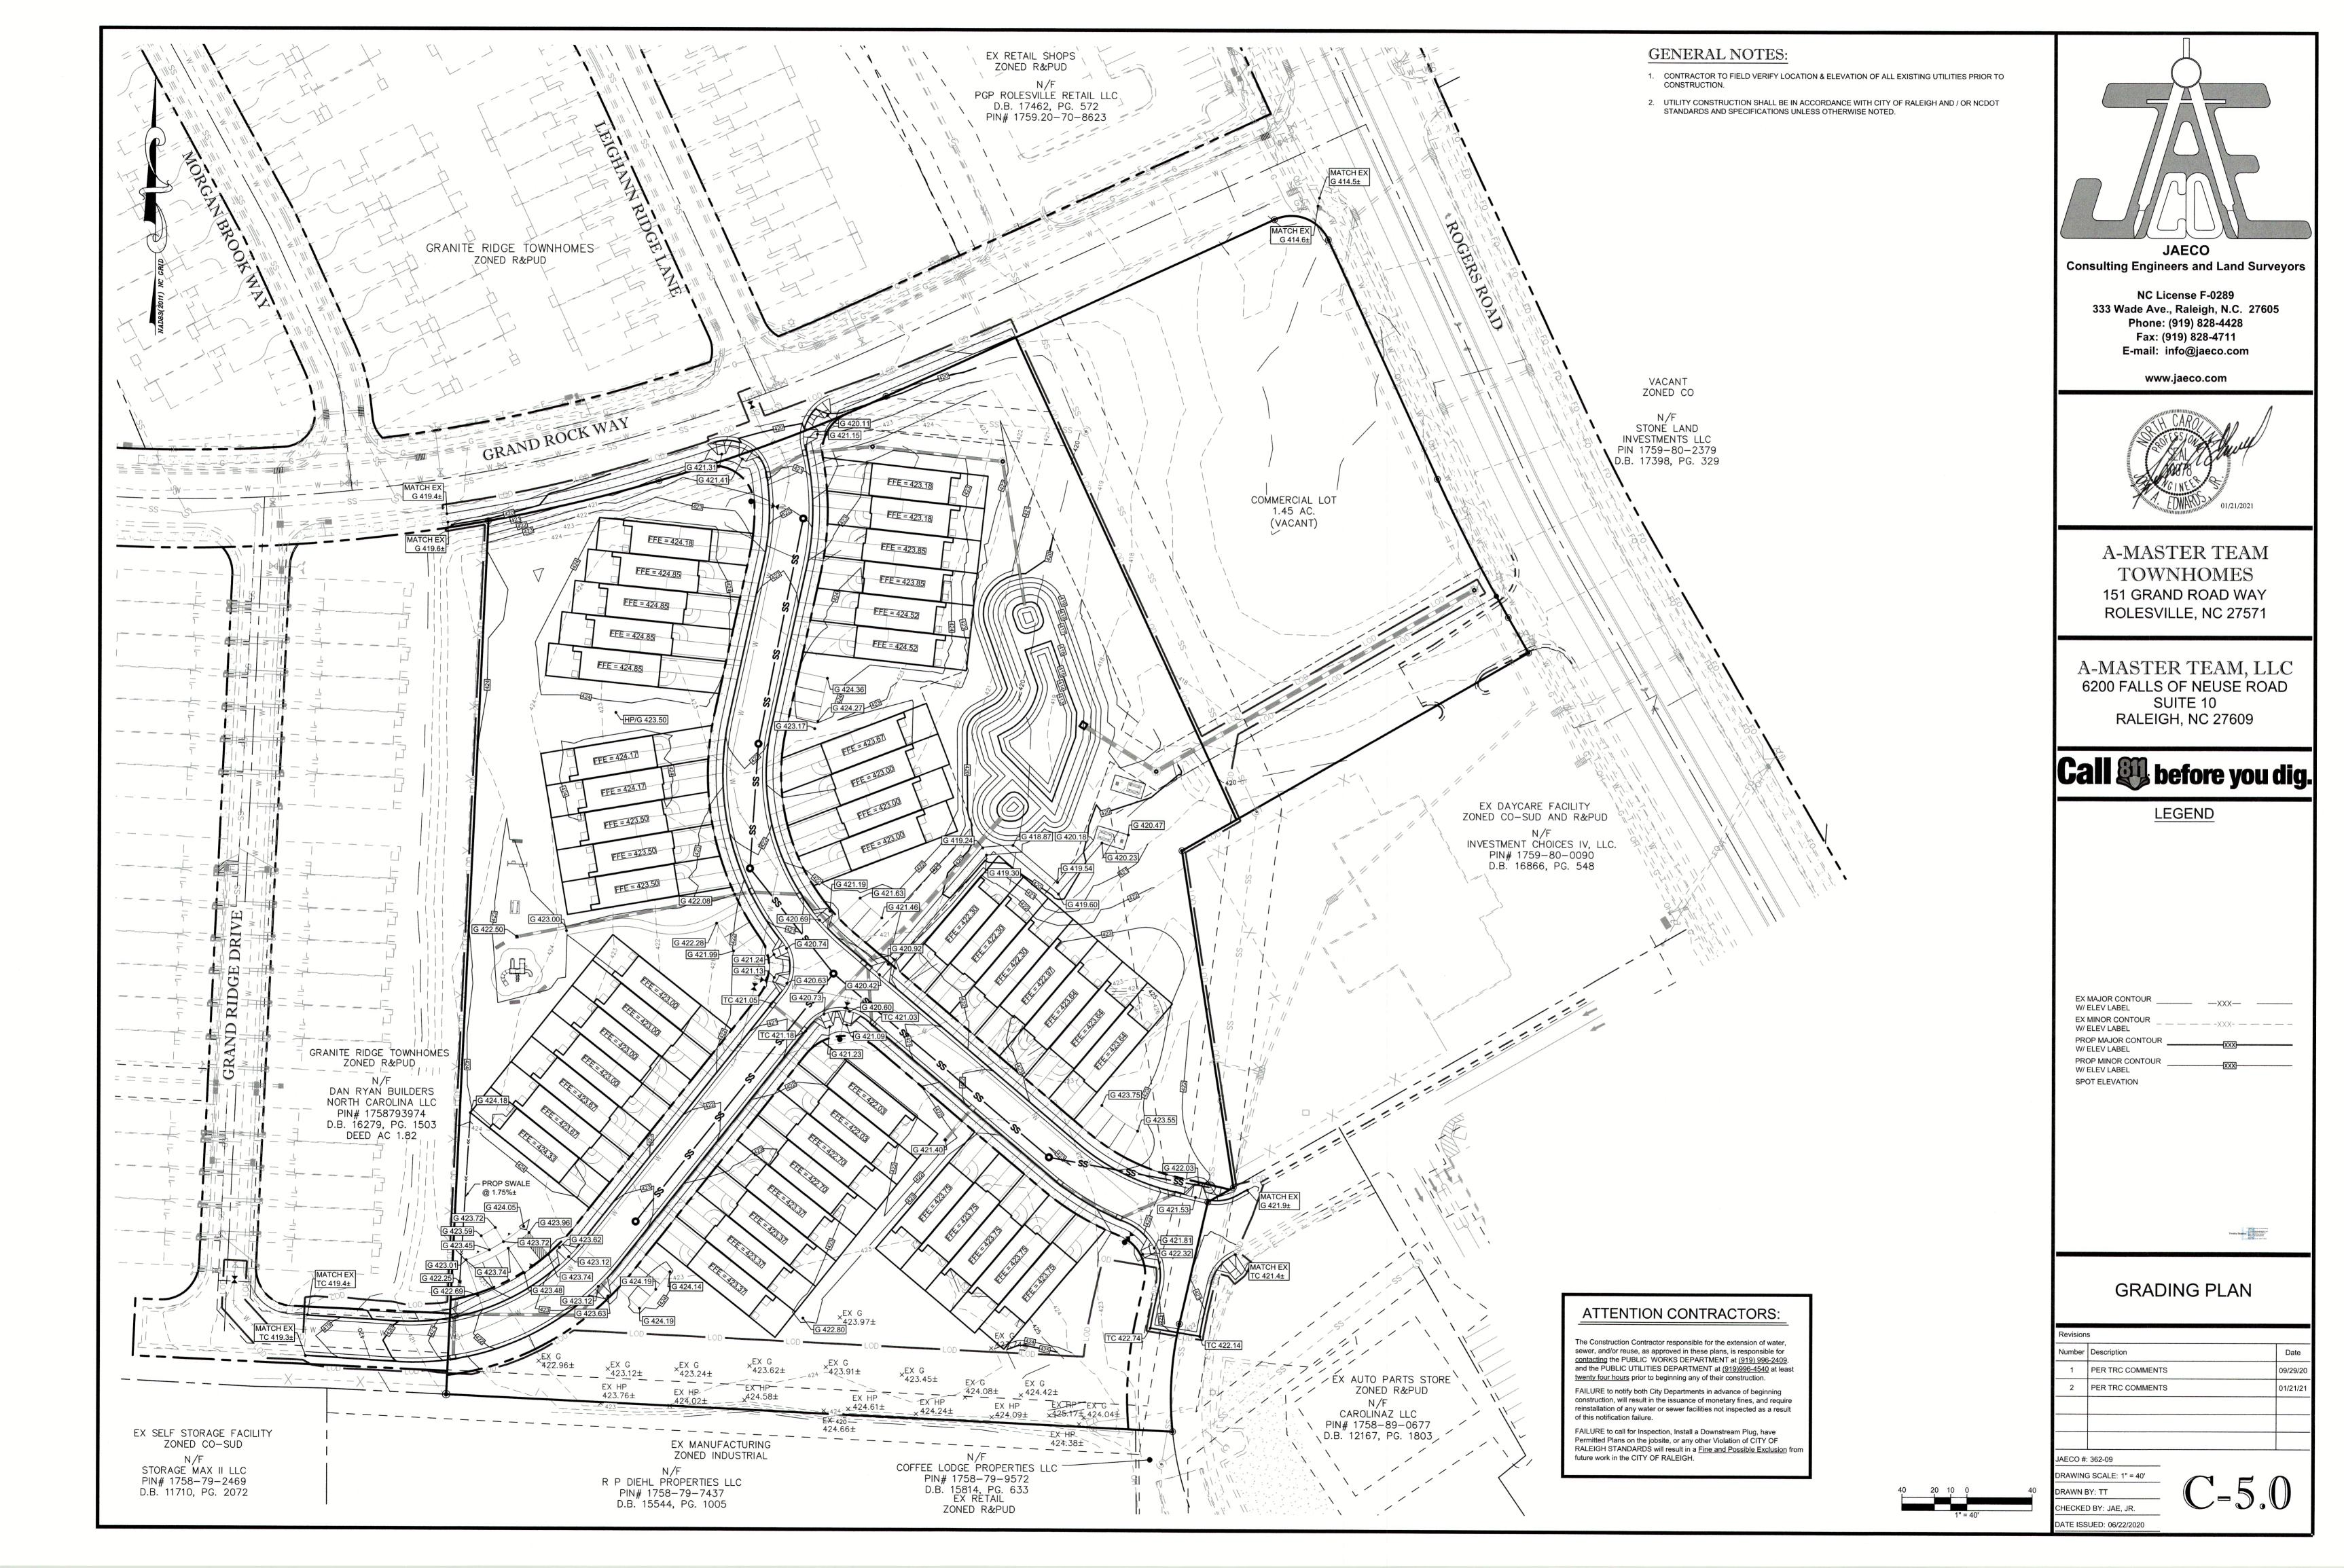

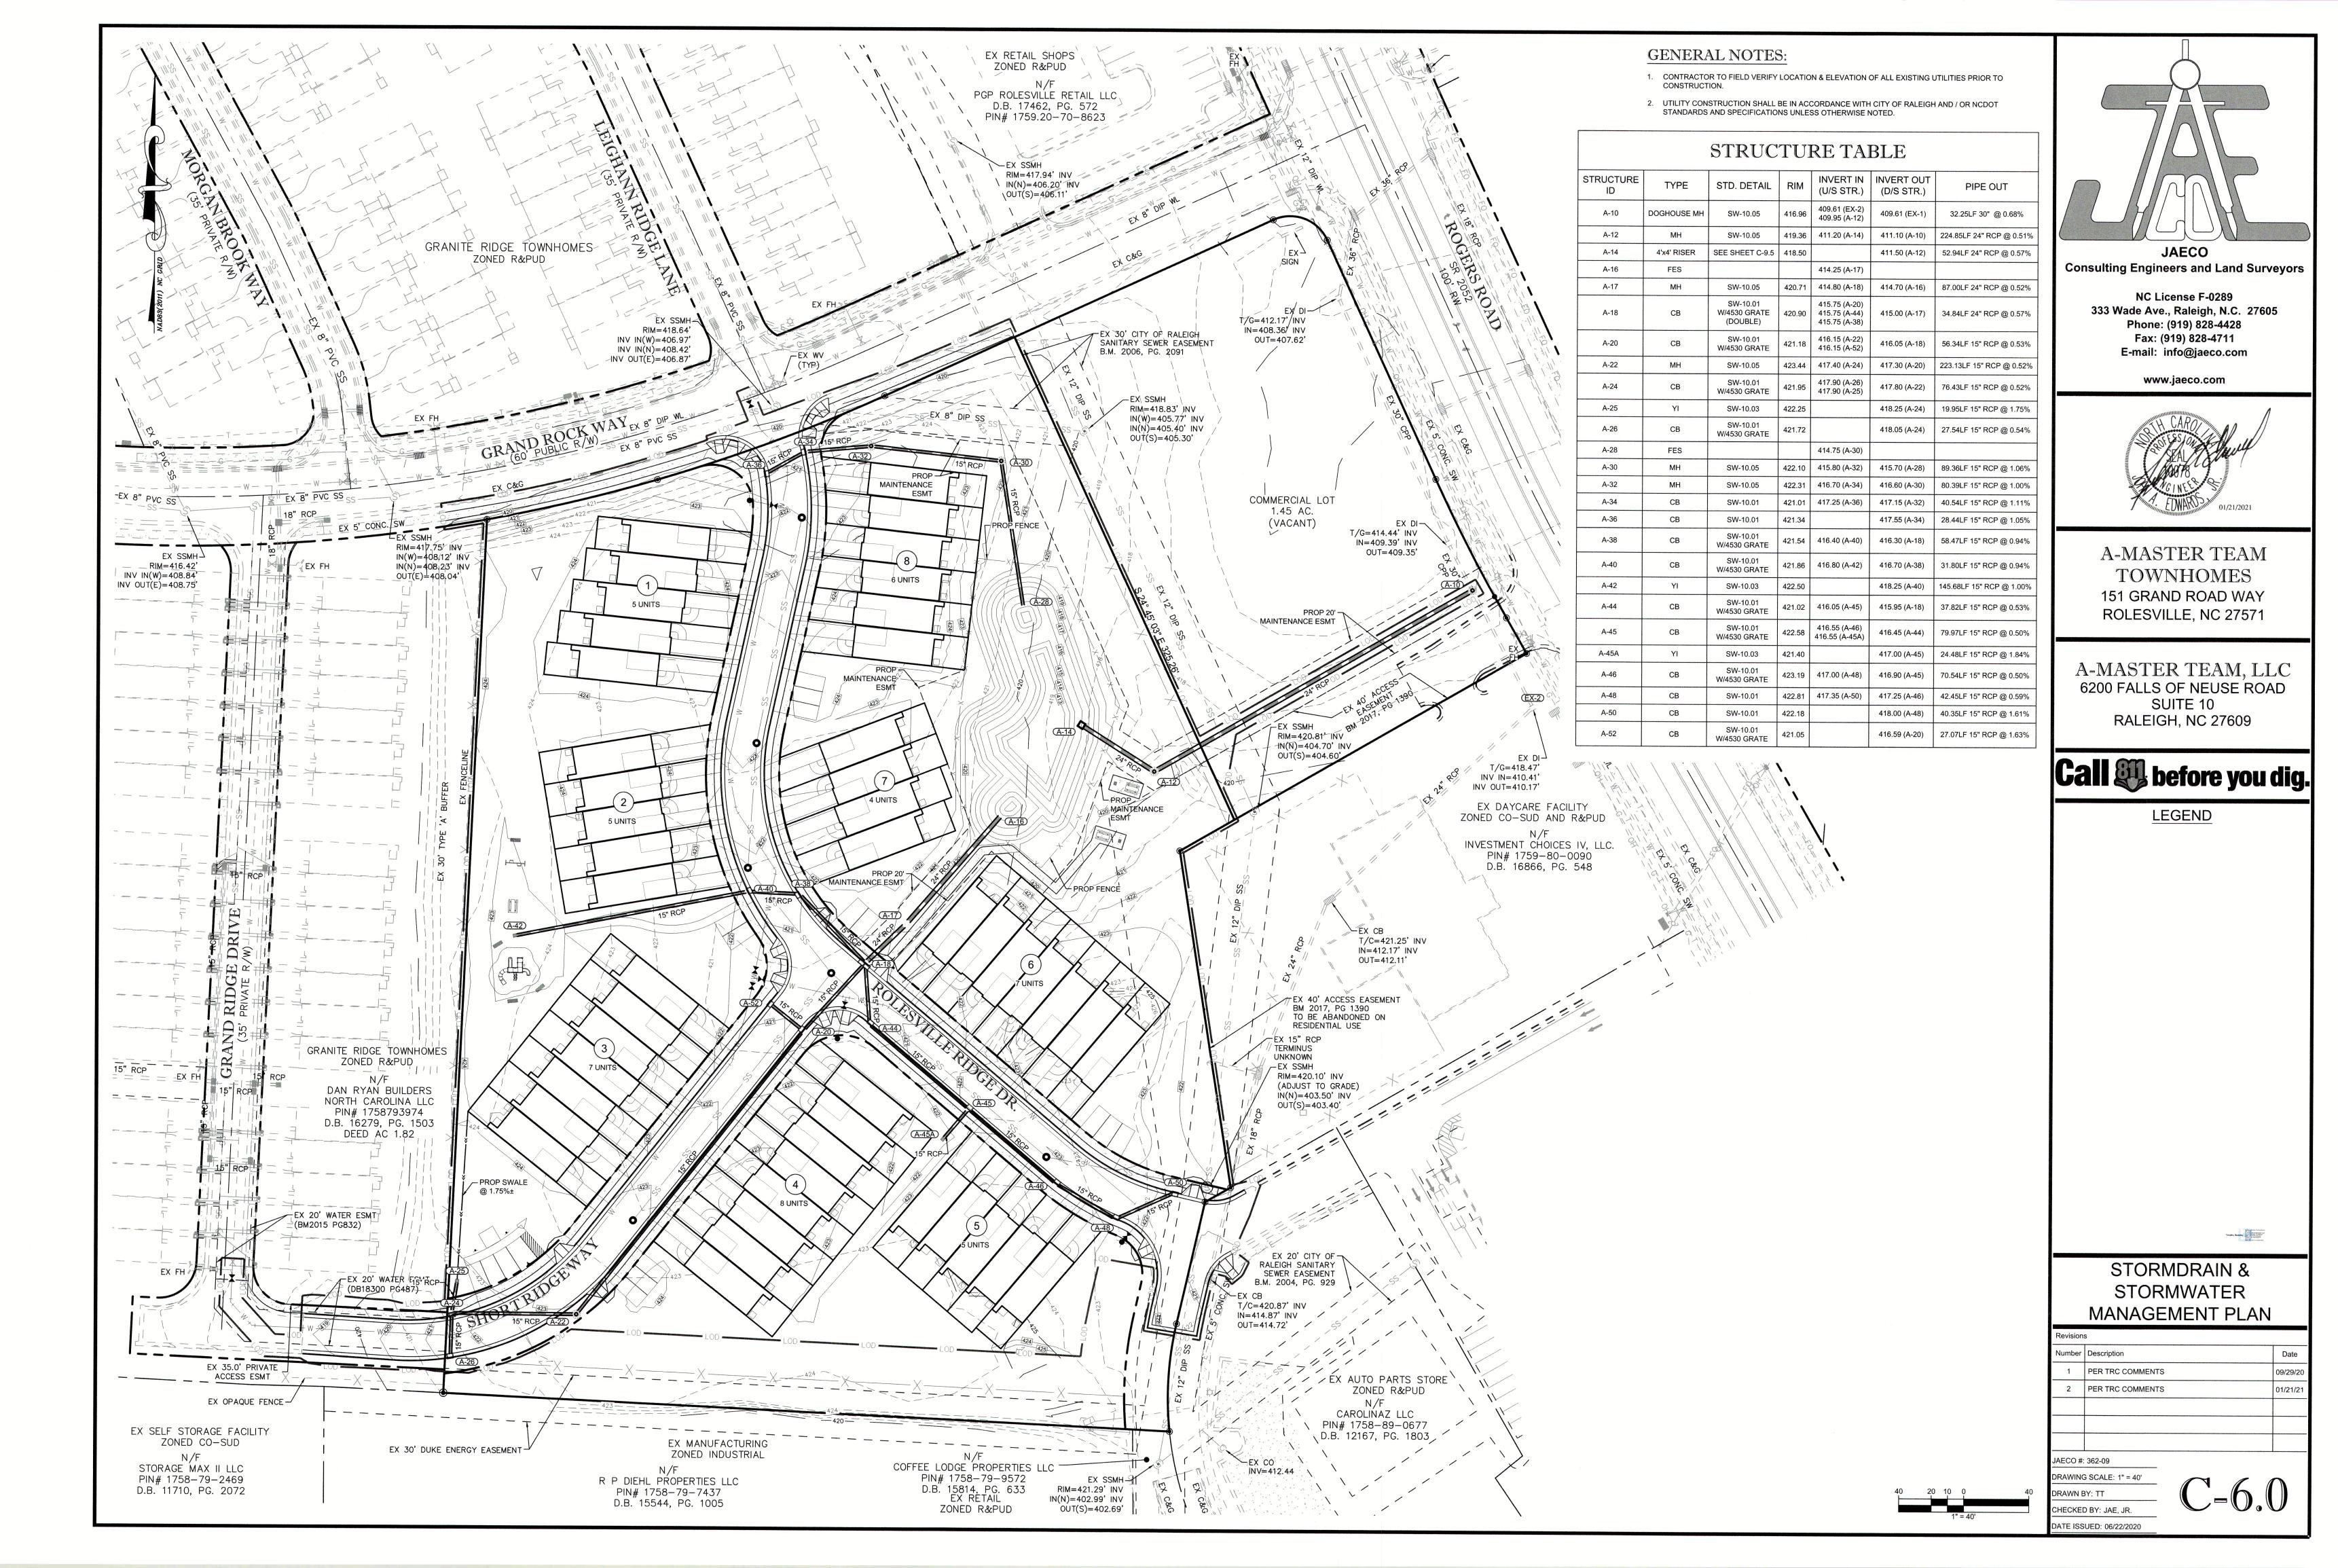

STANDARD UTILITY NOTES (as

- All materials & construction methods shall be in accordance with City of Raleigh design standards, details & specifications (reference: CORPUD Handbook, current edition)
- Utility separation requirements: a. A distance of 100' shall be maintained between sanitary sewer & any private or public water supply source such as an impounded reservoir used as a source of drinking water. If adequate lateral separation cannot be achieved, ferrous sanitary sewer pipe shall be specified &
- installed to waterline specifications. However, the minimum separation shall not be less than 25' from a private well or 50' from a public well b. When installing water &/or sewer mains, the horizontal separation between utilities shall be 10'. If this separation cannot be maintained due to existing conditions, the variation allowed is the water main in a separate trench with the elevation of the water main at least 18" above the top of the sewer & must be approved by the Public Utilities Director.

All distances are measured from outside diameter to outside diameter

- c. Where it is impossible to obtain proper separation, or anytime a sanitary sewer passes over a watermain, DIP materials or steel encasement extended 10' on each side of crossing must be specified & installed to waterline specifications
- d. 5.0' minimum horizontal separation is required between all sanitary sewer & storm sewer facilities, unless DIP material is specified for sanitary sewer
- e. Maintain 18" min. vertical separation at all watermain & RCP storm drain crossings; maintain 18" min. vertical separation at all sanitary sewer & RCP storm drain crossings. Where adequate separations cannot be achieved, specify DIP materials & a concrete cradle having 6" min. clearance (per CORPUD details W-41 & S-49)
- f. All other underground utilities shall cross water & sewer facilities with 18" min. vertical separation required
- 3. Any necessary field revisions are subject to review & approval of an amended plan &/or profile by the City of Raleigh Public Utilities Department prior to construction
- 4. Developer shall provide 15 days advance notice to owner for any work required within an existing City of Raleigh Utility Easement traversing private property 5. Contractor shall maintain continuous water & sewer service to existing
- residences & businesses throughout construction of project. Any necessary service interruptions shall be preceded by a 24 hour advance notice to the City of Raleigh Public Utilities Department
- 6. 3.0' minimum cover is required on all water mains & sewer forcemains. 4.0' minimum cover is required on all reuse mains 7. It is the developer's responsibility to abandon or remove existing water & sewer services not being used in redevelopment of a site unless otherwise directed by the City of Raleigh Public Utilities Department. This includes
- CORPUD Handbook procedure 8. Install 3/4" copper water service with 5/8" meter located within private ROW. NOTE: it is the applicant's responsibility to properly size the water service for each connection to provide adequate flow & pressure

abandoning tap at main & removal of service from ROW or easement per

- 9. Install 4" PVC sewer service @ 1.0% minimum grade with cleanouts located at ROW or easement line & spaced every 75 linear feet maximum 10. Pressure reducing valves are required on all water services exceeding 80
- psi; backwater valves are required on all sanitary sewer services having building drains lower than 1.0' above the next upstream manhole 11. All environmental permits applicable to the project must be obtained from NCDWQ, USACE &/or FEMA for any riparian buffer, wetland &/or floodplain impacts (respectively) prior to construction.
- 12. NCDOT / Railroad Encroachment Agreements are required for any utility work (including main extensions & service taps) within state or railroad
- Grease Interceptor / Oil Water Separator sizing calculations & installation specifications shall be approved by the CORPUD FOG Program Coordinator prior to issuance of a Building Permit. Contact Stephen Calverley at (919) 996-2334 or Stephen.calverley@raleighnc.gov for more
- 14. Cross-connection control protection devices are required based on degree of health hazard involved as listed in Appendix-B of the Rules Governing Public Water Systems in North Carolina. These guidelines are the minimum requirements. The devices shall meet American Society of Sanitary Engineering (ASSE) standards or be on the University of Southern California approval list. The devices shall be installed and tested (both initial and periodic testing thereafter) in accordance with the manufacturer's recommendations or the local cross-connection control program, whichever is more stringent. Contact Joanie Hartley at (919) 996-5923 or joanie.hartley@raleighnc.gov for more information

GENERAL NOTES:

- . CONTRACTOR TO FIELD VERIFY LOCATION & ELEVATION OF ALL EXISTING UTILITIES PRIOR TO CONSTRUCTION.
- 2. UTILITY CONSTRUCTION SHALL BE IN ACCORDANCE WITH CITY OF 430 -RALEIGH AND / OR NCDOT STANDARDS AND SPECIFICATIONS UNLESS OTHERWISE NOTED.
- 3. PROPOSED PRIVATE SANITARY SEWER TO BE 8" PVC.
- 4. PROPOSED PUBLIC WATER LINE TO BE 6" DIP.
- 5. 30' PUBLIC CITY OF RALEIGH WATERLINE EASEMENT AND 5' CITY OF RALEIGH WATERLINE EASEMENT TO EACH METER AND FIRE HYDRANT TO BE RECORDED.

ATTENTION CONTRACTORS:

The Construction Contractor responsible for the extension of water, sewer, and/or reuse, as approved in these plans, is responsible for contacting the PUBLIC WORKS DEPARTMENT at (919) 996-2409. and the PUBLIC UTILITIES DEPARTMENT at (919)996-4540 at least twenty four hours prior to beginning any of their construction.

FAILURE to notify both City Departments in advance of beginning construction, will result in the issuance of monetary fines, and require reinstallation of any water or sewer facilities not inspected as a result of this notification failure.

FAILURE to call for Inspection, Install a Downstream Plug, have


future work in the CITY OF RALEIGH.


Permitted Plans on the jobsite, or any other Violation of CITY OF

RALEIGH STANDARDS will result in a Fine and Possible Exclusion from

PROP SEWER SERVICE (TYP) - PROP WATER SERVICE (TYP) - PROP SEWER SERVICE (TYP) PROP SEWER -

Rolesville Ridge Dr. Plan

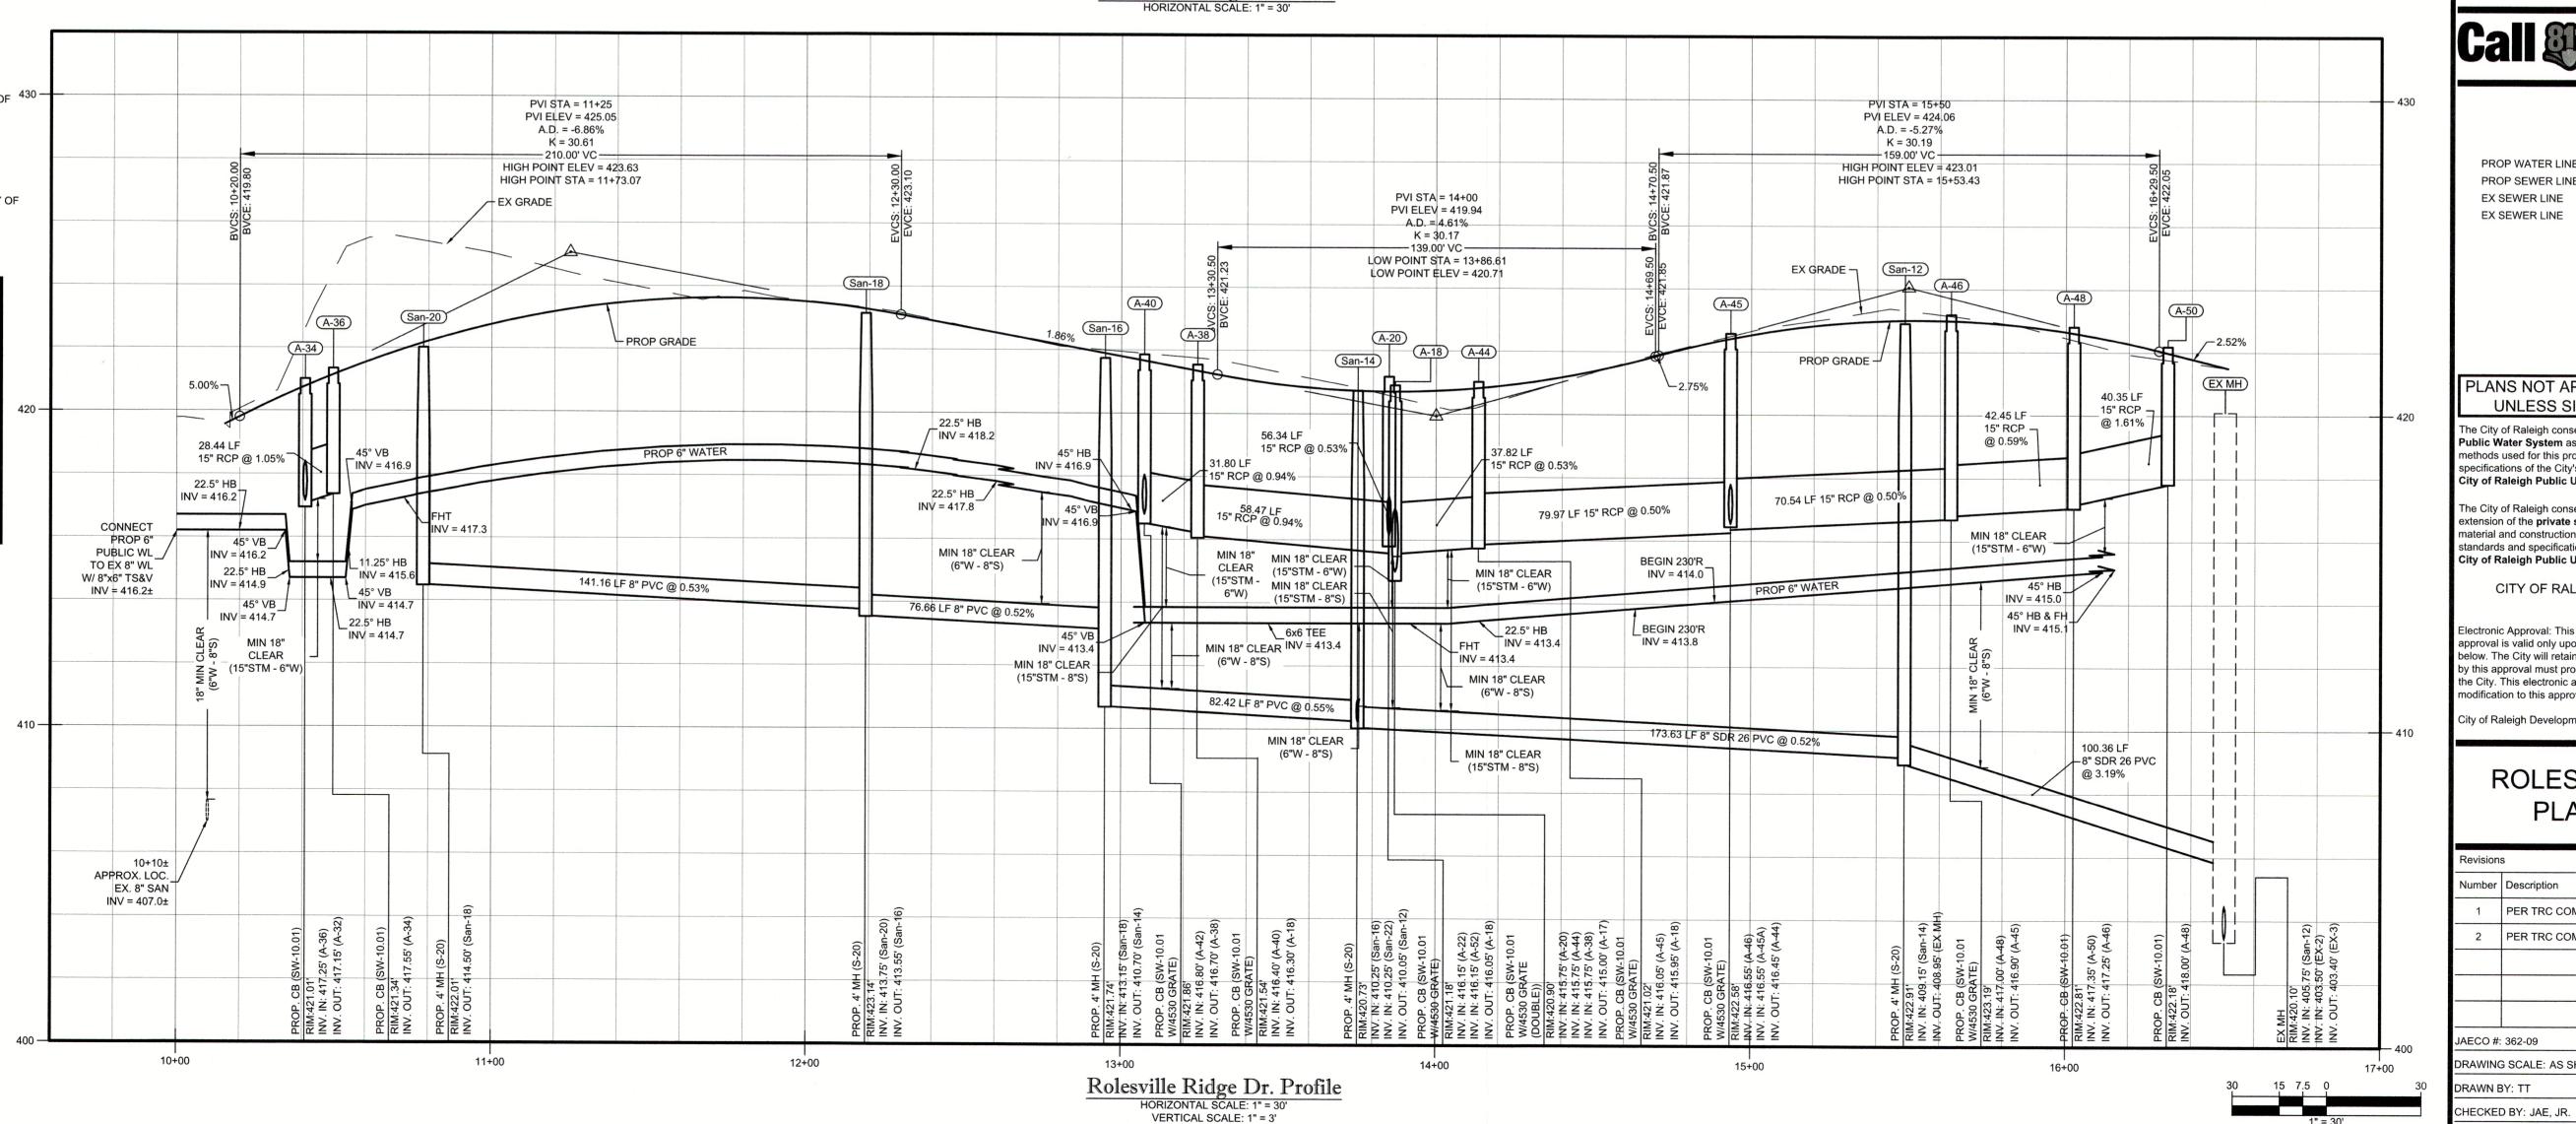


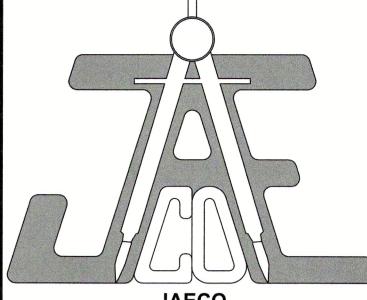

JAECO Consulting Engineers and Land Surveyors

> NC License F-0289 333 Wade Ave., Raleigh, N.C. 27605 Phone: (919) 828-4428 Fax: (919) 828-4711 E-mail: info@jaeco.com

> > www.jaeco.com

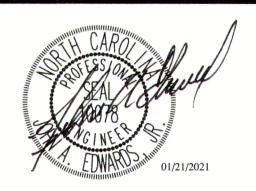

A-MASTER TEAM TOWNHOMES 151 GRAND ROAD WAY ROLESVILLE, NC 27571

A-MASTER TEAM, LLC 6200 FALLS OF NEUSE ROAD SUITE 10 RALEIGH, NC 27609

Call before you dig.

<u>LEGEND</u>

EX SEWER LINE ______SS____

PLANS NOT APPROVED FOR CONSTRUCTION

UNLESS SIGNED BY CITY OF RALEIGH The City of Raleigh consents to the connection and extension of the City's Public Water System as shown on this plan. The material and Construction methods used for this project shall conform to the standards and specifications of the City's Public Utilities Handbook. City of Raleigh Public Utilities Department Permit # W-3745

The City of Raleigh consents to the connection to its public sewer system and extension of the **private sewer collection** system as shown on this plan. The material and constructions methods used for this project shall conform to the standards and specifications of the City's Public Utilities Handbook. City of Raleigh Public Utilities Department Permit # S-4760(P)

CITY OF RALEIGH - PLANS AUTHORIZED FOR CONSTRUCTION

electronic Approval: This approval is being issued electronically. This pproval is valid only upon the signature of a City of Raleigh Review Officer pelow. The City will retain a copy of the approved plans. Any work authorized by this approval must proceed in accordance with the plans kept on file with the City. This electronic approval may not be edited once issued. Any modification to this approval once issued will invalidate this approval. City of Raleigh Development Approval _

ROLESVILLE RIDGE RD PLAN & PROFILE

Raleigh Water Review Officer

Revision	S	
Number	Description	Date
1	PER TRC COMMENTS	09/29/20
2	PER TRC COMMENTS	01/21/2
JAECO #:	: 362-09	
DRAWING	G SCALE: AS SHOWN	
DRAWN E	BY: TT	
CHECKE	D BY: JAE JR	

DATE ISSUED: 06/22/2020