FRAZIER FARM PARK

V2 - CID-23-05

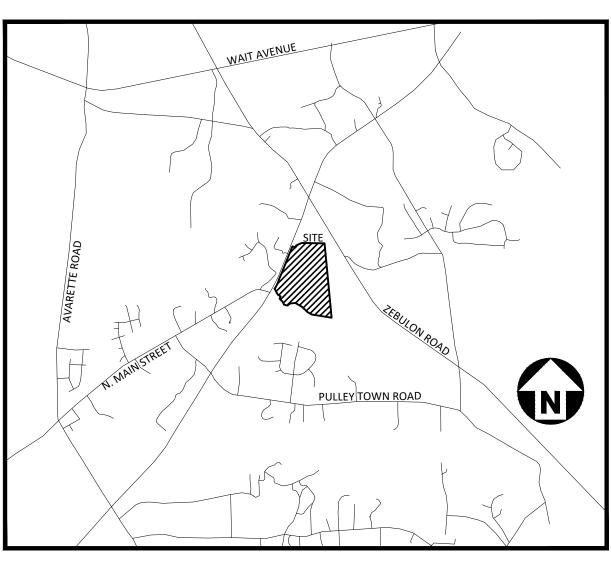
11624 LOUISBURG ROAD ROLESVILLE, NORTH CAROLINA, 27282

90% CONSTRUCTION DRAWINGS PHASE 1A

PROJECT NUMBER: 2020110039 DATE: AUGUST 1, 2023

SITE DATA

502 S	NN OF ROLESVILLE OUTHTOWN CIRCLE , NORTH CAROLINA 27571	
2905 DURHAM,	DAMS COMPANY ERIDIAN PARKWAY ORTH CAROLINA 27713 19. 361. 5000 PMCADAMSCO.COM	
PARCEL ID NUMBER: 1779076610		
TOTAL SITE ACREAGE:	±116.56 AC	
LAND AREA OF PARCEL	±105.00 AC	
SITE ACREAGE AS PART OF THIS DEVELOPMENT:	±8.00 AC	
CURRENT ZONING:	PARKS AND NATURAL RESOURCES (PNR)	
PROPOSED ZONING:	PARKS AND NATURAL RESOURCES (PNR)	
CURRENT LAND USE:	PUBLIC RECREATION FACILITY	
PROPOSED LAND USE:	PUBLIC RECREATION FACILITY	
ADJOINING PROPERTY OWNERS:	PIN: 1779083669, 1779263965, 1779190357	
DISTURBED AREA:	±8.50 AC	
FEMA REGULATIONS:		
WATERSHED(S):	NEUSE	



Know what's below.
Call before you dig. **VICINITY MAP**

OR EXCAVATION TO HAVE EXISTING UTILITIES LOCATED CONTRACTOR SHALL CONTACT ANY LOCAL UTILITIES THAT PROVIDE THEIR OWN LOCATOR SERVICES INDEPENDENT OF "NC811". REPORT ANY DISCREPANCIES TO THE ENGINEER IMMEDIATELY

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C1.01	EXISTING CONDITION	S
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C2.03	SITE PLAN 'AREA D'	
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C3.00	OVERALL GRADING &	DRAINAGE PLAN
C3.01	GRADING & DRAINAG	SE PLAN: 'AREA A'
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C3.01	FLAIN AIND FROITLE	SIREEL B , SIA. 10+00 INKO SIA. 10+33
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C7.02		NING CROSS SECTIONS
C7.03	LOOISDONG NO WIDE	MING CROSS SECTIONS
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C8.01	SITE DETAILS	
C8.02	STORM DRAINAGE &	UTILITY DETAILS
C8.03	STORM DRAINAGE &	UTILITY DETAILS

GENERAL NOTES:

ANY STRUCTURE TO BE REMOVED SHALL REQUIRE ADEMOLITION PERMIT FROM BUILDING INSPECTIONS.

PRELIMINARY DRAWING - NOT RELEASED FOR CONSTRUCTION

FRAZIER FARM PARK PHASE 1A 11624 LOUISBURG ROAD ROLESVILLE, NC 27282 PROJECT NUMBER: 2020110039



The John R. McAdams Company, Inc 2905 Meridian Parkway Durham, NC 27713

phone 919. 361. 5000 fax 919. 361. 2269 license number: C-0293, C-187

www.mcadamsco.com

CONTACT

ERIC DOMONELL domonell@mcadamsco.com PHONE: 919. 287. 0765

CLIENT

TOWN OF ROLESVILLE **502 SOUTHTOWN CIRCLE** ROLESVILLE, NORTH CAROLINA 27571 PHONE: 919. 554. 6582

PROJECT DIRECTORY

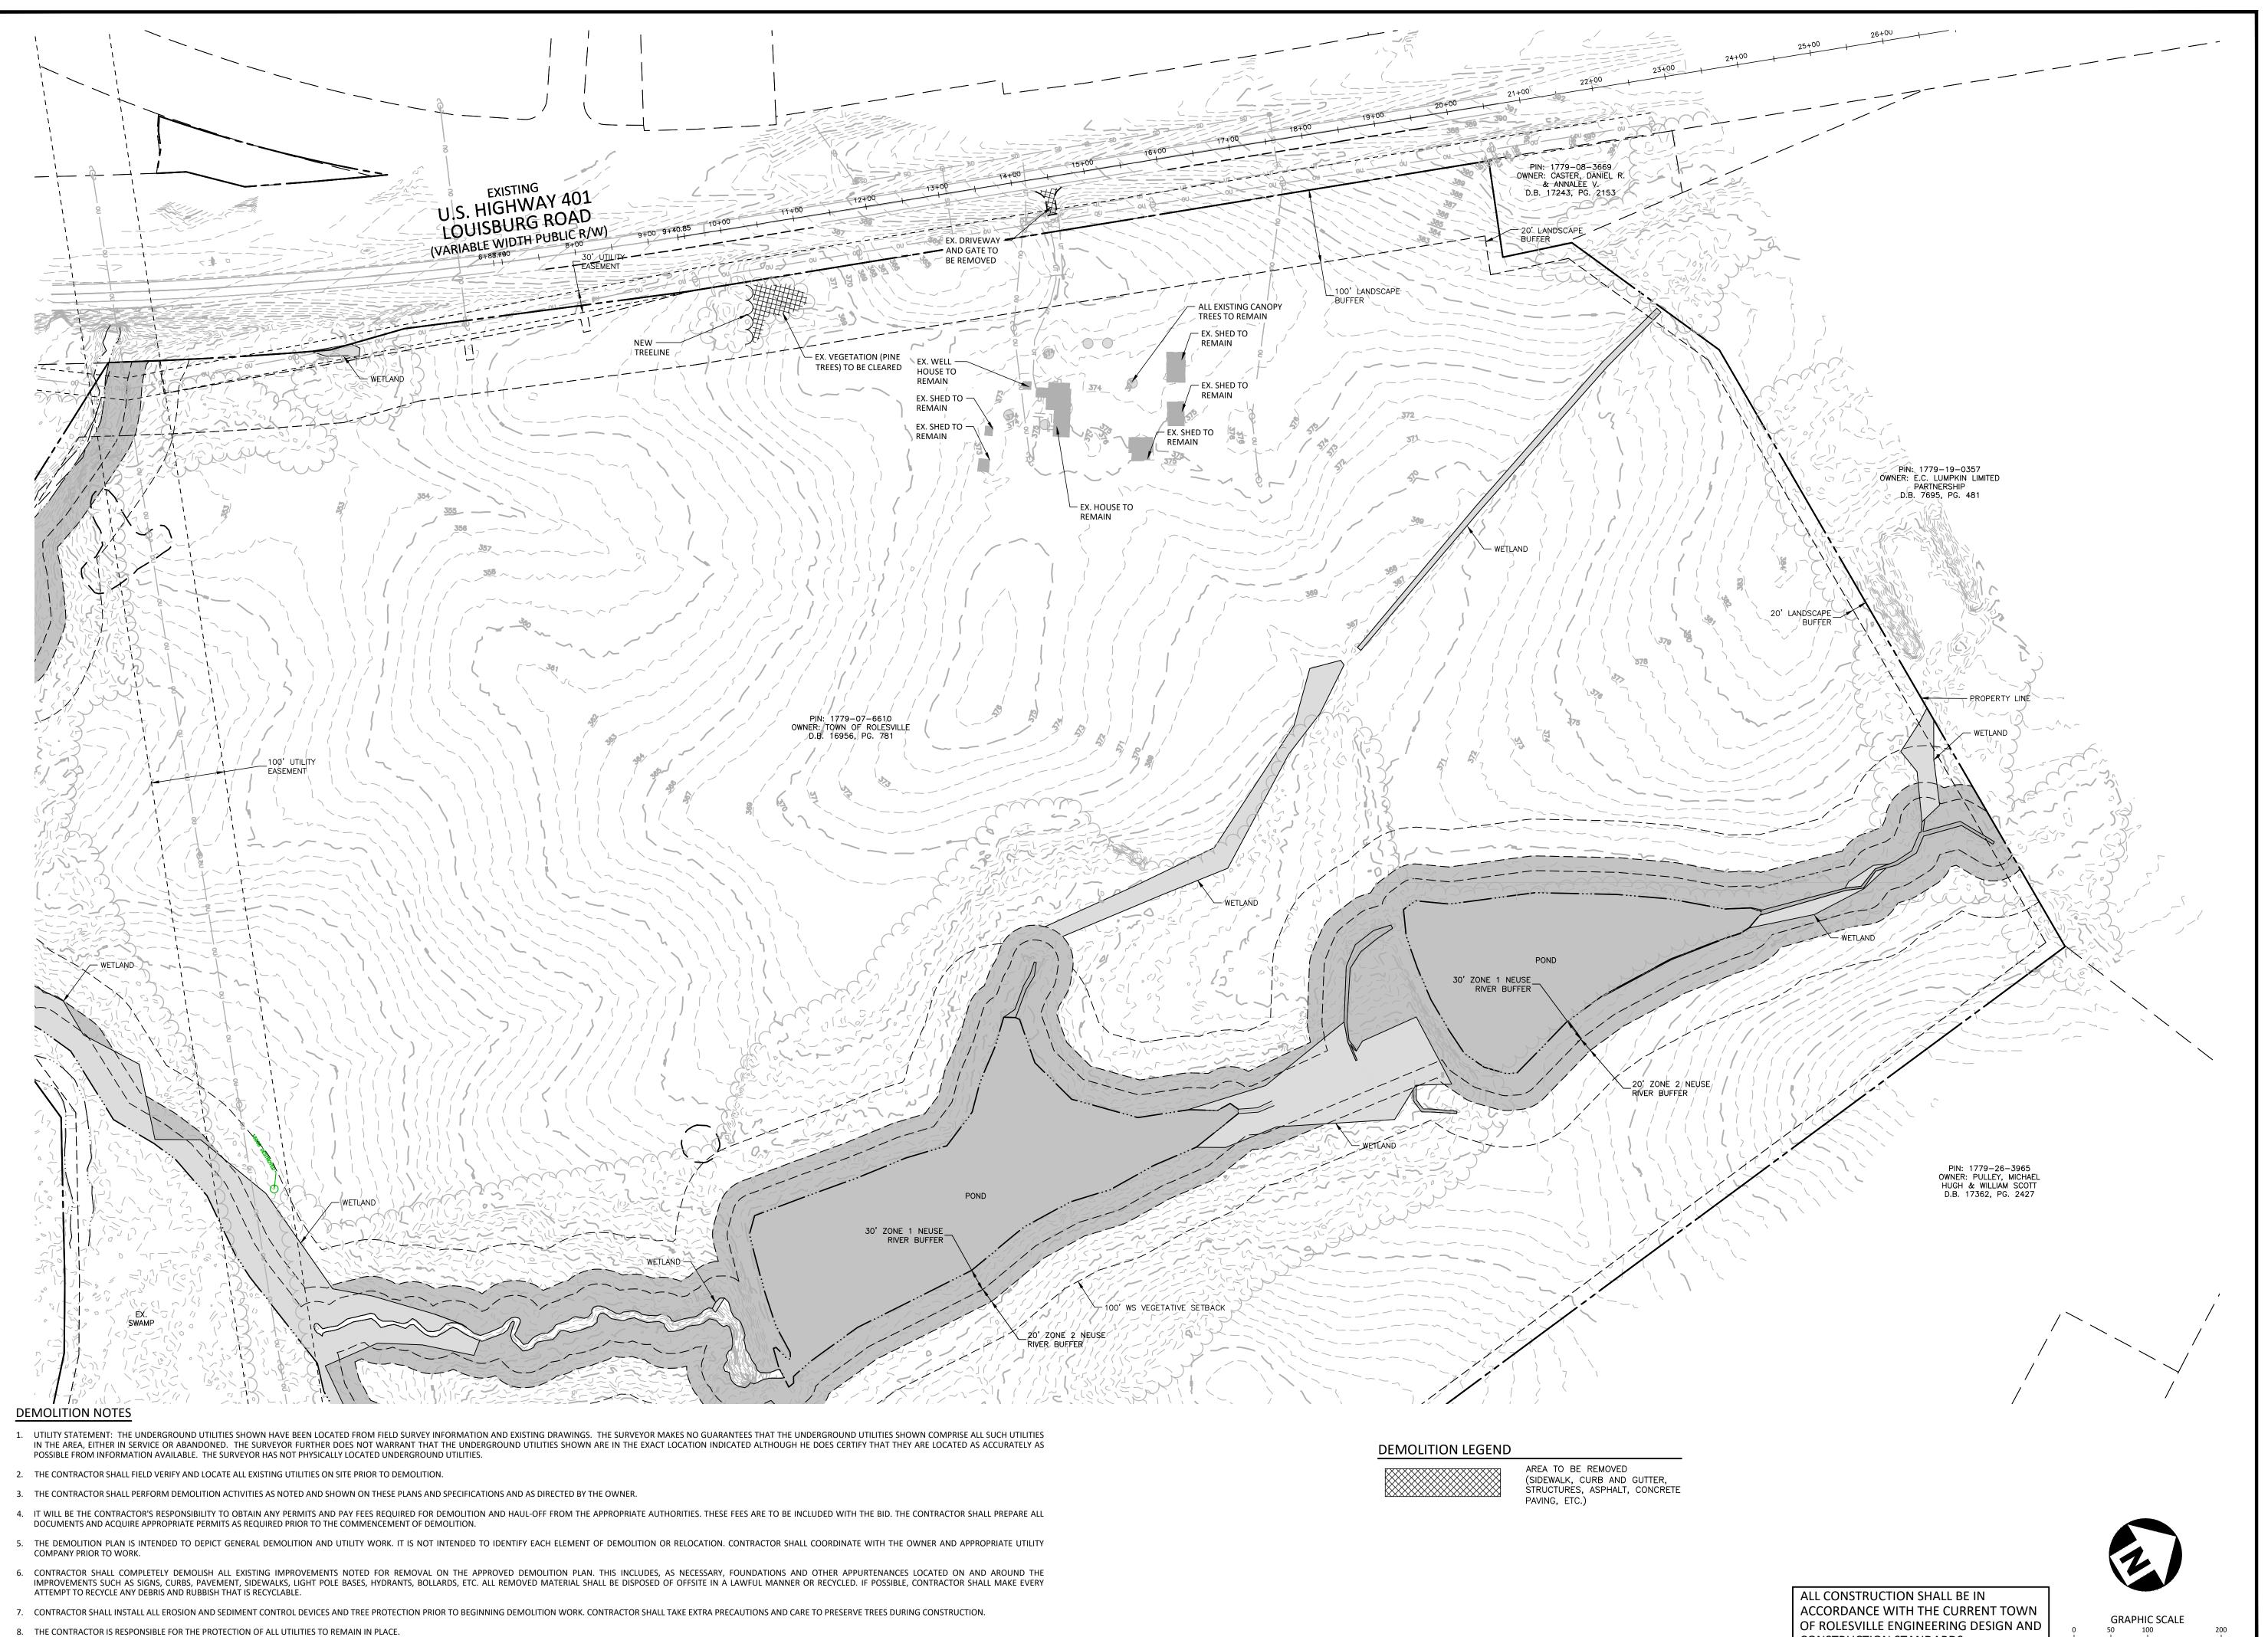




REVISIONS

1 08.01.2023 TRC RESUBMITTAL

CONSTRUCTION DRAWINGS FOR:



9. ALL EXISTING ITEMS TO REMAIN WHICH ARE DAMAGED DURING CONSTRUCTION SHALL BE RESTORED TO THEIR ORIGINAL CONDITION AT THE SOLE EXPENSE OF THE CONTRACTOR.

10. CONTRACTOR TO FLAG ALL TREES SLATED FOR REMOVAL AND SEEK APPROVAL FROM LANDSCAPE ARCHITECT PRIOR TO DEMOLISHING.

2905 Meridian Parkway Durham, NC 27713

The John R. McAdams Company, Inc.


fax 919. 361. 2269 license number: C-0293

phone 919. 361. 5000

www.mcadamsco.com

CLIENT

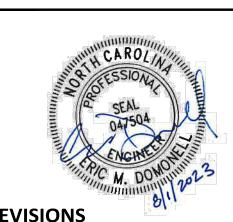NAME: TOWN OF ROLESVILLE ADDRESS: 502 SOUTHTOWN CIRCLE ADDRESS: ROLESVILLE NC 27571 PHONE: 919.554.6582



REVISIONS

PLAN INFORMATION

PROJECT NO. 202011039 2020110039-PH1-DM1 FILENAME


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DATE 08.01.2023 SHEET

OVERALL DEMOLITION

PRELIMINARY DRAWING - NOT RELEASED FOR CONSTRUCTION

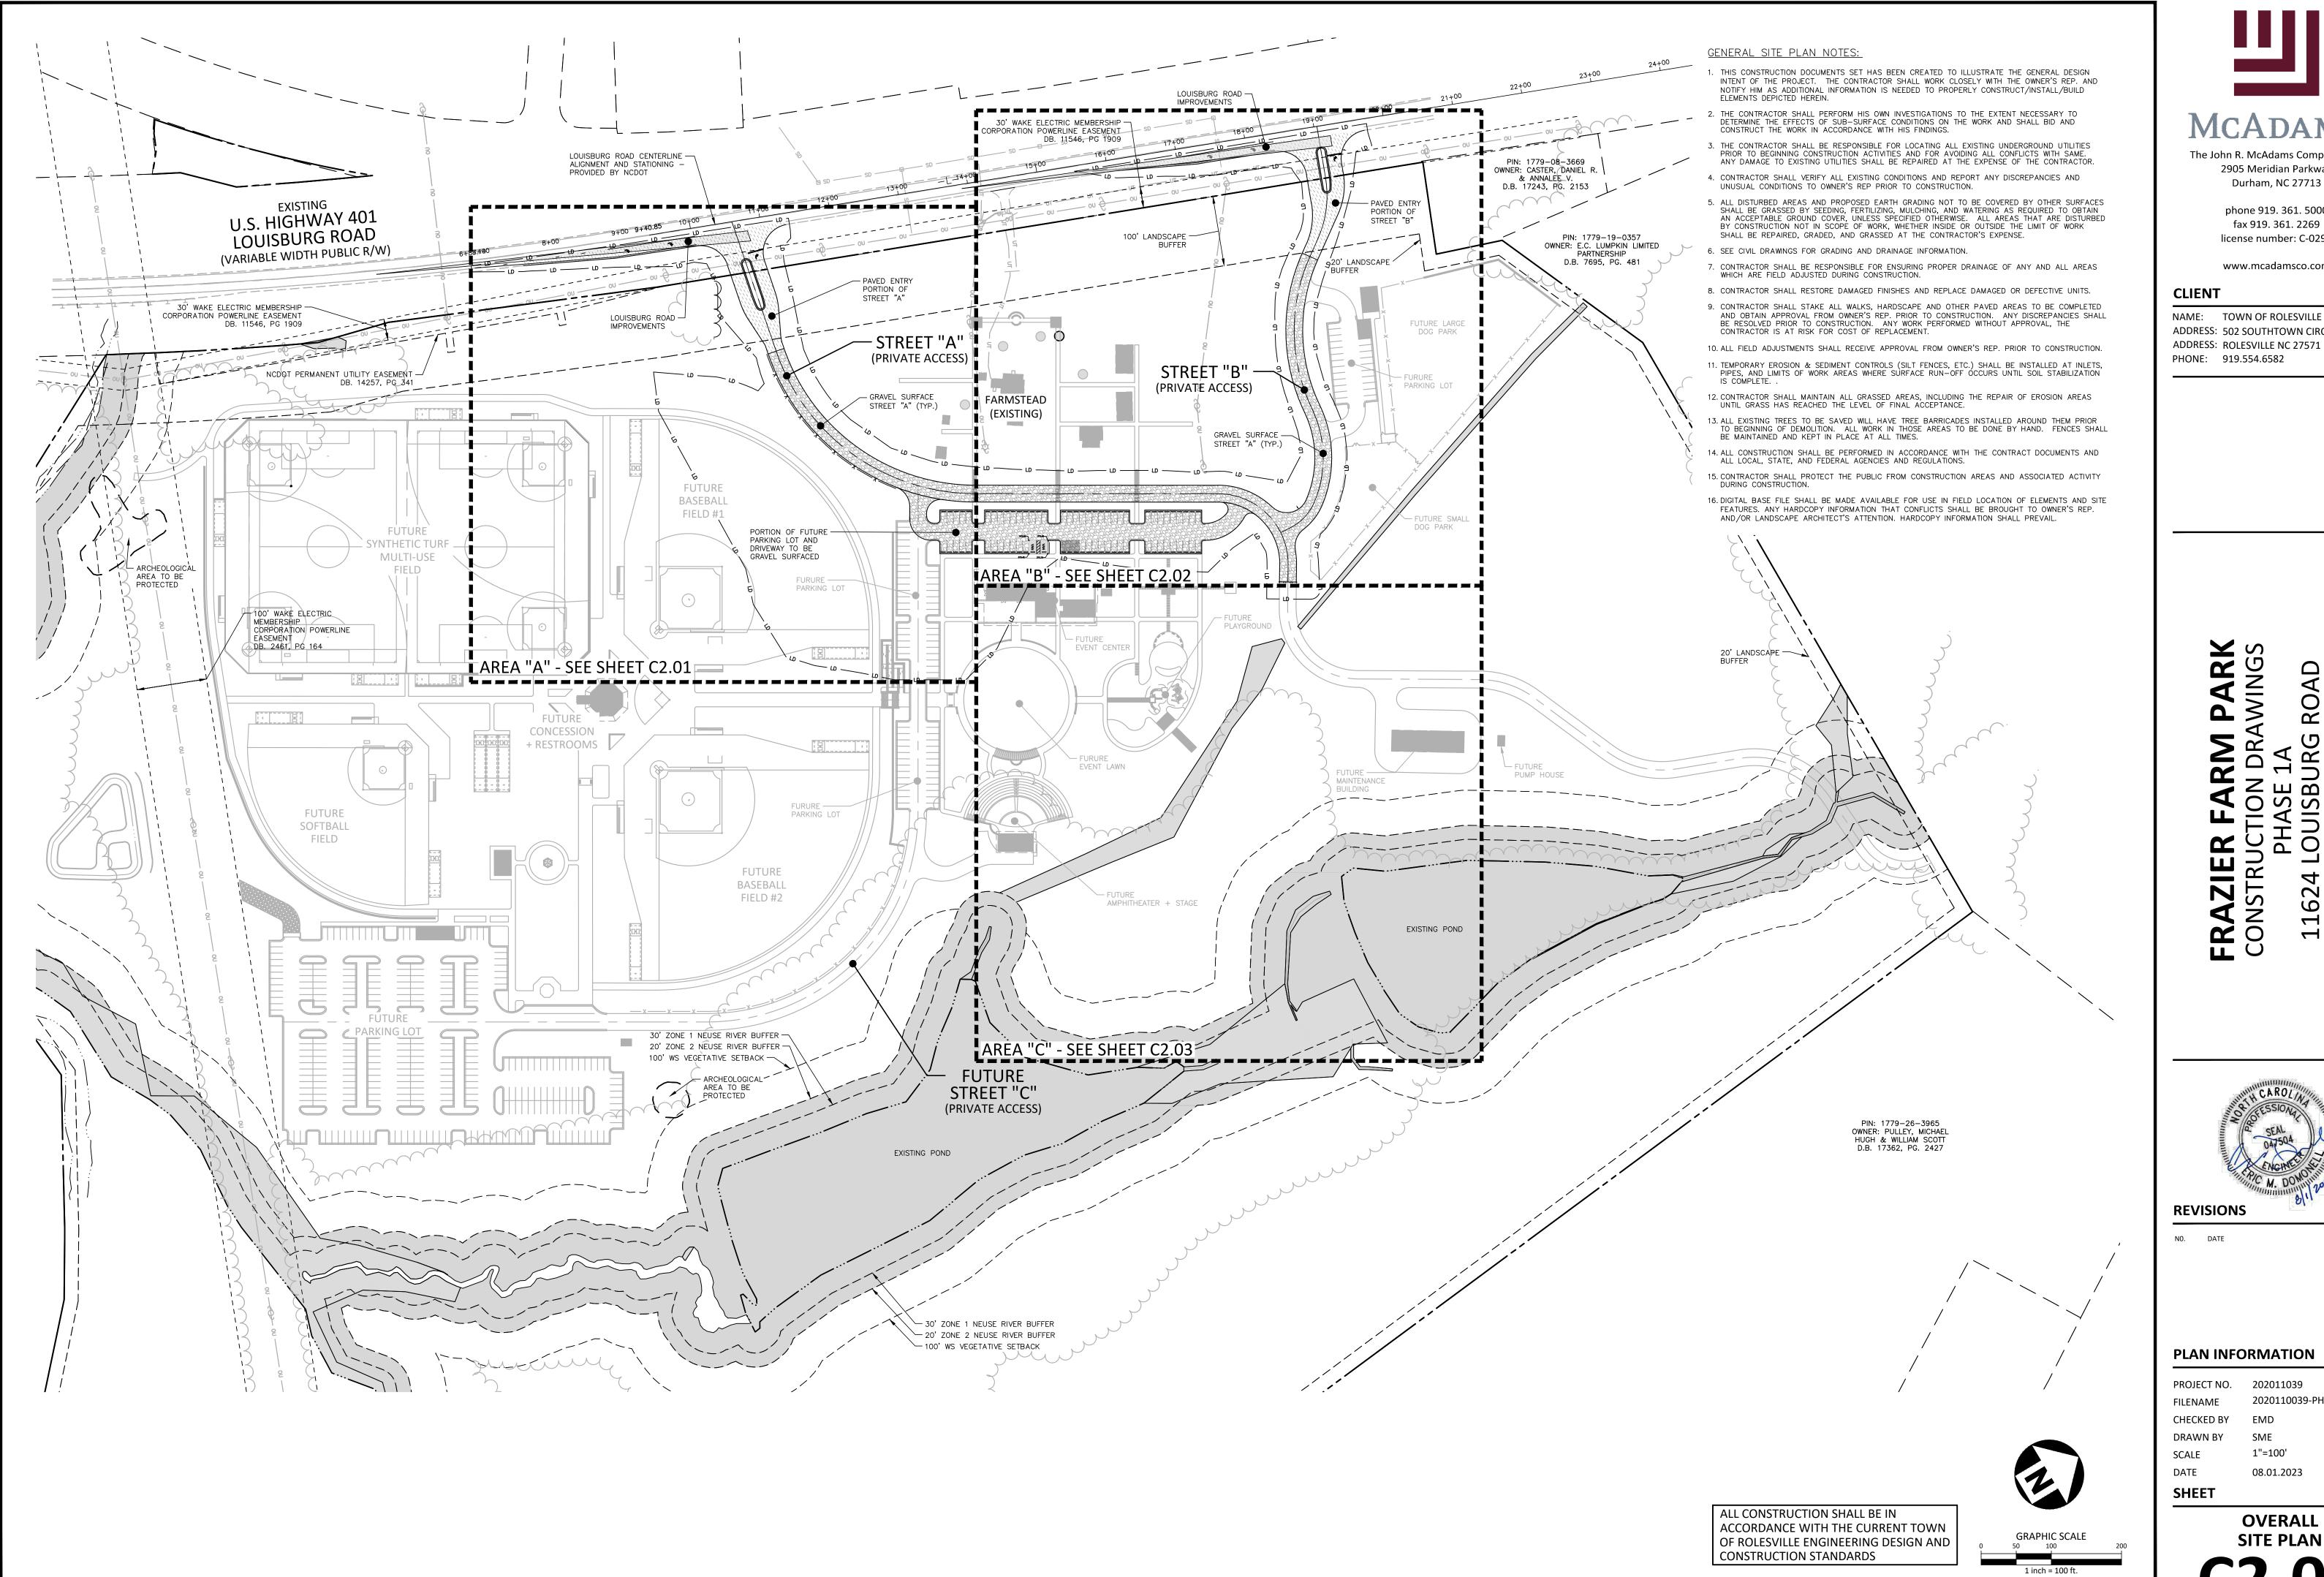CONSTRUCTION STANDARDS





The John R. McAdams Company, Inc.

2905 Meridian Parkway

Durham, NC 27713


phone 919. 361. 5000

fax 919. 361. 2269

license number: C-0293

www.mcadamsco.com

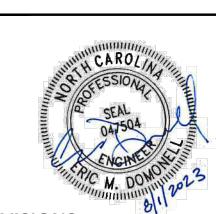ADDRESS: 502 SOUTHTOWN CIRCLE ADDRESS: ROLESVILLE NC 27571



REVISIONS

NO. DATE

PLAN INFORMATION

PROJECT NO. 202011039 2020110039-PH1-OAS1 FILENAME CHECKED BY

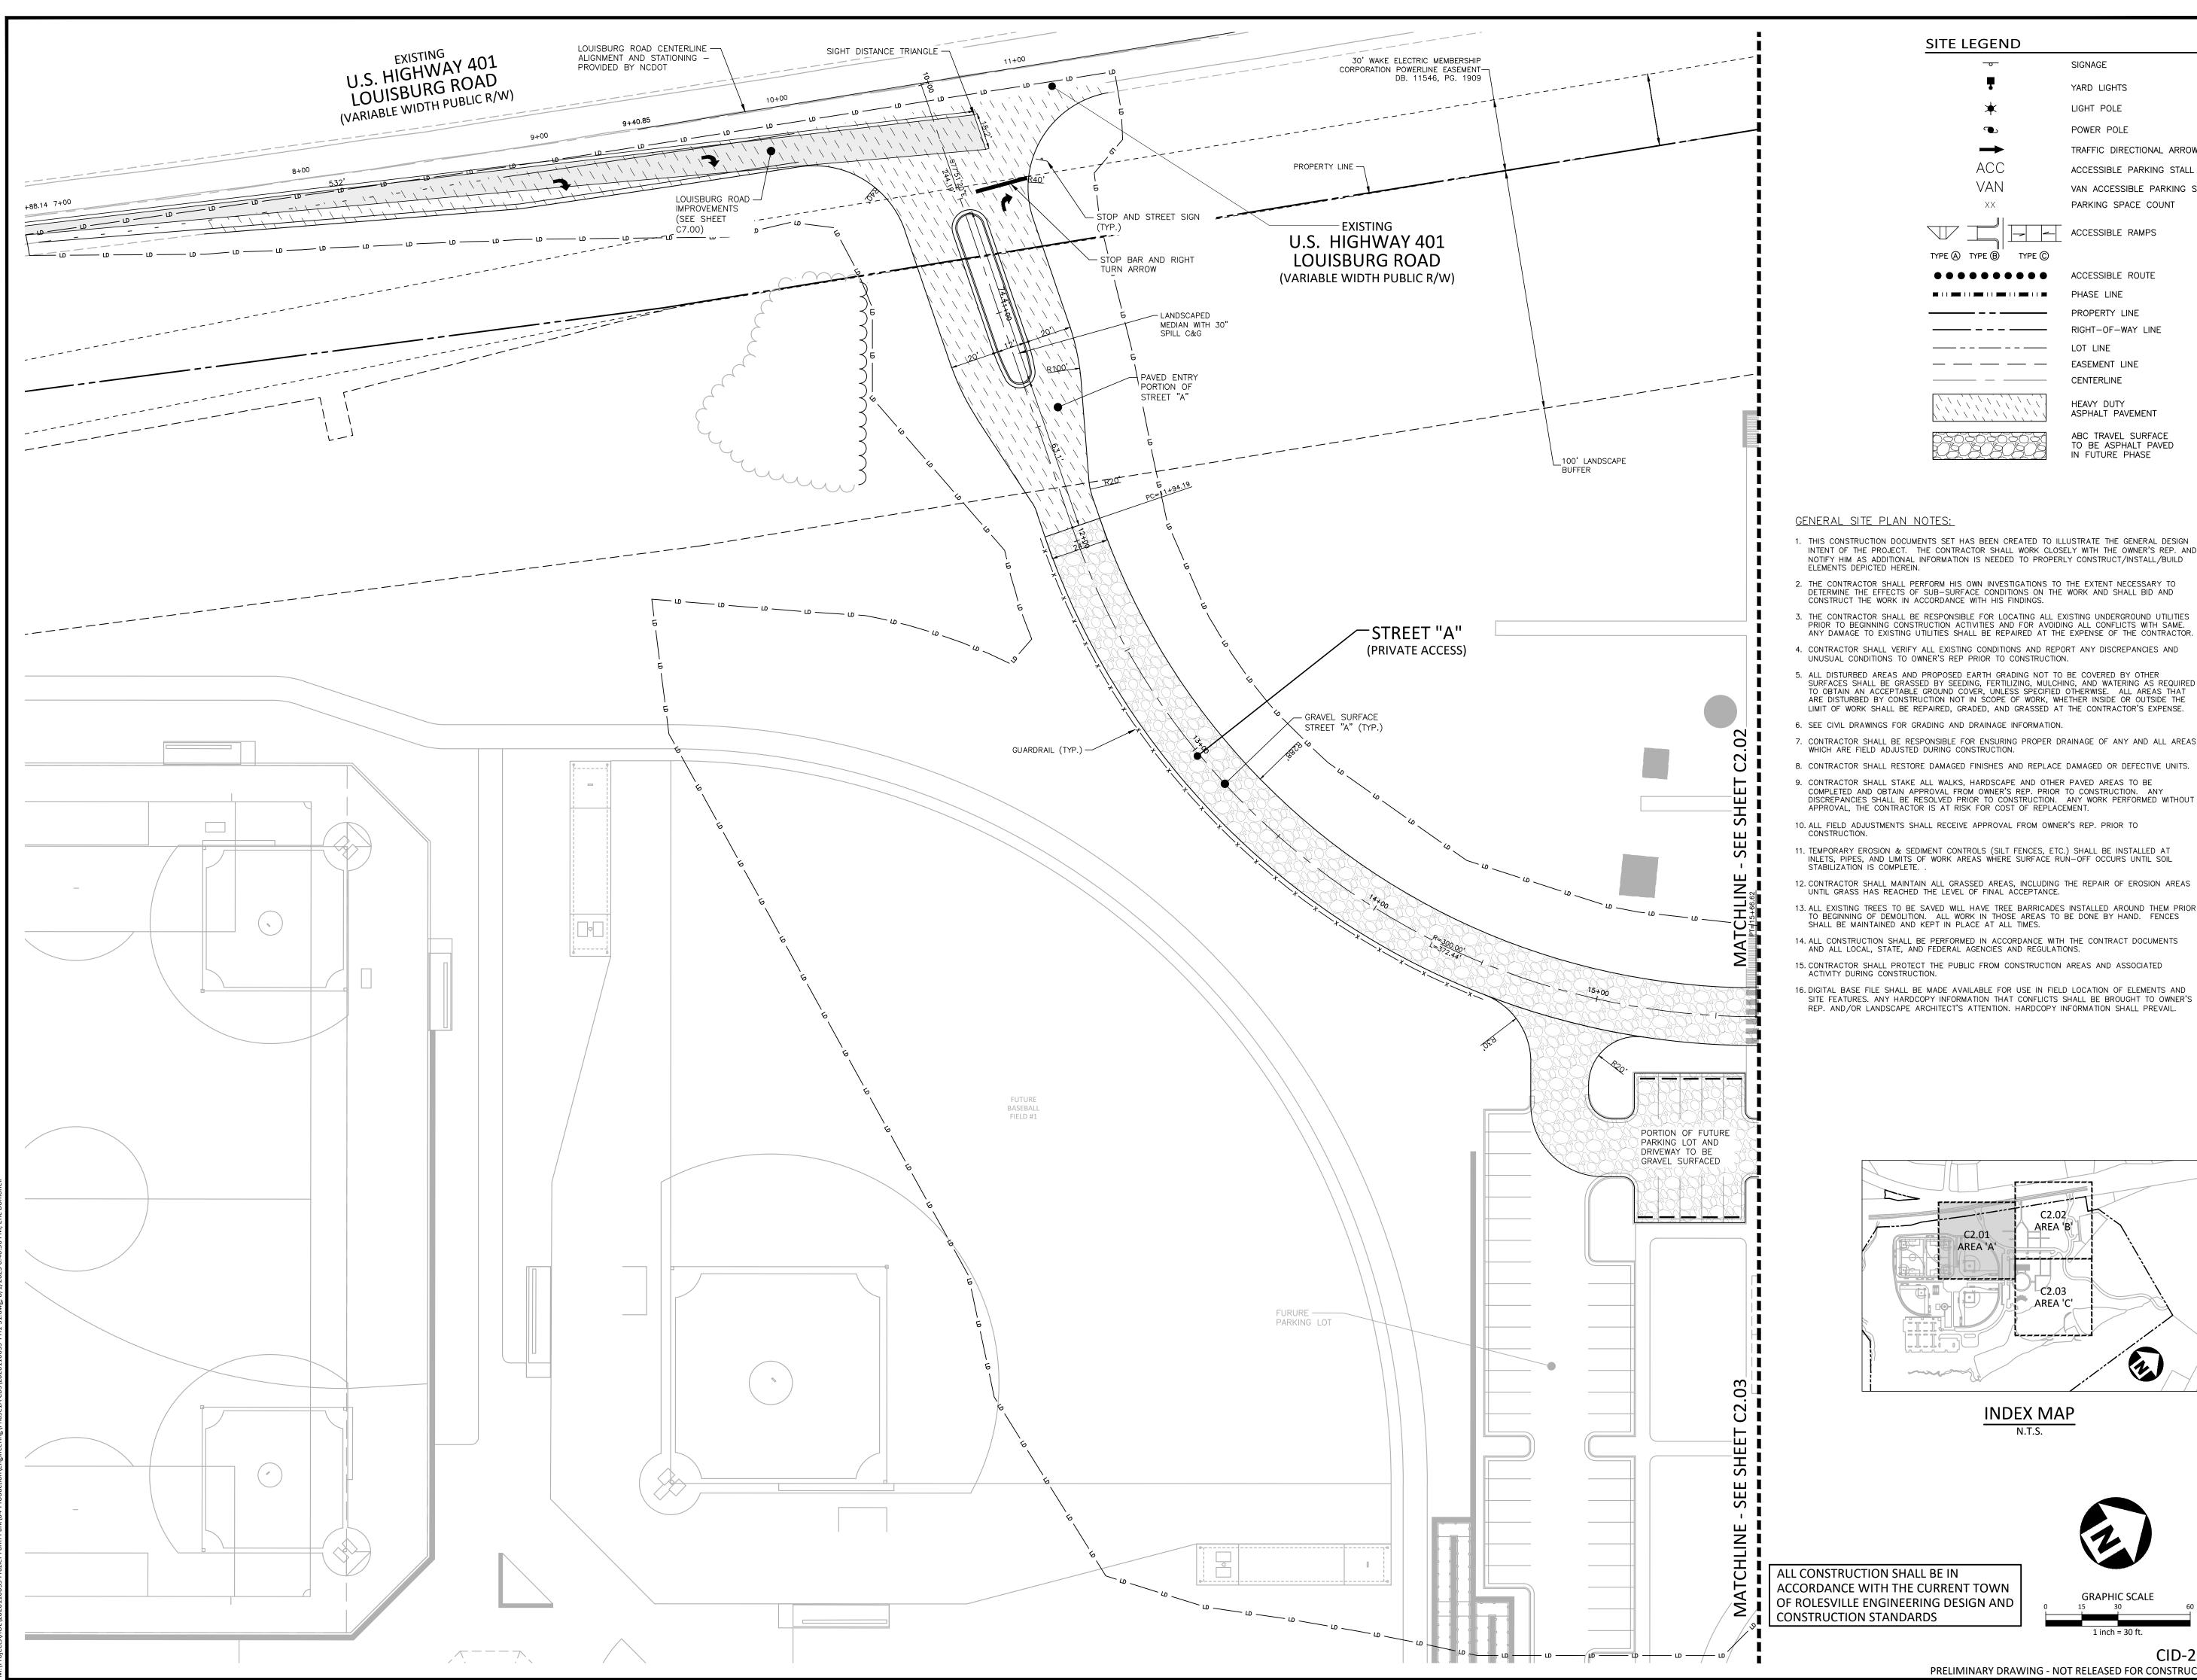
DRAWN BY 1"=100' SCALE DATE 08.01.2023

CID-23-5

PRELIMINARY DRAWING - NOT RELEASED FOR CONSTRUCTION

SHEET **OVERALL**

SITE PLAN





> phone 919. 361. 5000 fax 919. 361. 2269 license number: C-0293

> www.mcadamsco.com

CLIENT

PHONE: 919.554.6582

PARI WING

NAME: TOWN OF ROLESVILLE ADDRESS: 502 SOUTHTOWN CIRCLE ADDRESS: ROLESVILLE NC 27571

GENERAL SITE PLAN NOTES:

1. THIS CONSTRUCTION DOCUMENTS SET HAS BEEN CREATED TO ILLUSTRATE THE GENERAL DESIGN INTENT OF THE PROJECT. THE CONTRACTOR SHALL WORK CLOSELY WITH THE OWNER'S REP. AND NOTIFY HIM AS ADDITIONAL INFORMATION IS NEEDED TO PROPERLY CONSTRUCT/INSTALL/BUILD ELEMENTS DEPICTED HEREIN.

SITE LEGEND

TYPE (A) TYPE (B) TYPE (C)

● ● ● ● ● ● ● ● ACCESSIBLE ROUTE

PROPERTY LINE

SIGNAGE

YARD LIGHTS

LIGHT POLE

POWER POLE

TRAFFIC DIRECTIONAL ARROW

ACCESSIBLE PARKING STALL

PARKING SPACE COUNT

ACCESSIBLE RAMPS

RIGHT-OF-WAY LINE

ABC TRAVEL SURFACE TO BE ASPHALT PAVED IN FUTURE PHASE

EASEMENT LINE


CENTERLINE

HEAVY DUTY ASPHALT PAVEMENT


PHASE LINE

VAN ACCESSIBLE PARKING STALL

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INDEX MAP

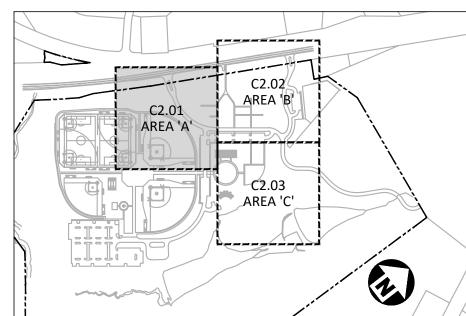

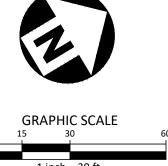PRELIMINARY DRAWING - NOT RELEASED FOR CONSTRUCTION

ALL CONSTRUCTION SHALL BE IN ACCORDANCE WITH THE CURRENT TOWN OF ROLESVILLE ENGINEERING DESIGN AND CONSTRUCTION STANDARDS

REVISIONS

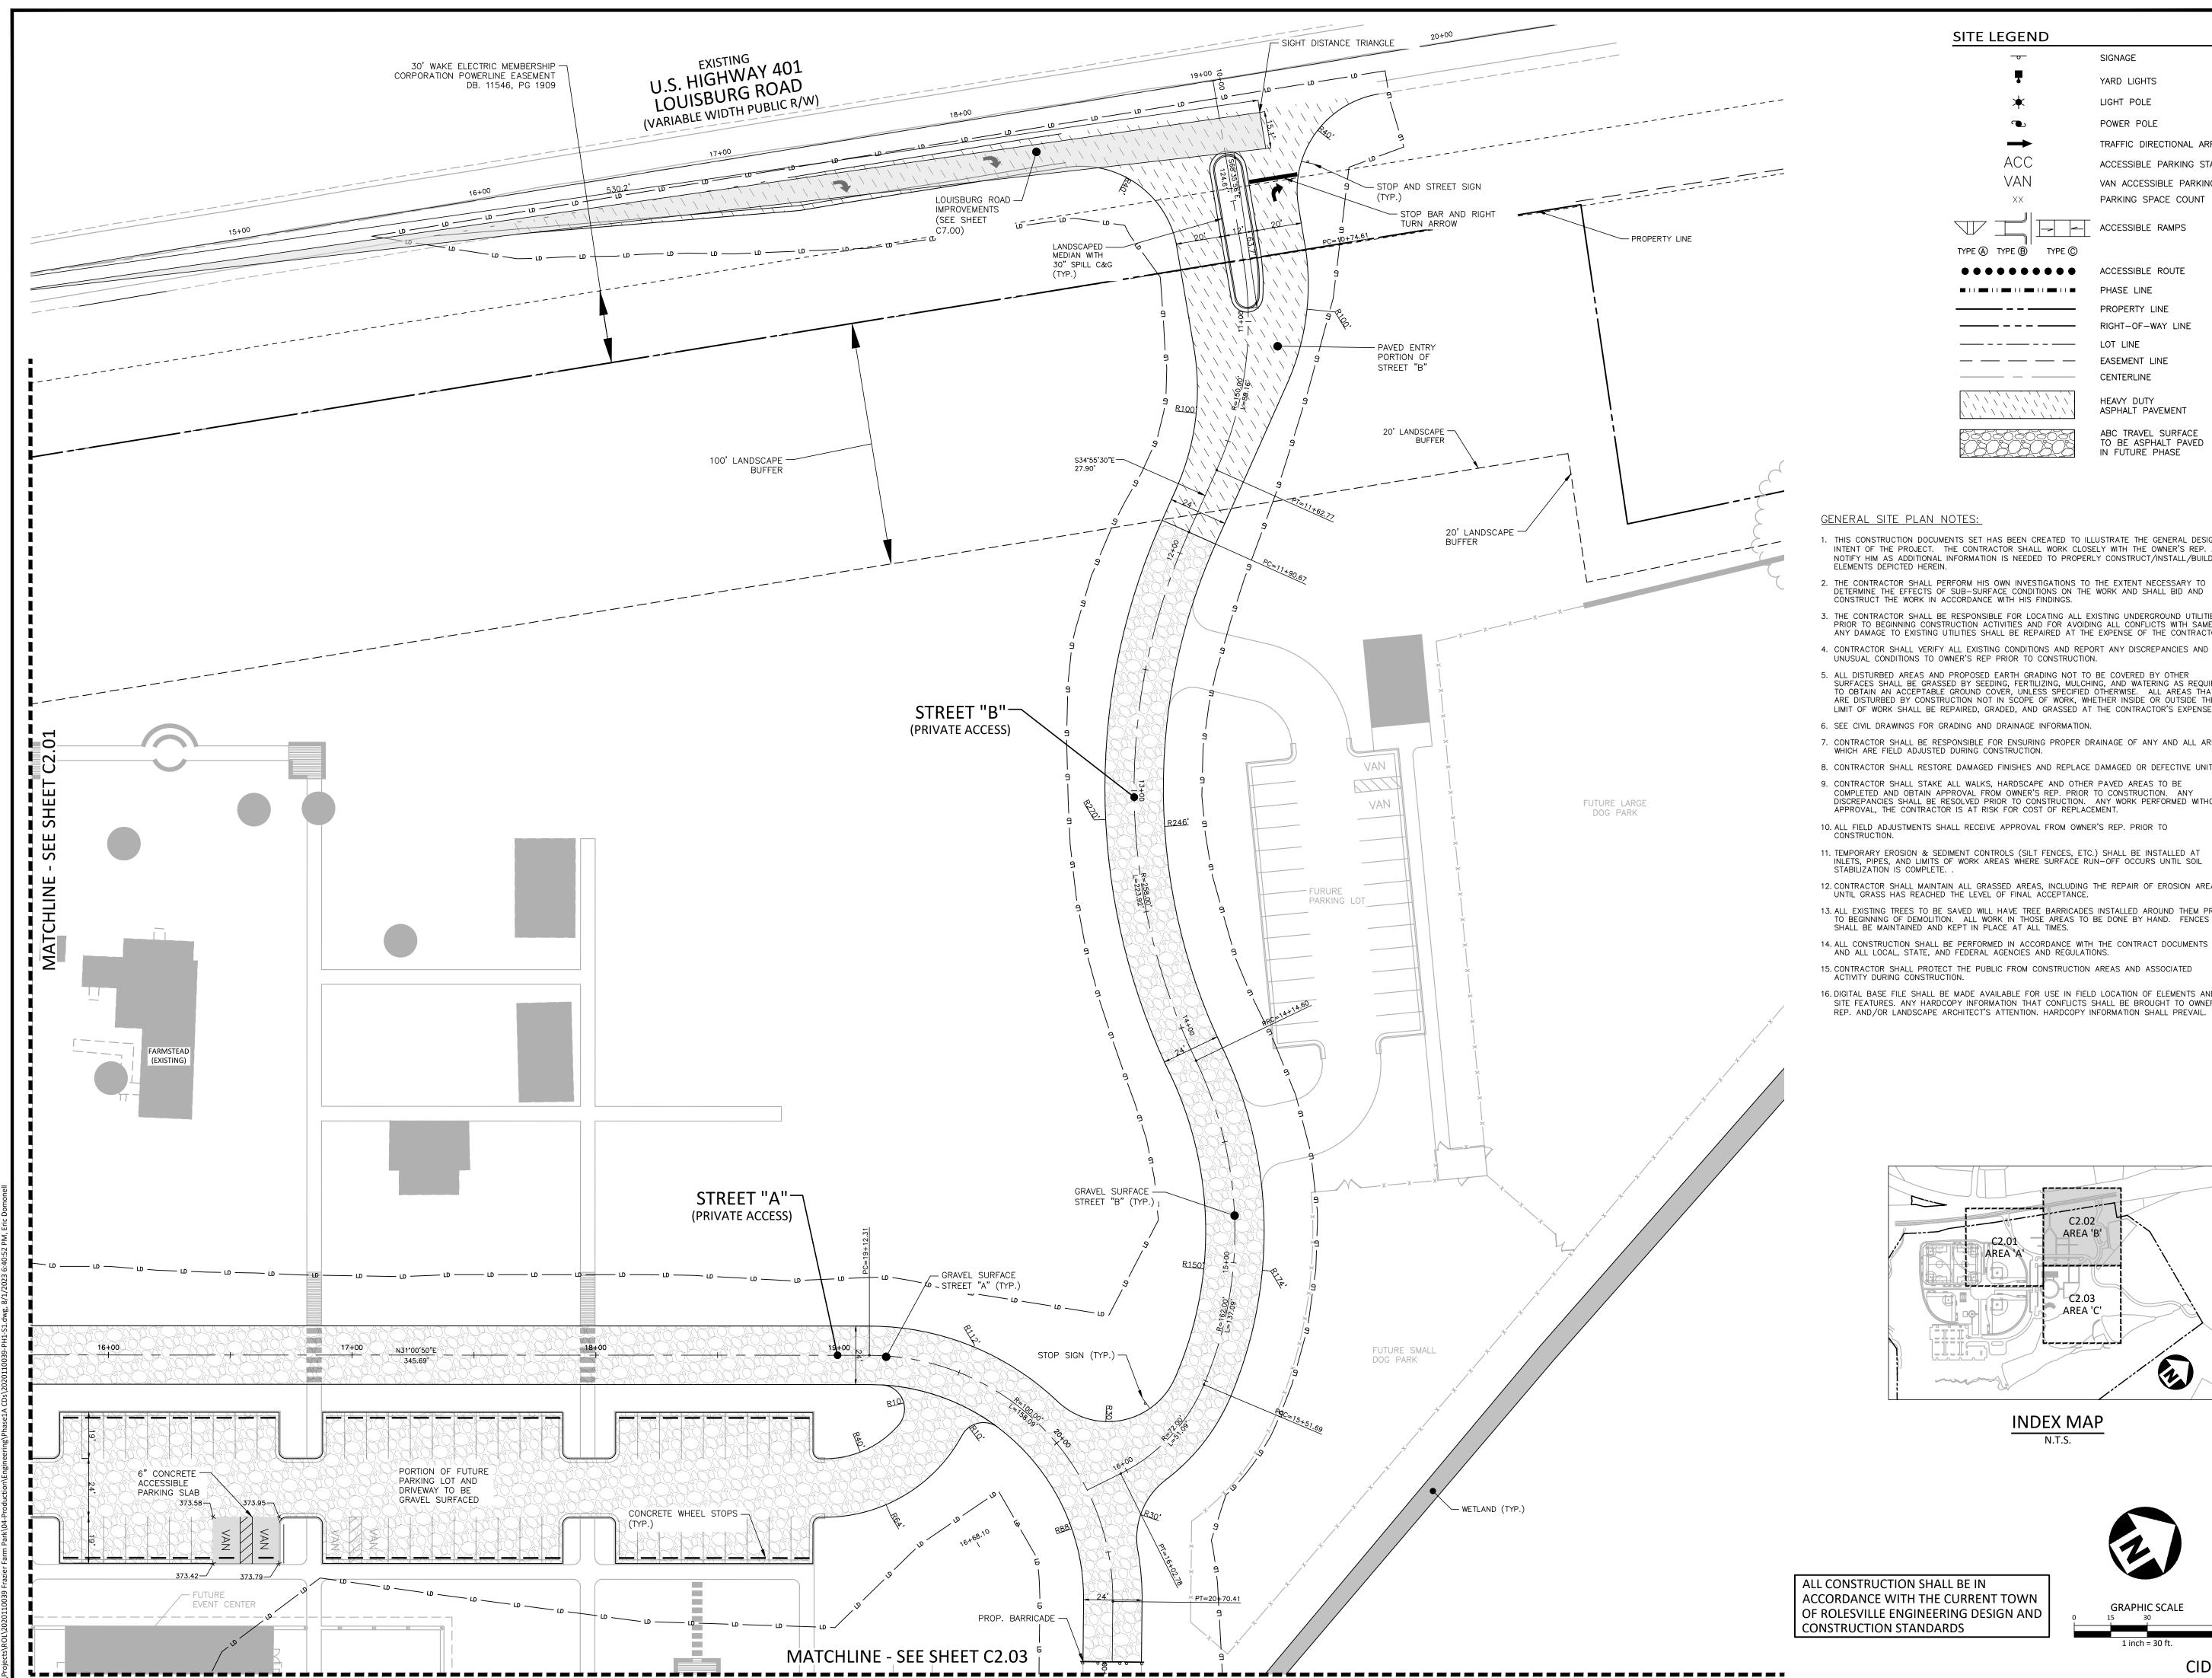
NO. DATE

PLAN INFORMATION

PROJECT NO. 202011039 2020110039-PH1-S1 FILENAME CHECKED BY DRAWN BY

1"=30' SCALE DATE 08.01.2023 **SHEET**

SITE PLAN: AREA 'A'





> phone 919. 361. 5000 fax 919. 361. 2269 license number: C-0293

> www.mcadamsco.com

CLIENT

NAME: TOWN OF ROLESVILLE

PARI WING

FRAZIEFCONSTRUC

ADDRESS: 502 SOUTHTOWN CIRCLE ADDRESS: ROLESVILLE NC 27571 PHONE: 919.554.6582

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SITE LEGEND

TYPE (A) TYPE (B) TYPE (C)

•••••

SIGNAGE

YARD LIGHTS

LIGHT POLE

POWER POLE

TRAFFIC DIRECTIONAL ARROW

ACCESSIBLE PARKING STALL

PARKING SPACE COUNT

ACCESSIBLE RAMPS

ACCESSIBLE ROUTE

RIGHT-OF-WAY LINE

ABC TRAVEL SURFACE TO BE ASPHALT PAVED IN FUTURE PHASE

PHASE LINE

PROPERTY LINE


EASEMENT LINE

CENTERLINE

HEAVY DUTY ASPHALT PAVEMENT

VAN ACCESSIBLE PARKING STALL

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INDEX MAP

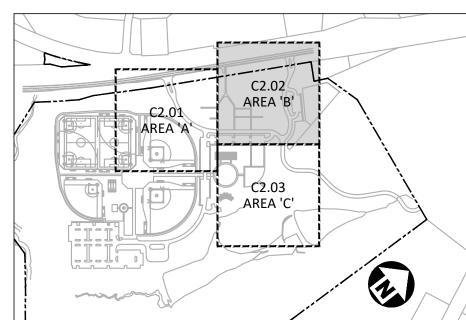GRAPHIC SCALE

PRELIMINARY DRAWING - NOT RELEASED FOR CONSTRUCTION

CID-23-

2020110039-PH1-S1 FILENAME CHECKED BY

REVISIONS

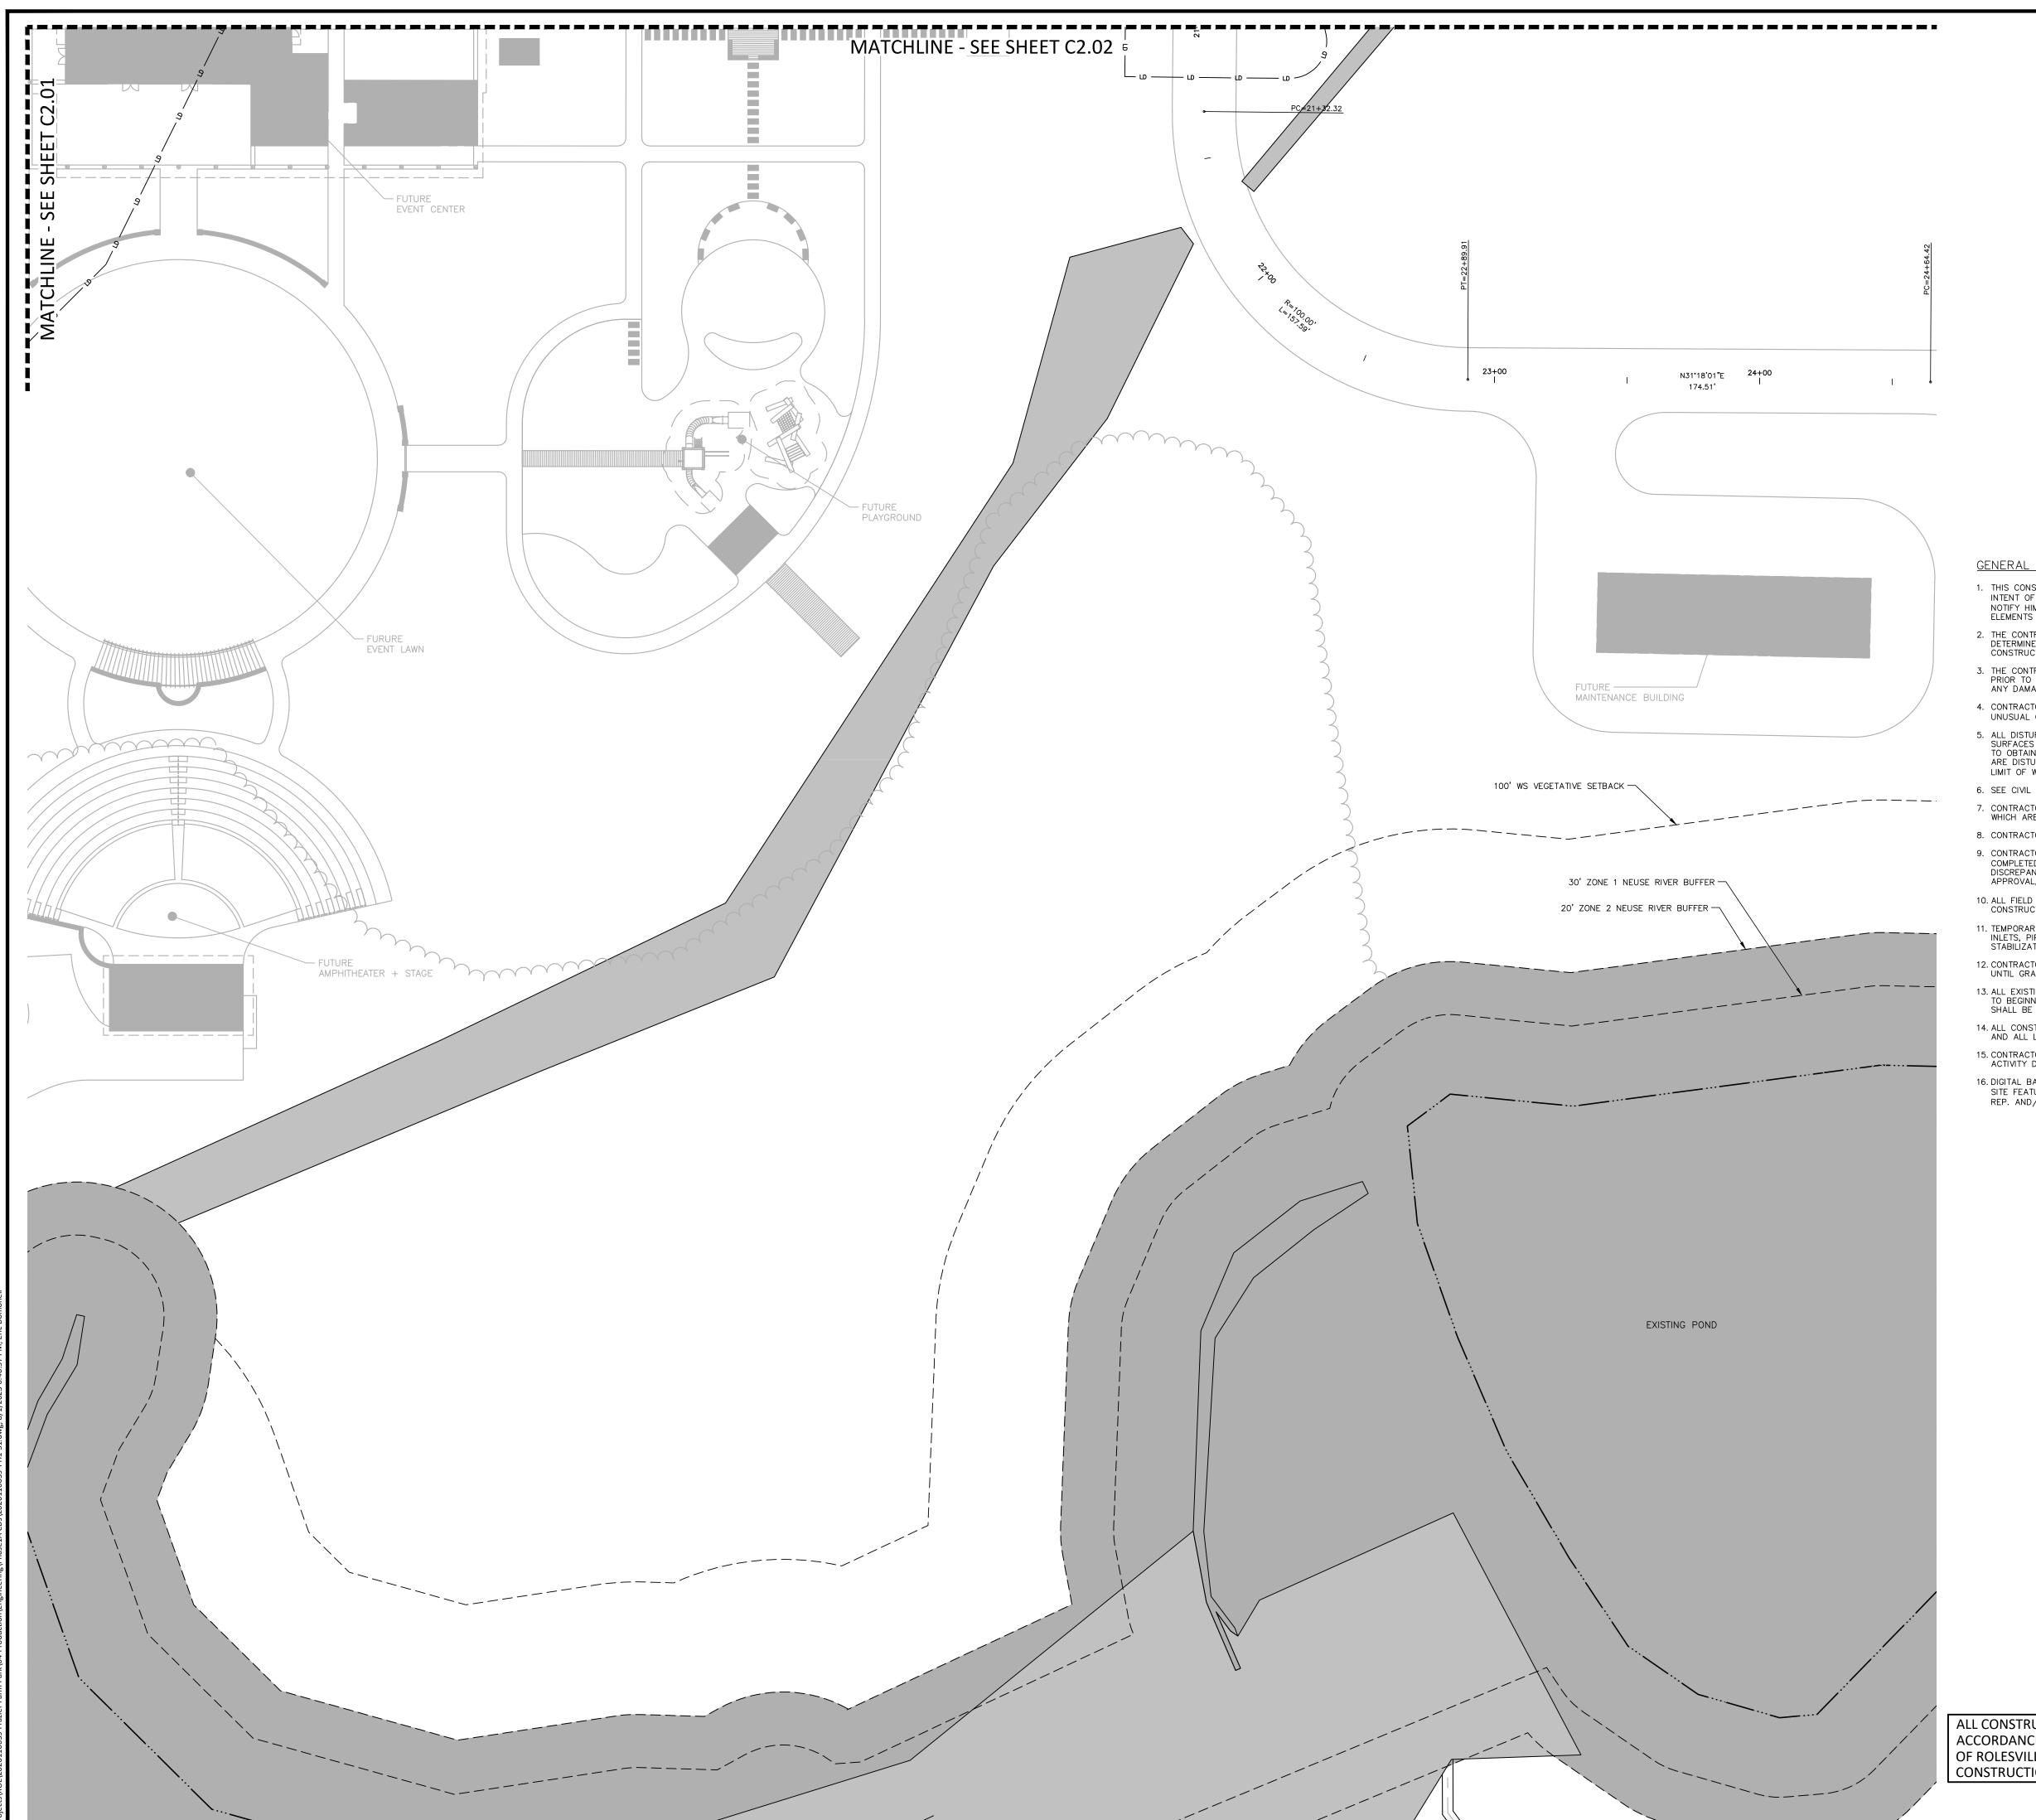
NO. DATE

DRAWN BY 1"=30' SCALE DATE 08.01.2023 SHEET

PLAN INFORMATION

PROJECT NO. 202011039

SITE PLAN: AREA 'B'





> fax 919. 361. 2269 license number: C-0293

phone 919. 361. 5000

www.mcadamsco.com

CLIENT

NAME: TOWN OF ROLESVILLE ADDRESS: 502 SOUTHTOWN CIRCLE ADDRESS: ROLESVILLE NC 27571 PHONE: 919.554.6582

LE 1AN DRAWINGS
E 1A

GENERAL SITE PLAN NOTES:

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SITE LEGEND

TYPE A TYPE B TYPE C

● ● ● ● ● ● ● ● ■ ACCESSIBLE ROUTE

PROPERTY LINE

PHASE LINE

SIGNAGE

YARD LIGHTS

LIGHT POLE

POWER POLE

TRAFFIC DIRECTIONAL ARROW

ACCESSIBLE PARKING STALL

PARKING SPACE COUNT

ACCESSIBLE RAMPS

RIGHT-OF-WAY LINE

ABC TRAVEL SURFACE TO BE ASPHALT PAVED IN FUTURE PHASE


EASEMENT LINE

CENTERLINE

HEAVY DUTY ASPHALT PAVEMENT

VAN ACCESSIBLE PARKING STALL

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INDEX MAP N.T.S.

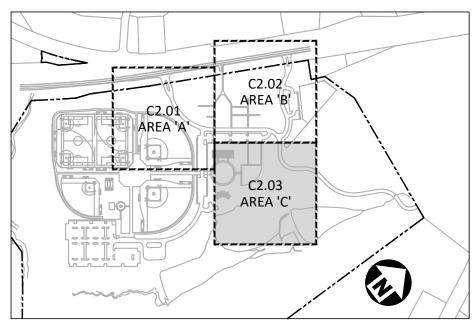ALL CONSTRUCTION SHALL BE IN ACCORDANCE WITH THE CURRENT TOWN OF ROLESVILLE ENGINEERING DESIGN AND CONSTRUCTION STANDARDS

GRAPHIC SCALE

SITE PLAN: AREA 'C'

1"=30'

08.01.2023

2020110039-PH1-S1

PLAN INFORMATION

PROJECT NO. 202011039

REVISIONS

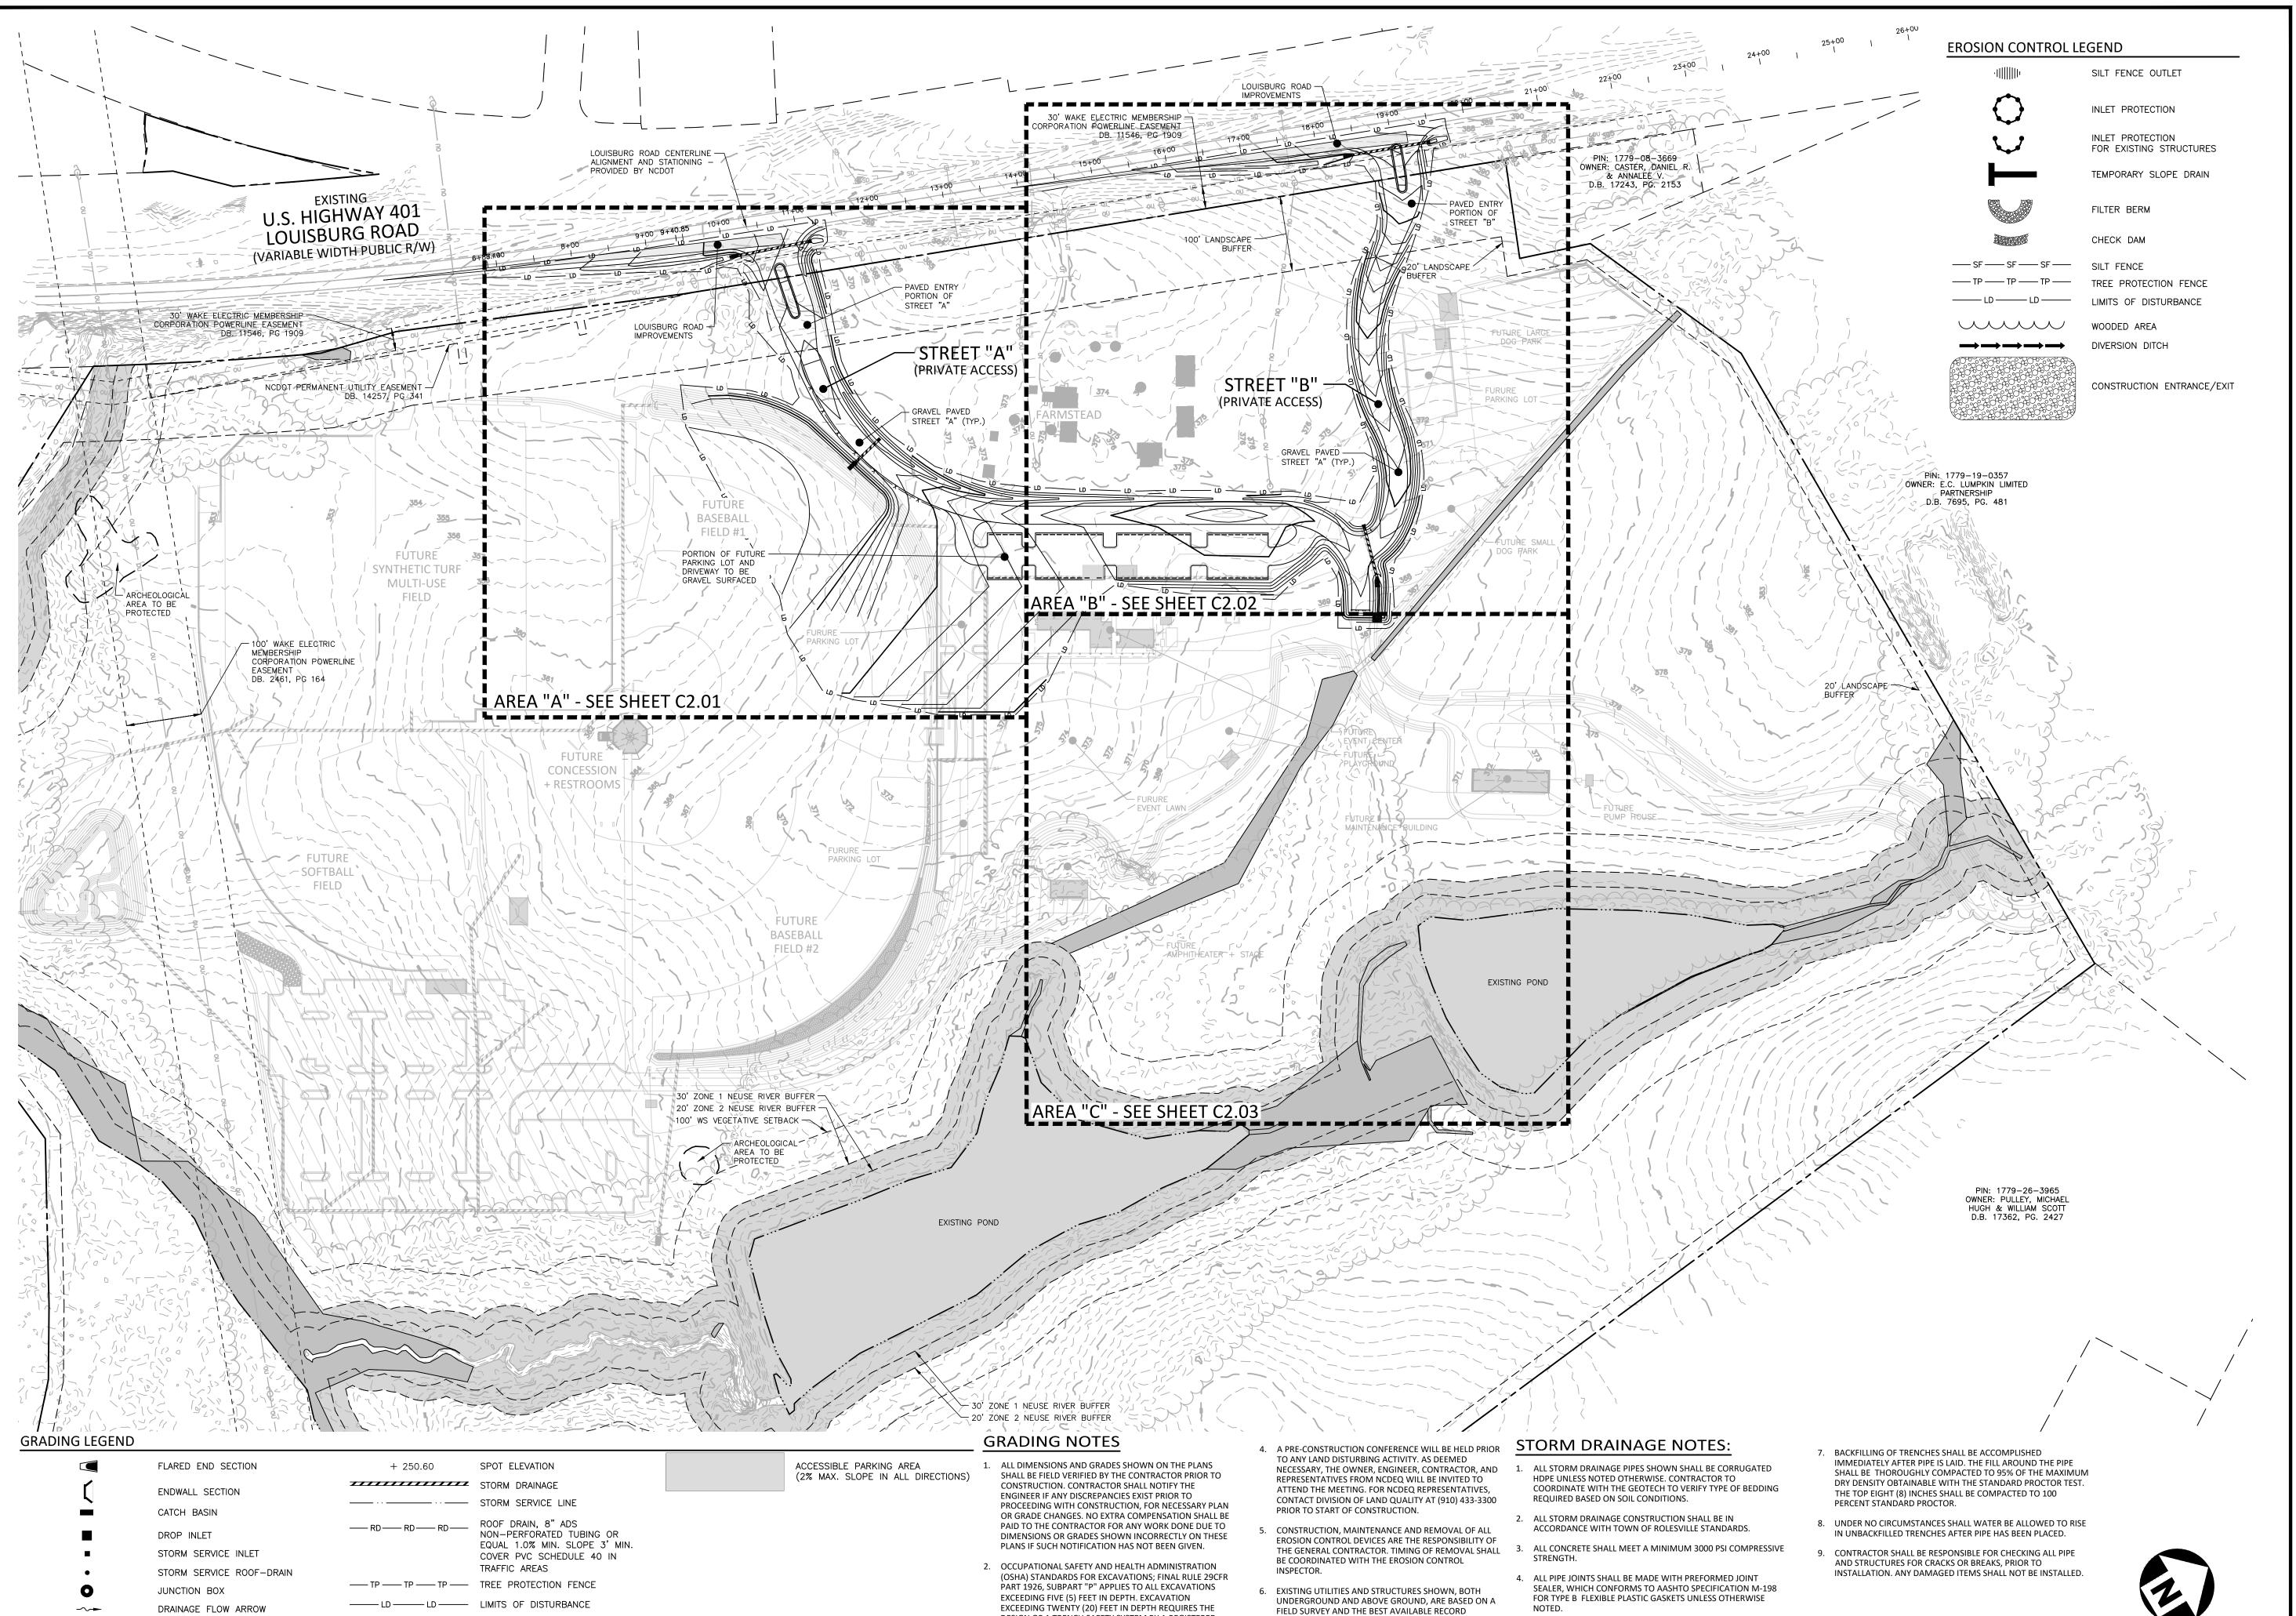
NO. DATE

FILENAME CHECKED BY DRAWN BY

SCALE DATE

SHEET

CID-23-5 PRELIMINARY DRAWING - NOT RELEASED FOR CONSTRUCTION



DESIGN OF A TRENCH SAFETY SYSTEM BY A REGISTERED

PROFESSIONAL ENGINEER, PROVIDED BY CONTRACTOR

(1-800-632-4949) AT LEAST 3 FULL BUSINESS DAYS PRIOR

EXISTING UTILITIES LOCATED. CONTRACTOR SHALL

TO BEGINNING CONSTRUCTION OR EXCAVATION TO HAVE

CONTACT ANY LOCAL UTILITIES THAT PROVIDE THEIR OWN

LOCATOR SERVICES INDEPENDENT OF "NC811". REPORT

ANY DISCREPANCIES TO THE ENGINEER IMMEDIATELY.

RESPONSIBLE FOR EXCAVATION.

3. CONTRACTOR SHALL NOTIFY "NC811" (811) OR

LINE BREAK SYMBOL

— BOTTOM OF WALL ELEVATION

TW=223.00 TOP OF WALL ELEVATION
BW=213.00 BOTTOM OF WALL FI FVATION

TOP & BOTTOM CURB ELEVATIONS

(NOTE: BOTTOM OF WALL IS GROUND

ELEVATION NOT WALL FOUNDATION)

WOODED AREA

— — — EASEMENT LINE

____ MAJOR CONTOUR

__252____ EXISTING MINOR CONTOUR

_____250____ EXISTING MAJOR CONTOUR

___ MINOR CONTOUR

DRAWINGS. THE CONTRACTOR SHALL VERIFY FIELD

7. SOIL UNDER BUILDINGS, PAVED AREAS AND WITHIN

AND COMPACTED AS RECOMMENDED BY THE

CONSTRUCTION. ANY DISCREPANCIES SHALL BE REPORTED

SLOPES LESS THAN 4:1 (H:V) SHALL BE APPROVED, PLACED

CONDITIONS PRIOR TO BEGINNING RELATED

TO THE ENGINEER IMMEDIATELY.

GEOTECHNICAL ENGINEER.




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CLIENT

NAME: TOWN OF ROLESVILLE ADDRESS: 502 SOUTHTOWN CIRCLE ADDRESS: ROLESVILLE NC 27571 PHONE: 919.554.6582



REVISIONS

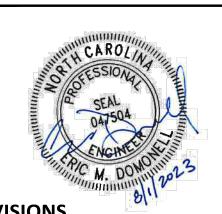NO. DATE

PLAN INFORMATION

PROJECT NO. 202011039 2020110039-PH1-OAG1 FILENAME CHECKED BY

DRAWN BY 1"=100'

SCALE DATE 08.01.2023

SHEET

OVERALL GRADING & DRAINAGE PLAN

GRAPHIC SCALE

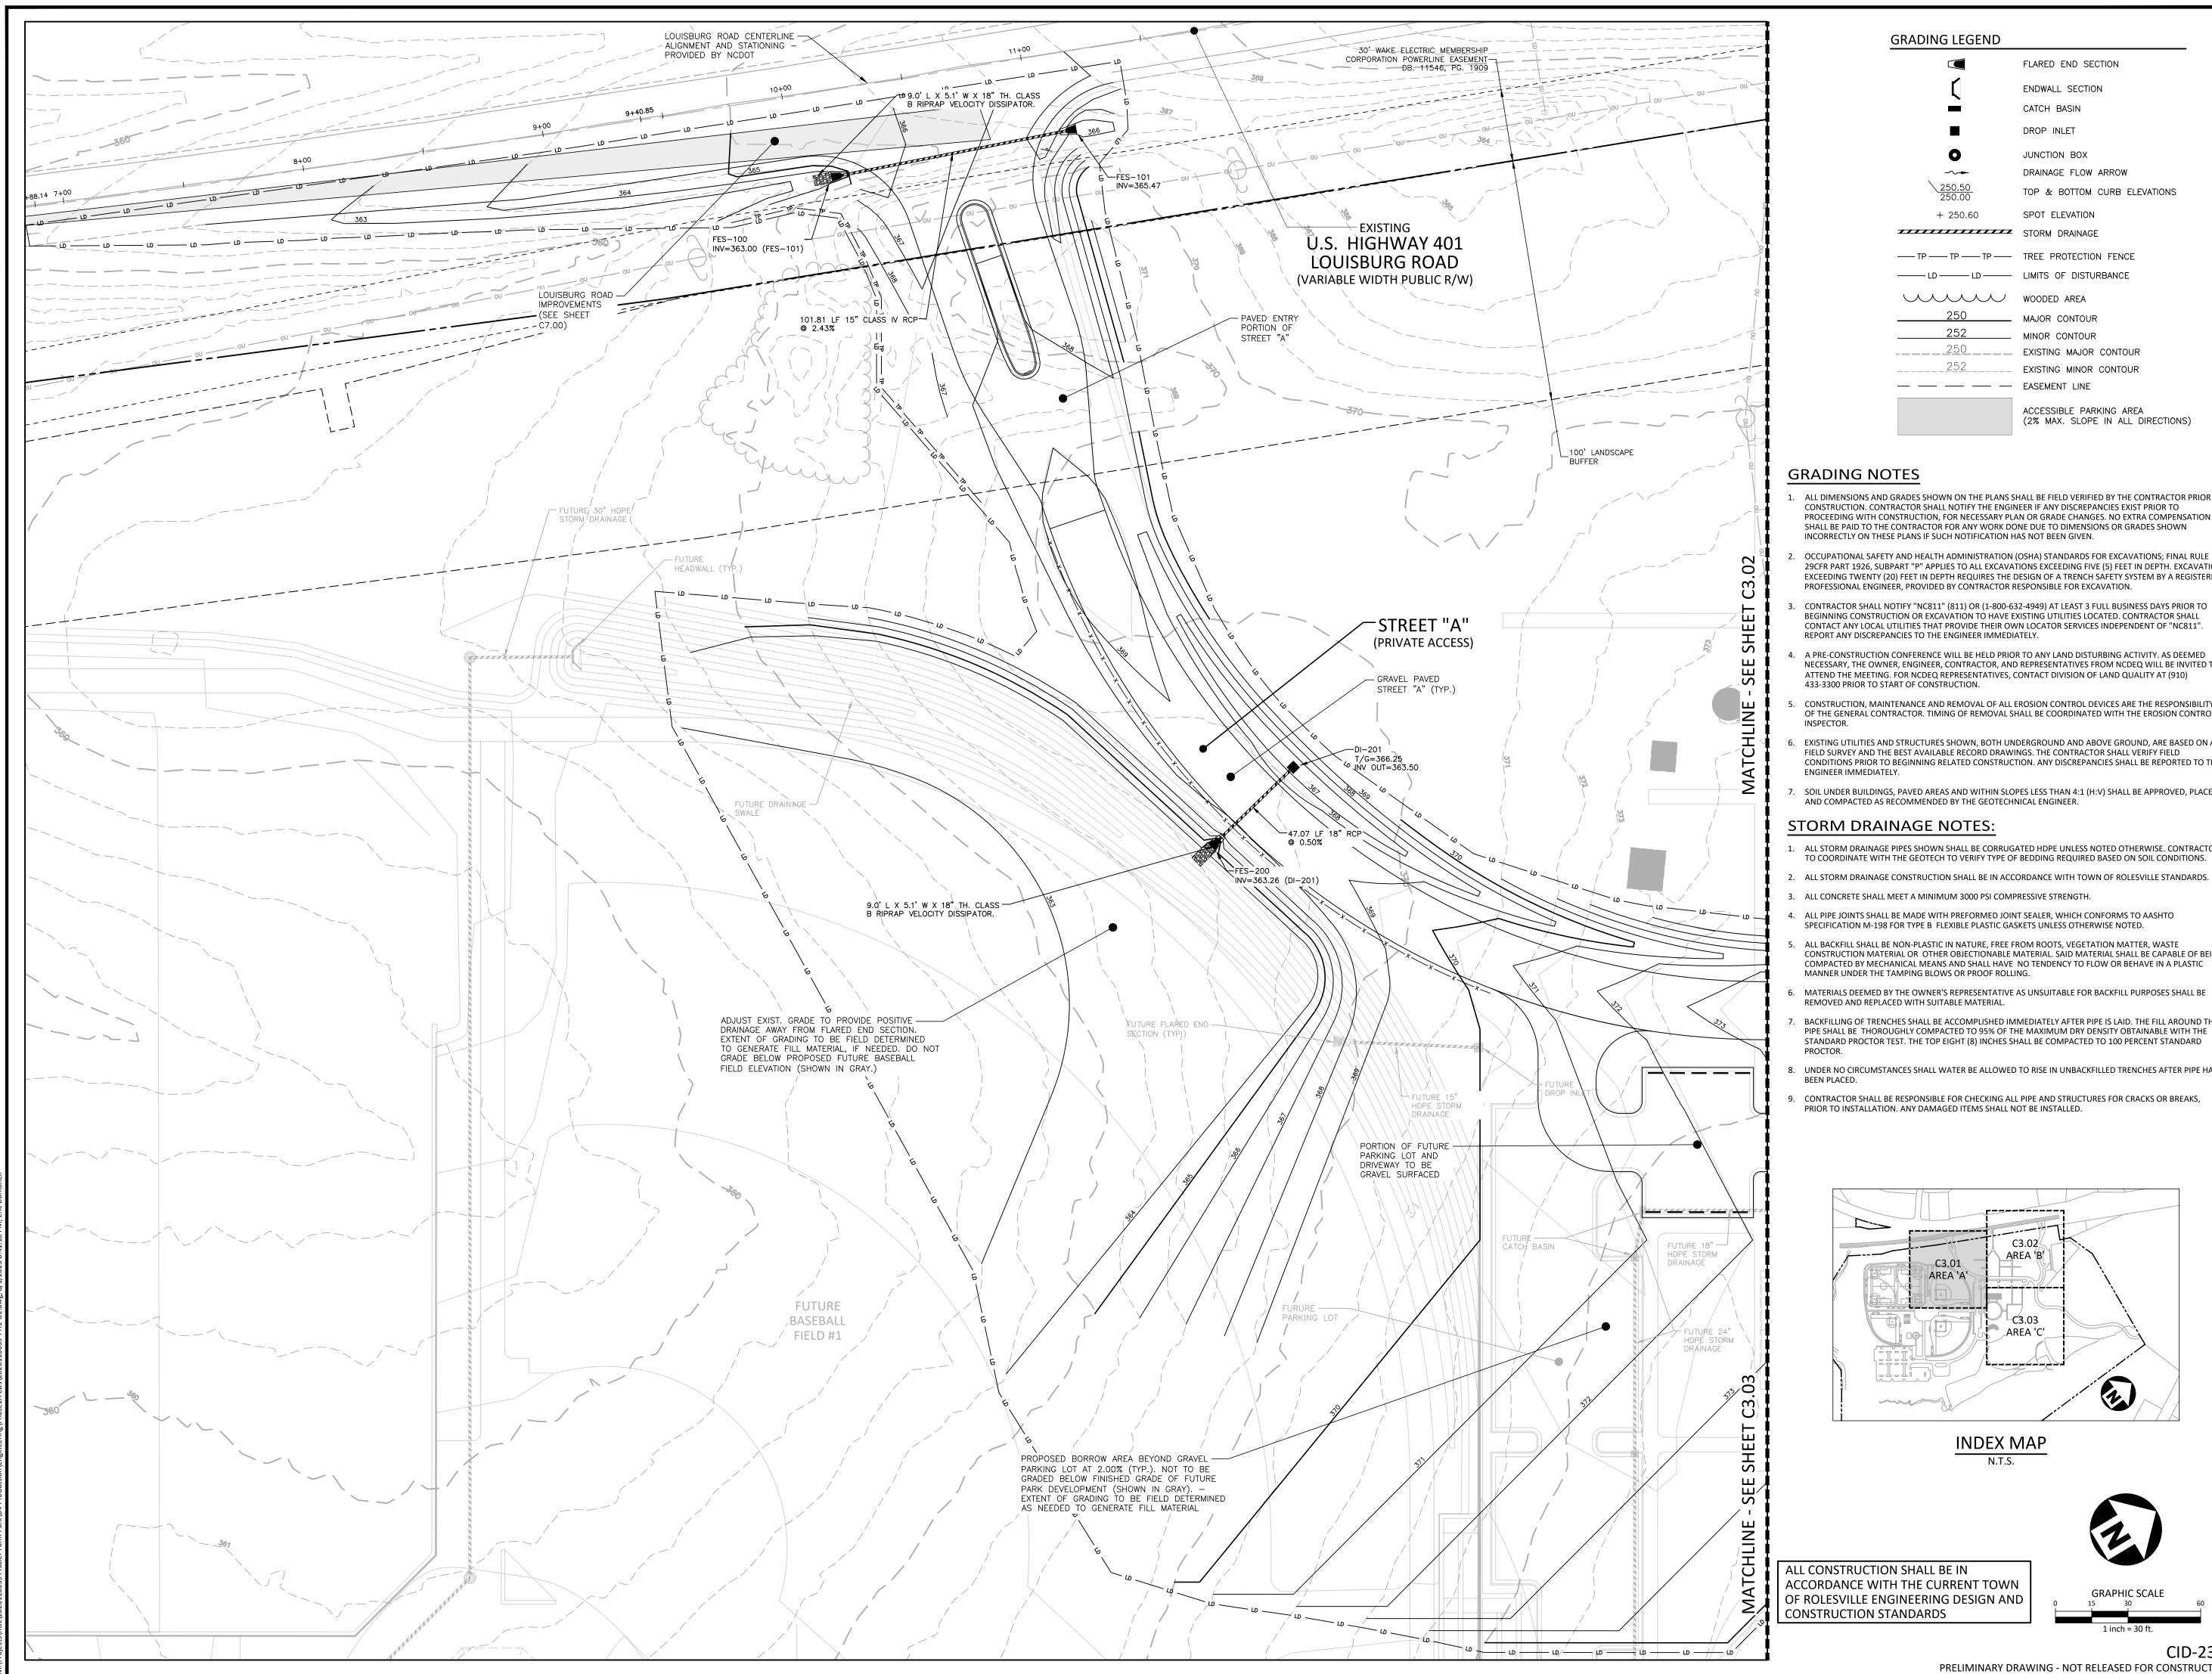
- ALL BACKFILL SHALL BE NON-PLASTIC IN NATURE, FREE FROM ROOTS, VEGETATION MATTER, WASTE CONSTRUCTION MATERIAL OR OTHER OBJECTIONABLE MATERIAL. SAID MATERIAL SHALL BE
- ALL CONSTRUCTION SHALL BE IN
- CAPABLE OF BEING COMPACTED BY MECHANICAL MEANS AND SHALL HAVE NO TENDENCY TO FLOW OR BEHAVE IN A PLASTIC MANNER UNDER THE TAMPING BLOWS OR PROOF ROLLING.
- MATERIALS DEEMED BY THE OWNER'S REPRESENTATIVE AS UNSUITABLE FOR BACKFILL PURPOSES SHALL BE REMOVED AND REPLACED WITH SUITABLE MATERIAL.

CID-23-5 PRELIMINARY DRAWING - NOT RELEASED FOR CONSTRUCTION

ACCORDANCE WITH THE CURRENT TOWN

OF ROLESVILLE ENGINEERING DESIGN AND

CONSTRUCTION STANDARDS



GRADING LEGEND

FLARED END SECTION ENDWALL SECTION

CATCH BASIN DROP INLET

JUNCTION BOX DRAINAGE FLOW ARROW

TOP & BOTTOM CURB ELEVATIONS + 250.60 SPOT ELEVATION

STORM DRAINAGE — TP — TP — TREE PROTECTION FENCE -----LD ------ LIMITS OF DISTURBANCE

____ MINOR CONTOUR EXISTING MAJOR CONTOUR 252 EXISTING MINOR CONTOUR

WOODED AREA

— — — EASEMENT LINE

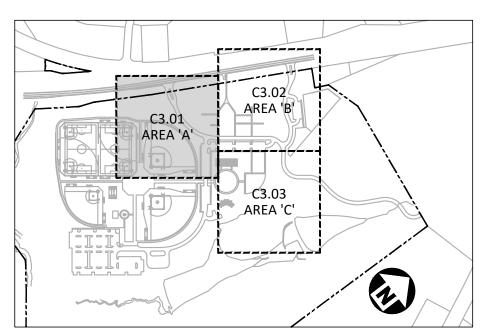
ACCESSIBLE PARKING AREA (2% MAX. SLOPE IN ALL DIRECTIONS)

GRADING NOTES

- ALL DIMENSIONS AND GRADES SHOWN ON THE PLANS SHALL BE FIELD VERIFIED BY THE CONTRACTOR PRIOR TO CONSTRUCTION. CONTRACTOR SHALL NOTIFY THE ENGINEER IF ANY DISCREPANCIES EXIST PRIOR TO PROCEEDING WITH CONSTRUCTION, FOR NECESSARY PLAN OR GRADE CHANGES. NO EXTRA COMPENSATION SHALL BE PAID TO THE CONTRACTOR FOR ANY WORK DONE DUE TO DIMENSIONS OR GRADES SHOWN INCORRECTLY ON THESE PLANS IF SUCH NOTIFICATION HAS NOT BEEN GIVEN.
- OCCUPATIONAL SAFETY AND HEALTH ADMINISTRATION (OSHA) STANDARDS FOR EXCAVATIONS; FINAL RULE 29CFR PART 1926, SUBPART "P" APPLIES TO ALL EXCAVATIONS EXCEEDING FIVE (5) FEET IN DEPTH. EXCAVATION EXCEEDING TWENTY (20) FEET IN DEPTH REQUIRES THE DESIGN OF A TRENCH SAFETY SYSTEM BY A REGISTERED PROFESSIONAL ENGINEER, PROVIDED BY CONTRACTOR RESPONSIBLE FOR EXCAVATION.
- CONTRACTOR SHALL NOTIFY "NC811" (811) OR (1-800-632-4949) AT LEAST 3 FULL BUSINESS DAYS PRIOR TO BEGINNING CONSTRUCTION OR EXCAVATION TO HAVE EXISTING UTILITIES LOCATED. CONTRACTOR SHALL CONTACT ANY LOCAL UTILITIES THAT PROVIDE THEIR OWN LOCATOR SERVICES INDEPENDENT OF "NC811".
- NECESSARY, THE OWNER, ENGINEER, CONTRACTOR, AND REPRESENTATIVES FROM NCDEQ WILL BE INVITED TO ATTEND THE MEETING. FOR NCDEQ REPRESENTATIVES, CONTACT DIVISION OF LAND QUALITY AT (910) 433-3300 PRIOR TO START OF CONSTRUCTION.
- CONSTRUCTION, MAINTENANCE AND REMOVAL OF ALL EROSION CONTROL DEVICES ARE THE RESPONSIBILITY OF THE GENERAL CONTRACTOR. TIMING OF REMOVAL SHALL BE COORDINATED WITH THE EROSION CONTROL
- EXISTING UTILITIES AND STRUCTURES SHOWN, BOTH UNDERGROUND AND ABOVE GROUND, ARE BASED ON A FIELD SURVEY AND THE BEST AVAILABLE RECORD DRAWINGS. THE CONTRACTOR SHALL VERIFY FIELD CONDITIONS PRIOR TO BEGINNING RELATED CONSTRUCTION. ANY DISCREPANCIES SHALL BE REPORTED TO THE
- SOIL UNDER BUILDINGS, PAVED AREAS AND WITHIN SLOPES LESS THAN 4:1 (H:V) SHALL BE APPROVED, PLACED AND COMPACTED AS RECOMMENDED BY THE GEOTECHNICAL ENGINEER.


STORM DRAINAGE NOTES:

- 1. ALL STORM DRAINAGE PIPES SHOWN SHALL BE CORRUGATED HDPE UNLESS NOTED OTHERWISE, CONTRACTOR TO COORDINATE WITH THE GEOTECH TO VERIFY TYPE OF BEDDING REQUIRED BASED ON SOIL CONDITIONS.
- ALL STORM DRAINAGE CONSTRUCTION SHALL BE IN ACCORDANCE WITH TOWN OF ROLESVILLE STANDARDS.
- 3. ALL CONCRETE SHALL MEET A MINIMUM 3000 PSI COMPRESSIVE STRENGTH.
- ALL PIPE JOINTS SHALL BE MADE WITH PREFORMED JOINT SEALER, WHICH CONFORMS TO AASHTO SPECIFICATION M-198 FOR TYPE B FLEXIBLE PLASTIC GASKETS UNLESS OTHERWISE NOTED.
- CONSTRUCTION MATERIAL OR OTHER OBJECTIONABLE MATERIAL. SAID MATERIAL SHALL BÉ CAPABLE OF BEING COMPACTED BY MECHANICAL MEANS AND SHALL HAVE NO TENDENCY TO FLOW OR BEHAVE IN A PLASTIC MANNER UNDER THE TAMPING BLOWS OR PROOF ROLLING.
- MATERIALS DEEMED BY THE OWNER'S REPRESENTATIVE AS UNSUITABLE FOR BACKFILL PURPOSES SHALL BE REMOVED AND REPLACED WITH SUITABLE MATERIAL.
- BACKFILLING OF TRENCHES SHALL BE ACCOMPLISHED IMMEDIATELY AFTER PIPE IS LAID. THE FILL AROUND THE PIPE SHALL BE THOROUGHLY COMPACTED TO 95% OF THE MAXIMUM DRY DENSITY OBTAINABLE WITH THE STANDARD PROCTOR TEST. THE TOP EIGHT (8) INCHES SHALL BE COMPACTED TO 100 PERCENT STANDARD
- UNDER NO CIRCUMSTANCES SHALL WATER BE ALLOWED TO RISE IN UNBACKFILLED TRENCHES AFTER PIPE HAS
- CONTRACTOR SHALL BE RESPONSIBLE FOR CHECKING ALL PIPE AND STRUCTURES FOR CRACKS OR BREAKS,



INDEX MAP

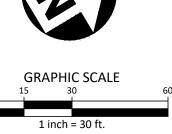ALL CONSTRUCTION SHALL BE IN ACCORDANCE WITH THE CURRENT TOWN OF ROLESVILLE ENGINEERING DESIGN AND CONSTRUCTION STANDARDS



CID-23-PRELIMINARY DRAWING - NOT RELEASED FOR CONSTRUCTION

The John R. McAdams Company, Inc 2905 Meridian Parkway


> phone 919. 361. 5000 fax 919. 361. 2269 license number: C-0293

Durham, NC 27713

www.mcadamsco.com

CLIENT

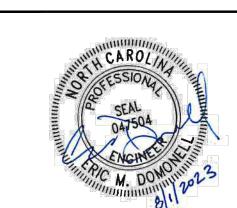NAME: TOWN OF ROLESVILLE ADDRESS: 502 SOUTHTOWN CIRCLE ADDRESS: ROLESVILLE NC 27571 PHONE: 919.554.6582



REVISIONS

NO. DATE

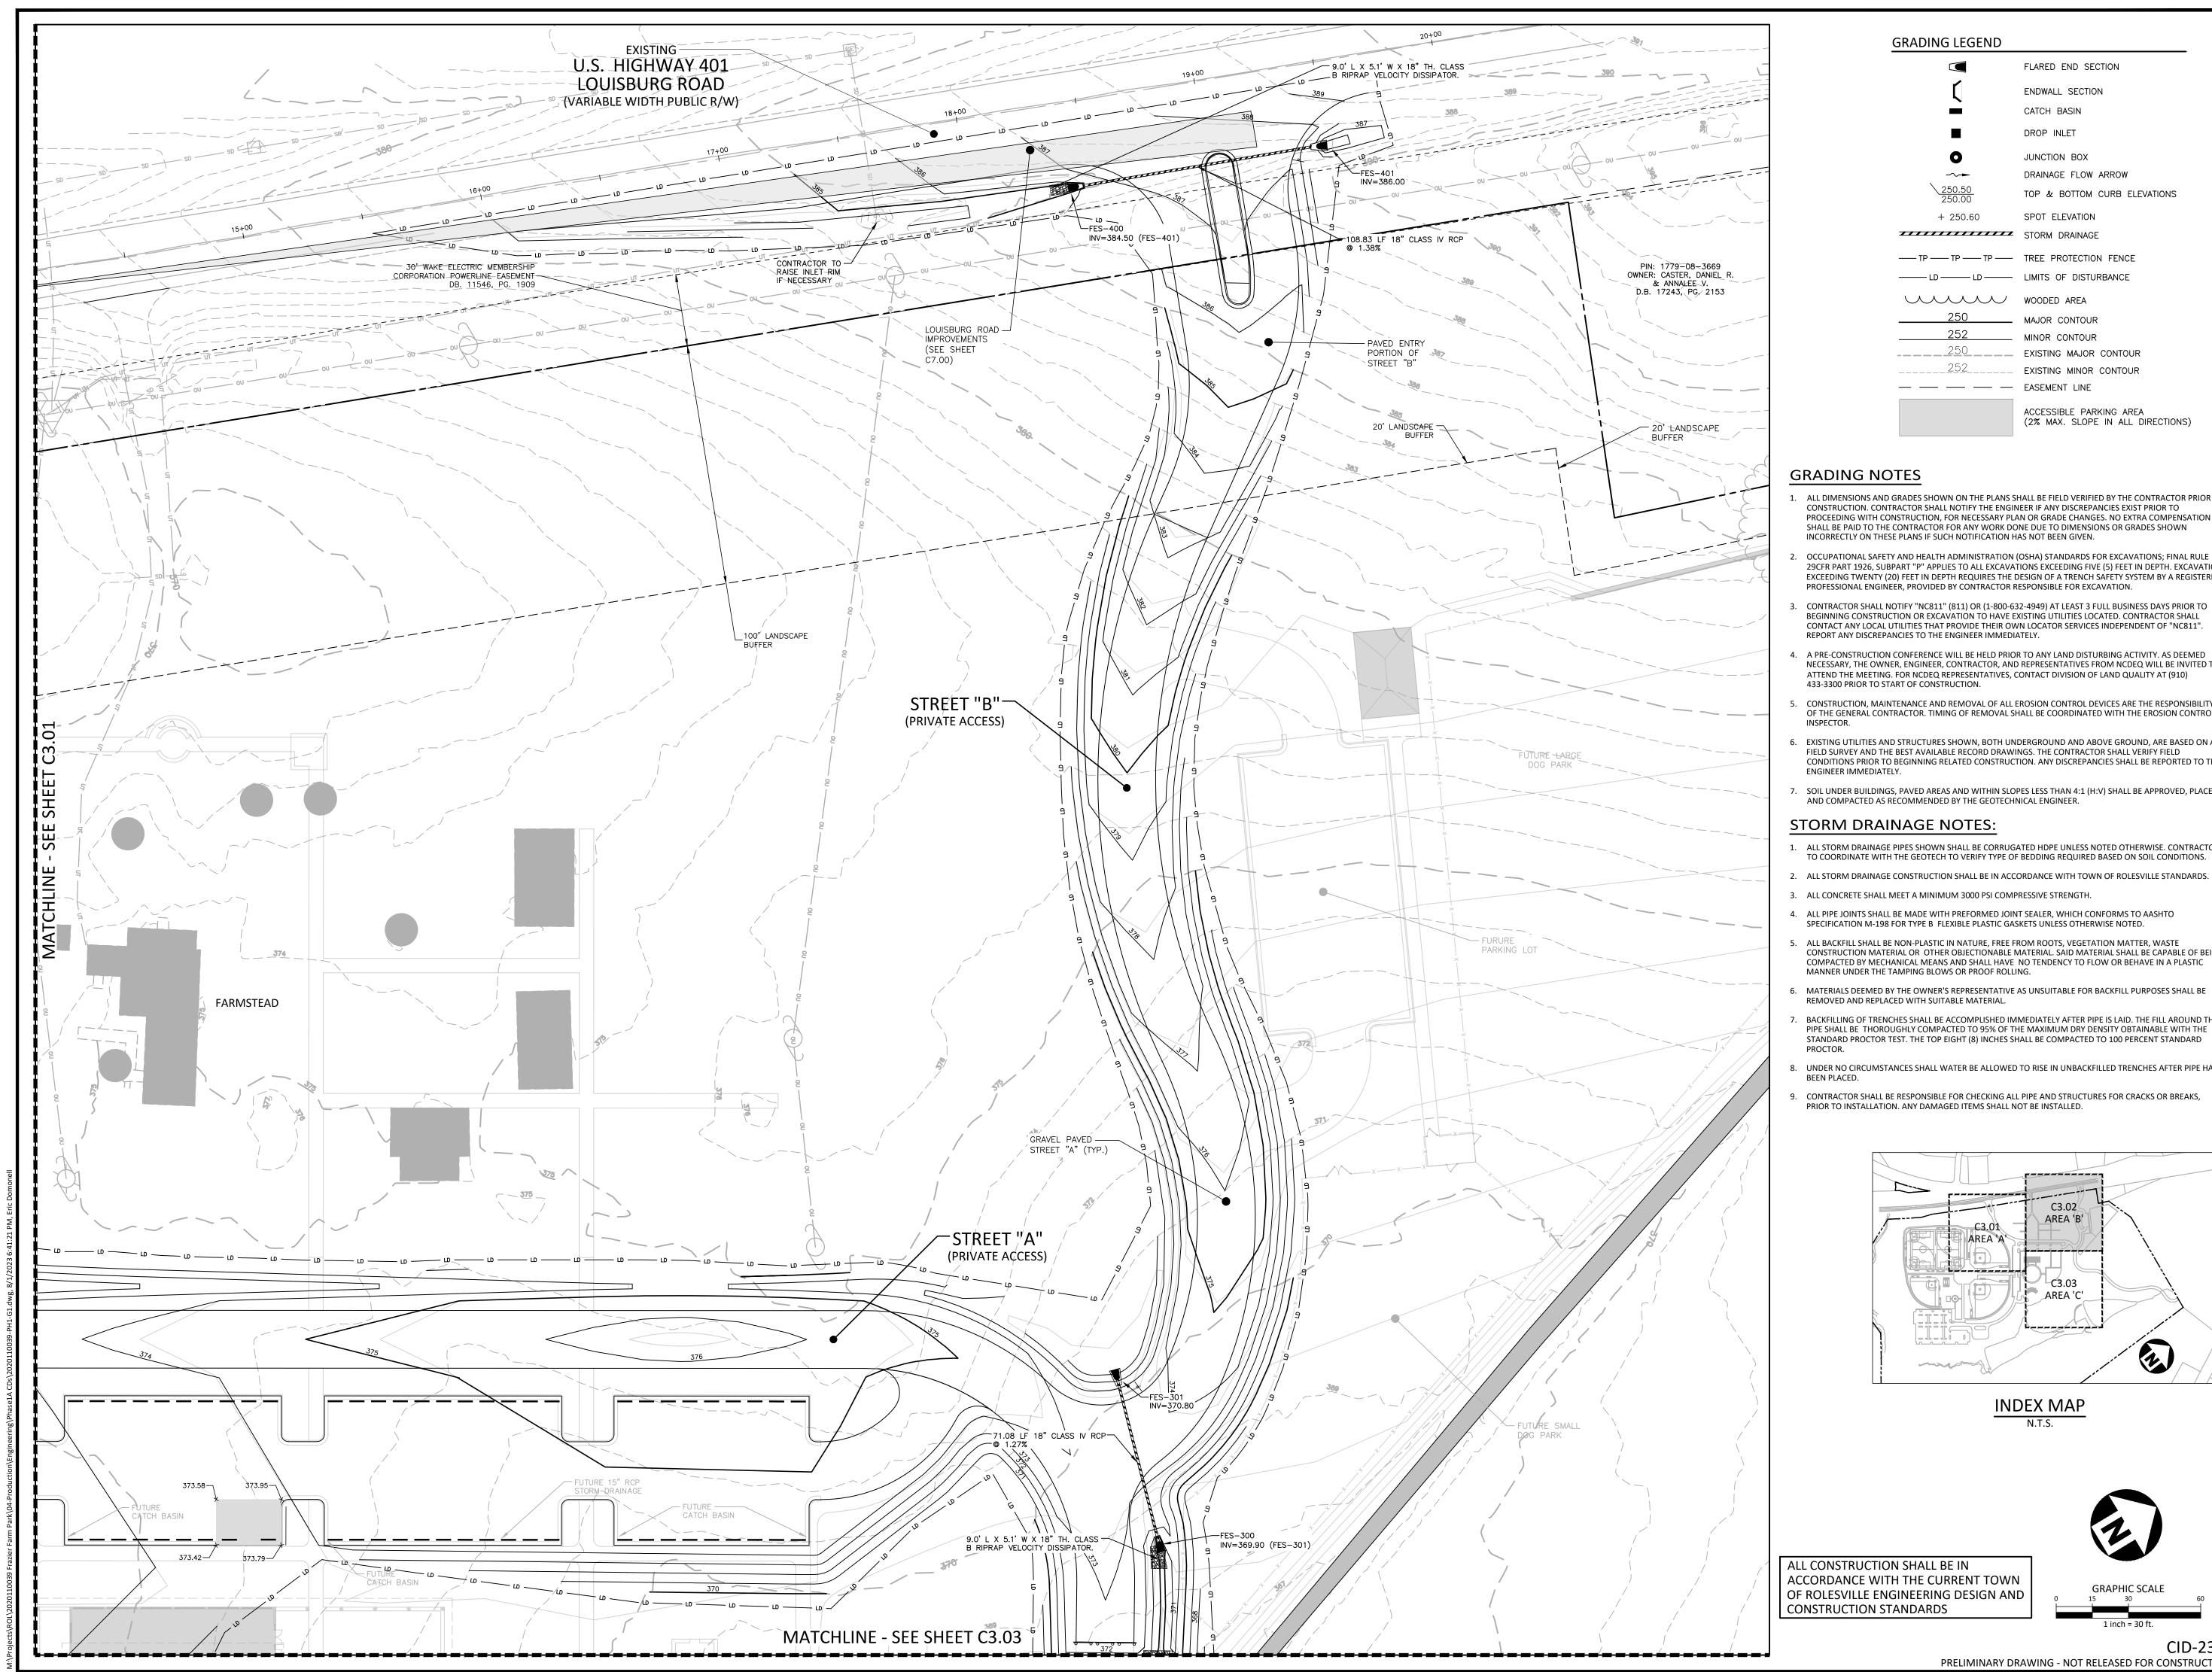
PLAN INFORMATION

PROJECT NO. 202011039 2020110039-PH1-G1 FILENAME

CHECKED BY DRAWN BY 1"=30' SCALE DATE 08.01.2023

SHEET

GRADING & DRAINAGE PLAN: AREA 'A'



GRADING LEGEND

FLARED END SECTION ENDWALL SECTION CATCH BASIN DROP INLET JUNCTION BOX DRAINAGE FLOW ARROW TOP & BOTTOM CURB ELEVATIONS SPOT ELEVATION + 250.60 STORM DRAINAGE — TP — TP — TREE PROTECTION FENCE -----LD ------ LIMITS OF DISTURBANCE WOODED AREA

____ MINOR CONTOUR ___250_____ EXISTING MAJOR CONTOUR EXISTING MINOR CONTOUR — — — EASEMENT LINE

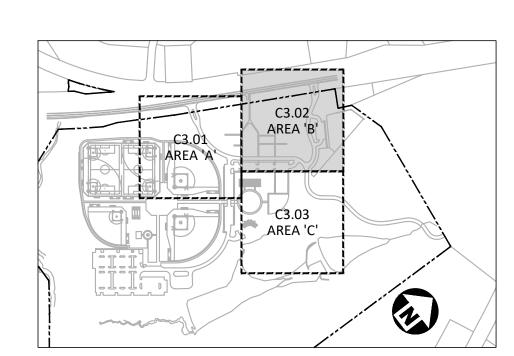
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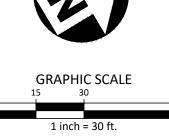
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INDEX MAP

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CID-23-PRELIMINARY DRAWING - NOT RELEASED FOR CONSTRUCTION



The John R. McAdams Company, Inc 2905 Meridian Parkway

Durham, NC 27713


phone 919. 361. 5000 fax 919. 361. 2269 license number: C-0293

www.mcadamsco.com

CLIENT

NAME: TOWN OF ROLESVILLE ADDRESS: 502 SOUTHTOWN CIRCLE

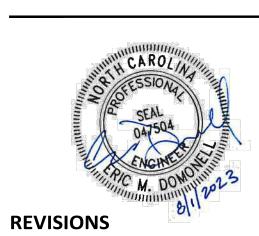ADDRESS: ROLESVILLE NC 27571 PHONE: 919.554.6582



NO. DATE

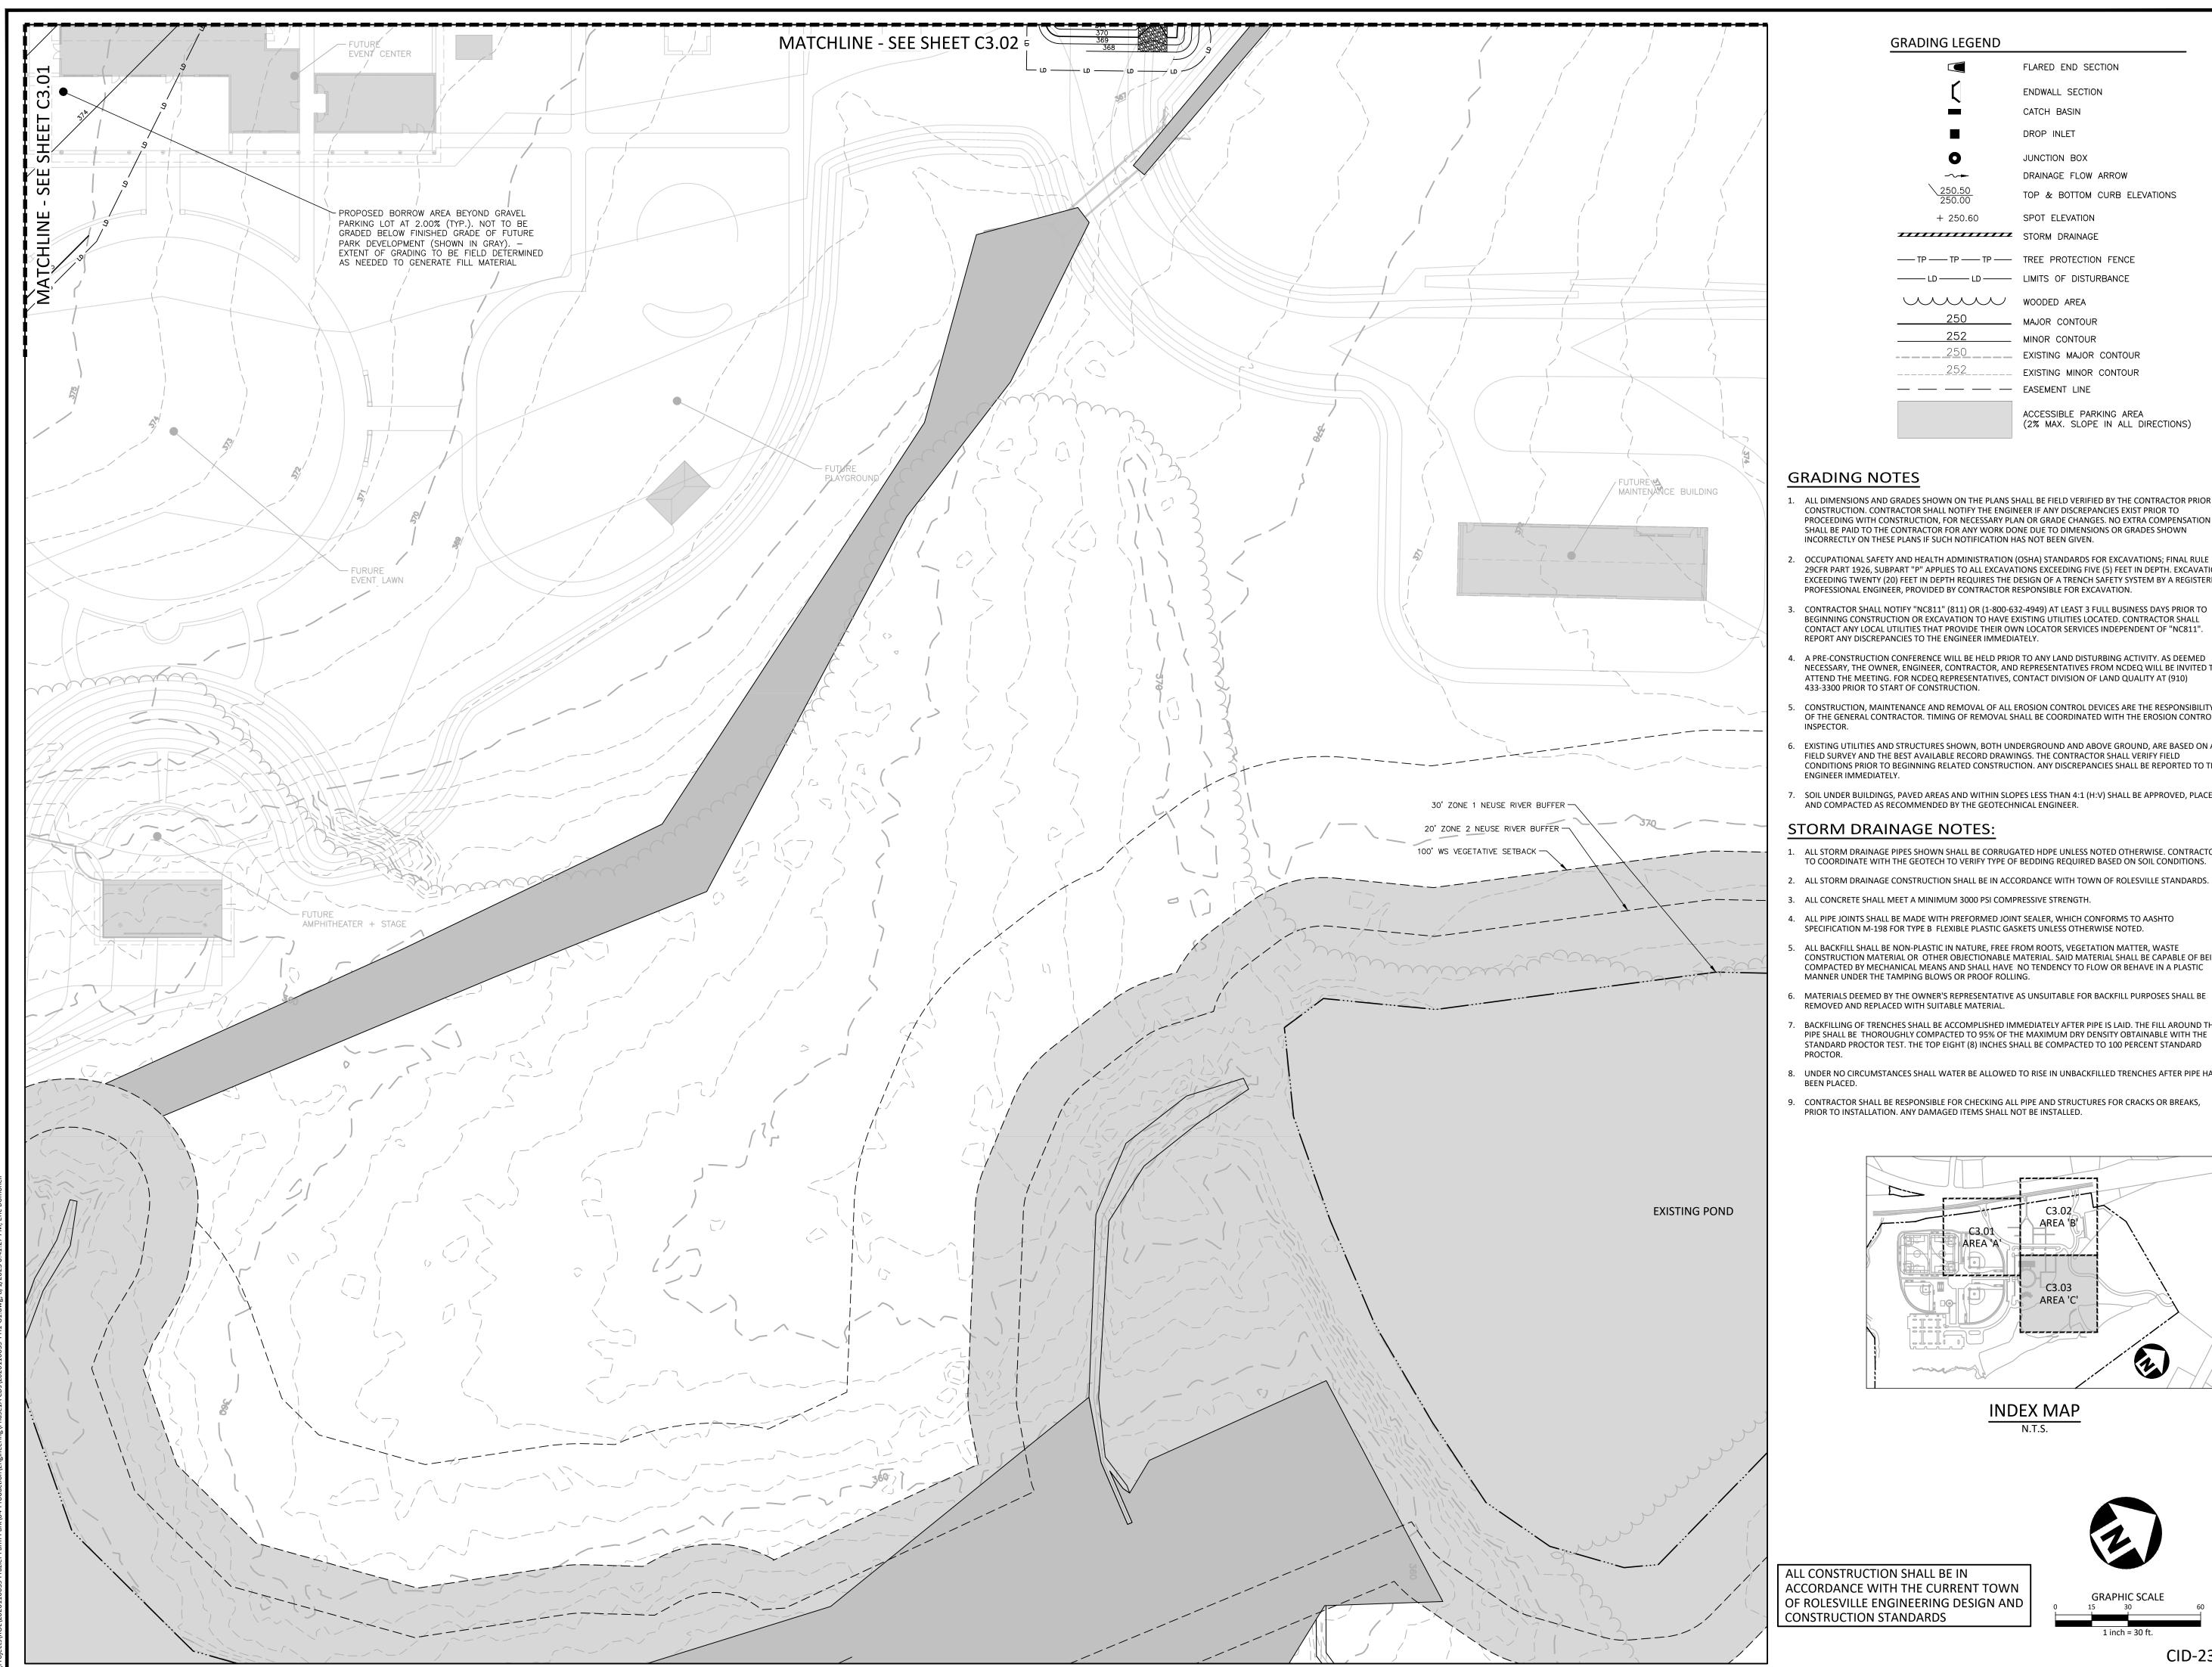
PLAN INFORMATION

PROJECT NO. 202011039 2020110039-PH1-G1 FILENAME

CHECKED BY DRAWN BY 1"=30' SCALE DATE 08.01.2023

SHEET

GRADING & DRAINAGE PLAN: AREA 'B'



GRADING LEGEND

FLARED END SECTION ENDWALL SECTION CATCH BASIN DROP INLET JUNCTION BOX DRAINAGE FLOW ARROW TOP & BOTTOM CURB ELEVATIONS + 250.60 SPOT ELEVATION STORM DRAINAGE — TP — TP — TP — TREE PROTECTION FENCE

-----LD ------ LIMITS OF DISTURBANCE WOODED AREA _____ MAJOR CONTOUR

252 MINOR CONTOUR EXISTING MAJOR CONTOUR -252 EXISTING MINOR CONTOUR — — — EASEMENT LINE

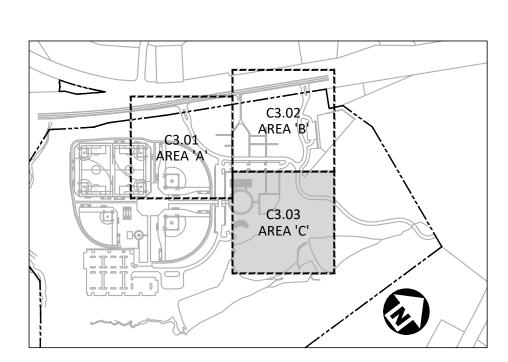
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- A PRE-CONSTRUCTION CONFERENCE WILL BE HELD PRIOR TO ANY LAND DISTURBING ACTIVITY. AS DEEMED NECESSARY, THE OWNER, ENGINEER, CONTRACTOR, AND REPRESENTATIVES FROM NCDEQ WILL BE INVITED TO ATTEND THE MEETING. FOR NCDEQ REPRESENTATIVES, CONTACT DIVISION OF LAND QUALITY AT (910) 433-3300 PRIOR TO START OF CONSTRUCTION.
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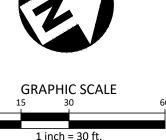
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- 9. CONTRACTOR SHALL BE RESPONSIBLE FOR CHECKING ALL PIPE AND STRUCTURES FOR CRACKS OR BREAKS, PRIOR TO INSTALLATION. ANY DAMAGED ITEMS SHALL NOT BE INSTALLED.



INDEX MAP

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PRELIMINARY DRAWING - NOT RELEASED FOR CONSTRUCTION


The John R. McAdams Company, Inc. 2905 Meridian Parkway Durham, NC 27713

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CLIENT

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NO. DATE


PLAN INFORMATION

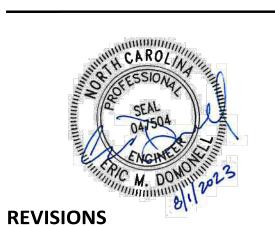PROJECT NO. 202011039 2020110039-PH1-G1 FILENAME

CHECKED BY DRAWN BY 1"=30' SCALE DATE 08.01.2023

SHEET

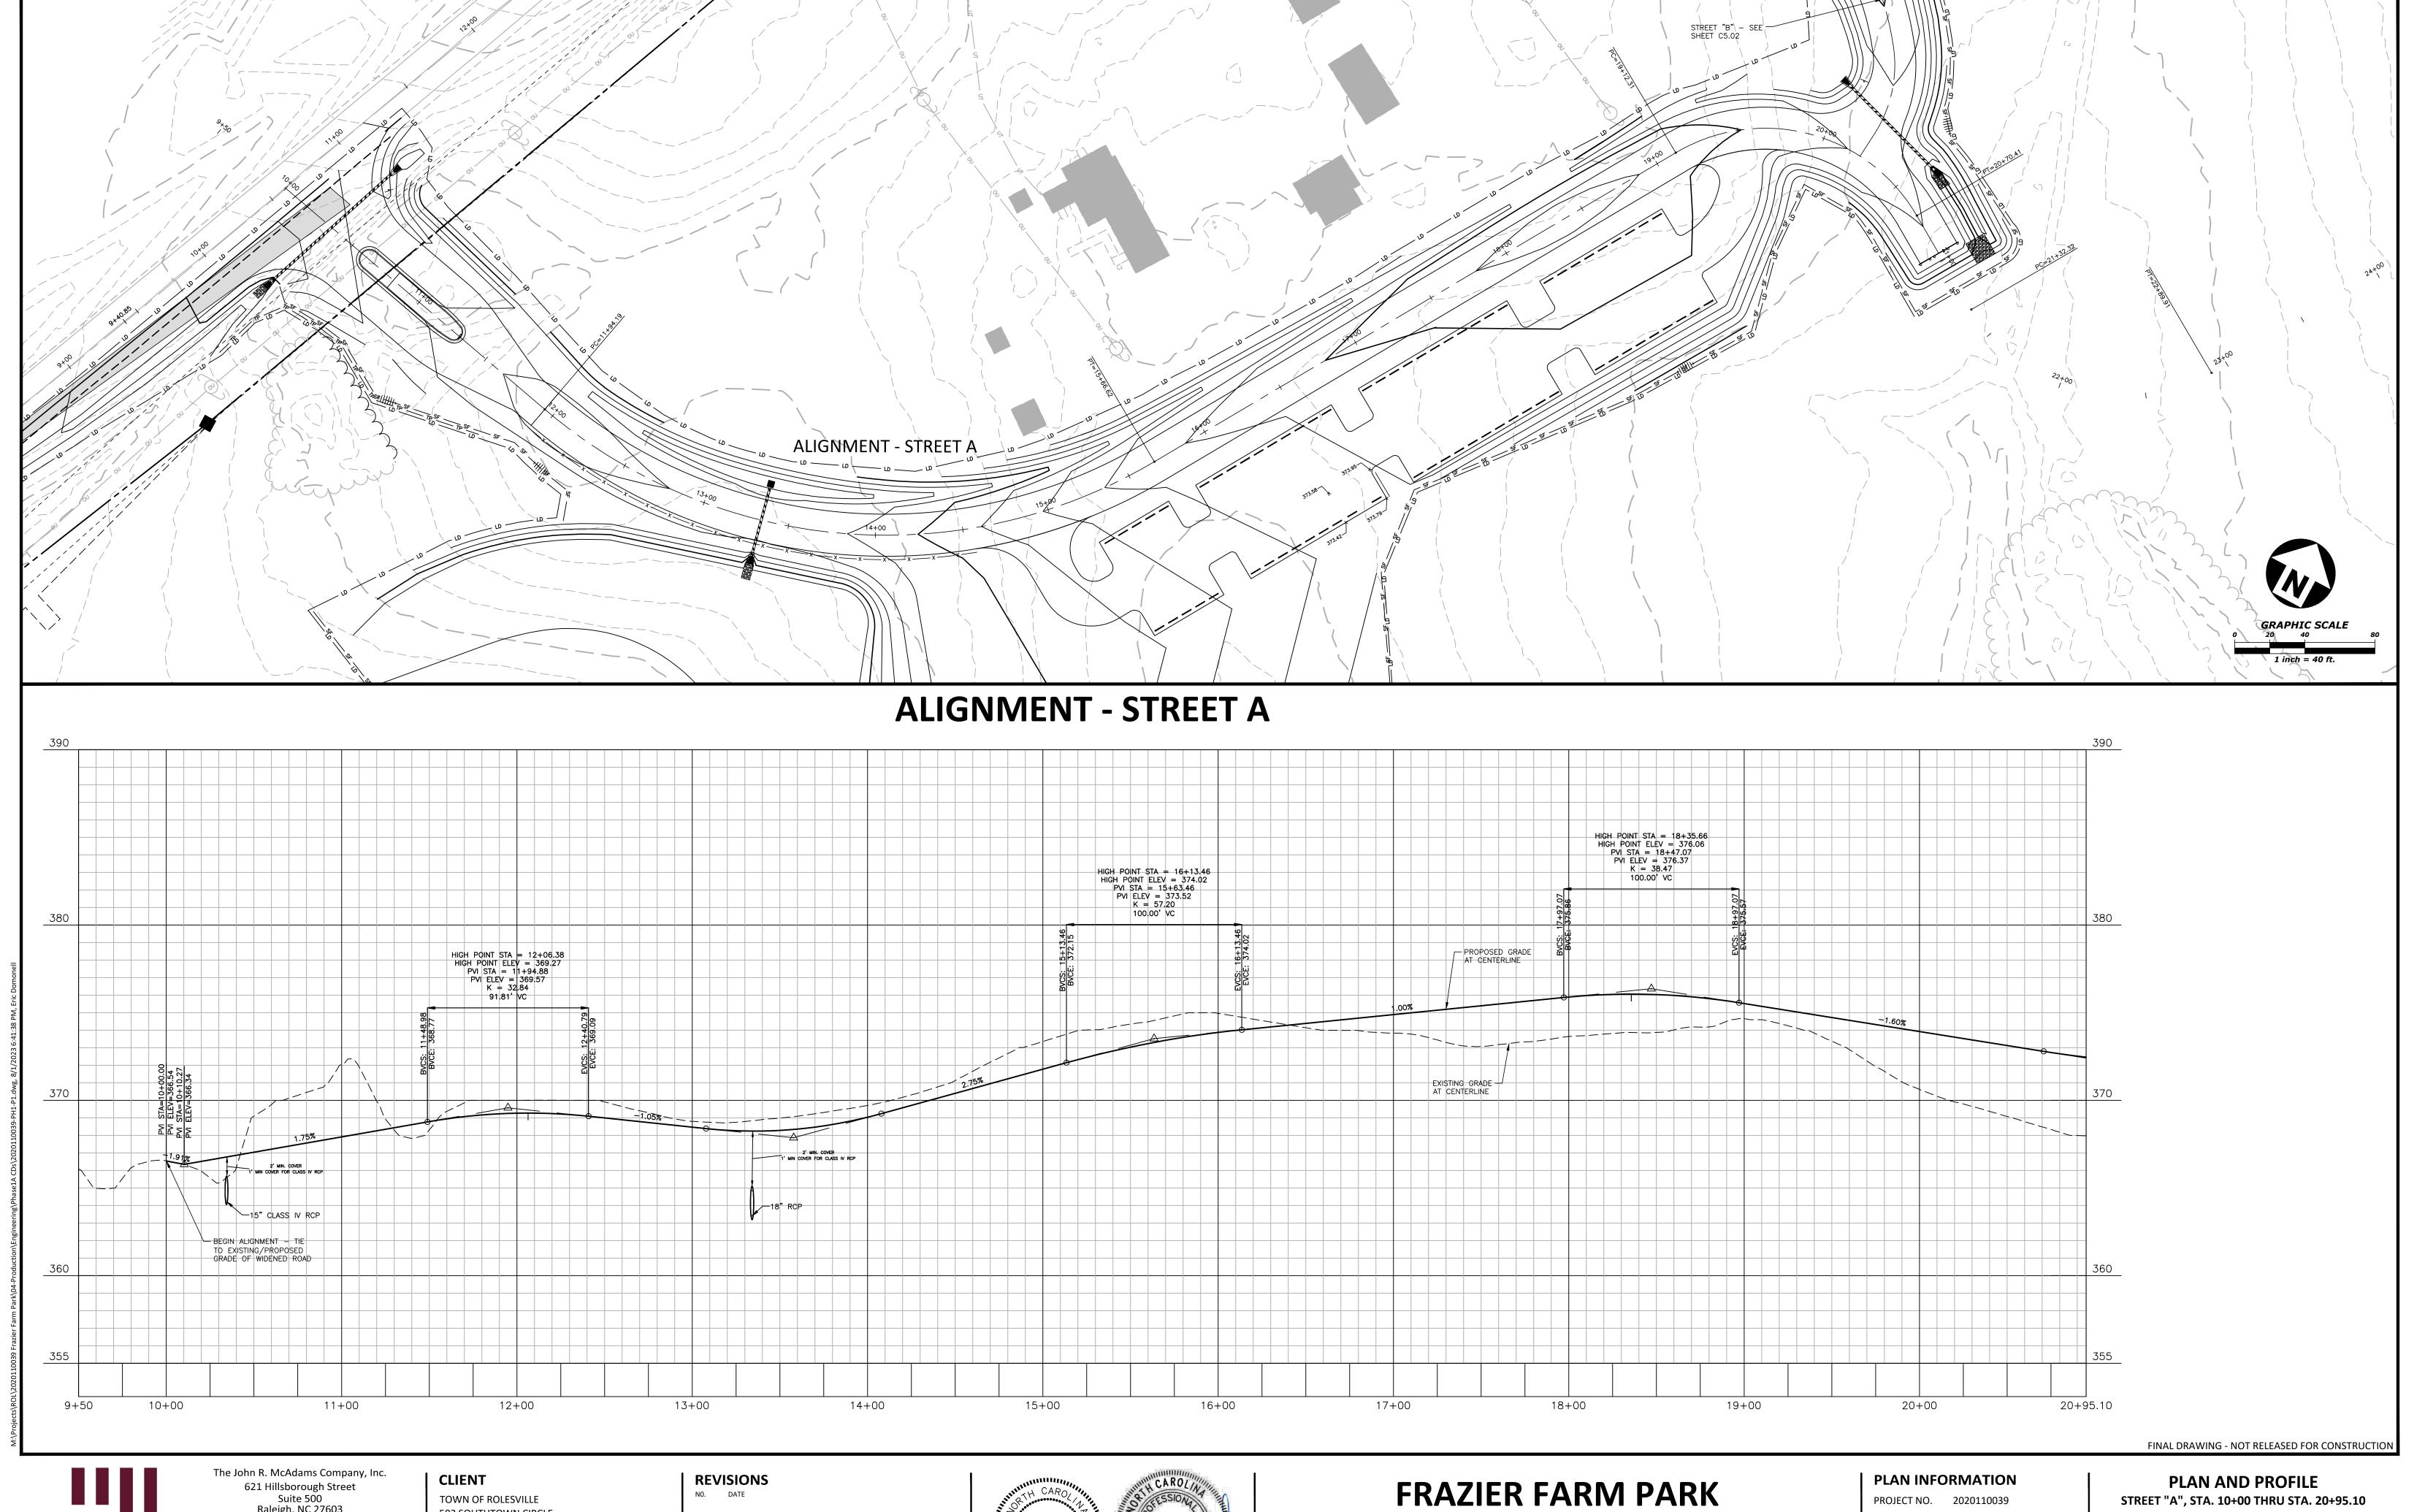GRADING & DRAINAGE PLAN: AREA 'C'




McAdams

Raleigh, NC 27603 phone 919. 361. 5000 fax 919. 361. 2269

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502 SOUTHTOWN CIRCLE ROLESVILLE, NC 27571 PHONE: 919. 554. 6582 license number: C-0293, C-187



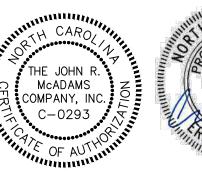


CONSTRUCTION DRAWINGS - PHASE 1A 11624 LOUISBURG ROAD ROLESVILLE, NORTH CAROLINA


2020110039-PH1-P1 FILENAME CHECKED BY DRAWN BY SCALE H:1"=40' / V:1"=4'

07.31.2023

DATE

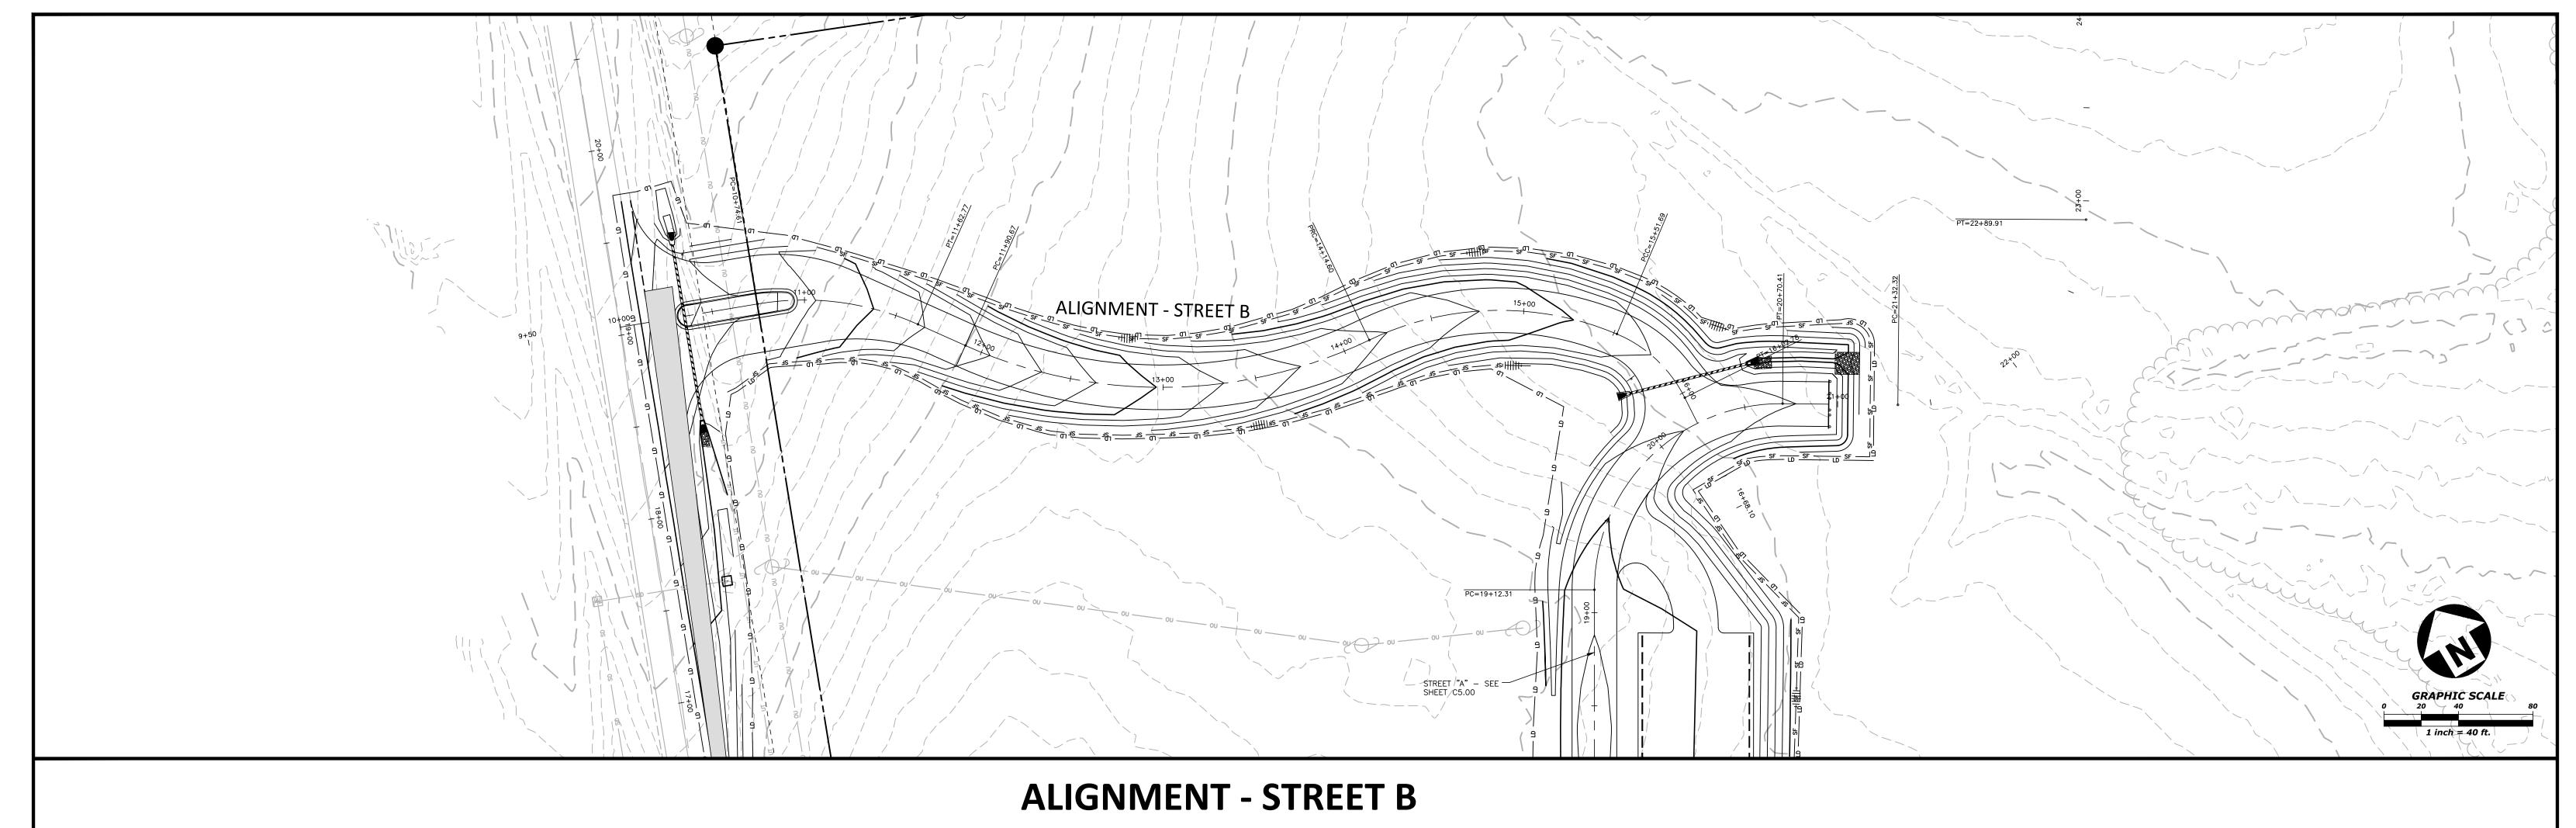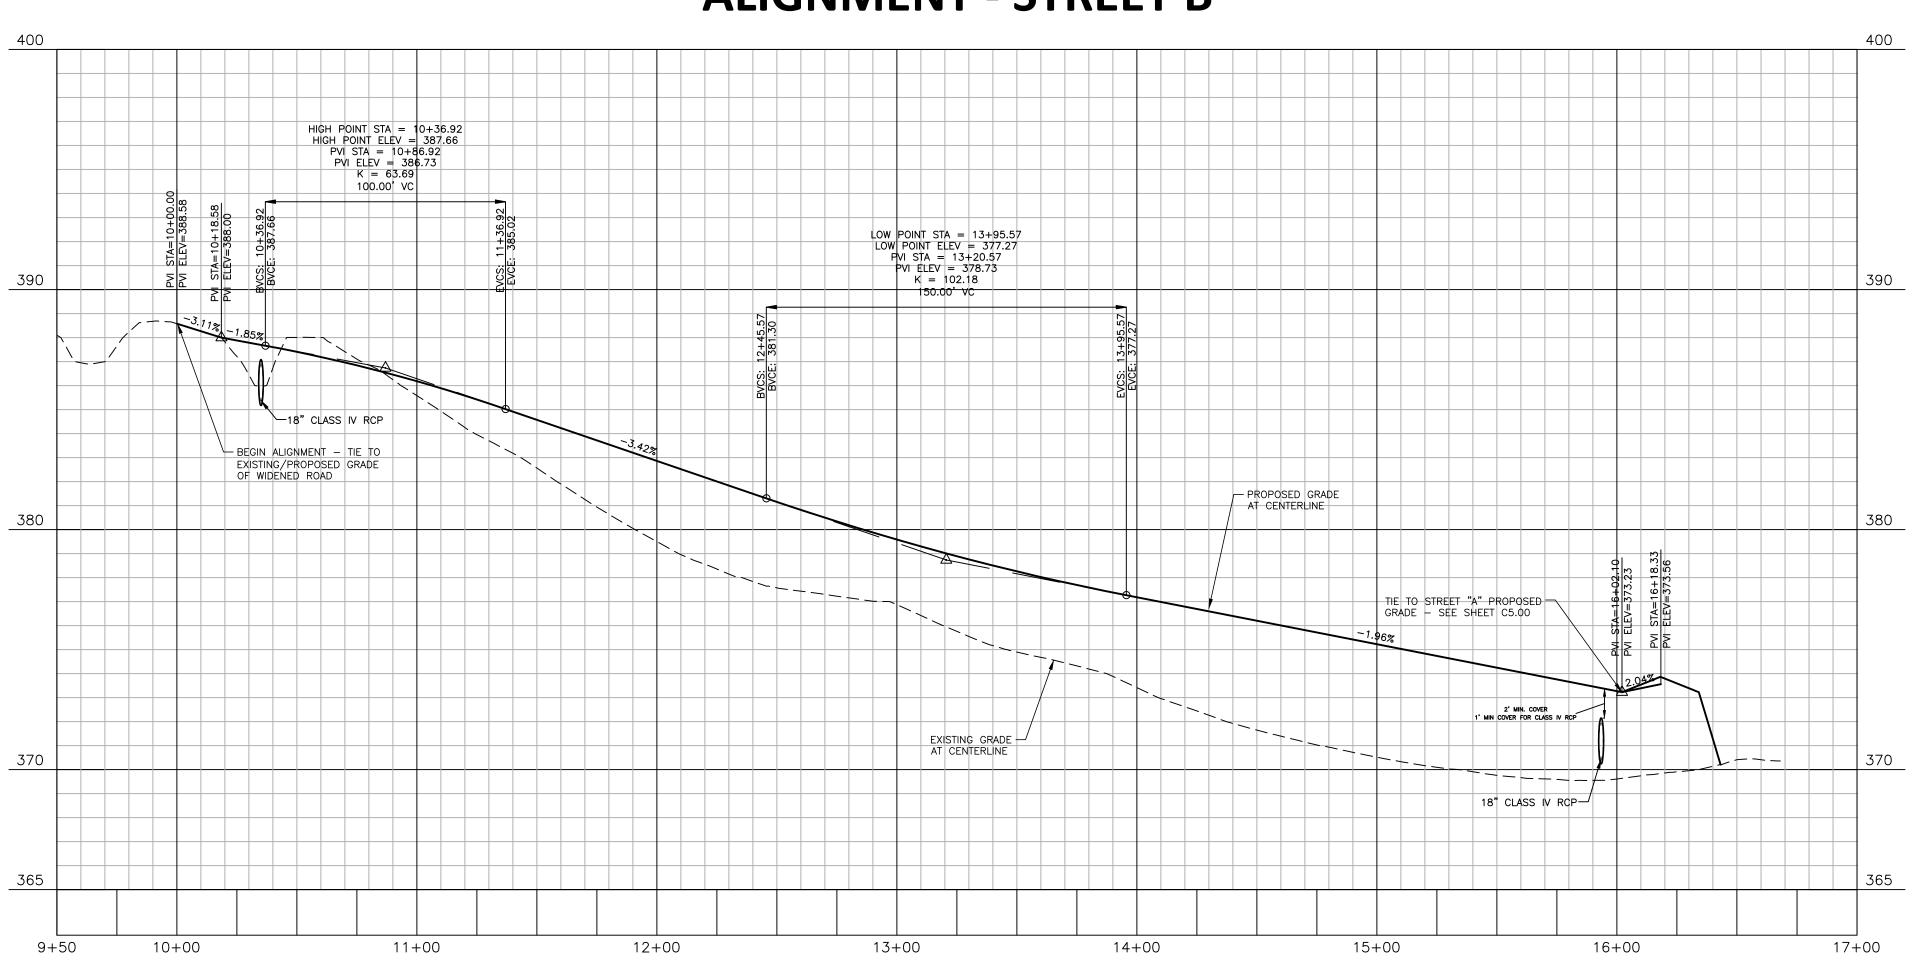C5.00





McAdams

The John R. McAdams Company, Inc. 621 Hillsborough Street Suite 500 Raleigh, NC 27603 phone 919. 361. 5000 fax 919. 361. 2269

license number: C-0293, C-187

www.mcadamsco.com

TOWN OF ROLESVILLE **502 SOUTHTOWN CIRCLE** ROLESVILLE, NC 27571 PHONE: 919. 554. 6582

CLIENT

REVISIONS NO. DATE



FRAZIER FARM PARK

CONSTRUCTION DRAWINGS - PHASE 1A 11624 LOUISBURG ROAD ROLESVILLE, NORTH CAROLINA

PLAN INFORMATION

PROJECT NO. 2020110039 FILENAME CHECKED BY

2020110039-PH1-P1 DRAWN BY SCALE H:1"=40' / V:1"=4' DATE 07.31.2023

PLAN AND PROFILE STREET "B", STA. 10+00 THRU STA. 16+35

FINAL DRAWING - NOT RELEASED FOR CONSTRUCTION

C5.01

CITY OF RALEIGH PUBLIC UTILITIES STANDARD UTILITY NOTES (AS APPLICABLE)

DETAILS & SPECIFICATIONS (REFERENCE: CORPUD HANDBOOK, CURRENT EDITION)

- 1. ALL MATERIALS & CONSTRUCTION METHODS SHALL BE IN ACCORDANCE WITH CITY OF RALEIGH DESIGN STANDARDS,
- 2. UTILITY SEPARATION REQUIREMENTS:
- a. A DISTANCE OF 100' SHALL BE MAINTAINED BETWEEN SANITARY SEWER & ANY PRIVATE OR PUBLIC WATER SUPPLY SOURCE SUCH AS AN IMPOUNDED RESERVOIR USED AS A SOURCE OF DRINKING WATER. IF ADEQUATE LATERAL SEPARATION CANNOT BE ACHIEVED. FERROUS SANITARY SEWER PIPE SHALL BE SPECIFIED & INSTALLED TO WATERLINE SPECIFICATIONS. HOWEVER, THE MINIMUM SEPARATION SHALL NOT BE LESS THAN 25' FROM A PRIVATE WELL OR 50' FROM A PUBLIC WELL.
- b. WHEN INSTALLING WATER &/OR SEWER MAINS, THE HORIZONTAL SEPARATION BETWEEN UTILITIES SHALL BE 10'. IF THIS SEPARATION CANNOT BE MAINTAINED DUE TO EXISTING CONDITIONS, THE VARIATION ALLOWED IS THE WATER MAIN IN A SEPARATE TRENCH WITH THE ELEVATION OF THE WATER MAIN AT LEAST 18" ABOVE THE TOP OF THE SEWER & MUST BE APPROVED BY THE PUBLIC UTILITIES DIRECTOR. ALL DISTANCES ARE MEASURED FROM OUTSIDE DIAMETER TO
- c. Where it is impossible to obtain proper separation, or anytime a sanitary sewer passes over a WATERMAIN, DIP MATERIALS OR STEEL ENCASEMENT EXTENDED 10' ON EACH SIDE OF CROSSING MUST BE SPECIFIED & INSTALLED TO WATERLINE SPECIFICATIONS
- d. 5.0' MINIMUM HORIZONTAL SEPARATION IS REQUIRED BETWEEN ALL SANITARY SEWER & STORM SEWER FACILITIES, UNLESS DIP MATERIAL IS SPECIFIED FOR SANITARY SEWER.
- e. MAINTAIN 18" MIN. VERTICAL SEPARATION AT ALL WATERMAIN & RCP STORM DRAIN CROSSINGS; MAINTAIN 18" MIN. VERTICAL SEPARATION AT ALL SANITARY SEWER & RCP STORM DRAIN CROSSINGS. WHERE ADEQUATE SEPARATIONS CANNOT BE ACHIEVED, SPECIFY DIP MATERIALS & A CONCRETE CRADLE HAVING 6" MIN. CLEARANCE (PER CORPUD DETAILS W-41 &
- f. ALL OTHER UNDERGROUND UTILITIES SHALL CROSS WATER & SEWER FACILITIES WITH 18" MIN. VERTICAL SEPARATION
- ANY NECESSARY FIELD REVISIONS ARE SUBJECT TO REVIEW & APPROVAL OF AN AMENDED PLAN &/OR PROFILE BY THE CITY OF RALEIGH PUBLIC UTILITIES DEPARTMENT PRIOR TO CONSTRUCTION.
- 4. CONTRACTOR SHALL MAINTAIN CONTINUOUS WATER & SEWER SERVICE TO EXISTING RESIDENCES & BUSINESSES THROUGHOUT CONSTRUCTION OF PROJECT. ANY NECESSARY SERVICE INTERRUPTIONS SHALL BE PRECEDED BY A 24 HOUR ADVANCE NOTICE TO THE CITY OF RALEIGH PUBLIC UTILITIES DEPARTMENT.
- 5. 3.0' MINIMUM COVER IS REQUIRED ON ALL WATER MAINS & SEWER FORCEMAINS. 4.0' MINIMUM COVER IS REQUIRED ON ALL REUSE MAINS.
- IT IS THE DEVELOPER'S RESPONSIBILITY TO ABANDON OR REMOVE EXISTING WATER & SEWER SERVICES NOT BEING USED IN REDEVELOPMENT OF A SITE UNLESS OTHERWISE DIRECTED BY THE CITY OF RALEIGH PUBLIC UTILITIES DEPARTMENT. THIS
- INSTALL 3/4" COPPER WATER SERVICES WITH METERS LOCATED AT ROW OR WITHIN A 2'X2' WATERLINE EASEMENT IMMEDIATELY ADJACENT. NOTE: IT IS THE APPLICANT'S RESPONSIBILITY TO PROPERLY SIZE THE WATER SERVICE FOR EACH CONNECTION TO PROVIDE ADEQUATE FLOW & PRESSURE.

INCLUDES ABANDONING TAP AT MAIN & REMOVAL OF SERVICE FROM ROW OR EASEMENT PER CORPUD HANDBOOK PROCEDURE

- 8. INSTALL 4" PVC SEWER SERVICES @ 1.0% MINIMUM GRADE WITH CLEANOUTS LOCATED AT ROW OR EASEMENT LINE & SPACED EVERY 75 LINEAR FEET MAXIMUM.
- PRESSURE REDUCING VALVES ARE REQUIRED ON ALL WATER SERVICES EXCEEDING 80 PSI; BACKWATER VALVES ARE REQUIRED ON ALL SANITARY SEWER SERVICES HAVING BUILDING DRAINS LOWER THAN 1.0' ABOVE THE NEXT UPSTREAM MANHOLE.
- 10. ALL ENVIRONMENTAL PERMITS APPLICABLE TO THE PROJECT MUST BE OBTAINED FROM NCDWQ, USACE &/OR FEMA FOR ANY RIPARIAN BUFFER, WETLAND &/OR FLOODPLAIN IMPACTS (RESPECTIVELY) PRIOR TO CONSTRUCTION.
- 11. NCDOT / RAILROAD ENCROACHMENT AGREEMENTS ARE REQUIRED FOR ANY UTILITY WORK (INCLUDING MAIN EXTENSIONS & SERVICE TAPS) WITHIN STATE OR RAILROAD ROW PRIOR TO CONSTRUCTION
- 12. GREASE INTERCEPTOR / OIL WATER SEPARATOR SIZING CALCULATIONS & INSTALLATION SPECIFICATIONS SHALL BE APPROVED BY THE CORPUD FOG PROGRAM COORDINATOR PRIOR TO ISSUANCE OF A BUILDING PERMIT. CONTACT TIM BEASLEY AT
- (919) 996-2334 OR TIMOTHY.BEASLEY@RALEIGHNC.GOV FOR MORE INFORMATION. 13. CROSS-CONNECTION CONTROL PROTECTION DEVICES ARE REQUIRED BASED ON DEGREE OF HEALTH HAZARD INVOLVED AS LISTED IN APPENDIX-B OF THE RULES GOVERNING PUBLIC WATER SYSTEMS IN NORTH CAROLINA. THESE GUIDELINES ARE THE MINIMUM REQUIREMENTS. THE DEVICES SHALL MEET AMERICAN SOCIETY OF SANITARY ENGINEERING (ASSE) STANDARDS
- OR BE ON THE UNIVERSITY OF SOUTHERN CALIFORNIA APPROVAL LIST. THE DEVICES SHALL BE INSTALLED AND TESTED (BOTH INITIAL AND PERIODIC TESTING THEREAFTER) IN ACCORDANCE WITH THE MANUFACTURER'S RECOMMENDATIONS OR THE LOCAL CROSS-CONNECTION CONTROL PROGRAM WHICHEVER IS MORE STRINGENT, CONTACT, IOANIE HARTLEY AT (919) 996-5923 OR JOANIE.HARTLEY@RALEIGHNC.GOV FOR MORE INFORMATION.

NOTES:

DEEDS OF EASEMENT FOR SANITARY SEWER PURPOSES TO CITY OF RALEIGH RECORDED IN BOOK 12249, PAGE 864 AND BOOK 12466, PAGE 1149 AND AS SHOWN ON RECORDED PLAT IN BOOK OF MAPS 2006, PAGES 2216 AND 2217. WAKE COUNTY REGISTRY.

(DEED OF EASEMENT SUPERSEDED BY BM 2008 PG 480 & 481

RIGHT OF WAY AND UTILITY EASEMENTS RECORDED IN BOOK 13736 PAGES 1287 AND 1294 AND AS SHOWN ON RECORDED PLAT IN BOOK OF MAPS 2009, PAGE 1091, WAKE COUNTY REGISTRY.

(AS SHOWN ON SURVEY)

DEEDS OF EASEMENT FOR SANITARY SEWER PURPOSES TO CITY OF RALEIGH RECORDED IN BOOK 12249, PAGE 860 AND BOOK 12466, PAGE 1171 AND AS SHOWN ON RECORDED PLAT IN BOOK OF MAPS 2006, PAGES 2216 AND 2217, WAKE COUNTY REGISTRY.

BY-PASS PUMPING NOTES:

- 1. DEVELOPER SHALL PROVIDE 30 DAYS ADVANCE WRITTEN NOTICE TO PROPERTY OWNER FOR ANY WORK REQUIRED WITHIN AN EXISTING CITY OF RALEIGH UTILITY EASEMENT TRAVERSING PRIVATE PROPERTY.
- 2. A BYPASS PLAN SEALED BY A NC PROFESSIONAL ENGINEER MUST BE SUBMITTED TO CITY OF RALEIGH PUBLIC UTILITIES PRIOR TO PUMPING OPERATIONS TO COORDINATE WITH ENGINEERING STAFF, PUMPS SHOULD BE SIZED TO HANDLE THE PEAK FLOW(2.5 TIMES THE AVERAGE DAILY FLOW) FOR THE LINE OR AREA OF WORK, THE CONTRACTOR SHALL SECURE THE PUMPS FROM A PUMP SUPPLIER ACCORDING TO THE PROVIDED FLOW INFORMATION, PUMPING OPERATIONS MUST BE MONITORED 24 HOURS A DAY FOR EACH OF THE PUMPING OPERATION BY QUALIFIED PERSONNEL IN ORDER TO RESPONSE TO PROBLEMS OR FAILURES. 100% REDUNDANCY IS REQUIRED FOR PUMPING OPERATIONS. IN ADDITION, BACK UP PUMPS ARE TO BE CONNECTED TO THE BYPASS FORCE MAIN TO FACILITATE IMMEDIATE USE UPON FAILURE OF THE PRIMARY PUMPS.

TRAFFIC CONTROL

1. ALL EXISTING DRIVES, ROADS, SIDEWALKS, PAVED AREAS IMPACTED BY CONSTRUCTION OPERATIONS, SHALL BE REPLACED TO EXISTING CONDITION OR BETTER.

TEMPORARY SKIMMER BASIN SPECIFICATIONS:

- L. CLEAR, GRUB, AND STRIP THE AREA UNDER THE EMBANKMENT OF ALL VEGETATION AND ROOT MAT. REMOVE ALL SURFACE SOIL CONTAINING HIGH AMOUNTS OF ORGANIC MATTER AND STOCKPILE OR DISPOSE OF IT PROPERLY. HAUL ALL OBJECTIONABLE MATERIAL TO THE DESIGNATED DISPOSAL AREA. PLACE TEMPORARY SEDIMENT CONTROL MEASURES BELOW BASIN AS NEEDED.
- . ENSURE THAT FILL MATERIAL FOR THE EMBANKMENT IS FREE OF ROOTS, WOODY VEGETATION, ORGANIC MATTER, AND OTHER OBJECTIONABLE MATERIAL. PLACE THE FILL IN LIFTS NOT THE EXCEED 9 INCHES, AND MACHINE COMPACT IT. OVER FILL THE EMBANKMENT 6 INCHES TO ALLOW FOR SETTLEMENT.
- 3. SHAPE THE BASIN TO THE SPECIFIED DIMENSIONS. PREVENT THE SKIMMING DEVICE FROM SETTLING INTO THE MUD BY EXCAVATING A SHALLOW PIT UNDER THE SKIMMER OR PROVIDING A LOW SUPPORT UNDER THE SKIMMER OF STONE OR TIMBER.
- 4. PLACE THE BARREL (TYPICALLY 4-INCH SCHEDULE 40 PVC PIPE) ON A FIRM, SMOOTH FOUNDATION OF IMPERVIOUS SOIL. DO NOT USE PERVIOUS MATERIAL SUCH AS SAND, GRAVEL, OR CRUSHED STONE AS BACKFILL AROUND THE PIPE. PLACE THE FILL MATERIAL AROUND THE PIPE SPILLWAY IN 4-INCH LAYERS AND COMPACT IT UNDER AND AROUND THE PIPE TO AT LEAST THE SAME DENSITY AS THE ADJACENT EMBANKMENT. CARE MUST BE TAKEN NOT THE RAISE THE PIPE FROM THE FIRM CONTACT WITH ITS FOUNDATION WHEN COMPACTING UNDER THE PIPE HAUNCHES.
- 5. PLACE A MINIMUM DEPTH OF 2 FEET OF COMPACTED BACKFILL OVER THE PIPE SPILLWAY BEFORE CROSSING IT WITH CONSTRUCTION EQUIPMENT. IN NO CASE SHOULD THE PIPE CONDUIT BE INSTALLED BY CUTTING A TRENCH THROUGH THE DAM AFTER THE EMBANKMENT IS COMPLETE.
- 6. ASSEMBLE THE SKIMMER FOLLOWING THE MANUFACTURER'S INSTRUCTIONS, OR AS DESIGNED. 7. LAY THE ASSEMBLED SKIMMER ON THE BOTTOM OF THE BASIN WITH THE FLEXIBLE JOINT AT THE INLET OF THE BARREL PIPE. ATTACH THE FLEXIBLE JOINT TO THE BARREL PIPE AND POSITION THE SKIMMER OVER THE EXCAVATED PIT OR SUPPORT. BE SURE TO ATTACH A ROPE TO THE SKIMMER AND ANCHOR IT TO THE SIDE OF THE BASIN. THIS WILL BE USED TO PULL THE SKIMMER TO THE SIDE FOR MAINTENANCE.
- 8. EARTHEN SPILLWAYS INSTALL THE SPILLWAY IN UNDISTURBED SOIL TO THE GREATEST EXTENT POSSIBLE. THE ACHIEVEMENT OF PLANNED ELEVATIONS, GRADE, DESIGN WIDTH, AND ENTRANCE AND EXIT CHANNEL SLOPES ARE CRITICAL TO THE SUCCESSFUL OPERATION OF THE SPILLWAY. THE SPILLWAY SHOULD BE LINED WITH LAMINATED PLASTIC OR IMPERMEABLE GEOTEXTILE FABRIC. THE FABRIC MUST BE WIDE AND LONG ENOUGH TO COVER THE BOTTOM AND SIDES AND EXTEND ONTO THE TOP OF THE DAM FOR ANCHORING IN A TRENCH. THE EDGES MAY BE SECURED WITH 8-INCH STAPLES OR PINS THE FABRIC MUST BE LONG ENOUGH TO EXTEND DOWN THE SLOPE AND EXIT ONTO STABLE GROUND. THE WIDTH OF THE FABRIC MUST BE ONE PIECE. NOT JOINED OR SPLICED; OTHERWISE WATER CAN GET UNDER THE FABRIC. IF THE LENGTH OF THE FABRIC IS INSUFFICIENT FOR THE ENTIRE LENGTH OF THE SPILLWAY, MULTIPLE SECTIONS, SPANNING THE COMPLETE WIDTH, MAY BE USED, THE UPPER SECTION (S) SHOULD OVERLAP THE LOWER SECTION(S) SO THAT WATER CANNOT FLOW UNDER THE FABRIC. SECURE THE UPPER EDGE AND SIDES OF THE FABRIC IN A TRENCH WITH STAPLES OR PINS. (ADAPTED FROM "A MANUAL FOR DESIGNING, INSTALLING, AND MAINTAINING SKIMMER SEDIMENT BASINS." FEBRUARY, 1999. J. W. FAIRCLOTH & SON.).
- 9. INLETS DISCHARGE WATER INTO THE BASIN IN A MANNER TO PREVENT EROSION. USE TEMPORARY SLOPE DRAINS OR DIVERSIONS WITH OUTLET PROTECTION TO DIVERT SEDIMENT-LADEN WATER TO THE UPPER END OF THE POOL AREA TO IMPROVE BASIN TRAP EFFICIENCY (REFERENCES: RUNOFF CONTROL MEASURES AND OUTLET PROTECTION)
- 10. EROSION CONTROL CONSTRUCT THE STRUCTURE SO THAT THE DISTURBED AREA IS MINIMIZED. DIVERT SURFACE WATER AWAY FROM BARE AREAS. COMPLETE THE EMBANKMENT BEFORE THE AREA IS CLEARED. STABILIZE THE EMERGENCY SPILLWAY EMBANKMENT AND ALL OTHER DISTURBED AREAS ABOVE THE CREST OF THE PRINICIPAL SPILLWAY IMMEDIATELY AFTER CONSTRUCTION (REFERENCES: SURFACE STABILIZATION).
- 11. INSTALL POROUS BAFFLES AS SPECIFIED IN PRACTICE 6.65, POROUS BAFFLES. 12. AFTER ALL THE SEDIMENT-PRODUCING AREAS HAVE BEEN PERMANENTLY STABILIZED, REMOVE THE STRUCTURE AND ALL THE UNSTABLE SEDIMENT.

SMOOTH THE AREA TO BLEND WITH THE ADJOINING AREAS AND STABILIZE PROPERLY (REFERENCES: SURFACE STABILIZATION)

- **CONSTRUCTION SEQUENCE STAGE 1**
- 1. REQUEST PRE-CONSTRUCTION MEETING WITH DEMLR RALEIGH REGIONAL OFFICE AT LEAST 72 HOURS PRIOR TO COMMENCING THE PROJECT. CONTACT THE OFFICE AT LEAST 48 HOURS PRIOR TO COMMENCING THE LAND-DISTURBING ACTIVITY
- 2. EROSION AND SEDIMENT CONTROL (E&SC) PERMIT AND A CERTIFICATE OF COVERAGE (COC) MUST BE OBTAINED BEFORE ANY LAND DISTURBING ACTIVITIES (INCLUDING TIMBERING AND DEMOLITION) OCCUR. A COPY OF THE E&SC PERMIT, THE COC, AND A HARD COPY OF THE PLANS MUST BE KEPT ON SITE, PREFERABLY IN A PERMITS BOX, AND ACCESSIBLE DURING INSPECTION
- 3. INSTALL TREE PROTECTION FENCE AT FINAL LOCATIONS SHOWN. CALL NCDEQ TO INSPECT TREE PROTECTION FENCE. TREE PROTECTION FENCING MUST BE INSTALLED AND INSPECTED BY NCDEQ SITE INSPECTOR PRIOR TO A GRADING PERMIT BEING ISSUED.
- ATTEND PRE-CONSTRUCTION MEETING WITH NCDEQ EROSION CONTROL INSPECTOR.
- OBTAIN GRADING PERMIT.
- 6. INSTALL CONSTRUCTION ENTRANCE, SILT FENCE WITH OUTLETS, AND TEMPORARY STREAM CROSSING AS SHOWN ON THIS EROSION CONTROL PLAN STAGE 1. CONTRACTOR SHALL CLEAR ONLY AS NECESSARY FOR CONSTRUCTION EQUIPMENT TO ACCESS AND INSTALL THE TEMPORARY EROSION CONTROL DEVICES. INSTALL THE REQUIRED LINER FOR ALL DIVERSION DITCHES WHEN INSTALLING THE DITCHES. NO CLEARING SHALL OCCUR OUTSIDE OF THE LIMITS OF CONSTRUCTION SHOWN UNLESS PRIOR APPROVAL IS OBTAINED FROM NCDEO EROSION CONTROL INSPECTOR. ENSURE EXISTING SEDIMENT BASIN IS FUNCTIONING PROPERLY. IF SEDIMENT BASIN WAS CONVERTED TO AN SCM, REINSTALL THE SKIMMER AND BAFFLES AS SHOWN UNDER THE PHASE 1C INFRASTRUCTURE PLANS (22-DP-1332).
- 7. INSTALL ALL REMAINING PERIMETER EROSION CONTROL MEASURES AS SHOWN TO PREVENT EROSION AND SEDIMENTATION FROM OCCURRING WHEN GENERAL GRADING
- 8. OBTAIN CERTIFICATE OF COMPLIANCE THROUGH ON-SITE INSPECTION BY NCDEQ EROSION CONTROL INSPECTOR.
- 9. PROCEED WITH CLEARING OF SITE.
- 10. ALL FROSION AND SEDIMENTATION CONTROL PRACTICES SHALL BE CHECKED BY
- CONTRACTOR FOR STABILITY AND OPERATION FOLLOWING EVERY RUNOFF-PRODUCING RAINFALL BUT IN NO CASE LESS THAN ONCE EVERY WEEK. ANY NEEDED REPAIRS SHALL BE MADE IMMEDIATELY TO MAINTAIN ALL PRACTICES AS DESIGNED.
- 11. CLEAN SEDIMENT BASINS WHEN ONE-HALF FULL
- 12. ALL AREAS AND SLOPES DISTURBED DURING CONSTRUCTION AND EXPOSED SHALL BE STABILIZED WITH TEMPORARY SEEDING AND MULCHING WITHIN 14 CALENDAR DAYS FOLLOWING COMPLETION OF ANY PHASE OF GRADING OR PERIOD OF INACTIVITY. PERMANENT GROUNDCOVER IS TO BE ESTABLISHED FOR ALL DISTURBED AREAS WITHIN 14 WORKING DAYS OR 90 CALENDAR DAYS, WHICHEVER IS SHORTER, FOLLOWING COMPLETION OF CONSTRUCTION, COMPLETION OF GRADING OR PERIOD OF INACTIVITY. PFRMANFNT SFFDING. MULCHING AND GROUND COVER SHALL BE APPLIED TO THE SITE FOLLOWING COMPLETION OF CONSTRUCTION. HIGH QUALITY WATER (HWQ) ZONES AND PERIMETER DIKES, SWALES, DITCHES, AND SLOPES SHALL BE STABILIZED WITH TEMPORARY SEEDING AND MULCHING WITHIN 7 CALENDAR DAYS..
- 13. MAINTAIN SOIL EROSION CONTROL MEASURES UNTIL PERMANENT GROUND COVER IS ESTABLISHED.
- 14. WITH APPROVAL FROM NCDEQ EROSION CONTROL INSPECTOR MOVE TO EROSION CONTROL PLAN STAGE 2.

CONSTRUCTION SEQUENCE - STAGE 2

- 1. PROCEED WITH GRADING/BUILDING CONSTRUCTION.
- 2. INSTALL STORM DRAINAGE SYSTEM AND DIVERT FLOW TO INLETS WITH EXCAVATED INLET PROTECTION. INSTALL RETAINING WALLS AS NECESSARY WHILE MAINTAINING EROSION CONTROL MEASURES.
- 3. DRAIN AND REDUCE THE SEDIMENT BASIN UTILIZING THE SEDIMENT FILTER BAG WHICH WILL BE CONTINUOUSLY MONITORED DURING OPERATION, IN COORDINATION WITH NCDEQ EROSION CONTROL INSPECTOR
- 4. CLEAN SEDIMENT BASIN WHEN ONE-HALF FULL
- 5. ALL EROSION AND SEDIMENTATION CONTROL PRACTICES SHALL BE CHECKED BY CONTRACTOR FOR STABILITY AND OPERATION FOLLOWING EVERY RUNOFF-PRODUCING RAINFALL BUT IN NO CASE LESS THAN ONCE EVERY WEEK. ANY NEEDED REPAIRS SHALL BE MADE IMMEDIATELY TO MAINTAIN ALL PRACTICES AS DESIGNED.
- 6. ALL AREAS AND SLOPES DISTURBED DURING CONSTRUCTION AND EXPOSED SHALL BE STABILIZED WITH TEMPORARY SEEDING AND MULCHING WITHIN 14 CALENDAR DAYS, FOLLOWING COMPLETION OF ANY PHASE OF GRADING OR PERIOD OF INACTIVITY. PERMANENT GROUNDCOVER IS TO BE ESTABLISHED FOR ALL DISTURBED AREAS WITHIN 14 WORKING DAYS OR 90CALENDAR DAYS. WHICHEVER IS SHORTER. FOLLOWING COMPLETION OF CONSTRUCTION. COMPLETION OF GRADING OR PERIOD OF INACTIVITY. PERMANENT SEEDING, MULCHING AND GROUND COVER SHALL BE APPLIED TO THE SITE FOLLOWING COMPLETION OF CONSTRUCTION. HIGH QUALITY WATER (HWQ) ZONES AND PERIMETER DIKES, SWALES, DITCHES, AND SLOPES SHALL BE STABILIZED WITH TEMPORARY SEEDING AND MULCHING WITHIN 7 CALENDAR DAYS..
- 7. CONTINUE INSTALLATION OF PAVEMENT. CURB AND GUTTER.
- 8. ALL EROSION AND SEDIMENTATION CONTROL PRACTICES SHALL BE CHECKED BY CONTRACTOR FOR STABILITY AND OPERATION FOLLOWING EVERY RUNOFF-PRODUCING RAINFALL BUT IN NO CASE LESS THAN ONCE EVERY WEEK. ANY NEEDED REPAIRS SHALL BE MADE IMMEDIATELY TO MAINTAIN ALL PRACTICES AS DESIGNED.
- 9 ALL AREAS AND SLOPES DISTURBED DURING CONSTRUCTION AND EXPOSED SHALL BE STABILIZED WITH TEMPORARY SEEDING AND MULCHING WITHIN 14 CALENDAR DAYS FOLLOWING COMPLETION OF ANY PHASE OF GRADING OR PERIOD OF INACTIVITY. PERMANENT GROUNDCOVER IS TO BE ESTABLISHED FOR ALL DISTURBED AREAS WITHIN 14 WORKING DAYS OR 90 CALENDAR DAYS, WHICHEVER IS SHORTER, FOLLOWING COMPLETION OF CONSTRUCTION, COMPLETION OF GRADING OR PERIOD OF INACTIVITY. PERMANENT SEEDING, MULCHING AND GROUND COVER SHALL BE APPLIED TO THE SITE FOLLOWING COMPLETION OF CONSTRUCTION. HIGH QUALITY WATER (HWQ) ZONES AND PERIMETER DIKES, SWALES, DITCHES, AND SLOPES SHALL BE STABILIZED WITH TEMPORARY SEEDING AND MULCHING WITHIN 7 CALENDAR DAYS
- 10. PERIMETER MEASURES MUST BE LEFT IN PLACE UNTIL ALL UPLAND AREAS ARE PERMANENTLY STABILIZED. AFTER SITE IS PERMANENTLY STABILIZED. REMOVE ALL TEMPORARY EROSION CONTROL MEASURES AND PROVIDE PERMANENT SEEDING WHERE TEMPORARY MEASURES HAVE BEEN REMOVED AND GROUND COVER IS NOT ADEQUATE. SEDIMENTS BASINS MAY NOT BE REMOVED OR CONVERTED TO PERMANENT SCMS UNTIL ALL UPLAND AREAS ARE PERMANENTLY STABILIZED. NCDEQ SHOULD BE NOTIFIED 10-DAYS PRIOR TO REMOVAL OF A BASIN.
- 12. FILL IN EXCAVATED STORAGE AREAS AND DEWATER USING SEDIMENT FILTER BAGS. REMOVE EROSION CONTROL MEASURES FROM ALL AREAS THAT HAVE BEEN PERMANENTLY STABILIZED AND STABILIZE THE AREAS OF THE DEVICE REMOVAL WITH APPROVAL FROM EROSION CONTROL INSPECTOR.

DEVELOPER AND THE LOCAL GOVERNMENT STATING THE NITROGEN BUY DOWN HAS BEEN COMPLETED.

6. A COPY OF THE APPROVED EROSION CONTROL PLAN MUST BE ON FILE AT THE JOB SITE AT ALL TIMES.

PAVEMENT AND INSTALL ADDITIONAL MEASURES TO PREVENT THE FUTURE OCCURRENCE.

SHALL BE REMOVED IMMEDIATELY PRIOR TO THE FINAL SITE INSPECTION FOR THE SITE.

SHALL BE REMOVED IMMEDIATELY PRIOR TO THE FINAL SITE INSPECTION FOR THE SITE.

19. CONSTRUCTION ENTRANCES MUST BE MODIFIED TO ACHIEVE ADA COMPLIANCE WHERE APPLICABLE.

21. THE PROJECT MAY REQUIRE A PRE-CONSTRUCTION CONFERENCE BEFORE THE GRADING PERMIT IS ISSUED.

22. THE SKIMMER AND SEDIMENT BASIN OUTLET PIPE MUST BE ON SITE BEFORE THE GRADING PERMIT IS ISSUED.

ADDITIONAL FIELD MEASURES AS NECESSARY TO PROVIDE ADEQUATE PROTECTION FROM RECEIVING WATER COURSES.

WATER OR SEDIMENT OCCURS ALONG SILT FENCE, CONTRACTOR SHALL INSTALL AN ADDITIONAL SILT FENCE OUTLET.

20. THE STREETS IN FRONT OF THE PROJECT AREA WILL BE KEPT CLEAN AT ALL TIMES OR A WASH STATION WILL BE REQUIRED.

1. EROSION AND SEDIMENT CONTROL DEVICES MUST BE INSTALLED AND INSPECTED PRIOR TO ANY GRADING ON SITE. THE CONTRACTOR SHALL CALL FOR A INSPECTION BY NCDEQ SEDIMENTATION AND EROSION CONTROL (SEC) ONCE

2. REQUIRED TREE PROTECTION FENCING SHALL BE INSTALLED AND INSPECTED AND A PRE-CONSTRUCTION CONFERENCE SCHEDULED WITH THE TOWN'S URBAN FORESTER PRIOR TO BEGINNING LAND DISTURBANCE.

7. CONSTRUCTION, MAINTENANCE, AND REMOVAL OF ALL EROSION CONTROL DEVICES ARE THE RESPONSIBILITY OF THE GRADING CONTRACTOR UNLESS OTHERWISE NOTED.

INSTALLED AT THE SAME TIME AS THE EROSION CONTROL MEASURES AND SHALL BE IN PLACE UNTIL ALL CONSTRUCTION IN THE VICINITY OF THE TREES IS COMPLETE

16. TEMPORARY DIVERSIONS SHALL BE MAINTAINED DAILY BY CONTRACTOR SO THAT THEY ARE FUNCTIONAL AT THE END OF EACH WORKDAY AND WHEN STOPPING WORK FOR RAIN.

8. ANY GRADING BEYOND THE DENUDED LIMITS SHOWN ON THE PLAN IS A VIOLATION OF THE COUNTY EROSION CONTROL ORDINANCE AND IS SUBJECT TO A FINE.

3. GRADING PERMIT WILL NOT BE ISSUED UNTIL NCDEQ HAS RECEIVED NOTIFICATION FROM THE ECOSYSTEM ENHANCEMENT PROGRAM OR AN APPROVED NUTRIENT OFFSET BANK THAT A RECEIPT HAS BEEN ISSUED TO THE

4. SEDIMENT/EROSION CONTROL DEVICES MUST BE CHECKED AFTER EACH STORM EVENT. EACH DEVICE IS TO BE MAINTAINED OR REPLACED IF SEDIMENT ACCUMULATION HAS REACHED ONE HALF THE CAPACITY OF THE DEVICE.

9. NO DEBRIS SHALL BE TRACKED ONTO ANY EXISTING PAVED AREAS OR PUBLIC RIGHT OF WAY. IF THE SITUATION OCCURS WHERE MUD, ROCK AND DEBRIS IS TRACKED ONTO PAVEMENT, THE CONTRACTOR SHALL CLEAN THE

10. DURING THE CONSTRUCTION PHASE, ADDITIONAL EROSION AND SEDIMENT CONTROLS MAY BE REQUIRED IF THE PROPOSED MEASURES DO NOT CONTAIN THE SEDIMENT ON SITE. THE EROSION CONTROL INSPECTOR MAY REQUIRE

11. PROTECTION OF EXISTING VEGETATION: AT THE START OF GRADING INVOLVING THE STRIPPING OF TOPSOIL OR LOWERING OF EXISTING GRADE AROUND A TREE, A CLEAN, SHARP, VERTICAL CUT SHALL BE MADE AT THE EDGE OF THE

TREE SAVE AREA AT THE SAME TIME AS OTHER EROSION CONTROL MEASURES ARE INSTALLED. THE TREE PROTECTION FENCING SHALL BE INSTALLED ON THE SIDE OF THE CUT FARTHEST AWAY FROM THE TREE TRUNK AND SHALL

AREA AND SHALL BE POSTED ON THE PROTECTION FENCE. A PROTECTION FENCE CONSTRUCTED OF MATERIAL RESISTANT TO DEGRADATION BY SUN, WIND, AND MOISTURE FOR THE DURATION OF THE CONSTRUCTION, SHALL BE

12. A CONSTRUCTION SEQUENCE HAS BEEN PROVIDED. INSTALLATION OF ALL PROPOSED SEDIMENTATION & EROSION CONTROL MEASURES IN THE SEQUENCE(S) PROVIDED AND MAINTENANCE OF THOSE DEVICES IS REQUIRED. THE

13. CUT AND FILL SLOPE THAT IS TWO TO ONE (2:1) OR GREATER SHALL BE STABILIZED WITH PERMANENT SLOPE RETENTION DEVICES OR A SUITABLE COMBINATION OF PLANTINGS AND RETENTION DEVICES. SLOPES GREATER THAN

14. PROVIDE INLET PROTECTION AROUND ALL SITE STORM INLETS. PROTECT OPEN PIPES UNDER CONSTRUCTION WITH EITHER PLYWOOD OR WITH MESH AND GRAVEL WEIRS. RUNOFF SHALL NOT BE ALLOWED IN ANY OPEN TRENCH.

15. CONTRACTOR TO VERIFY SILT FENCE OUTLET PLACEMENT AT LOW POINTS AS THEY EXIST OR DEVELOP. ADDITIONAL SILT FENCE OUTLETS MAY BE REQUIRED TO PREVENT EROSION DURING AND AFTER CONSTRUCTION AND LAND

THREE TO ONE (3:1) SHALL NOT BE STABILIZED WITH TURF GRASS BUT MUST BE STABILIZED WITH VEGETATION THAT REQUIRES MINIMAL MAINTENANCE. WEEPING LOVE GRASS, RED FESCUE OR OTHER APPROVED VARIETY. (CHAPTER

DISTURBANCE ACTIVITIES. IF ADDITIONAL SILT FENCE OUTLETS ARE NECESSARY, CONTRACTOR TO ADD ADDITIONAL SILT FENCE OUTLETS PER ENGINEER, NCDEQ EROSION CONTROL INSPECTOR, OR OWNER DIRECTION. IF PONDING OF

17. THE TREE PROTECTION FENCE SHALL BE MAINTAINED ON THE SITE UNTIL ALL SITE WORK IS COMPLETED AND THE FINAL SITE INSPECTION IS SCHEDULED PRIOR TO THE ISSUANCE OF A CERTIFICATE OF OCCUPANCY (CO). THE FENCING

(LANDSCAPING FENCING, OR UTILITY INSTALLATION) SHOWN ON THE APPROVED PLANS IN A TREE PROTECTION AREA SHALL ALSO NOT OCCUR WITHOUT WRITTEN AUTHORIZATION FROM THE TOWN'S ZONING COMPLIANCE STAFF.

23. THE TREE PROTECTION FENCE SHALL BE MAINTAINED ON THE SITE UNTIL ALL SITE WORK IS COMPLETED AND THE FINAL SITE INSPECTION IS SCHEDULED PRIOR TO THE ISSUANCE OF A CERTIFICATE OF OCCUPANCY (CO). THE FENCING

(LANDSCAPING, FENCING, OR UTILITY INSTALLATION) SHOWN ON THE APPROVED PLANS IN A TREE PROTECTION AREA, SHALL ALSO NOT OCCUR WITHOUT WRITTEN AUTHORIZATION FROM THE TOWN'S ZONING COMPLIANCE STAFF.

ANY UNAUTHORIZED ENCROACHMENT OR DISTURBANCE WITHIN THE BOUNDARIES OF A TREE PROTECTION AREA SHALL AUTOMATICALLY RESULT IN FINES AND THE REPLACEMENT OF ANY DAMAGED VEGETATION IN ACCORDANCE

24. TREE PROTECTION FENCING SHALL NOT BE MOVED AND THERE SHALL BE NO ENCROACHMENT INTO SUCH PROTECTED AREA(S) WITHOUT WRITTEN AUTHORIZATION OF THE TOWN'S ZONING COMPLIANCE STAFF. ANY ACTIVITY

ANY UNAUTHORIZED ENCROACHMENT OR DISTURBANCE WITHIN THE BOUNDARIES OF A TREE PROTECTION AREA SHALL AUTOMATICALLY RESULT IN FINES AND THE REPLACEMENT OF ANY DAMAGED VEGETATION IN ACCORDANCE

18. TREE PROTECTION FENCING SHALL NOT BE MOVED AND THERE SHALL BE NO ENCROACHMENT INTO SUCH PROTECTED AREA(S) WITHOUT WRITTEN AUTHORIZATION OF THE TOWN'S ZONING COMPLIANCE STAFF. ANY ACTIVITY

CONTRACTOR MAY BE ALLOWED, WITH PRIOR APPROVAL FROM THE OWNER, TO COORDINATE CHANGES TO THE PLAN WITH THE ON-SITE SEDIMENTATION & EROSION CONTROL INSPECTOR AND THE ENGINEER.

REMAIN IN PLACE UNTIL ALL CONSTRUCTION IN THE VICINITY OF THE TREES IS COMPLETE. NO STORAGE OF MATERIALS, FILL, OR EQUIPMENT AND NO TRESPASSING SHALL BE ALLOWED WITHIN THE BOUNDARY OF THE PROTECTED

5. IN ADDITION TO THE REQUIREMENT DURING CONSTRUCTION FOR THE INSPECTION OF EROSION CONTROL DEVICES AFTER EVERY RAINFALL, THE CONTRACTOR SHALL INSPECT THE EROSION AND SEDIMENT CONTROL DEVICES AND

OFFSITE ROADWAYS DAILY, MAKE ANY NECESSARY REPAIRS OR ADJUSTMENTS TO THE DEVICES, REMOVE DEPOSITION OF WET OR DRY SILT ON ADJACENT ROADWAYS AND MAINTAIN INSPECTION LOGS DOCUMENTING THE DAILY

13. WHEN THE PROJECT IS COMPLETE, THE PERMITTEE SHALL CONTACT DEMLR TO CLOSE OUT THE E&SC PLAN.

EROSION CONTROL NOTES:

INSPECTIONS AND ANY NECESSARY REPAIRS.

7. PART 2. SECTION 4. (G) LDO).

WITH THE LAND DEVELOPMENT ORDINANCE.

WITH THE LAND DEVELOPMENT ORDINANCE

STOCKPILE NOTES

- A. STOCKPILE FOOTPRINTS SHALL BE SETBACK A MINIMUM OF 25' FROM ADJACENT PROPERTY LINES.
- B. STOCKPILE HEIGHT SHALL NOT EXCEED 35 FEET.
- C. STOCKPILE SLOPES SHALL BE 2:1 OR FLATTER.
- D. OFF-SITE SPOIL OR BORROW AREAS MUST BE IN COMPLIANCE WITH WAKE COUNTY UDO AND STATE REGULATIONS. ALL SPOIL AREAS OVER AN ACRE ARE REQUIRED TO HAVE AN APPROVED SEDIMENT CONTROL PLAN. DEVELOPER/CONTRACTOR SHALL NOTIFY WAKE COUNTY OF ANY OFFSITE DISPOSAL OF SOIL, PRIOR TO DISPOSAL. FILL OF FEMA FLOODWAYS AND NON-ENCROACHMENT AREAS ARE PROHIBITED EXCEPT AS OTHERWISE PROVIDED BY SUBSECTION 14-19-2 OF THE WAKE COUNTY UNIFIED DEVELOPMENT ORDINANCE (CERTIFICATIONS AND PERMITS REQUIRED).
- E. SEEDING OR COVERING STOCKPILES WITH TARPS OR MULCH IS REQUIRED AND WILL REDUCE EROSION PROBLEMS. TARPS SHOULD BE KEYED IN AT THE TOP OF THE SLOPE TO KEEP WATER FROM RUNNING UNDERNEATH THE PLASTIC.
- F. IF A STOCKPILE IS TO REMAIN FOR FUTURE USE AFTER THE PROJECT IS COMPLETE (BUILDERS, ETC.), THE FINANCIAL RESPONSIBLE PARTY MUST NOTIFY WAKE COUNTY OF A NEW RESPONSIBLE PARTY FOR THAT STOCKPILE.
- G. THE USE OF STAGED SEEDING AND MULCHING ON A CONTINUAL BASIS WHILE THE STOCKPILE IS IN USE IS
- H. ESTABLISH AND MAINTAIN A VEGETATIVE BUFFER AT THE TOE OF THE SLOPE (WHERE PRACTICAL).
- I. STOCKPILE MUST HAVE SILT FENCE WRAPPED AROUND THE LOW SIDE(S) AND A SILT FENCE OUTLET AT ALL LOW POINTS.

TEMPORARY SEEDING SCHEDULE

SEEDING DATE	SEEDING MIXTURE	APPLICATION RATE
JAN 1 - MAY 1	RYE (GRAIN)	120 LBS/AC
	KOBE LESPEDEZA	50 LBS/AC
MAY 1 - AUG 15	GERMAN MILLET	40 LBS/AC
AUG 15 - DEC 30	RYE (GRAIN)	120 LBS/AC

FOLLOW RECOMMENDATIONS OF SOIL TESTS OR APPLY 4,000 LB/AC GROUND AGRICULTURE LIMESTONE AND 750 LB/AC 10-10-10 FERTILIZER (FROM AUG 15 - DEC 30, INCREASE 10-10-10 FERTILIZER TO 1000 LB/AC).

APPLY 4000 LB/AC STRAW. ANCHOR STRAW BY TACKING WITH ASPHALT, NETTING, OR A MULCH ANCHORING TOOL. A DISK WITH BLADES SET NEARLY STRAIGHT CAN BE USED AS A MULCH ANCHORING TOOL.

REFERTILIZE IF GROWTH IS NOT FULLY ADEQUATE. RESEED, REFERTILIZE, AND MULCH

IMMEDIATELY FOLLOWING EROSION OR OTHER DAMAGE.

REPAIR AND REFERTILIZE DAMAGED AREAS IMMEDIATELY. TOP DRESS WITH 50 LB/AC OF NITROGEN IN MARCH. IF IT IS NECESSARY TO EXTEND TEMPORARY COVER BEYOND JUNE 15, OVERSEED WITH 50 LB/AC KOBE LESPEDEZA IN

NOTE: USE THE TEMPORARY SEEDING SCHEDULE ONLY WHEN DATE IS NOT CORRECT TO USE THE PERMANENT SEEDING SCHEDULE.

LATE FEBRUARY OR EARLY MARCH.

PERMANENT SEEDING SCHEDULE

SEEDING DATE	SEEDING MIXTURE	APPLICATION RATE
AUG 25 - OCT (BEST)	TALL FESCUE	200 LBS/AC
	RYE (GRAIN)	50 LBS/AC
	GERMAN MILLET	50 LBS/AC
FEB - APR 15 (POSSIBLE)	TALL FESCUE	200 LBS/AC
	RYE (GRAIN)	50 LBS/AC
	GERMAN MILLET	50 LBS/AC
COIL AMENIDMENTS		

FOLLOW RECOMMENDATIONS OF SOIL TESTS OR APPLY 4,000 LB/AC GROUND AGRICULTURE LIMESTONE AND 1000 LB/AC 10-10-10 FERTILIZER.

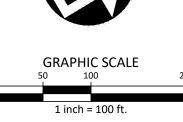
APPLY 4000 LB/AC STRAW. ANCHOR STRAW BY TACKING WITH ASPHALT, NETTING, OR A MULCH ANCHORING TOOL. A DISK WITH BLADES SET NEARLY STRAIGHT CAN BE USED AS A MULCH ANCHORING TOOL.

INSPECT AND REPAIR MULCH FREQUENTLY. REFERTILIZE IN LATE WINTER OF THE FOLLOWING YEAR; USE SOIL TESTS OR APPLY 150

LB/AC 10-10-10 FERTLIZER. MOW REGULARLY TO A HEIGHT OF 2-4 INCHES.

- NEEDED REPAIRS SHALL BE MADE IMMEDIATELY TO MAINTAIN ALL MEASURES AS DESIGNED.
- SEDIMENT BASINS SHALL BE INSPECTED REGULARLY DURING LAND DISTURBING ACTIVITIES AND AFTER EACH RUNOFF-PRODUCING RAINFALL. SEDIMENT SHALL BE REMOVED AND THE BASIN RESTORED TO ITS ORIGINAL DIMENSIONS WHEN SEDIMENT HAS ACCUMULATED TO ONE-HALF THE DESIGN DEPTH OF EACH BASIN. FRESH GRAVEL DURING EACH SEDIMENT REMOVAL EPISODE.
- 3. SEDIMENT FENCES SHALL BE INSPECTED AT LEAST ONCE A WEEK AND AFTER EACH RUNOFF PRODUCING RAINFALL. REPAIRS SHALL BE MADE IMMEDIATELY. SEDIMENT DEPOSITS SHALL BE REMOVED AS NEEDED TO PROVIDE ADEQUATE STORAGE VOLUME FOR THE NEXT RAINFALL EVENT, AND TO REDUCE PRESSURE ON THE FENCE. FENCING MATERIALS AND SEDIMENT DEPOSITS SHALL BE REMOVED, AND THE AREA BROUGHT TO
- 4. DIVERSION DITCHES MUST REMAIN IN PLACE UNTIL PROJECT IS STABILIZED.
- FENCE OUTLETS. DEVICES MUST BE EMPTIED WHEN SEDIMENT ACCUMULATION HAS REACHED 6" DEPTH.

ALL CONSTRUCTION SHALL BE IN ACCORDANCE WITH THE CURRENT TOWN OF ROLESVILLE ENGINEERING DESIGN AND **CONSTRUCTION STANDARDS**



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> phone 919. 361. 5000 fax 919. 361. 2269 license number: C-0293

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LAND DISTURBANCE NONE NONE IF SLOPES ARE 10' OR LESS IN LENGTH AND ARE NOT STEEPER THAN 2:1, 14-DAYS ARE ALLOWED 7-DAYS FOR SLOPES GREATER THAN 50 FEET IN I FNGTH AND WITH SLOPES STEEPER THAN 4:1 7-DAYS FOR PERIMETER DIKES, SWALS, DITCHES, PERIMETER SLOPES AND HQW ZONES 10-DAYS FOR FALLS LAKE WATERSHED 7-DAYS FOR PERIMETER DIKES, SWALES, DITCHES PERIMETER SLOPES AND HQW ZONES 10-DAYS FOR FALLS LAKE WATERSHED UNLESS THERE IS ZERO SLOPE BUILDING WASTES HANDLING

TIMEFRAME VARIATIONS

CONTRACTOR'S MAINTENANCE PLAN:

- 1. ALL EROSION AND SEDIMENT CONTROL MEASURES SHALL BE CHECKED FOR STABILITY AND OPERATION FOLLOWING EVERY RUNOFF-PRODUCING RAINFALL BUT IN NO CASE LESS THAN ONCE EVERY WEEK. ANY
- PORTIONS OF THE BASIN'S GRAVEL FACING THAT ARE CONTAMINATED BY SEDIMENT SHALL BE REPLACED WITH

TEMPORARY DIVERSION SPECIFICATIONS:

REMOVE AND PROPERLY DISPOSE OF ALL TREES, BRUSH, STUMPS, AND OTHER

OBJECTIONABLE MATERIAL IN THE LOCATIONS OF TEMPORARY DIVERSIONS

2. ENSURE THAT THE MINIMUM CONSTRUCTED CROSS SECTION MEETS ALL DESIGN

ENSURE THAT THE TOP OF THE DIKE IS NOT LOWER AT ANY POINT THAN THE

VEGETATE THE RIDGE IMMEDIATELY AFTER CONSTRUCTION, UNLESS IT WILL

MAINTENANCE - INSPECT TEMPORARY DIVERSIONS ONCE A WEEK AND AFTER

EVERY RAINFALL. IMMEDIATELY REMOVE SEDIMENT FROM THE FLOW AREA AND

REPAIRS AS NEEDED. WHEN THE AREA PROTECTED IS PERMANENTLY STABILIZED.

REMOVE THE RIDGE AND THE CHANNEL TO BLEND WITH THE NATURAL GROUND

AREAS TO BE SEEDED TO BE SCARIFIED 4" DEEP. A FIRM, WELL PULVERIZED, UNIFORM

SEEDBED SHOULD BE PROVIDED. FERTILIZER SHALL BE PLACED DURING SCARIFICATION AS

REQUIRED GROUND STABILIZATION TIMEFRAMES

STABILIZE WITHIN

CALENDAR DAYS AFTER CEASING

NO PAINT OR LIQUID WASTES IN STREAM OR STORM

OTHER WASTES MUST BE LOCATED 50' FROM STORM

EARTHEN-MATERIAL STOCKPILES MUST BE LOCATED 50'

CONCRETE MATERIALS MUST BE CONTROLLED TO AVOID

CONTACT WITH SURFACE WATER, WETLANDS, OR BUFFERS.

DRAINS AND STREAMS UNLESS NO REASONABLE

FROM STORM DRAINS AND STREAMS UNLESS NO

REASONABLE ALTERNATIVES AVAILABLE

ALTERNATIVES AVAILABLE

DEDICATED AREAS FOR DEMOLITION, CONSTRUCTION AND

REPAIR THE DIVERSION RIDGE. CAREFULLY CHECK OUTLETS AND MAKE TIMELY

PROVIDE SUFFICIENT ROOM AROUND DIVERSIONS TO PERMIT MACHINE

REQUIREMENTS. SEE TEMPORARY DIVERSION SWALE DESIGN SUMMARY TABLE.

PRIOR TO CONSTRUCTION OF DIVERSION CHANNELS AND/OR RIDGES.

DESIGN ELEVATION PLUS THE SPECIFIED SETTLEMENT.

REMAIN IN PLACE LESS THAN 30 WORKING DAYS

LEVEL AND APPROPRIATELY STABILIZE IT.

REGRADING AND CLEANOUT.

SEEDBED PREPARATION

LIME: 45 LBS / 1.000 SF

PHOSPHOROUS: 20 LBS / 1,000 SF

FERTILIZER: 17 LBS / 1,000 SF

SITE AREA

PERIMETER DIKES,

SWALES, DITCHES

HIGH QUALITY WATER

AND SLOPES

(HQW) ZONES

SLOPES STEEPER

SLOPES 3:1 TO 4:1

AREAS WITH SLOPES

FOLLOWS:

- GRADE FOLLOWING STABILIZATION OF UPGRADIENT DISTURBED AREAS.
- 5. EROSION CONTROL DURING SITE CONSTRUCTION WILL BE ACCOMPLISHED BY USE OF SILT FENCING AND SILT

PROJECT NO. 202011039 2020110039-PH1-ECN1 FILENAME

> CHECKED BY DRAWN BY SCALE DATE

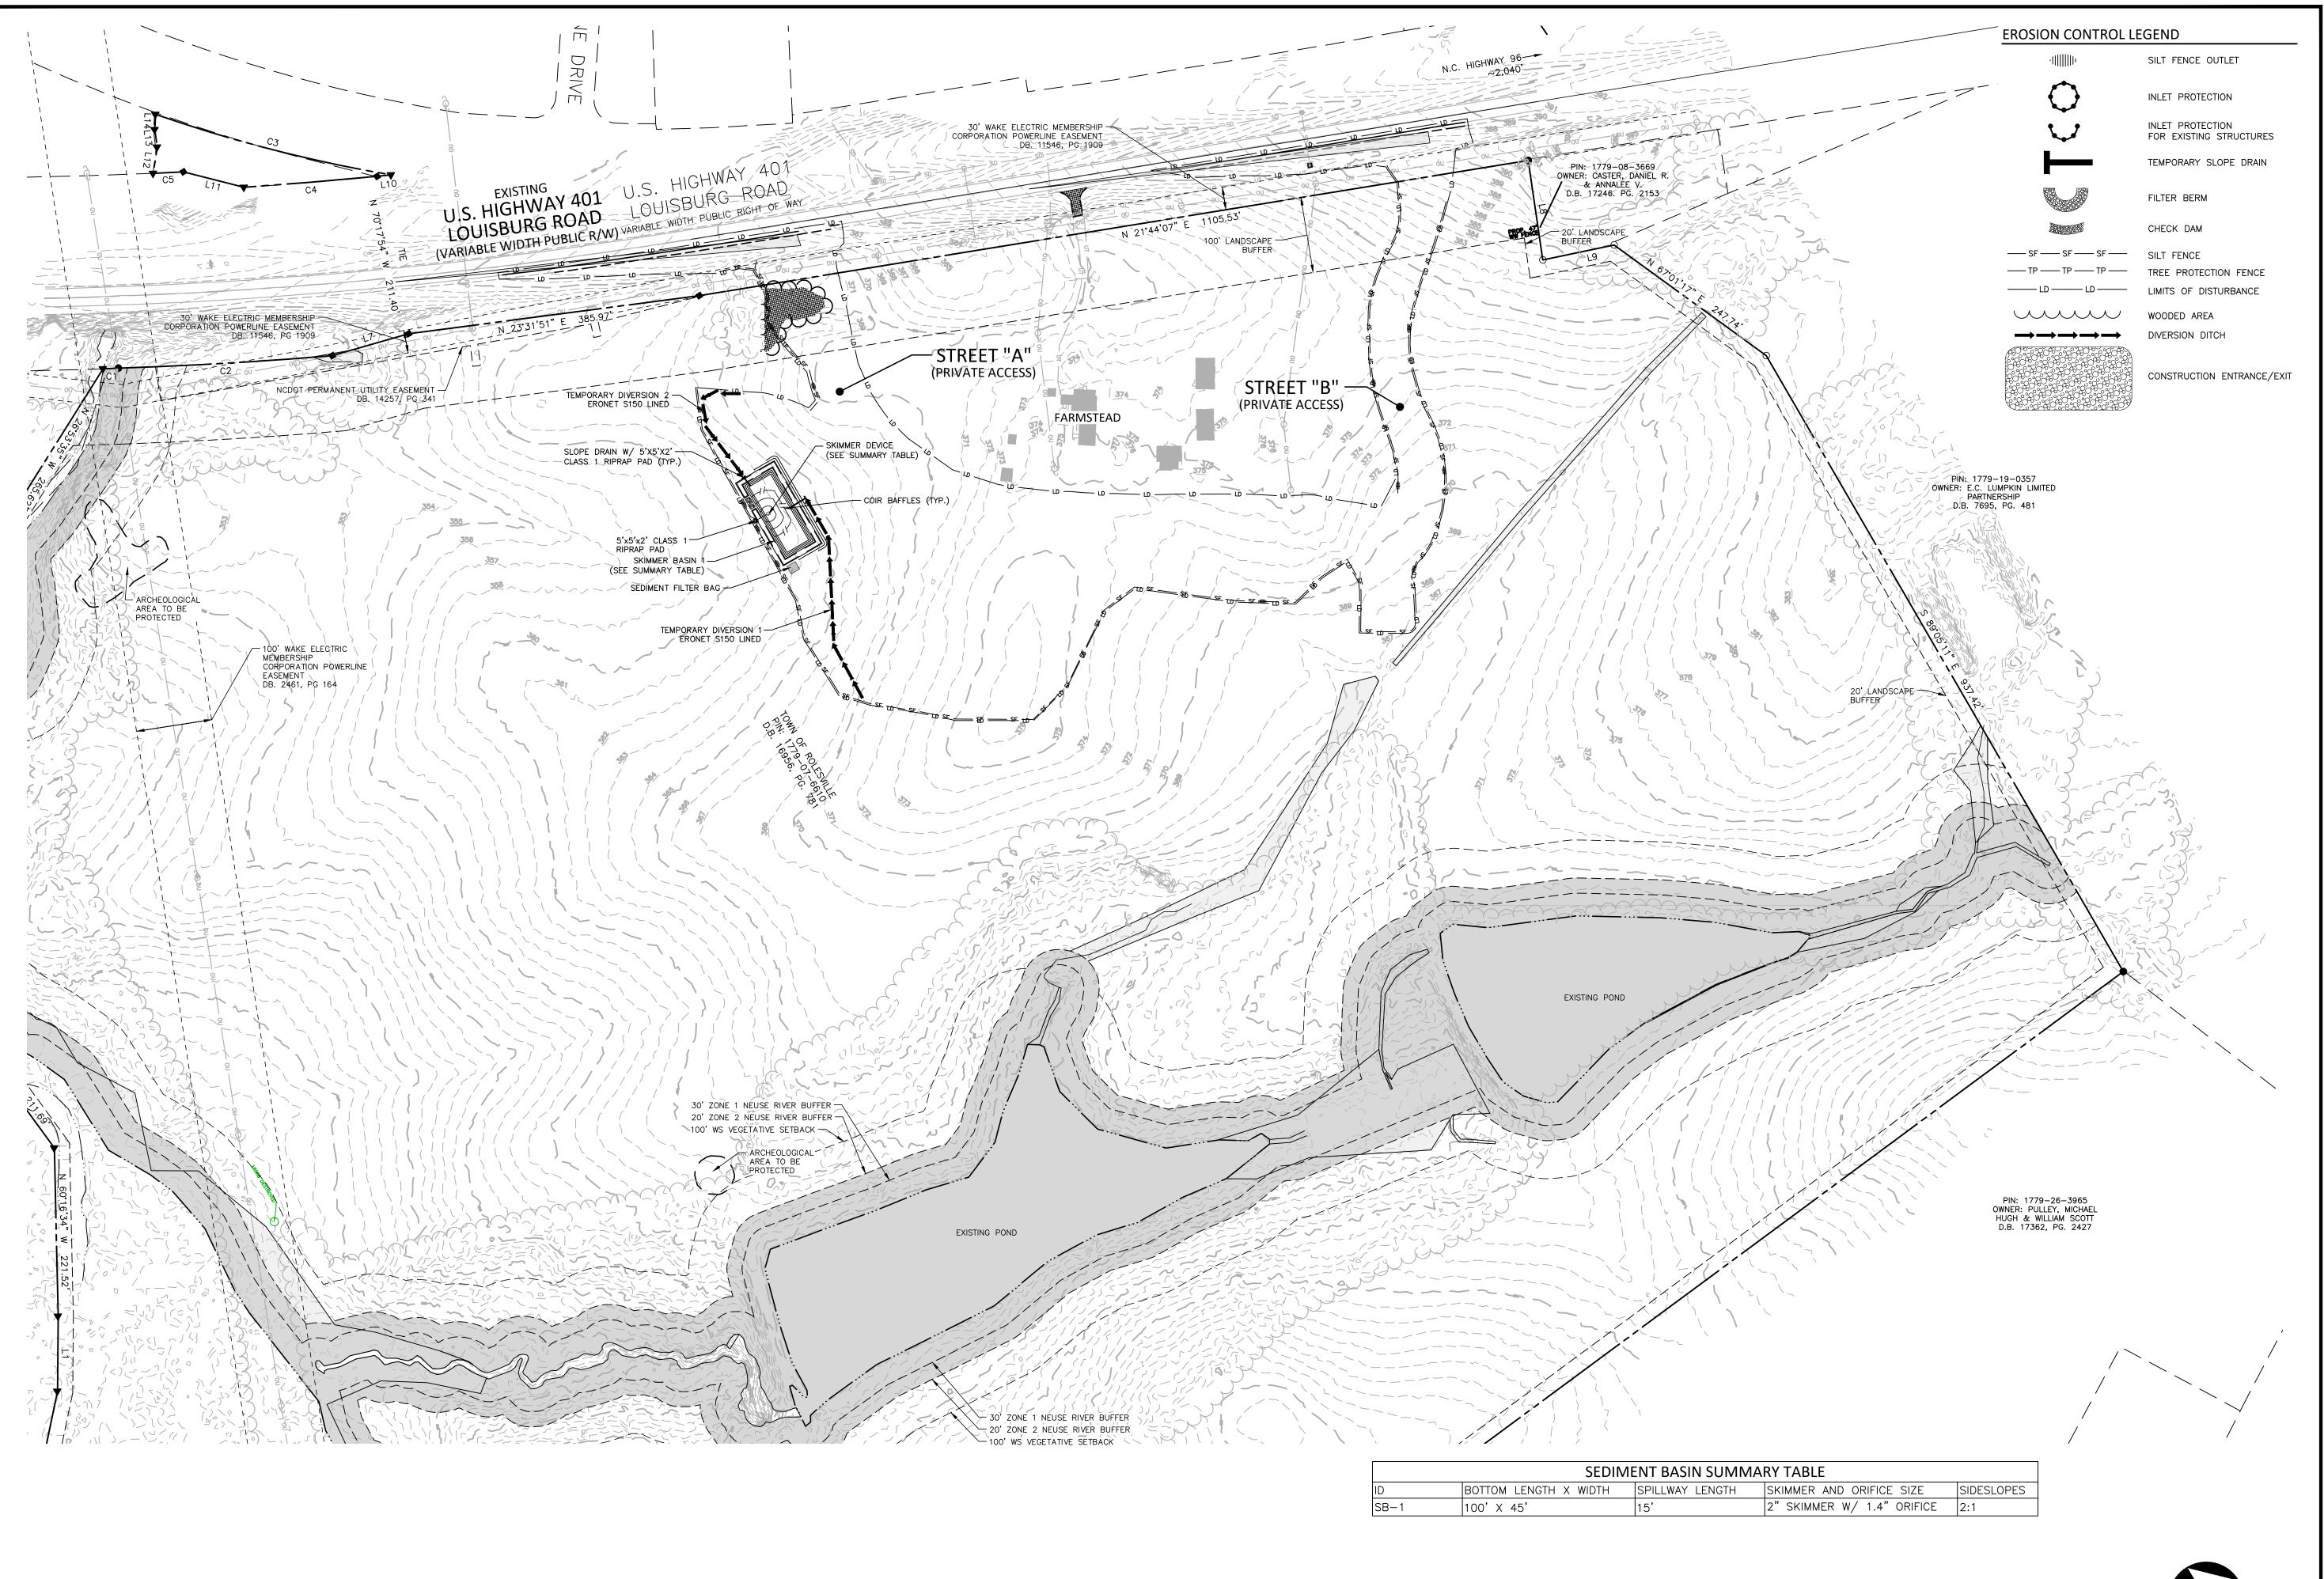
SHEET

PLAN INFORMATION

NO. DATE

EROSION CONTROL

CID-23-PRELIMINARY DRAWING - NOT RELEASED FOR CONSTRUCTION



ALL CONSTRUCTION SHALL BE IN ACCORDANCE WITH THE CURRENT TOWN OF ROLESVILLE ENGINEERING DESIGN AND CONSTRUCTION STANDARDS

CID-23-5 PRELIMINARY DRAWING - NOT RELEASED FOR CONSTRUCTION



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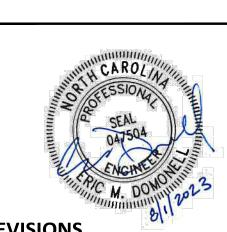
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CLIENT

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ADDRESS: 502 SOUTHTOWN CIRCLE ADDRESS: ROLESVILLE NC 27571 PHONE: 919.554.6582



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PLAN INFORMATION

PROJECT NO. 202011039 2020110039-PH1-EC1 FILENAME CHECKED BY

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OVERALL EROSION CONTROL PLAN-STAGE I



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phone 919. 361. 5000 fax 919. 361. 2269

2905 Meridian Parkway


Durham, NC 27713

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license number: C-0293

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PLAN INFORMATION

2020110039-PH1-EC2 FILENAME

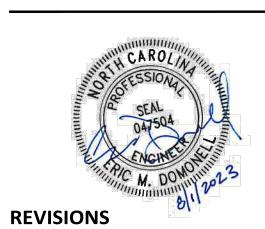
CHECKED BY DRAWN BY 1"=100' SCALE DATE


SHEET

CID-23-5
PRELIMINARY DRAWING - NOT RELEASED FOR CONSTRUCTION

OVERALL EROSION CONTROL PLAN-STAGE II

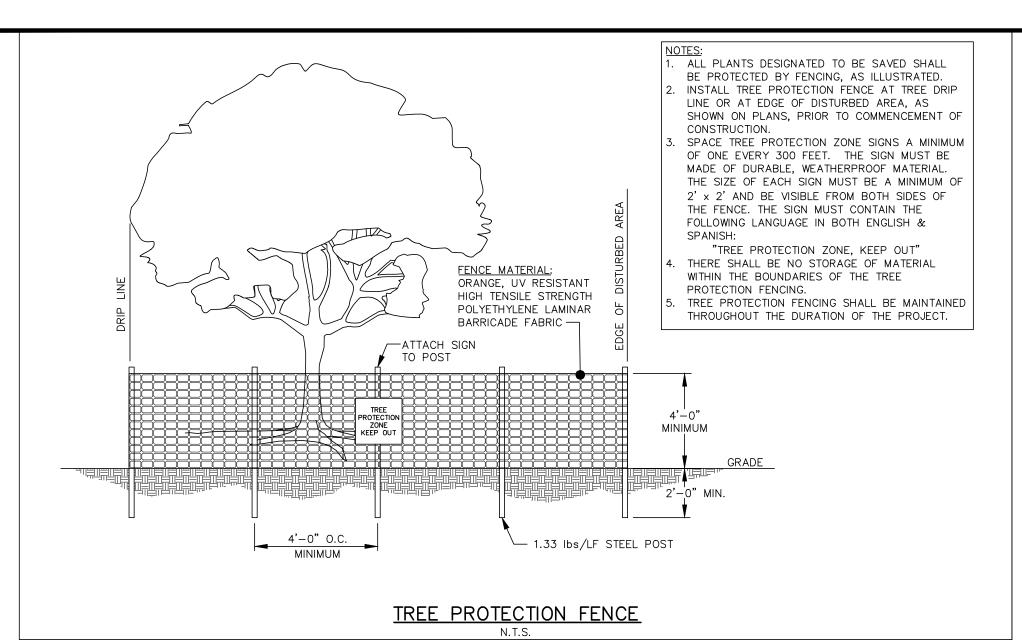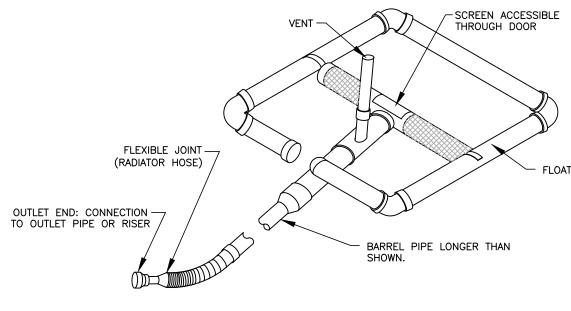C6.02





MAINTENANCE:

IF THE SKIMMER IS CLOGGED WITH WITH TRASH AND THERE IS WATER IN THE BASIN, USUALLY A FEW JERKS ON THE ROPE TO MAKE THE SKIMMER BOB UP AND DOWN WILL DISLODGE THE DEBRIS AND RESTORE FLOW. IF THIS DOES NOT WORK PULL THE SKIMMER OVER TO THE SIDE (IT'S EASIER TO DO WHAEN THE BASIN PARTIALLY FULL) AND REMOVE THE DEBRIS. ALSO CHECK THE ORIFICE INSIDE THE SKIMMER TO SEE IF IT IS CLOGGED; IF SO REMOVE THE DEBRIS.

SEDIMENT UNDER THE SKIMMER. IF SEDIMENT ACCUMULATES TO THE POINT THE SKIMMER CANNOT SETTLE LOW ENOUGH TO DRAIN THE ENTIRE BASIN BULL THE SKIMMER OVER TO ONE SIDE AND EXCAVATE THE SEDIMENT WITH A BACKHOE.

CLOGGED BARREL OR PIPE THROUGH THE DAM. IF THE SKIMMER IS CLOGGED DESPITE REMOVING DEBRIS AND IT APPEARS THAT EITHER THE BARREL BETWEEN THE ORIFICE AND THE FLEXIBLE JOINT OR THE PIPE THROUGH THE DAM IS CLOGGED TAKE THE FOLLOWING STEPS TO CLEAR THE BLOCKAGE (SEDIMENT WILL SOMETIMES ACCUMULATE IN THE PIPE).

*PULL THE SKIMMER OVER TO THE SIDE.

*REMOVE THE PIN AND OPEN THE DOOR TO ACCESS THE ORIFICE.

*REMOVE THE ORIFICE PLUG OR CAP.

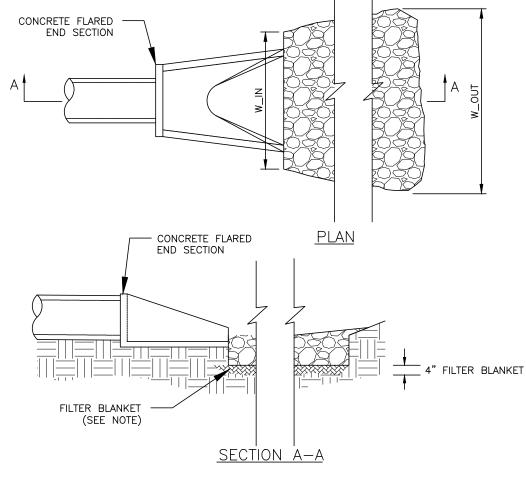
*RAISE THE INLET AS HIGH AS PRACTICAL.

*FILL THE BARREL WITH WATER (USE A BUCKET AND FUNNEL OR A PUMP) TO REMOVE THE CLOG USING THE WATER AND PRESSURE.

*AFTER THE OBSTRUCTION IS REMOVED CONTINUE POURING WATER INTO THE BARREL TO FLUSH OUT ACCUMULATED DEBRIS AND SEDIMENT TO PREVENT FUTURE CLOGGING.

*A PLUMBERS SNAKE CAN BE USED BUT FLUSHING OUT THE SEDIMENT AND DEBRIS IS RECOMMENDED FIRST.

SKIMMER DETAIL



NOTES:

FILTER BLANKET WILL CONSIST OF A MINIMUM 4" THICK LAYER OF STONE (NCDOT #57) UNDERLAIN WITH MIRAFI FILTER WEAVE 700 OR ENGINEER APPROVED EQUIVALENT.

2. INSPECT VELOCITY DISSIPATOR WEEKLY AND AFTER EVERY 1/2 INCH OR GREATER RAINFALL TO SEE IF ANY EROSION AROUND OR BELOW THE RIPRAP HAS TAKEN PLACE, OR IF STONES HAVE BEEN DISLODGED. IMMEDIATELY MAKE ALL NEEDED REPAIRS TO PREVENT FURTHER DAMAGE.

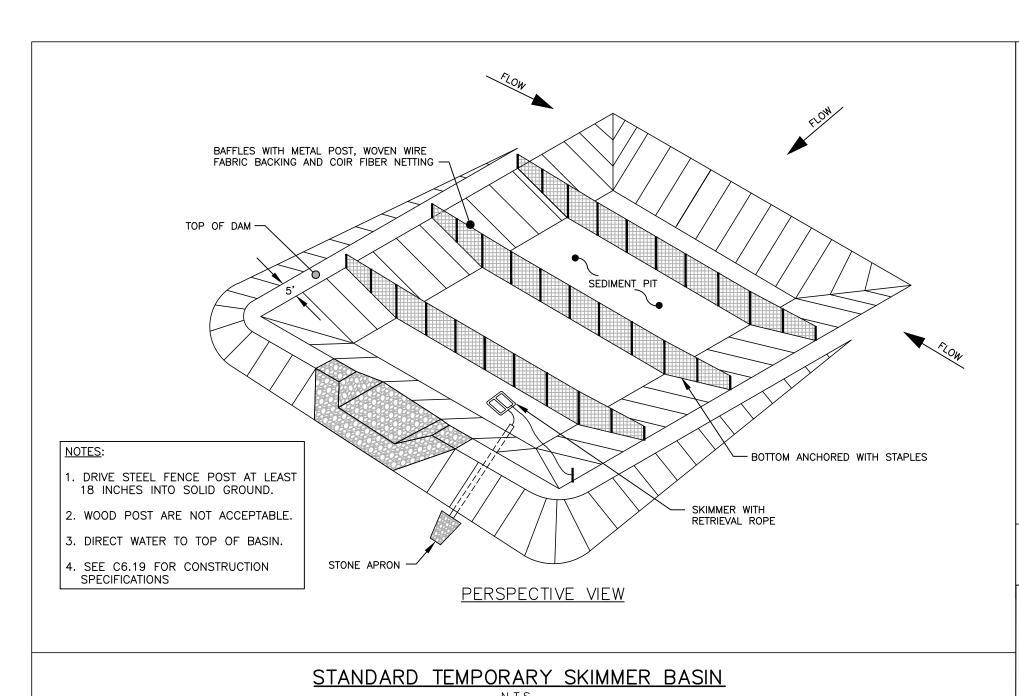
1. A FILTER BLANKET IS TO BE INSTALLED BETWEEN THE RIPRAP AND SOIL FOUNDATION. THE

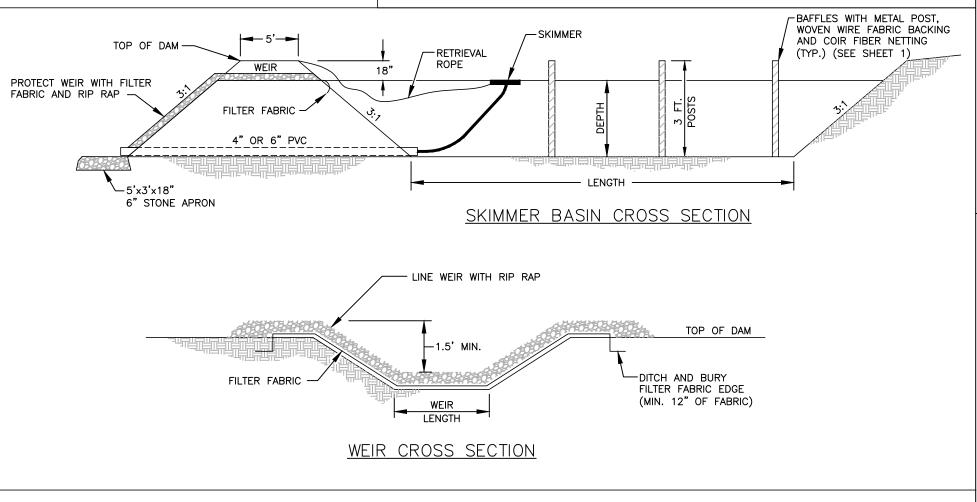
RIP RAP MAINTENANCE

INSPECT CHANNELS AT REGULAR INTERVALS AS WELL AS AFTER MAJOR RAINS, AND MAKE REPAIRS PROMPTLY. GIVE SPECIAL ATTENTION TO THE OUTLET AND INLET SECTIONS AND OTHER POINTS WHERE CONCENTRATED FLOW ENTERS. CAREFULLY CHECK STABILITY AT ROAD CROSSINGS, AND LOOK FOR INDICATIONS OF PIPING, SCOUR HOLES, OR BANK FAILURES. MAKE REPAIRS IMMEDIATELY. MAINTAIN ALL VEGETATION ADJACENT TO THE CHANNEL IN A HEALTHY, VIGOROUS CONDITION TO PROTECT THE AREA FROM EROSION AND SCOUR DURING OUT-OF-BANK FLOW.

FLARED END SECTION VELOCITY DISSIPATOR

N. I.C







STANDARD TEMPORARY SKIMMER BASIN N.T.S.

SEDIMENT BASIN MAINTENANCE

INSPECT TEMPORARY SEDIMENT BASIN AT LEAST WEEKLY AND AFTER EACH SIGNIFICANT (1/2 INCH OR GREATER) RAINFALL EVENT AND REPAIR IMMEDIATELY. REMOVE SEDIMENT AND RESTORE THE BASIN TO ITS ORIGINAL DIMENSIONS WHEN SEDIMENT ACCUMULATES TO ONE—HALF THE DESIGN DEPTH. PLACE REMOVED SEDIMENT IN AN AREA WITH SEDIMENT CONTROLS.

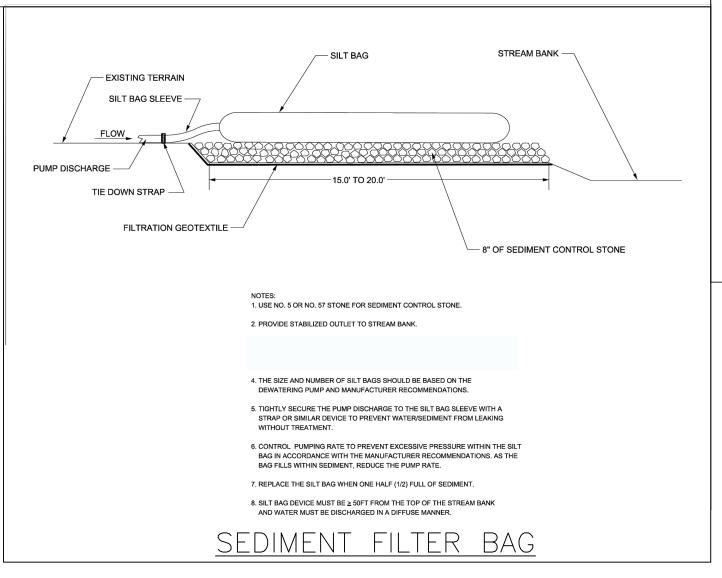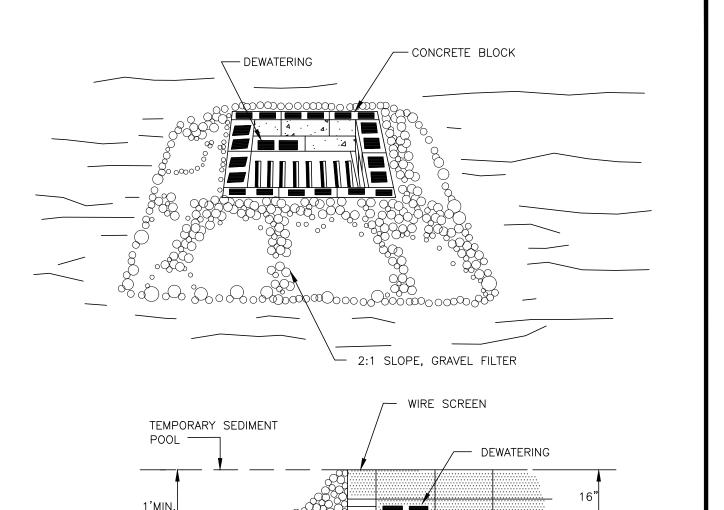CHECK THE EMBANKMENT, SPILLWAY, AND OUTLET FOR EROSION DAMAGE, AND INSPECT THE EMBANKMENT FOR PIPING AND SETTLEMENT. MAKE ALL NECESSARY REPAIRS IMMEDIATELY. REMOVE ALL TRASH AND OTHER DEBRIS FROM THE RISER AND POOL AREAS.





CONSTRUCTION SPECIFICATIONS

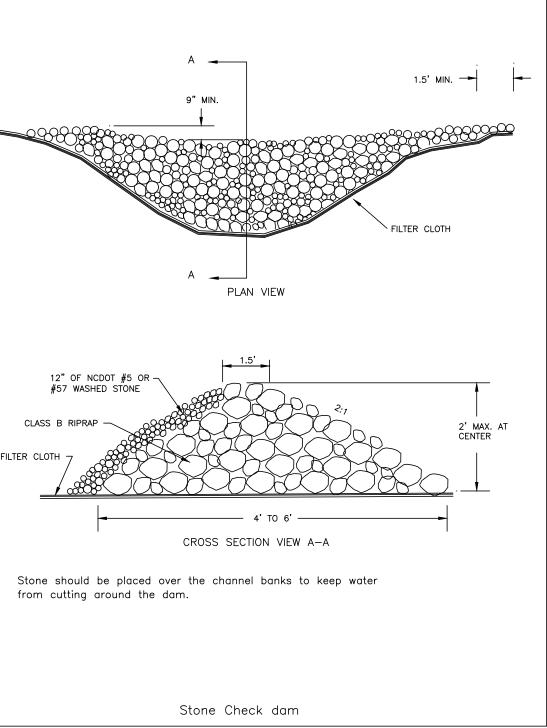
SEDIMENT

1. LAY ONE BLOCK ON EACH SIDE OF THE STRUCTURE ON ITS SIDE ON THE BOTTOM ROW TO ALLOW POOL DRAINAGE. THE FOUNDATION SHOULD BE EXCAVATED AT LEAST 2 INCH BELOW THE CREST OF THE STORM DRAIN. PLACE THE BOTTOM ROW OF THE BLOCK AGAINST THE EDGE OF THE STORM DRAIN FOR LATERAL SUPPORT AND TO AVOID WASHOUTS WHEN OVERFLOW OCCURS. IF NEEDED, GIVE LATERAL SUPPORT TO SUBSEQUENT ROWS BY PLACING 2x4 WOOD STUDS THROUGH BLOCK OPENINGS.

2. CAREFULLY FIT HARDWARE CLOTH OR COMPARABLE WIRE MESH WITH 1/2-INCH OPENING OVER ALL BLOCK OPENING TO HOLD GRAVEL IN PLACE.

3. USE CLEAN GRAVEL, 3/4-TO 1/2-INCH IN DIAMETER, PLACED 2 INCHES BELOW THE TOP OF THE BLOCK ON A 2:1 SLOPE OR FLATTER AND SMOOTH IT TO AN EVEN GRADE. DOT #57 WASHED STONE IS RECOMMENDED

BLOCK AND GRAVEL DROP INLET PROTECTION



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CONSTRUCTION STANDARDS

PRELIMINARY DRAWING - NOT RELEASED FOR CONSTRUCTION

MCADAMS

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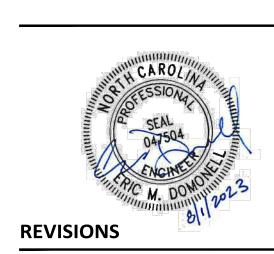
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CLIENT

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ADDRESS: 502 SOUTHTOWN CIRCLE
ADDRESS: ROLESVILLE NC 27571
PHONE: 919.554.6582

FRAZIER FARM PARK CONSTRUCTION DRAWINGS PHASE 1A



NO. DATE

PLAN INFORMATION

PROJECT NO. 202011039

FILENAME 2020110039-PH1-ECN3

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DRAWN BY SME

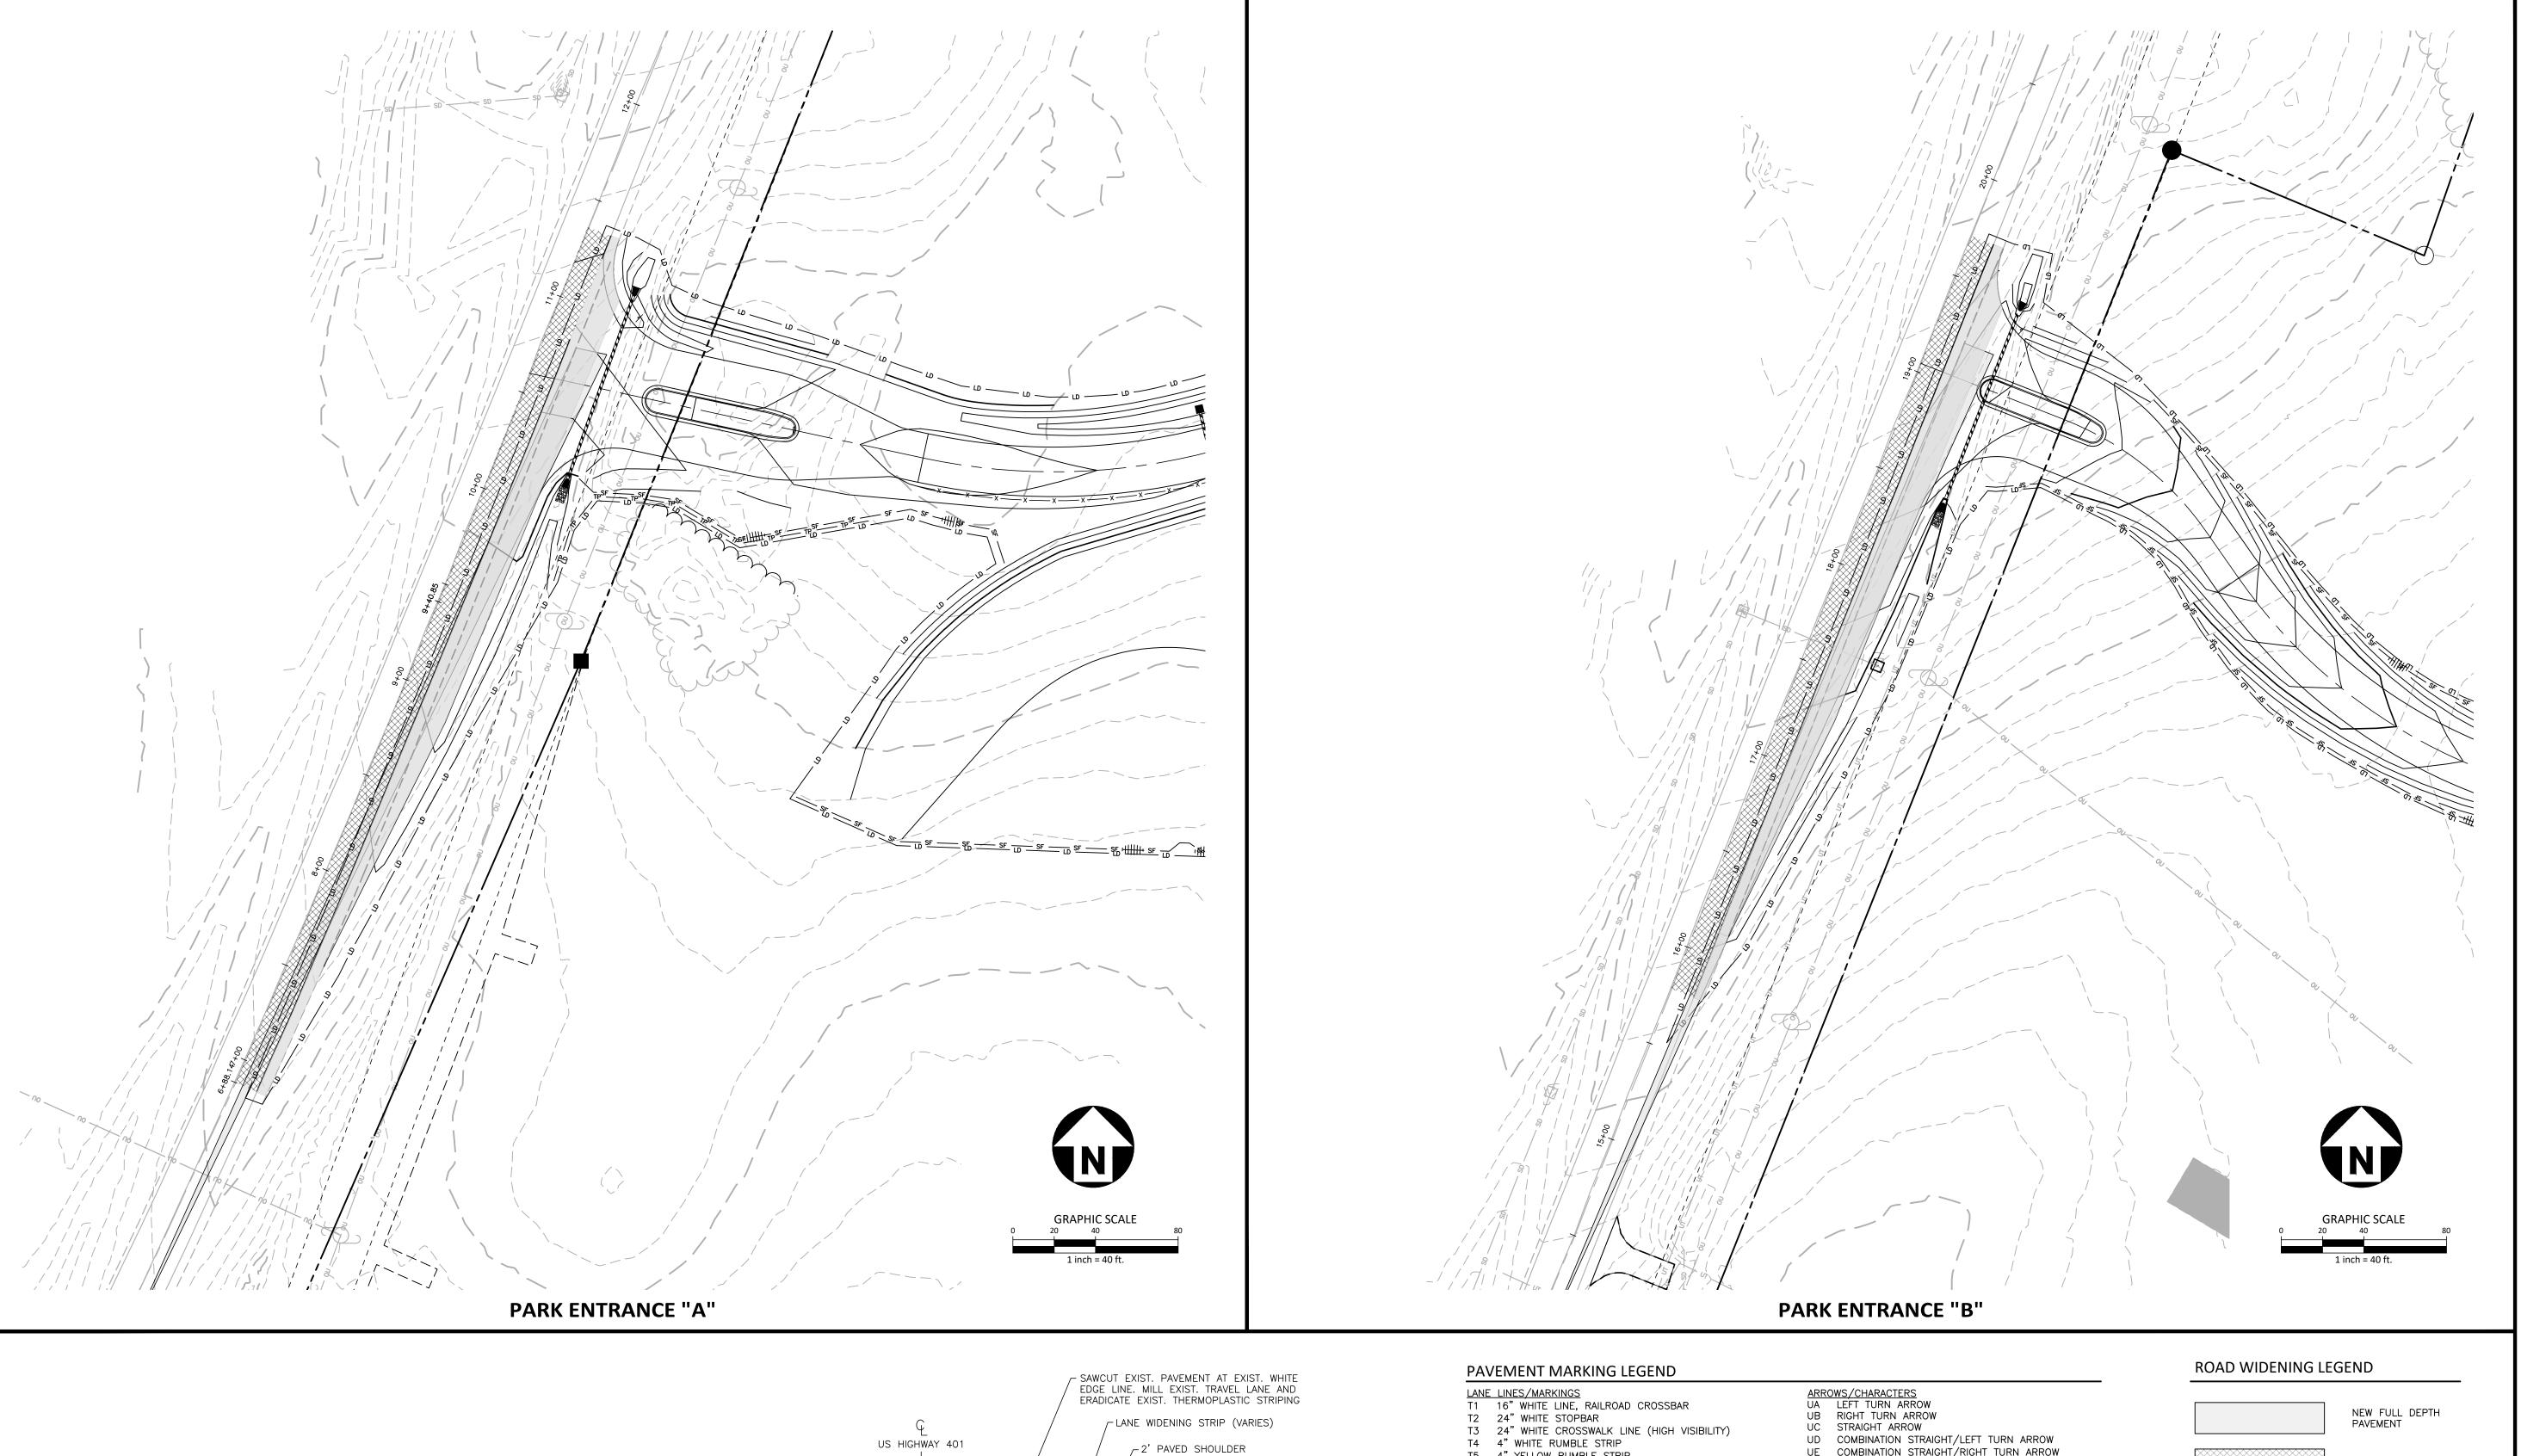
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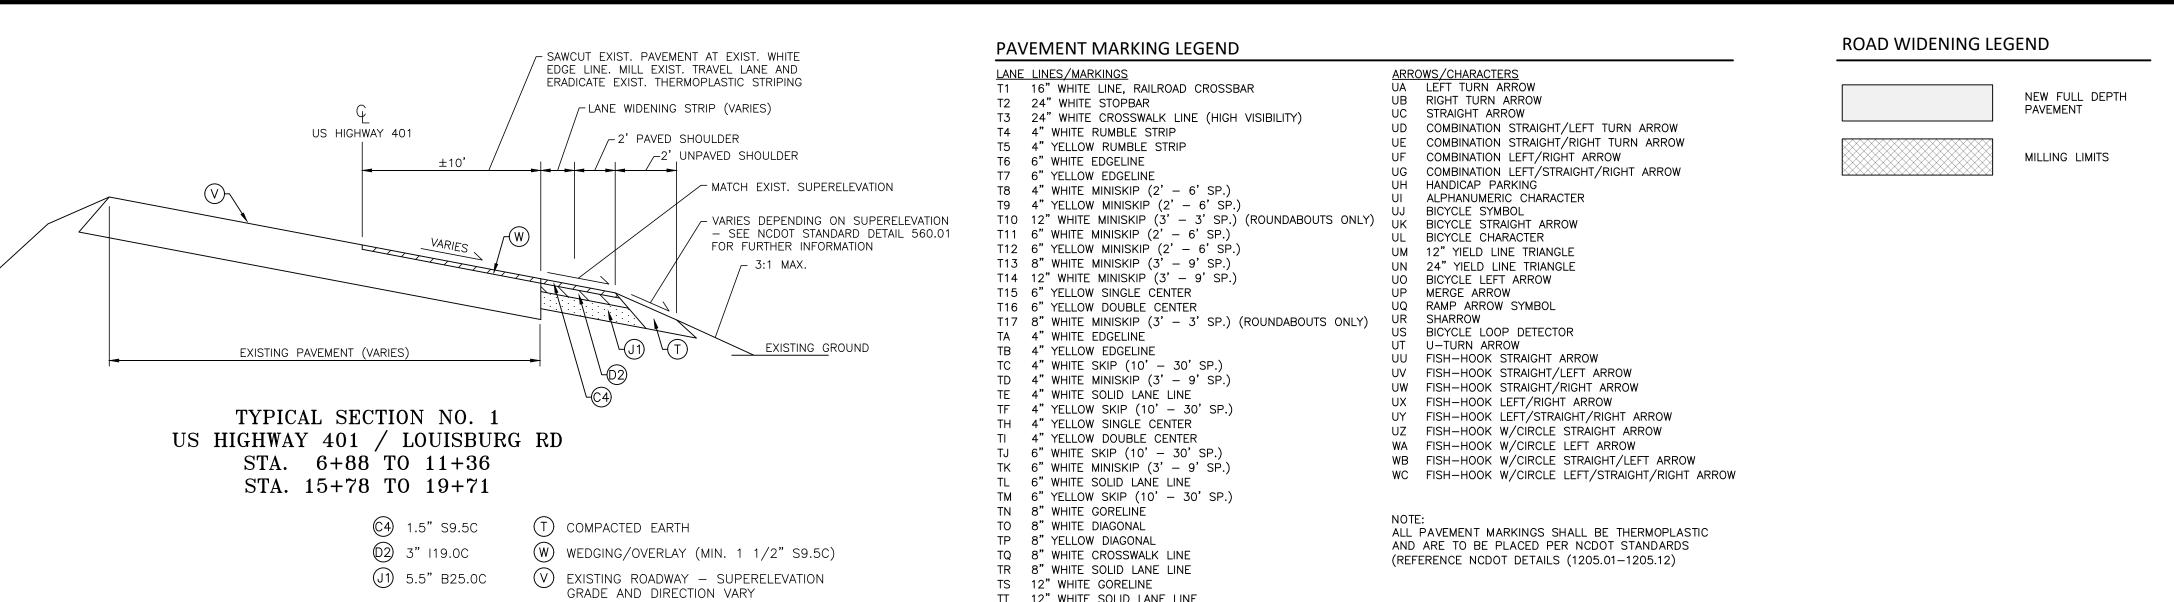
DATE 08.01.2023

SHEET

EROSION CONTROL DETAILS

C6.11





TS 12" WHITE GORELINE

TT 12" WHITE SOLID LANE LINE

TU 12" WHITE DIAGONAL (45MPH OR GREATER) TV 12" YELLOW DIAGONAL (45MPH OR GREATER)

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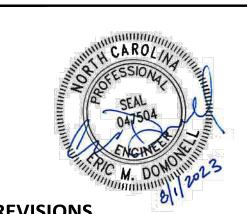
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FRAZIERCONSTRUC



REVISIONS NO. DATE

PLAN INFORMATION


PROJECT NO. 202011039 FILENAME 2020110039-PH1-RW1 CHECKED BY

DRAWN BY 1"=40' SCALE DATE 08.01.2023

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PRELIMINARY DRAWING - NOT RELEASED FOR CONSTRUCTION

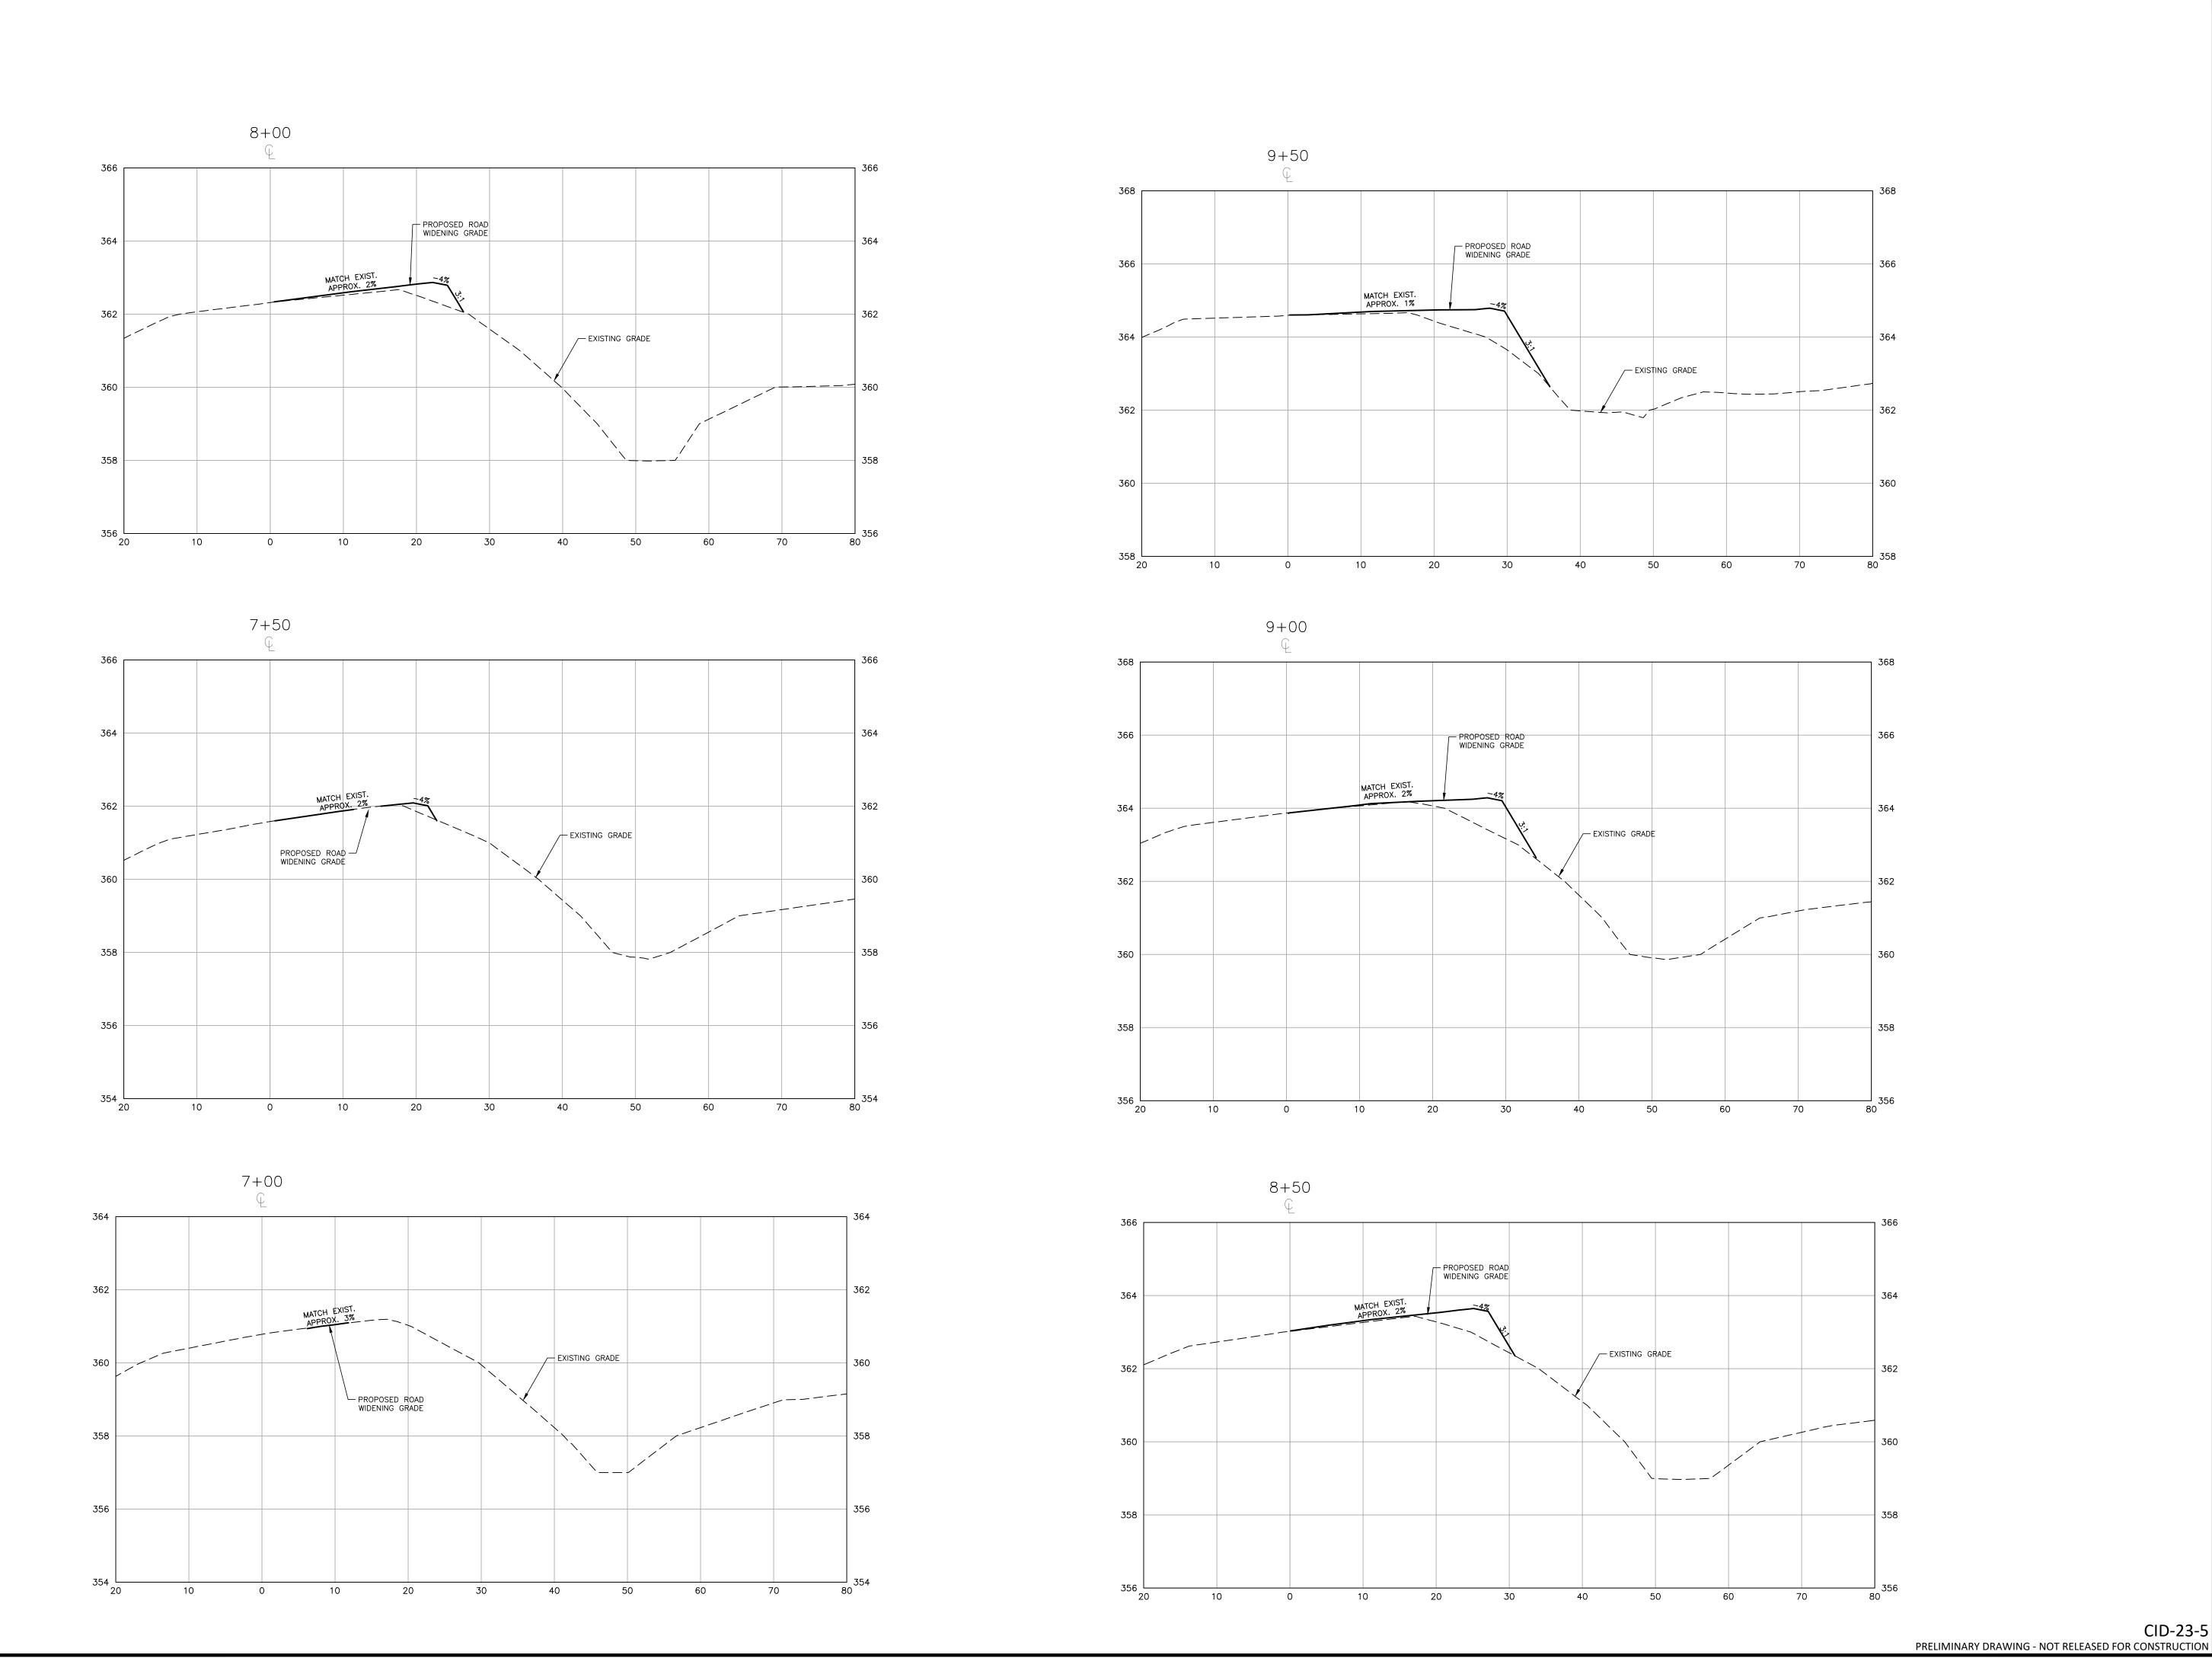LOUISBURG RD WIDENING PLAN





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FRAZIER FARM PARK CONSTRUCTION DRAWINGS



NEVISION.

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PLAN INFORMATION

PROJECT NO. 202011039

FILENAME 2020110039-PH1-RW2

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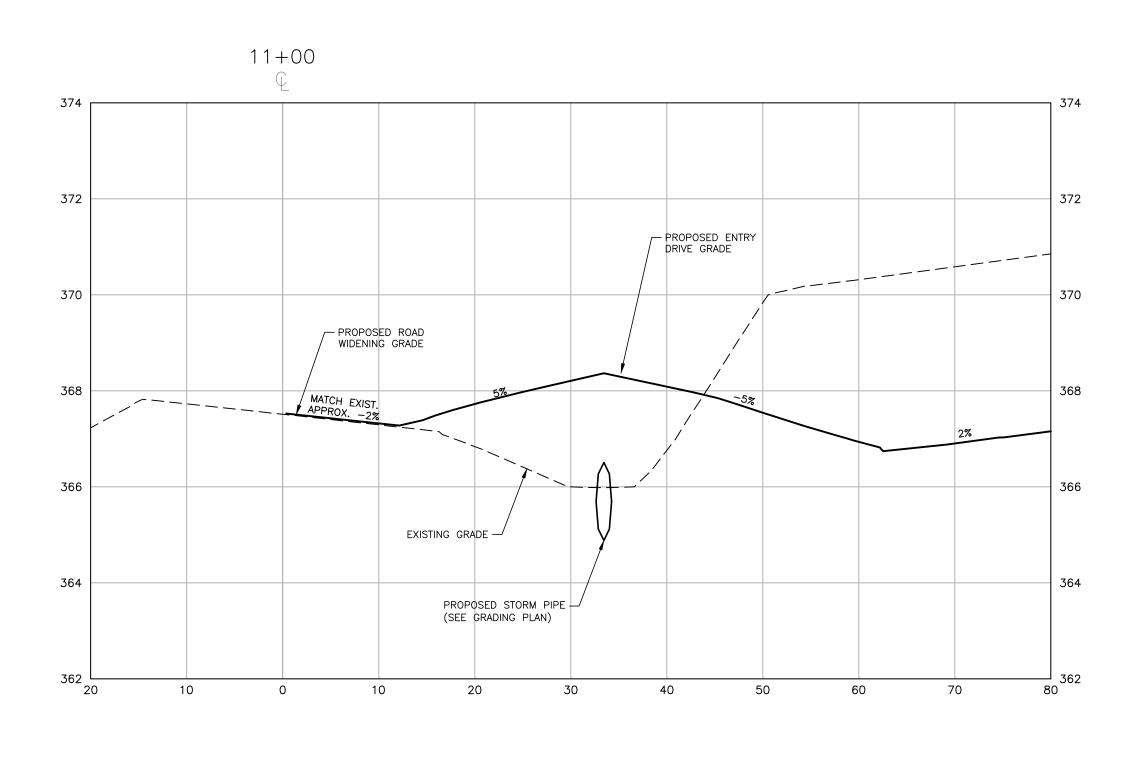
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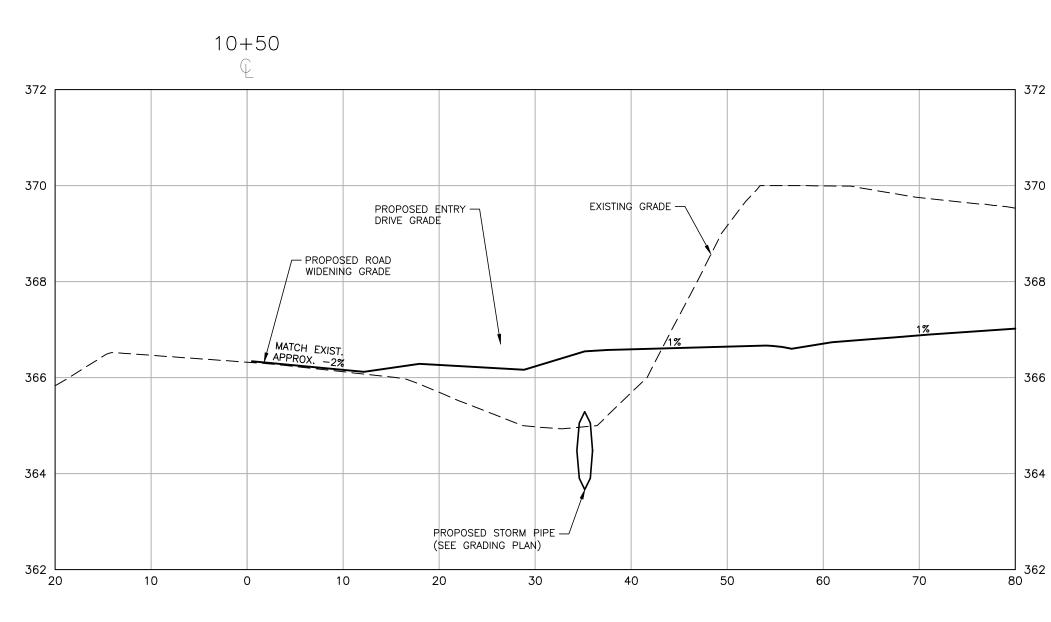
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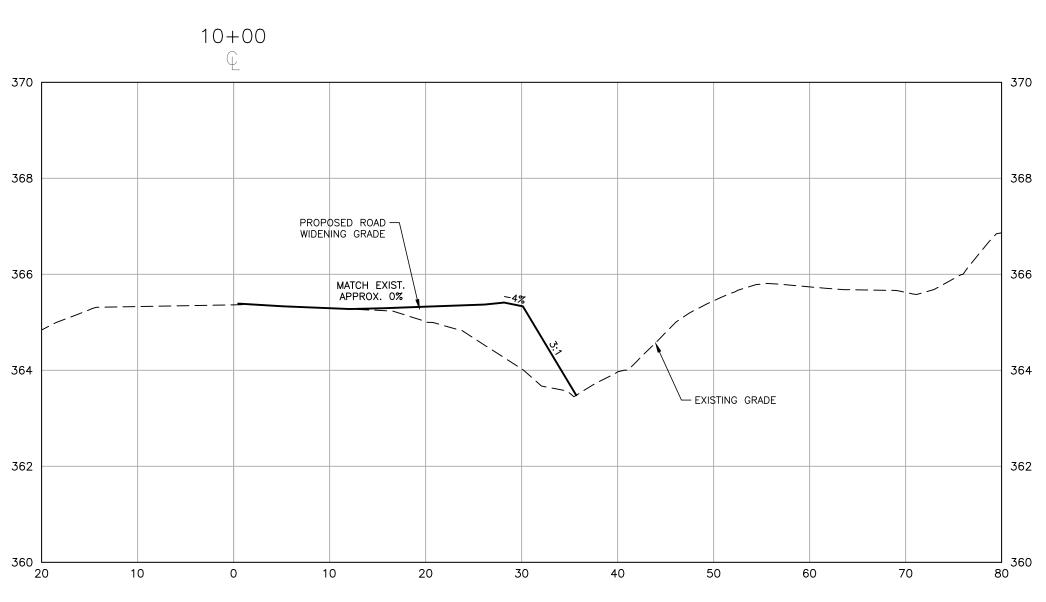
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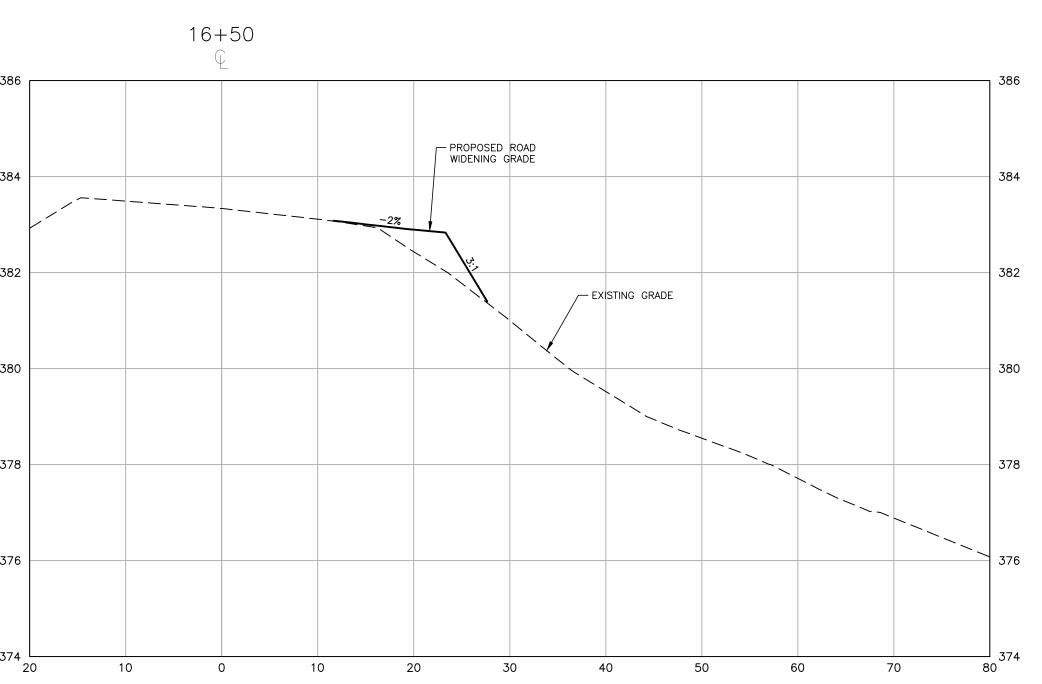
LOUISBURG RD
WIDENING
CROSS SECTIONS

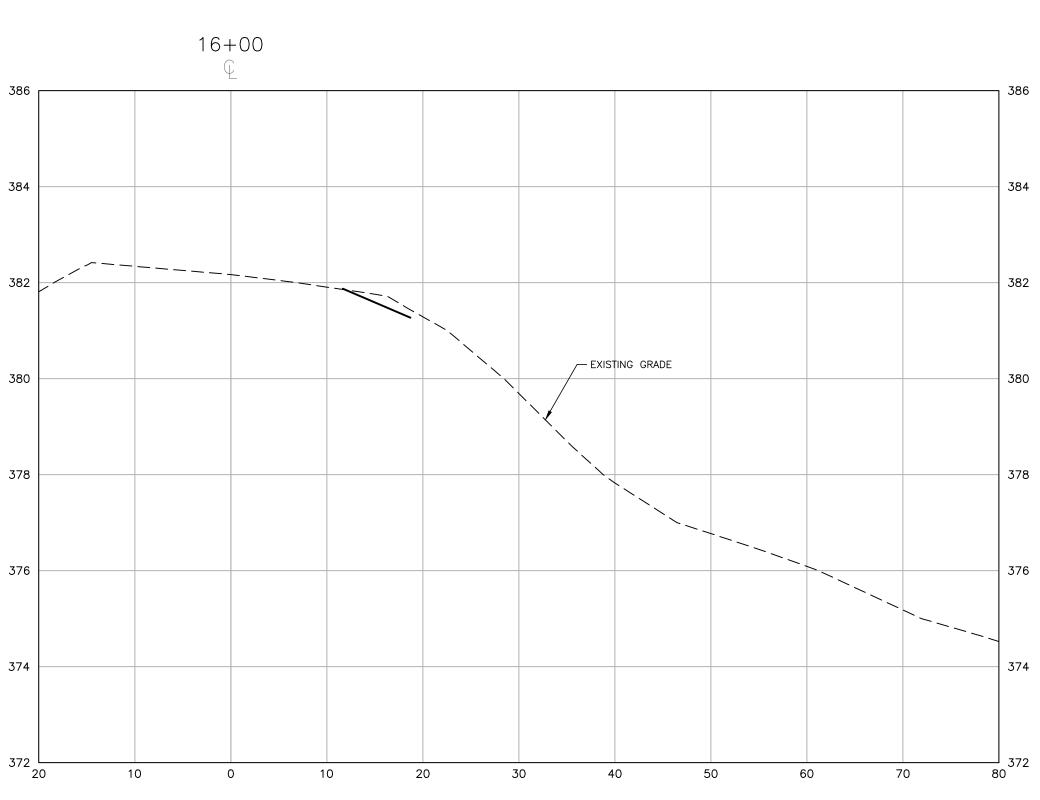
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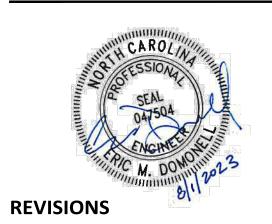
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NO. DATE


PLAN INFORMATION

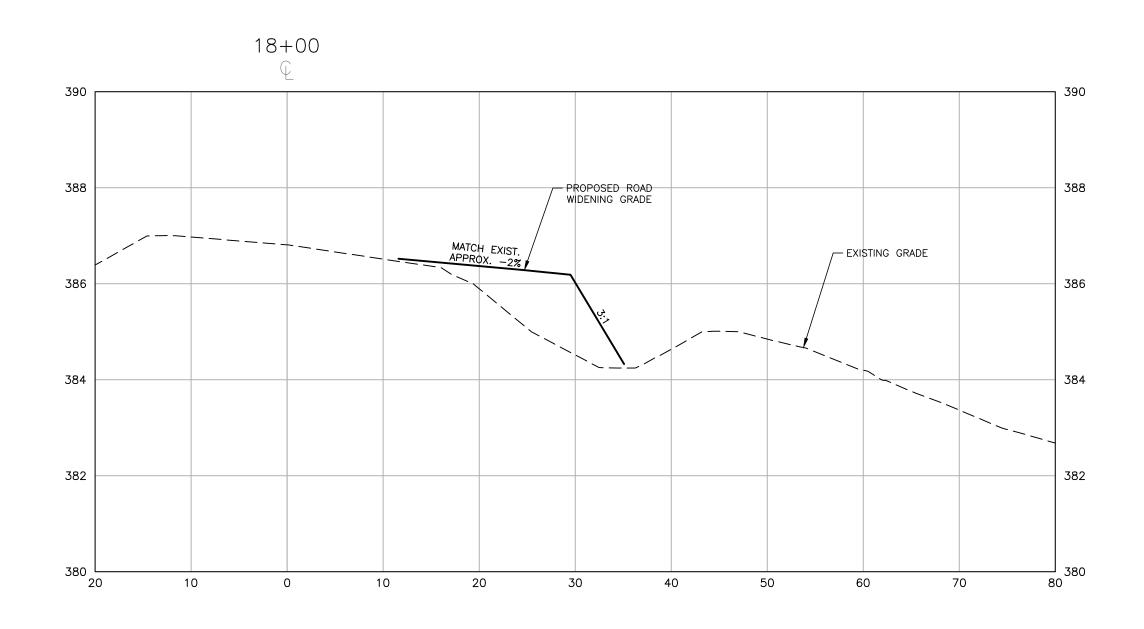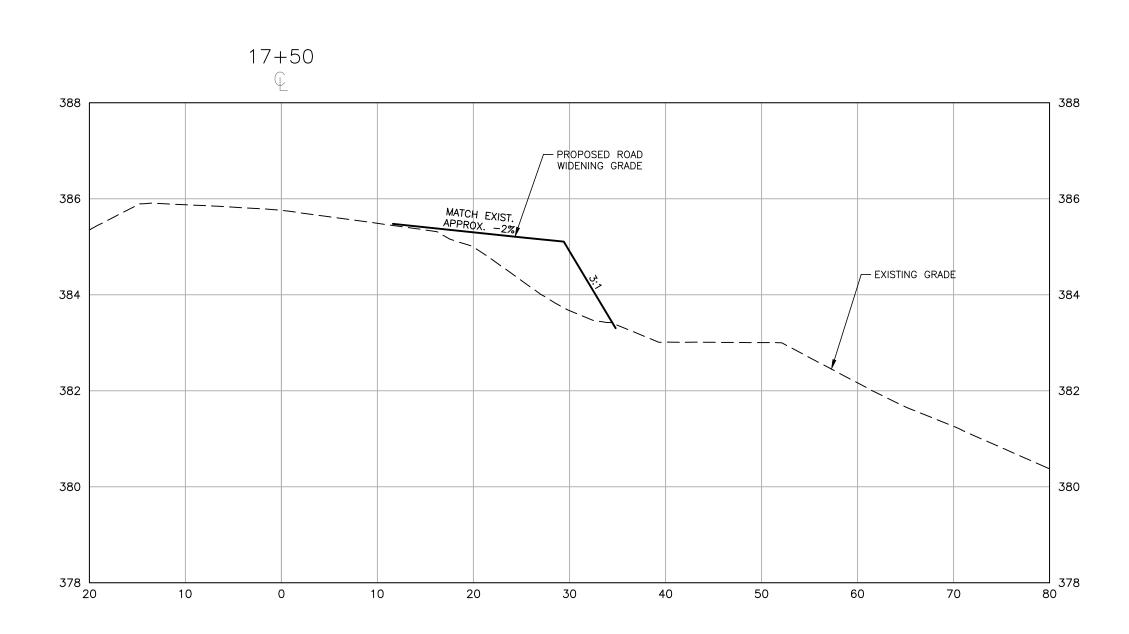
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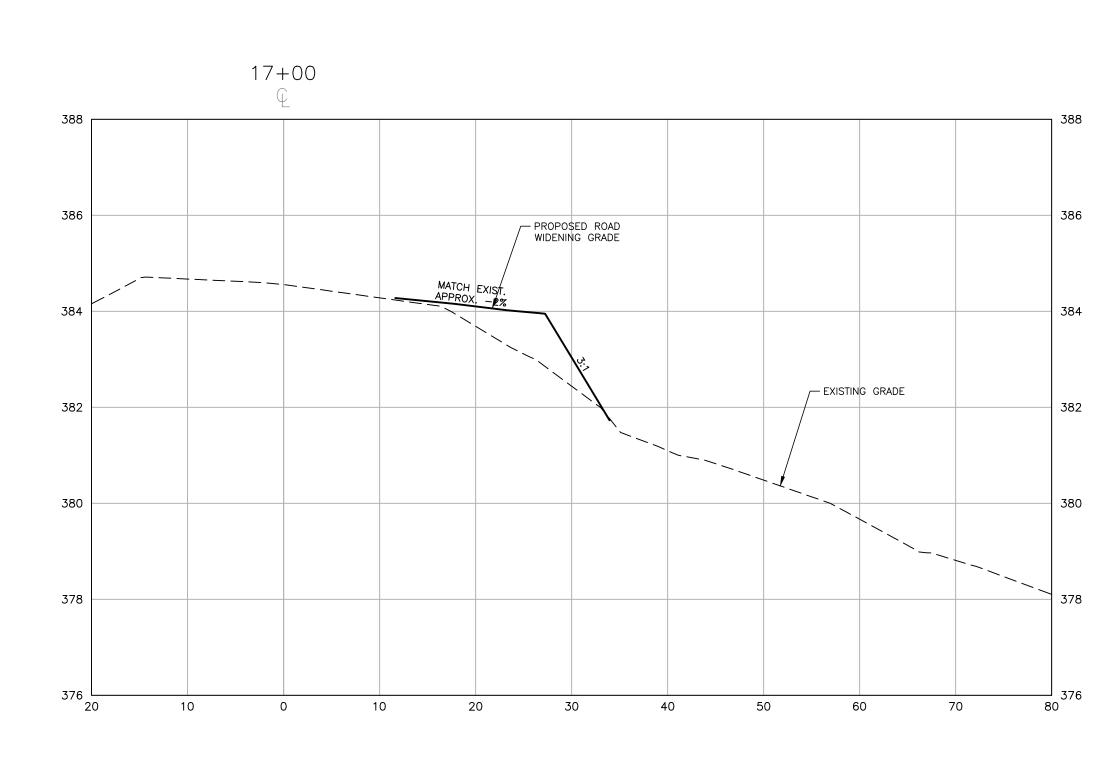
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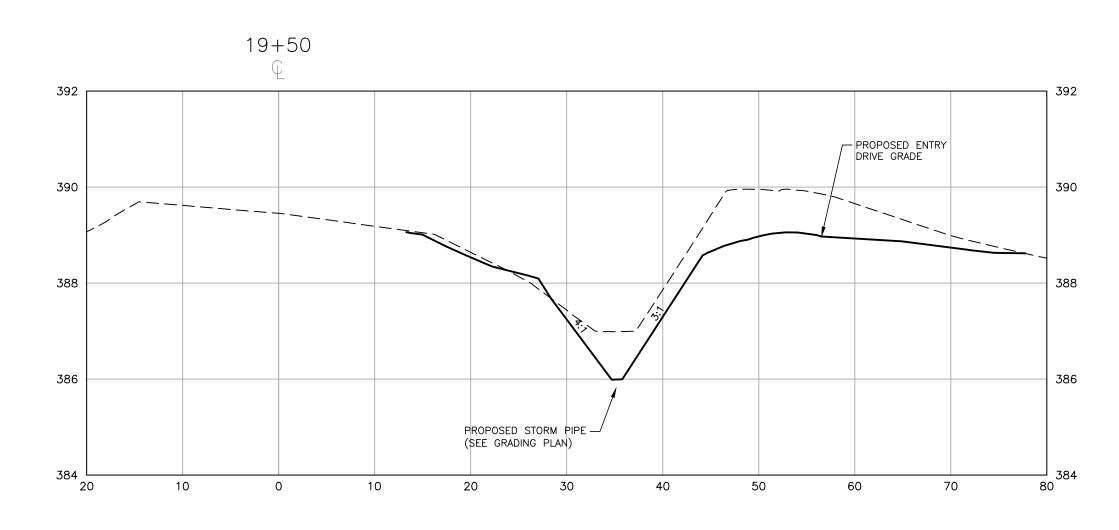
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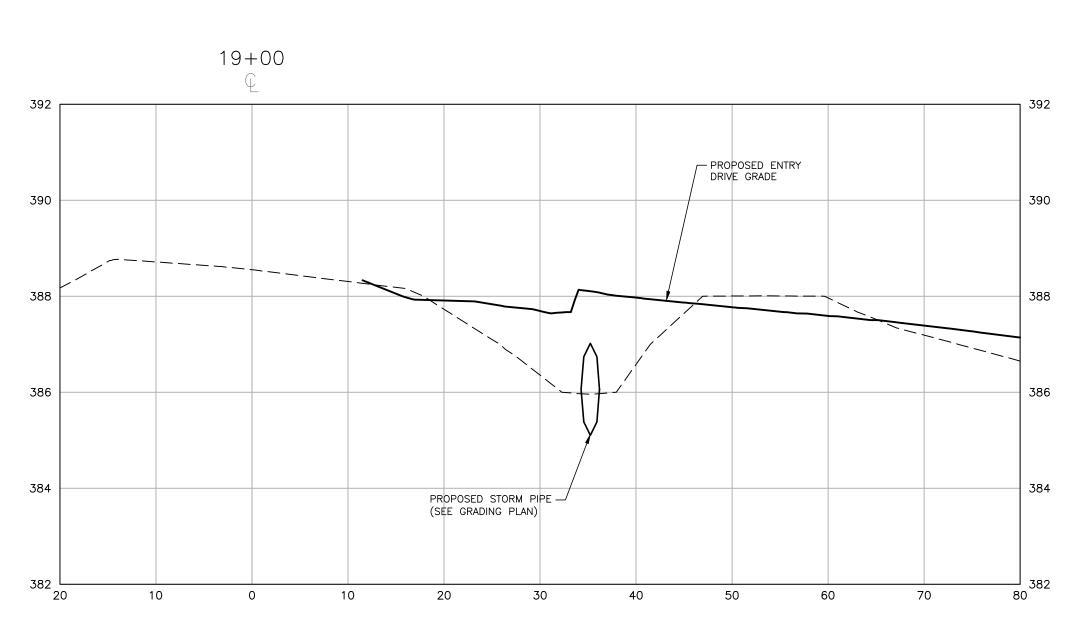
LOUISBURG RD WIDENING **CROSS SECTIONS**

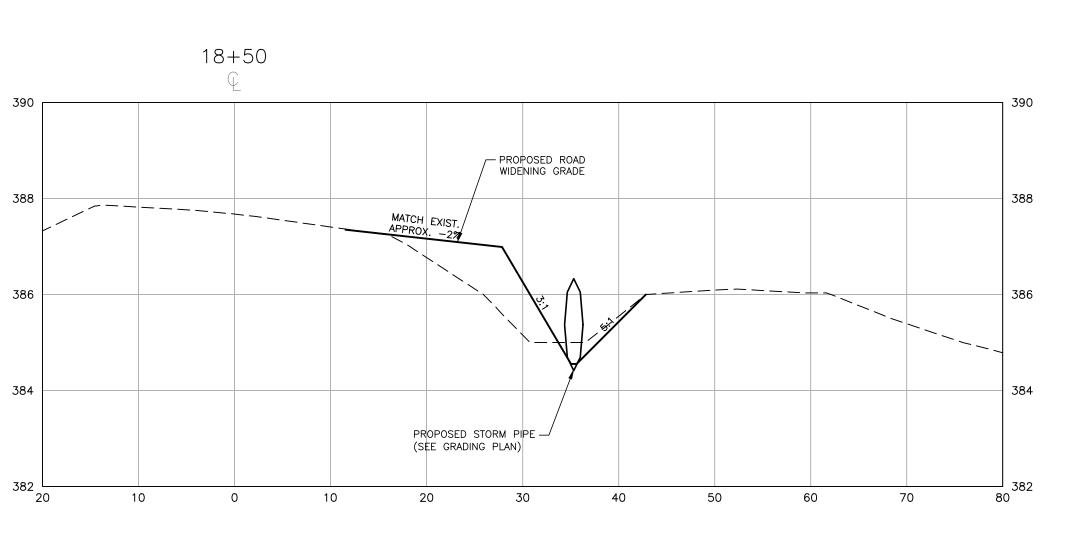












CID-23-5
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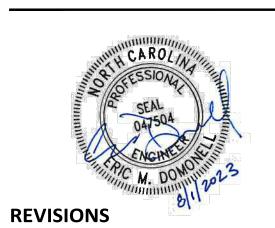
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ADDRESS: ROLESVILLE NC 27571
PHONE: 919.554.6582

RAZIER FARM PARK CONSTRUCTION DRAWINGS



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NO. DATE

PLAN INFORMATION

PROJECT NO. 202011039
FILENAME 2020110039-PH1-RW2


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DRAWN BY SME

SCALE H:1"=10' / V:1"=2'
DATE 08.01.2023


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LOUISBURG RD
WIDENING
CROSS SECTIONS

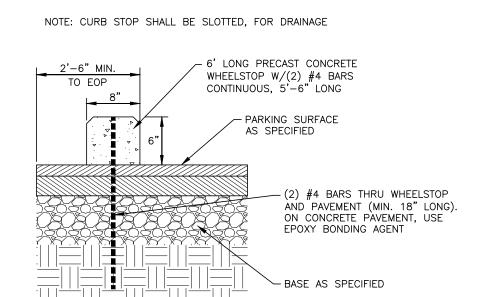C7.03




____3" ASPHALT SURFACE COURSE (S-9.5C) -4" ASPHALT SURFACE COURSE (I-19.0C) - 10" MIN. AGGREGATE BASE COURSE - COMPACTED SUBGRADE SEE SPECIFICATIONS FOR REQUIRED MATERIALS SUBGRADE COMPACTED TO A MINIMUM 98% STANDARD PROCTOR MAXIMUM DRY DENSITY (ASTM D 698) REFER TO SOILS REPORT IF AVAILABLE. THE PAVEMENT SECTIONS SHOWN ARE PRELIMINARY. THE CONTRACTOR SHALL VERIFY PAVEMENT DESIGN WITH NCDOT AND A GEOTECHNICAL ENGINEER PRIOR TO PROCEEDING WITH CONSTRUCTION. ROAD WIDENING PAVEMENT DETAIL

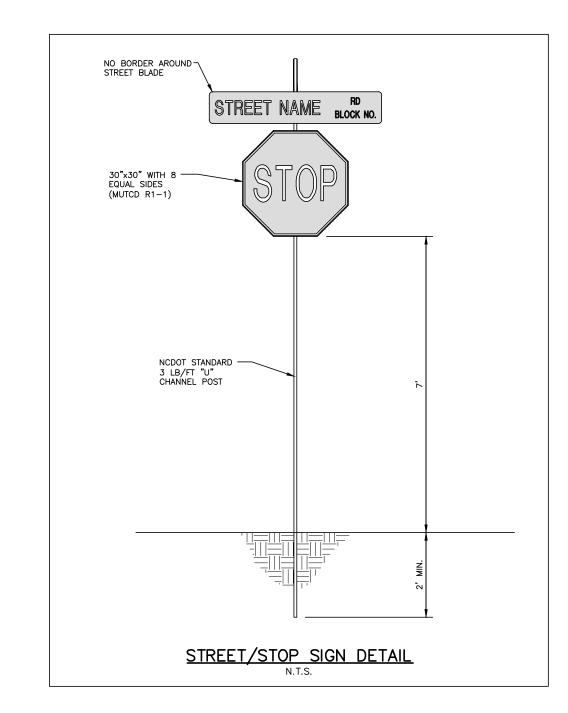


O1 CONCRETE WHEEL STOP

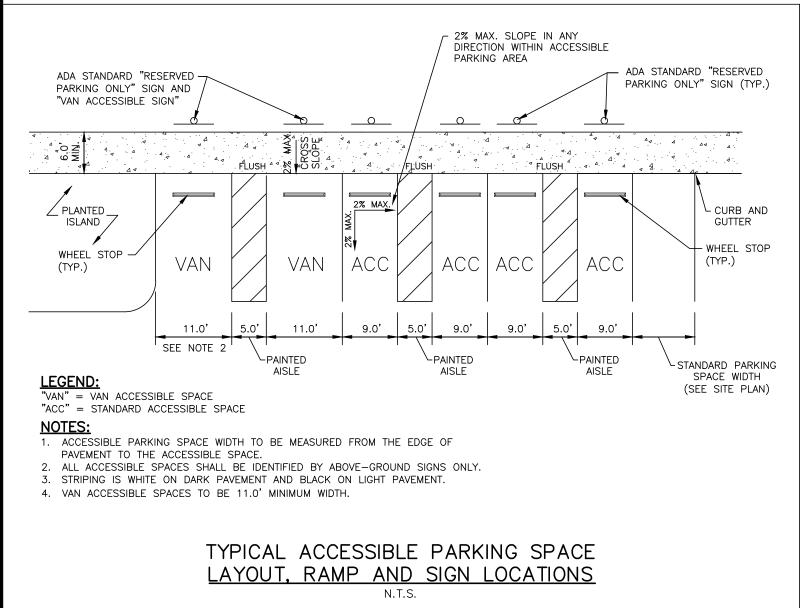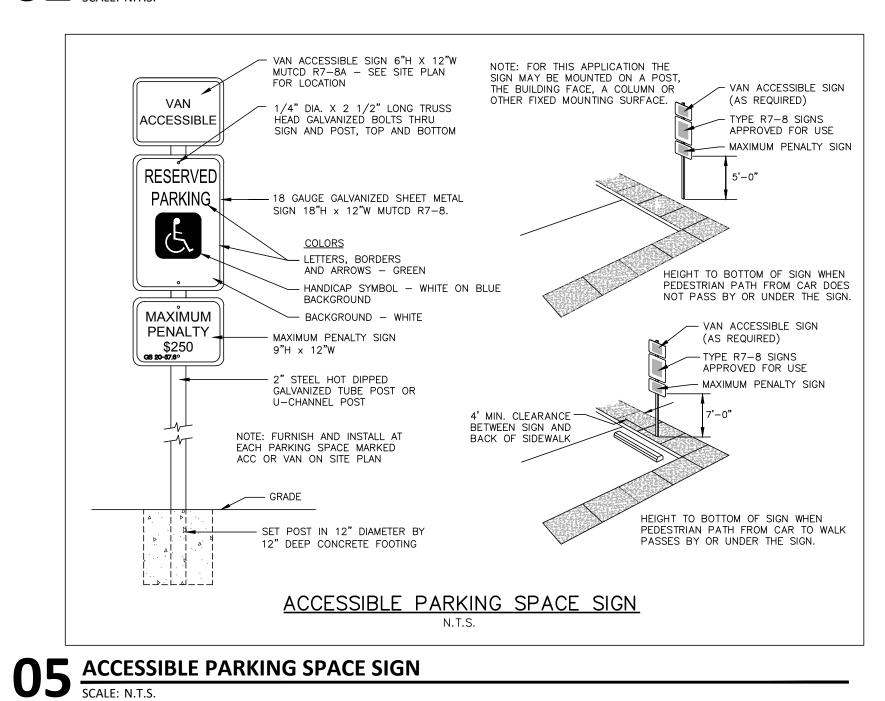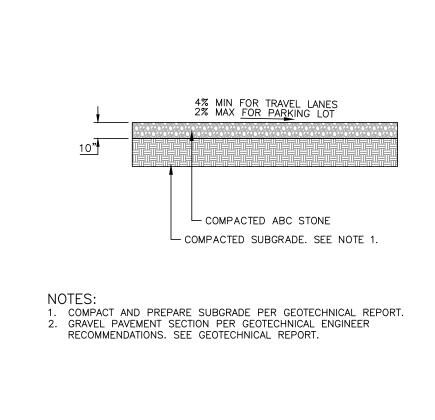
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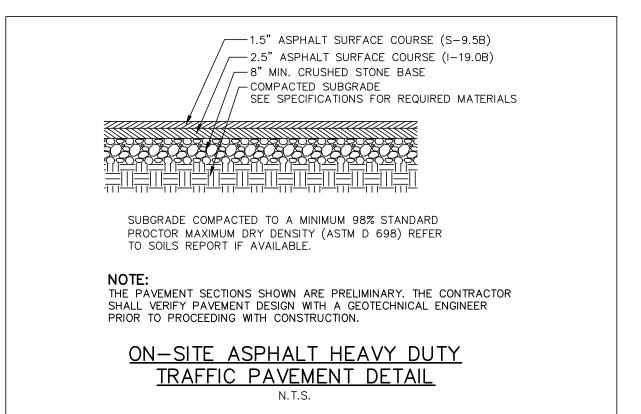
02 US-401 PAVEMENT SECTION SCALE: N.T.S.



3 STOP AND STREET SIGN DETAIL SCALE: N.T.S.



O7 ON-SITE HEAVY-DUTY ASPHALT PAVEMENT DETAIL SCALE: N.T.S.



- 6" 4,000 PSI AIR ENTRAINED CONCRETE 6.0" NCDOT ABC COMPACTED SUBGRADE SEE SPECIFICATIONS FOR REQUIRED MATERIALS. SUBGRADE COMPACTED TO A MINIMUM 98% STANDARD

PROCTOR MAXIMUM DRY DENSITY (ASTM D 698) REFER

TO S&ME GEOTECHNICAL EXPLORATION REPORT PROJECT

12' GRAVEL TRAVEL LANE 12' GRAVEL TRAVEL LANE 4.0% 4.0% TYPICAL GRAVEL SECTION STREET "A" AND "B"

06 GRAVEL DRIVE AND PARKING LOT SCALE: N.T.S.



PLAN INFORMATION

PROJECT NO. 202011039 2020110039-PH1-D1 FILENAME CHECKED BY DRAWN BY

N/A SCALE DATE 08.01.2023

08 ON-SITE HEAVY-DUTY CONCRETE PAVEMENT DETAIL SCALE: N.T.S.

22050659 DATED 12-23-2022.

PRELIMINARY DRAWING - NOT RELEASED FOR CONSTRUCTION

O4 ACCESSIBLE PARKING AND STRIPING DETAIL SCALE: N.T.S.

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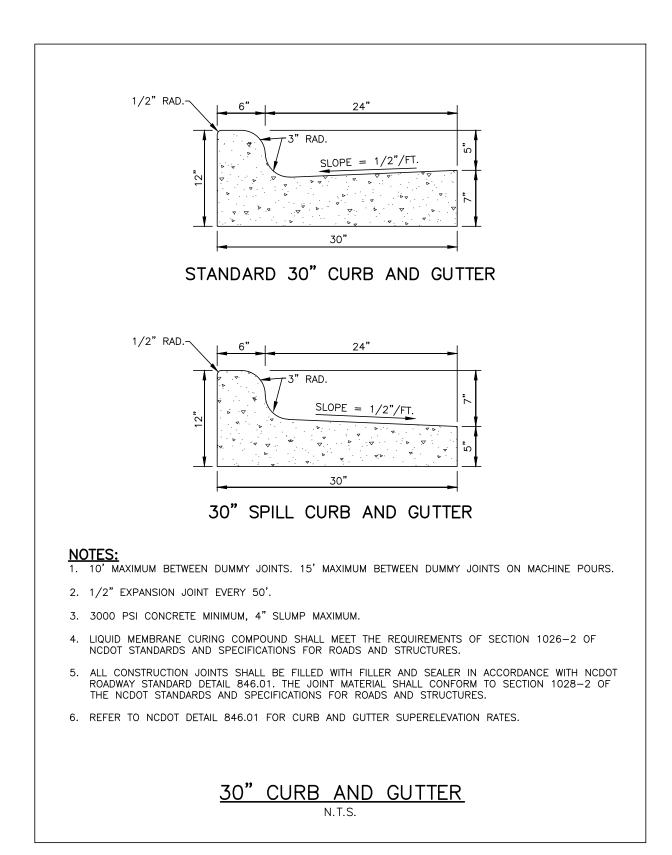
RM PARK N DRAWINGS

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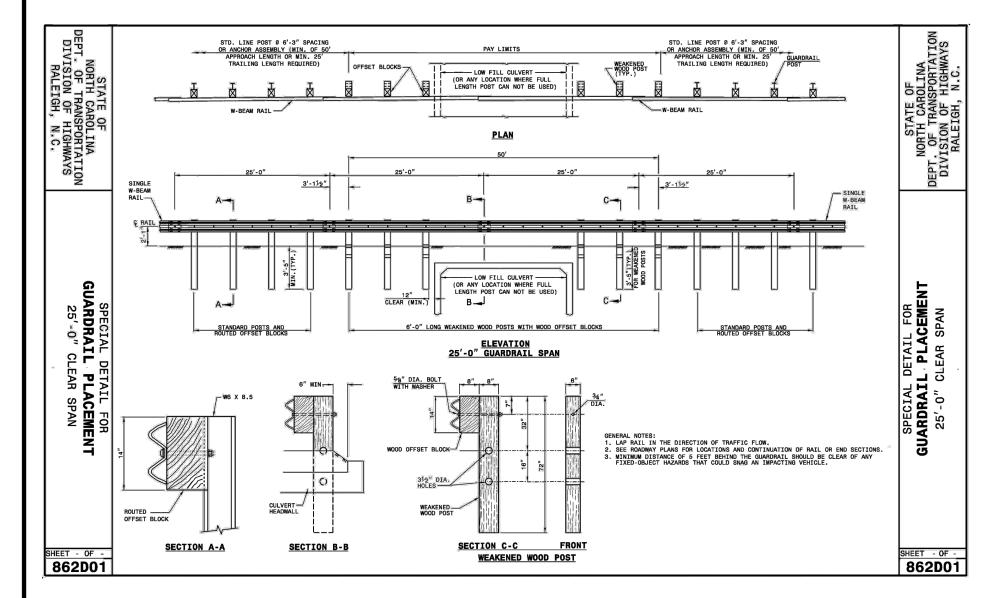
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SITE DETAILS



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12 NCDOT GUARDRAIL
SCALE: N.T.S.

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SCALE: N.T.S.



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FRAZIER FARM PARK CONSTRUCTION DRAWINGS



NO. DATE

PLAN INFORMATION

PROJECT NO. 202011039


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DATE 08.01.2
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SITE DETAILS
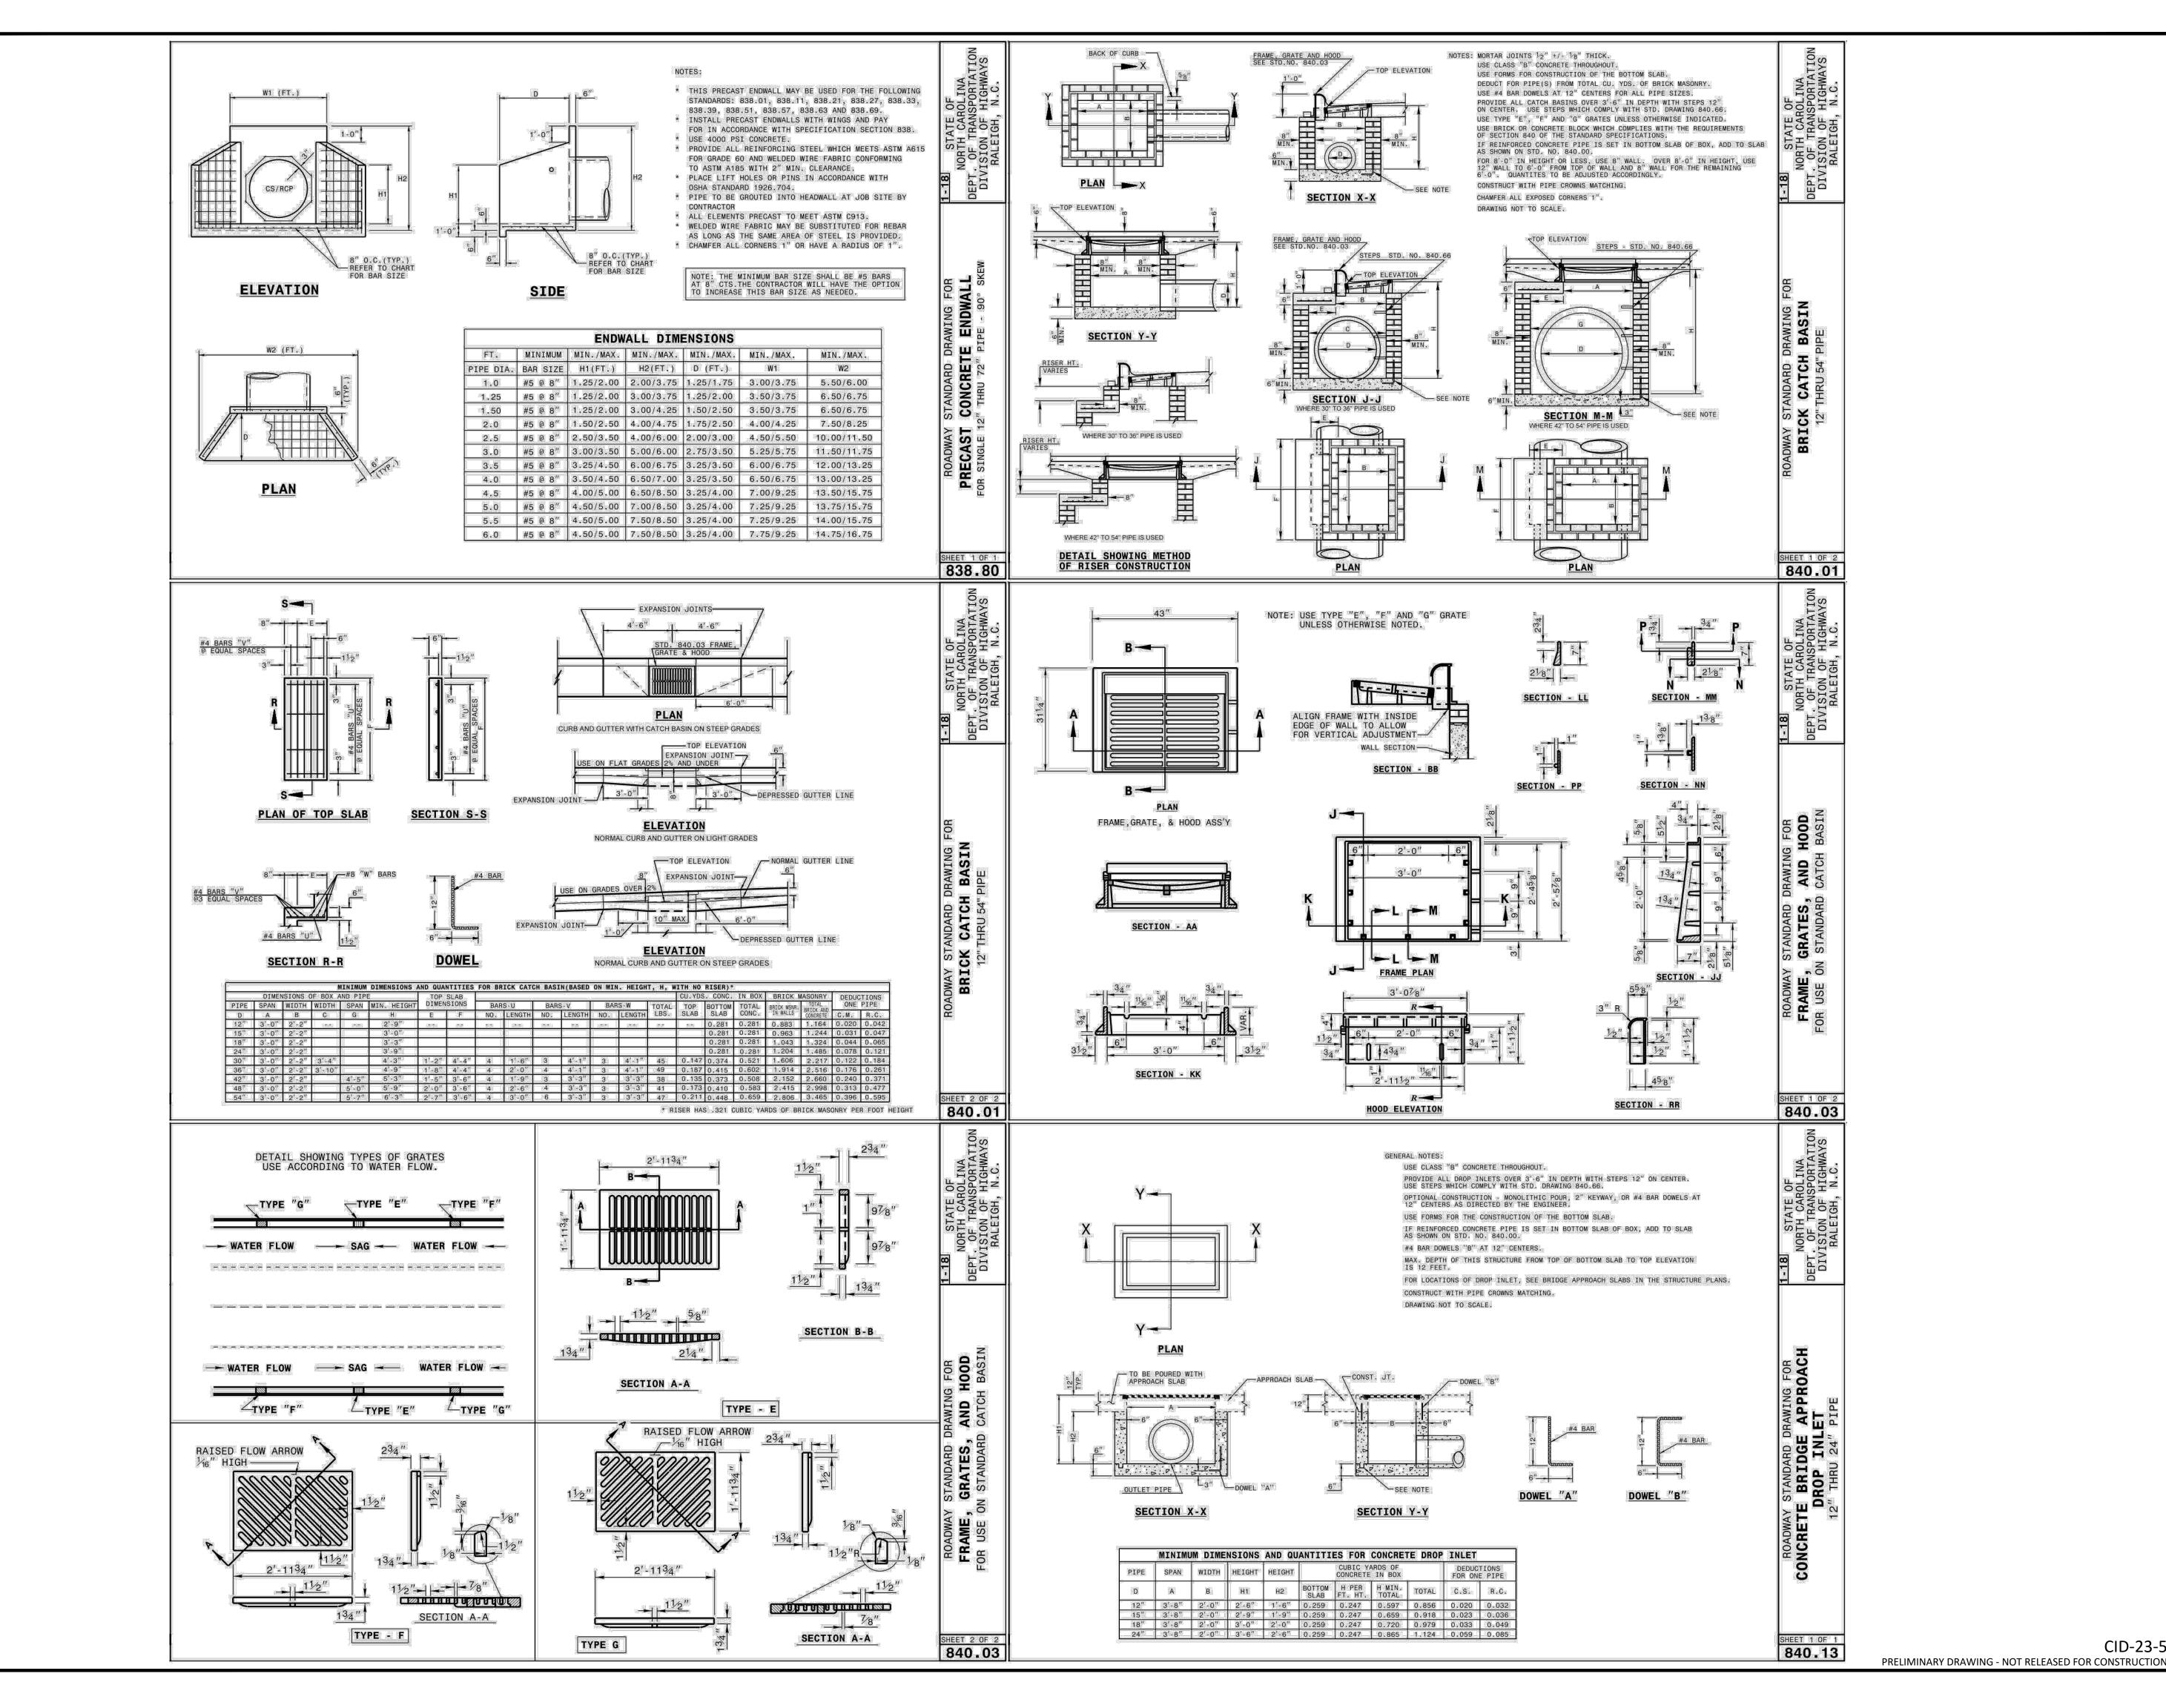
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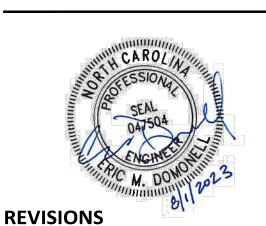
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NO. DATE

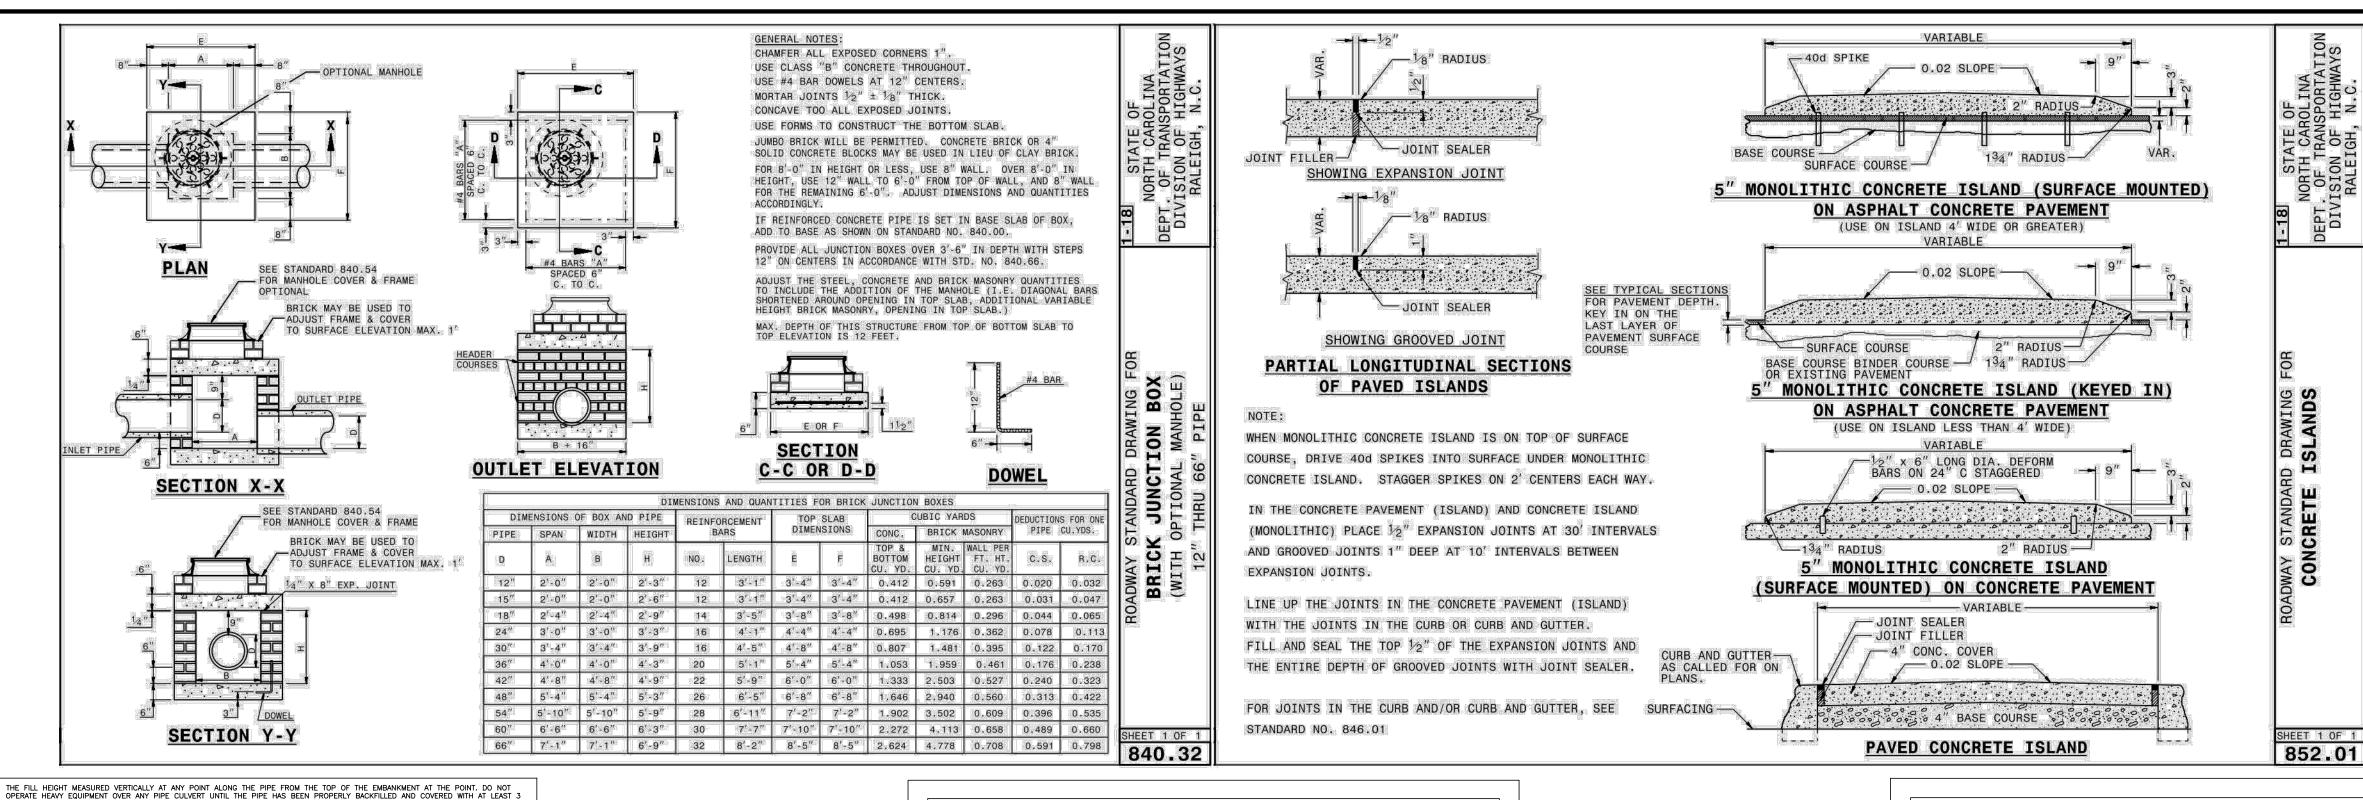
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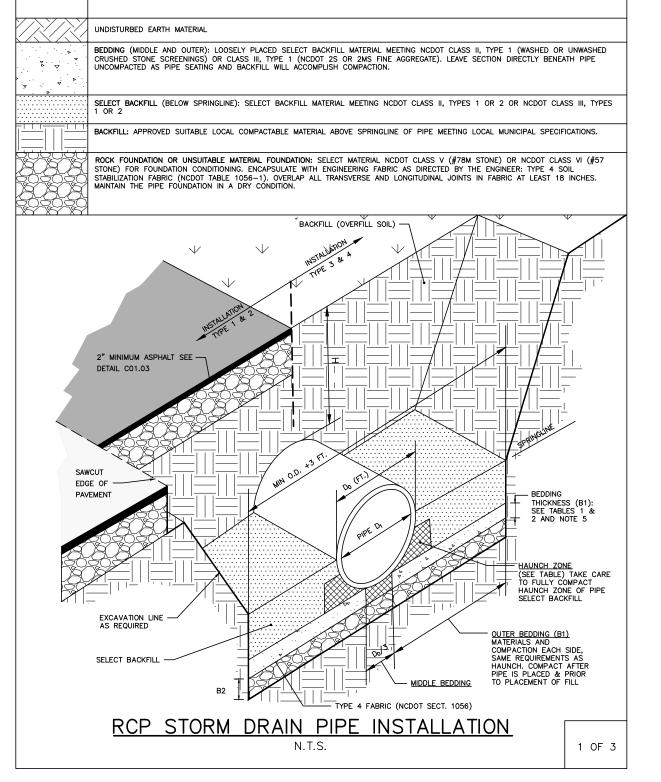
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STORM DRAINAGE & UTILITY DETAILS





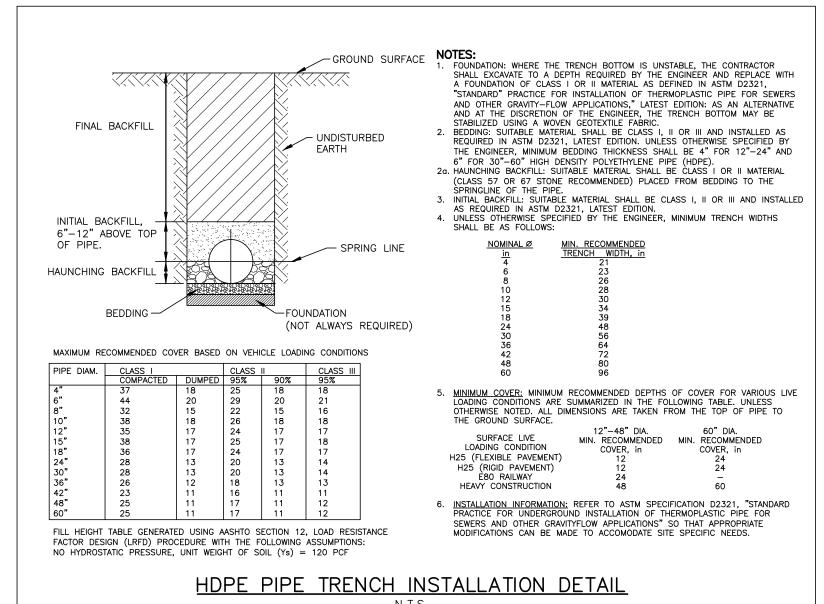


TABLE 1 EQUIVALENT USCS AND AASHTO SOIL CLASSIFICATION FOR SIDD SOIL DESIGNATIONS			
SIDD USCS		NCDOT/AASHTO	
GRAVELLY SAND (CATEGORY I)	SW, SP, GW, GP	-NCDOT CLASS II-TYPE I (CRUSHED STONE SCREEENINGS), LL<30; PI≤6 -NCDOT CLASS III, TYPE I (2S OR 2MS), LL<30; PI≤6	
SANDY SILT (CATEGORY II)	GM, SM, ALSO GC, SC WITH LESS THAN 20% PASSING #200 SIEVE	-NCDOT CLASS II TYPE I (CRUSHED STONE SCREENINGS) AND CLASS II, TYPE 2 (AASHTO M145 FOR A-2-4 WITH MAX PI OF 6, A-4 W/ MAX 45% PASSING #200 SIEVE AND A MAX PI OF 6) -NCDOT CLASS III, TYPE 1 (2S OR 2MS) OR CLASS III, TYPE 2 (AASHTO M145 FOR SOIL CLASSIFICATION A-1 OR A-3)	
SILTY CLAY CATEGORY III)	CL, MH, GC, SC	A5, A6	

TABLE 2 STANDARD INSTALLATIONS SOILS AND MINIMUM COMPACTION REQUIREMENTS				
INSTALLATION TYPE	BEDDING THICKNESS	OUTER BEDDING (B1) NOTE 5 (% COMPACTION/CATEGORY)	HAUNCH ZONE & SELECT BACKFILL AREA (% COMPACTION/CATEGORY)	LOCATION
TYPE 1	B1 = Di/6 (6" MIN) B2=IF ROCK FOUNDATION OR OVER UNSUITABLE FOUNDATION, ½" /FT OF 'H', 12" MIN/24" MAX	95% CATEGORY 1	90% CATEGORY 1 95% CATEGORY II	PAVED AREAS WITH 2' OR LESS BURY
TYPE 2	B1 = Di/6 (6" MIN) B2=IF ROCK FOUNDATION OR OVER UNSUITABLE FOUNDATION, ½" /FT OF 'H', 12" MIN/24" MAX	90% CATEGORY 1	85% CATEGORY 1 90% CATEGORY II	PAVED AREAS WITH GREATER THAN 2' OF BURY
TYPE 3	B1 = Di/6 (6" MIN) B2=IF ROCK FOUNDATION OR OVER UNSUITABLE FOUNDATION, ½" /FT OF 'H', 12" MIN/24" MAX	85% CATEGORY 1 90% CATEGORY II	85% CATEGORY 1 90% CATEGORY II OR 95% CATEGORY III	IN R/W OUTSIDE OF PAVEMENT
TYPE 4	B1 = Di/6 (6" MIN) B2=IF ROCK FOUNDATION OR OVER UNSUITABLE FOUNDATION, ½" /FT OF 'H', 12" MIN/24" MAX	NO COMPACTION REQUIRED, EXCEPT IF CATEGORY III, USE 85% CATEGORY III	NO COMPACTION REQUIRED, EXCEPT IF CATEGORY III, USE 85% CATEGORY III	NATURAL AREAS

1. COMPACTION AND SOIL SYMBOLS - I.E. "95% CATEGORY I" - REFERS TO CATEGORY I SOIL MATERIAL WITH MINIMUM STANDARD PROCTOR COMPACTION OF 95%. 2. SOIL IN THE OUTER BEDDING, HAUNCH, AND LOWER SIDE ZONES, EXCEPT UNDER THE MIDDLE \$ OF THE PIPE, SHALL BE COMPACTED TO AT LEAST THE SAME COMPACTION AS THE MAJORITY OF THE SOIL IN THE OVERFILL (BACKFILL) ZONE.
3. FOR TRENCHES. THE TOP ELEVATION SHALL BE NO LOWER THAN 0.1H BELOW FINISHED GRADE OR, FOR ROADWAYS, ITS TOP SHALL BE NO LOWER THAN AN ELEVATION OF 1-FOOT BELOW THE BOTTOM OF THE ROADWAYS, ITS TOP SHALL BE NO LONG. THAT THE PAVEMENT BASE MATERIAL.

4. FOR TRENCHES, THE WIDTH SHALL BE WIDER THAN SHOWN IF REQUIRED FOR ADEQUATE SPACE TO ATTAIN THE SPECIFIED COMPACTION IN THE HAUNCH AND BEDDING ZONES.

5. COMPACT OUTER BEDDING AFTER PIPE IS PLACED AND PRIOR TO PLACEMENT OF SELECT FILL. MIDDLE 6. OVERFILL (BACKFILL) SOILS TO BE PLACED PER STANDARD SPECIFICATION 02700 STORM DRAINAGE FOR THE APPLICABLE BACKFILL TYPE AND BURY LIMITATIONS.

THESE TWO TABLES WERE MODIFIED TO GENERALLY CONFORM TO THE NCDOT STANDARDS AS SHOWN IN DETAIL 300.01 RIGID PIPE IN TRENCH CONDITION.

REFERENCE SOURCES: 1. AMERICAN CONCRETE PIPE ASSOCIATION DESIGN STANDARDS
2. 2012 NCDOT STANDARD SPECIFICATIONS FOR ROADS AND STRUCTURES AND NCDOT STANDARD DETAILS 300.01 FOR RIGID PIPE, TRENCH CONDITIONS."

STORM DRAIN PIPE INSTALLATION

2 OF 3

FILL HEIGHT TABLE				
	TYPE 3 (BEDDING) INSTALLATION (0.01 INCH CRACK)		TYPE 4 (BEDDING) INSTALLATION (0.01 INCH CRACK)	
INSIDE PIPE DIAMETER DI (INCHES)	CLASS III PIPE MAXIMUM BURY H (FEET)	CLASS IV PIPE MAXIMUM BURY H (FEET)	CLASS III PIPE MAXIMUM BURY H (FEET)	CLASS IV PIPE MAXIMUM BURY H (FEET)
15	2 MIN, 12 MAX	1 MIN, 20 MAX	3 MIN, 7 MAX	2 MIN, 12 MAX
18	2 MIN, 12 MAX	1 MIN, 20 MAX	3 MIN, 7 MAX	1 MIN, 13 MAX
24	1 MIN, 12 MAX	1 MIN, 20 MAX	2 MIN, 8 MAX	1 MIN, 13 MAX
30	1 MIN, 12 MAX	1 MIN, 20 MAX	1 MIN, 8 MAX	1 MIN, 13 MAX
36	1 MIN, 12 MAX	1 MIN, 20 MAX	1 MIN, 8 MAX	1 MIN, 13 MAX
42	1 MIN, 12 MAX	1 MIN, 20 MAX	1 MIN, 8 MAX	1 MIN, 13 MAX
48	1 MIN, 12 MAX	1 MIN, 19 MAX	1 MIN, 8 MAX	1 MIN, 13 MAX
54	1 MIN, 12 MAX	1 MIN, 19 MAX	1 MIN, 8 MAX	1 MIN, 13 MAX
60	1 MIN, 12 MAX	1 MIN, 19 MAX	1 MIN, 8 MAX	1 MIN, 13 MAX
72	1 MIN, 11 MAX	1 MIN, 19 MAX	1 MIN, 7 MAX	1 MIN, 13 MAX

FILL HEIGHT TABLE BASE ON: 1. $Y_S = 120 PCF (BACKFILL LOAD)$

- 3. POSITIVE PROJECTING EMBANKMENT CONDITION (THIS GIVES CONSERVATIVE RESULTS IN COMPARISON TO
- 4. PIPE = REINFORCED CONCRETE PIPE MEETING ASTM C76 (AASHTO M170), WALL C THICKNESS 5. CONCRETE PIPE SHOULD BE INSTALLED IN ACCORDANCE WITH AASHTO LRFD BRIDGE CONSTRUCTION SPECIFICATIONS SECTION 27 OR ASTM C1479.

9 FILL HEIGHT TABLES, THE PORTION EXCERPTED HERE. WAS DEVELOPED BY THE AMERICAN CONCRETE PIPE ASSOCIATION (ACPA) USING THE INDIRECT DESIGN METHOD IN ACCORDANCE WITH SECTION 12.10.4.3 OF THE AASHTO LRFD BRIDGE DESIGN SPECIFICATION, 4TH, 2007 WITH 2008 INTERIM.

1. GREATER BURY DEPTHS THAN THOSE SHOWN ABOVE ARE ACHIEVABLE BY EITHER USING TYPE 1 OR 2 INSTALLATION, USING CLASS V PIPE, CONTROLLING BACKFILL TYPE, CALCULATING DEPTH USING A TRENCH CONDITION, OR BY SPECIAL DESIGN. SEE ALSO DESIGN DATA 9 PUBLISHED BY THE ACPA FOR DESIGN METHODOLOGY. 2. IN LIEU OF CALCULATING BURY DEPTH FOR OTHER CONDITIONS, FIRST SEE "LRFD FILL HEIGHT TABLES FOR CONCRETE PIPE", LAST REVISED JULY 2009 OR LATER), PREPARED BY THE ACPA FOR OTHER BURY DEPTH

STORM DRAIN PIPE INSTALLATION

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SHEET STORM DRAINAGE &

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3 OF 3