### V1 - SDP-23-09

TOTAL SITE AREA:

EXISTING ZONING:

PROPERTY SETBACKS:

**BUFFERS:** 

WATERSHED:

RIVER BASIN:

PARKING:

CURRENT USE:

PROPOSED USE:

CURRENT IMPERVIOUS:

ACCESSIBLE PARKING:

TREE COVERAGE DATA:

BUILDING SQUARE FOOTAGE: 700 SF (APPROX.)

BICYCLE PARKING:

BUILDING HEIGHT:

PROPOSED IMPERVIOUS:

SITE DATA TABLE

1759806076

10' LANDSCAPE

SANFORD CREEK

FRONT: 20'

REAR: 35'

NEUSE

GENERAL COMMERCIAL (GC)

0.70 AC

### SCOOTER'S ROLESVILLE


302 SOUTH MAIN STREET ROLESVILLE, NC 27571

A DEVELOPMENT BY: S&S JAVA ENTERPRISES

PROJECT NO.: SDPXX-XX

SCALE: 1" = 500'

VACANT		de Storm Dra	
COMMERCIAL	storm a	s well pre/po	)St L
143 SF			
18,525 SF			
MIN. REQUIRED: (2.5 SPACES/1,000 SF)  \[ \frac{X}{700} \frac{SF}{} = 2  \text{SPACES} \]			
MAX. ALLOWED: (10 SPACES/1,000 SF)  X 700 SF  = 7 SPACES	40)	70	
PROVIDED: 8 SPACES			1
REQUIRED: 1 SPACE PROVIDED: 1 SPACE	MORRISVILLE		人
MIN. REQUIRED: (1 SPACE/5,000 SF)  X 700 SF  = 1 SPACES		CARY 40	
PROVIDED: 2 SPACES	APEX		/
SEE SHEET L1.0	1		
19'	$\exists \gamma$	24	01
700 SF (APPROX.)	HOLLY SPRINGS		
	РΓ		$\cap$

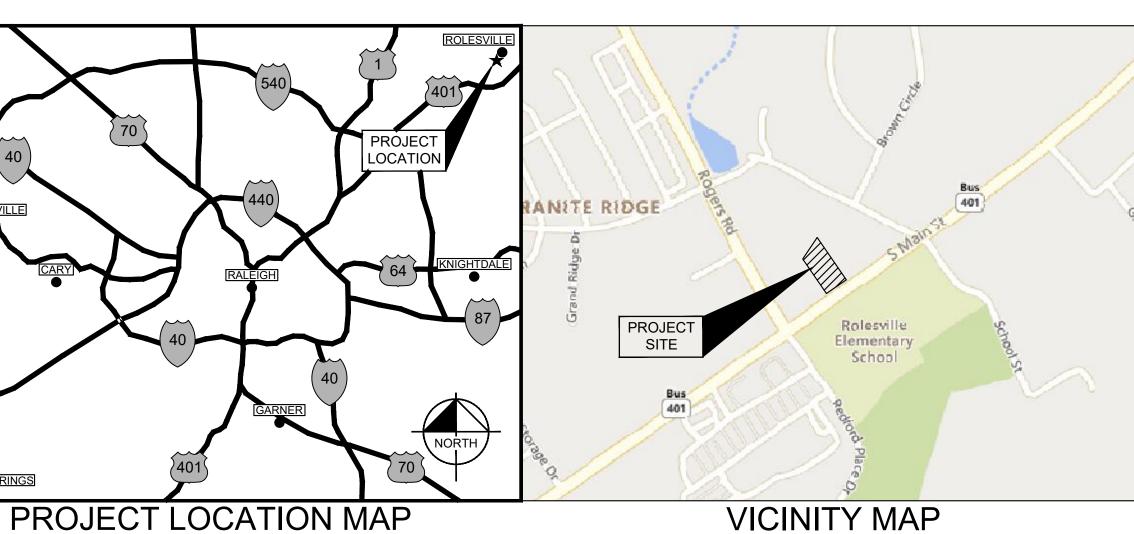

### PROJECT OWNERS & CONSULTANTS

### OWNER

ROLESVILLE, LLC 11016 RUSHMORE DRIVE, SUITE 160 CHARLOTTE, NORTH CAROLINA 28277 CONTACT: MARLANE KLINTWORTH PHONE: (919) 868-4472 EMAIL: mvkcommercial@gmail.com

SCALE: NOT TO SCALE

DEVELOPER S&S JAVA ENTERPRISES - ROLESVILLE, LLC

13 LAFOY DRIVE CLAYTON, NORTH CAROLINA 27527 CONTACT: ROBERT SOUTHERLAND PHONE: (919) 426-7670 EMAIL: b2driver@earthlink.net

**CIVIL ENGINEER** KIMLEY-HORN AND ASSOCIATES, INC. 421 FAYETTEVILLE ST., SUITE 600 RALEIGH, NORTH CAROLINA 27601 CONTACT: CHRIS BOSTIC, P.E. PHONE: (919) 653-2927 EMAIL: chris.bostic@kimley-horn.com

LANDSCAPE ARCHITECT KIMLEY-HORN AND ASSOCIATES, INC 421 FAYETTEVILLE ST., SUITE 600 RALEIGH, NORTH CAROLINA 27601 CONTACT: ADAM FULLERTON, MLA, ASLA PHONE: (919) 653-2937

EMAIL: adam.fullerton@kimley-horn.com

EMAIL: mike@cmppls.com

SURVEYOR CMP PROFESSIONAL LAND SURVEYORS, PC 333 S. WHITE ST WAKE FOREST, NORTH CAROLINA 27587 CONTACT: MICHAEL A. MOSS, PLS PHONE: (919) 556-3148

SURVEY NOTE:  EXISTING TOPOGRAPHICAL INFORMATION IS BASED ON A TOPOGRAPHIC SURVEY OBTAINED ON 02/23/2023 BY CMP PROFESSIONAL LAND SURVEYORS, 333 S. WHITE STREET, WAKE	
FOREST, NC, 27588, PHONE: (919) 556-3148. CONTRACTOR SHALL BE RESPONSIBLE FOR VERIFYING ALL EXISTING INFORMATION, DEPICTED OR NOT, PRIOR TO CONSTRUCTION AND REPORT	EXISTING TOPOGRAPHICAL INFORMATION IS BASED ON A TOPOGRAPHIC SURVEY OBTAINED ON 02/23/2023 BY CMP PROFESSIONAL LAND SURVEYORS, 333 S. WHITE STREET, WAKE FOREST, NC, 27588, PHONE: (919) 556-3148. CONTRACTOR SHALL BE RESPONSIBLE FOR VERIFYING ALL EXISTING INFORMATION,



**Sheet List Table Sheet Title** Sheet Number **COVER SHEET** C0.0 C0.1 **GENERAL NOTES EXISTING CONDITIONS & DEMOLITION PLAN** C2.0 SITE PLAN **GRADING PLAN** C3.0 C4.0 **UTILITY PLAN** C4.1 MECHANICAL PLAN SEPTIC TANK DETAILS C4.2 C5.0 **EROSION CONTROL PLAN - PHASE 1** C5.1 **EROSION CONTROL PLAN - PHASE 2** C5.2 **EROSION CONTROL DETAILS EROSION CONTROL DETAILS** C5.3 C8.0 SITE DETAILS C8.1 SITE DETAILS C9.0 STORM DETAILS C9.1 STORM DETAILS C10.0 SANITARY SEWER DETAILS C11.0 WATER DETAILS WATER DETAILS C11.1 LANDSCAPE PLAN L1.0 L2.0 LANDSCAPE DETAILS L2.1 LANDSCAPE NOTES E3.1 **EXTERIOR SITE PHOTOMETRIC PLAN** TRASH ENCLOSURE PLAN A1.5 **EXTERIOR COLOR ELEVATIONS** A2.0 **EXTERIOR ELEVATIONS** A2.1 **EXTERIOR ELEVATIONS** A2.2







COVER

SHEET NUMBER C0.0

### GENERAL NOTES:

- 1. WORK IN THIS PROJECT SHALL CONFORM TO THESE PLANS, THE LATEST EDITIONS OF THE NORTH CAROLINA DEPARTMENT OF TRANSPORTATION (NCDOT) ROAD AND BRIDGE SPECIFICATIONS, THE NCDOT ROAD AND BRIDGE STANDARDS, THE NORTH CAROLINA EROSION AND SEDIMENT CONTROL REGULATIONS, THE ROLESVILLE DESIGN AND CONSTRUCTION STANDARDS AND SPECIFICATIONS, THE FINAL GEOTECHNICAL REPORT, AND GENERAL DESIGN STANDARDS. IN THE EVENT OF CONFLICT BETWEEN ANY OF THESE STANDARDS, SPECIFICATIONS, OR PLANS, THE MOST STRINGENT SHALL GOVERN. ALL UTILITIES TO BE DEDICATED TO THE CITY OF RALEIGH MUNICIPAL WATER AND/OR SANITARY SEWER SYSTEM SHALL BE CONSTRUCTED AND TESTED TO CONFORM TO STATE OF NORTH CAROLINA/STATE BOARD OF HEALTH WATERWORKS AND/OR SEWAGE REGULATIONS AND THE CITY OF RALEIGH DESIGN AND CONSTRUCTION STANDARDS AND SPECIFICATIONS.
- 2. THE TERM "CONTRACTOR" AS REFERENCED HERE—IN SHALL ALSO INCLUDE THE SUBCONTRACTOR OR PRINCIPAL TRADE CONTRACTOR, UNDER CONTRACT TO THE GENERAL CONTRACTOR TO PROVIDE LABOR, MATERIALS, AND/OR SERVICES TO THE PROJECT.
- 3. THE CONTRACTOR SHALL BE SOLELY RESPONSIBLE FOR ALL JOBSITE SAFETY, INCLUDING BUT NOT LIMITED TO TRENCH SAFETY, DURING ALL PHASES OF CONSTRUCTION.
- 4. THE LOCATION AND SIZE OF EXISTING UTILITIES AS SHOWN IS APPROXIMATE ONLY. THE CONTRACTOR IS RESPONSIBLE FOR HORIZONTALLY AND VERTICALLY LOCATING AND PROTECTING ALL PUBLIC OR PRIVATE UTILITIES (SHOWN OR NOT SHOWN) WHICH LIE IN OR ADJACENT TO THE CONSTRUCTION SITE. AT LEAST 48 HOURS PRIOR TO ANY DEMOLITION, GRADING, OR CONSTRUCTION ACTIVITY, THE CONTRACTOR SHALL NOTIFY THE NORTH CAROLINA 811 UTILITIES LOCATION SERVICE (NC811) AT 1-800-632-4949 FOR PROPER IDENTIFICATION OF EXISTING UTILITIES WITHIN THE SITE.
- 5. THE CONTRACTOR SHALL SALVAGE AND PROTECT ALL EXISTING POWER POLES, SIGNS, MANHOLES, TELEPHONE RISERS, WATER VALVES, ETC. DURING ALL CONSTRUCTION PHASES. THE CONTRACTOR SHALL REPAIR, AT HIS OWN EXPENSE, ANY EXISTING UTILITIES DAMAGED DURING CONSTRUCTION.
- 6. TRAFFIC CONTROL WITHIN ALL VEHICULAR AREAS IS THE RESPONSIBILITY OF THE CONTRACTOR, SHALL BE IN CONFORMANCE WITH THE "MANUAL OF UNIFORM TRAFFIC CONTROL DEVICES," AND AS FURTHER DIRECTED BY CITY AND STATE INSPECTORS.
- 7. ANY DISCREPANCIES FOUND BETWEEN THE DRAWINGS, SPECIFICATIONS, AND SITE CONDITIONS OR ANY INCONSISTENCIES OR AMBIGUITIES IN DRAWINGS OR SPECIFICATIONS SHALL BE IMMEDIATELY REPORTED TO THE ENGINEER, IN WRITING, WHO SHALL PROMPTLY ADDRESS SUCH INCONSISTENCIES OR AMBIGUITIES. WORK DONE BY THE CONTRACTOR AFTER HIS DISCOVERY OF SUCH DISCREPANCIES, INCONSISTENCIES, OR AMBIGUITIES SHALL BE DONE AT THE CONTRACTOR'S RISK.
- 8. CONSTRUCTION STAKEOUT FOR THIS PROJECT SHALL BE PER A DIGITAL (CAD) FILE PROVIDED BY THE ENGINEER. THE CONTRACTOR SHALL NOTIFY THE LEAD ARCHITECT IMMEDIATELY OF ANY DISCREPANCIES FOUND BETWEEN THE DIGITAL FILE AND THE CRITICAL STAKING DIMENSIONS SHOWN ON THIS PLAN. ANY MODIFICATIONS MADE BY OTHERS TO THE DIGITAL FILE PROVIDED BY THE ENGINEER SHALL RENDER IT VOID.
- 9. A PRE—CONSTRUCTION CONFERENCE SHALL BE HELD PRIOR TO THE START OF CONSTRUCTION. THE CONTRACTOR SHALL ARRANGE THE MEETING WITH THE ROLESVILLE ENGINEERING DIVISION AND THE OWNER.
- 10. CONTRACTOR IS RESPONSIBLE FOR VERIFYING OR OBTAINING ALL REQUIRED PERMITS AND APPROVALS PRIOR TO COMMENCING CONSTRUCTION.
- 11. THE FRAMES AND COVERS OF ALL EXISTING AND PROPOSED DRAINAGE, SANITARY SEWER, WATER MAIN, GAS, AND WIRE UTILITY STRUCTURES SHALL BE ADJUSTED TO MATCH PROPOSED FINISHED ELEVATIONS AND SLOPES.
- 12. ROADWAYS AND BUILDINGS MUST BE CAPABLE OF SUPPORTING FIRE APPARATUS DURING CONSTRUCTION.
- 13. EXISTING INFORMATION SHOWN TAKEN FROM A TOPOGRAPHIC SURVEY DATED FEBRUARY 23, 2023 AND PROVIDED BY CMP PROFESSIONAL LAND SURVEYORS C-1525, 333 S. WHITE STREET, P.O. BOX 1253, WAKE FOREST, N.C. 27588, PHONE: (919) 556-3148.
- 14. ALL CONSTRUCTION SHALL BE IN ACCORDANCE WITH THE NC DOT AND ROLESVILLE STANDARDS, SPECIFICATIONS, & DETAILS IF APPLICABLE.

### GRADING

- 1. OBTAIN AND POST THE WAKE COUNTY LAND DISTURBANCE PERMIT ONSITE PRIOR TO COMMENCING WORK ON SITE.
- 2. REFER TO FINAL CONSTRUCTION PLANS FOR CLEARING LIMITS AND TEMPORARY EROSION CONTROL DEVICES TO BE INSTALLED PRIOR TO COMMENCING CONSTRUCTION.
- 3. CONTRACTOR SHALL ADHERE TO THE LIMITS OF TREE PROTECTION FENCE.
- 4. EROSION AND SEDIMENT CONTROL MEASURES SHALL BE MAINTAINED CONTINUOUSLY, RELOCATED WHEN AND AS NECESSARY, AND SHALL BE CHECKED AFTER EVERY RAINFALL. SEEDED AREAS SHALL BE CHECKED REGULARLY AND SHALL BE WATERED, FERTILIZED, RESEEDED, AND MULCHED AS NECESSARY TO OBTAIN A DENSE STAND OF GRASS.
- 5. ALL AREAS SHALL BE GRADED FOR POSITIVE DRAINAGE, AND AS SHOWN ON THESE PLANS. THE CONTRACTOR SHALL MAINTAIN ADEQUATE SITE DRAINAGE DURING ALL PHASES OF CONSTRUCTION. THE CONTRACTOR SHALL USE SILT FENCES (OR OTHER METHODS APPROVED BY THE ENGINEER, WAKE COUNTY, AND NCDENR). AS REQUIRED TO PREVENT SILT AND CONSTRUCTION DEBRIS FROM FLOWING ONTO ADJACENT PROPERTIES. CONTRACTOR SHALL COMPLY WITH ALL APPLICABLE FEDERAL, STATE, OR LOCAL EROSION, CONSERVATION, AND SILTATION ORDINANCES. CONTRACTOR SHALL REMOVE ALL TEMPORARY EROSION CONTROL DEVICES UPON COMPLETION OF PERMANENT DRAINAGE FACILITIES AND THE ESTABLISHMENT OF A STAND OF GRASS OR OTHER GROWTH TO PREVENT EROSION.
- 6. THE CONTRACTOR SHALL CLEAR AND GRUB THE SITE AND PLACE, COMPACT, AND MOISTURE CONDITION ALL FILL PER THE PROJECT GEOTECHNICAL ENGINEER'S SPECIFICATIONS AND REPORT. THE FILL MATERIAL TO BE USED SHALL BE APPROVED BY THE CERTIFIED MATERIAL TESTING AGENCY PRIOR TO PLACEMENT.
- 7. GRADING CONTRACTOR SHALL COORDINATE WITH THE UTILITY COMPANIES FOR ANY REQUIRED UTILITY ADJUSTMENTS AND/OR RELOCATIONS.
- 8. ALL MATERIALS USED FOR BACKFILL SHALL BE FREE OF WOOD, ROOTS, ROCKS, BOULDERS, OR ANY OTHER NON-COMPATIBLE SOIL TYPE MATERIAL. UNSATISFACTORY MATERIALS ALSO INCLUDE MAN-MADE FILLS AND REFUSE DEBRIS DERIVED FROM ANY SOURCE.
- 9. MATERIALS USED TO CONSTRUCT EMBANKMENTS FOR ANY PURPOSE, BACKFILL AROUND DRAINAGE STRUCTURES, OR IN UTILITY TRENCHES FOR ANY OTHER DEPRESSION REQUIRING FILL OR BACKFILL SHALL BE COMPACTED TO 95% OF MAXIMUM DENSITY AS DETERMINED BY THE STANDARD PROCTOR TEST AS SET OUT IN ASTM STANDARD D-698. THE CONTRACTOR SHALL, PRIOR TO ANY OPERATIONS INVOLVING FILLING OR BACKFILLING, SUBMIT THE RESULTS OF THE PROCTOR TEST TOGETHER WITH A CERTIFICATION THAT THE SOIL TESTED IS REPRESENTATIVE OF THE MATERIALS TO BE USED ON THE PROJECT. TESTS SHALL BE CONDUCTED BY A CERTIFIED MATERIALS TESTING LABORATORY AND THE CERTIFICATIONS MADE BY A LICENSED PROFESSIONAL ENGINEER REPRESENTING THE
- 10. ALL DEMOLITION, DEBRIS, AND OTHER EXCESS MATERIAL SHALL BE HAULED OFF—SITE AND LEGALLY DISPOSED OF AT THE CONTRACTOR'S EXPENSE.
- 11. NO TREE WITHIN THE TREE PROTECTION AREA SHALL BE REMOVED OR DAMAGED.
- 12. THE TREE PROTECTION FENCE SHALL BE MAINTAINED ON THE SITE UNTIL ALL SITE WORK IS COMPLETED AND THE FINAL SITE INSPECTION PRIOR TO THE PROJECT ACCEPTANCE IS SCHEDULED. FENCING SHALL BE REMOVED PRIOR TO FINAL SITE INSPECTION FOR THE CO.
- 13. REFERENCE GEOTECHNICAL REPORT FOR PAVING SUB GRADE INFORMATION.
- 14. ALL SPOT GRADE ELEVATIONS IN CURB AND GUTTER REPRESENT GUTTER FLOWLINE ELEVATION AT FACE OF CURB UNLESS OTHERWISE NOTED (ADD 6" FOR TOP OF CURB).
- 15. PROPOSED CONTOURS AND GUTTER GRADIENTS ARE APPROXIMATE. PROPOSED SPOT ELEVATIONS AND ROADWAY PROFILES/SUPERELEVATIONS ARE TO BE USED IN CASE OF DISCREPANCY.
- 16. REFER TO SITE PLAN AND FINAL PLAT FOR HORIZONTAL DIMENSIONS.
- 17. WHERE FILL IS TO BE PLACED ON EXISTING SLOPES STEEPER THAN 4:1, CONTRACTOR SHALL EXCAVATE BENCHES WITH A MAXIMUM DEPTH OF 3'.
- 18. THE CONTRACTOR SHALL COORDINATE WITH THE GEOTECHNICAL ENGINEER FOR APPROPRIATE SLOPE STABILIZATION ON ALL SLOPES STEEPER THAN 3:1.
- 19. CONTRACTOR SHALL OBTAIN ALL PERMITS REQUIRED FOR BLASTING ROCK IF BLAST ROCK IS ENCOUNTERED. CONTRACTOR SHALL BE SOLELY RESPONSIBLE FOR COMPLYING WITH ALL BLASTING AND SAFETY REQUIREMENTS.
- 20. SILT FENCE SHALL BE PLACED AROUND ALL TEMPORARY SOIL STOCKPILES A MINIMUM OF 3' FROM TOE OF SLOPE.
- 21. VERTICAL DATUM IS BASED ON NAVD 88.

### SANITARY SEWER

- 1. SANITARY SEWER SERVICES SHALL BE SCHEDULE 40 PVC.
- 2. CLEANOUT SYMBOLS SHOWN ON THESE PLANS REPRESENT LOCATION OF SURFACE ACCESS POINT. CONTRACTOR SHALL LOCATE WYE APPROPRIATELY BASED ON PIPE DEPTH.
- 3. SANITARY SEWER CLEAN-OUTS LOCATED IN PAVEMENT AREAS SHALL BE HEAVY-DUTY TRAFFIC BEARING CASTINGS.

- 1. WATERLINES, LARGER THAN 2" SHALL BE DUCTILE IRON PIPE MEETING THE REQUIREMENTS OF ANSI-AWWA C151 PRESSURE CLASS 350. WATERLINES 3/4" TO 2" SHALL BE TYPE "K" SOFT COPPER.
- 2. ALL UNDERGROUND UTILITIES AND FIRE HYDRANTS MUST BE FUNCTIONALLY APPROVED PRIOR TO STRUCTURAL
- 3. NATIONAL STANDARD THREADS SHALL BE INSTALLED ON FIRE HYDRANTS.
- 4. ALL FIRE HYDRANTS AND FDC CONNECTIONS TO HAVE STORZ TYPE CONNECTION PER CITY OF RALEIGH FIRE DEPARTMENT STANDARDS.

### BACKFLOW PREVENTION:

- 1. THERE SHALL BE NO TAPS, PIPING BRANCHES, UNAPPROVED BYPASS PIPING, HYDRANTS, FIRE DEPARTMENT CONNECTION POINTS OR OTHER WATER—USING APPURTENANCES CONNECTED TO THE SUPPLY LINE BETWEEN ANY WATER METER AND ITS REQUIRED BACKFLOW PREVENTER.
- 2. EACH BACKFLOW PREVENTER ASSEMBLY IS REQUIRED TO BE TESTED BY AN APPROVED CERTIFIED TESTER PRIOR TO PLACING THE WATER SYSTEM INTO SERVICE. CONTRACTOR SHALL PERFORM TESTING IN ACCORDANCE WITH THE CITY OF RALEIGH ENGINEERING DEPARTMENT.

### CONSTRUCTION NOTES

EASEMENTS ON THE JOB SITE AT ALL TIMES.

- 1. THE CONTRACTOR SHALL CONDUCT THE WORK IN A SAFE MANNER AND WITH A MINIMUM AMOUNT OF INCONVENIENCE TO TRAFFIC.
- 2. THE CONTRACTOR SHALL BE RESPONSIBLE FOR ALL TRAFFIC CONTROL AND SHALL ADHERE TO THE PROVISIONS OF THE MUTCD (MOST CURRENT EDITION).
- PRIOR TO CONSTRUCTION RECINNING ALL SIGNAGE AND TRAFFIC CONTROL SHALL BE IN PLACE
- 3. PRIOR TO CONSTRUCTION BEGINNING, ALL SIGNAGE AND TRAFFIC CONTROL SHALL BE IN PLACE.4. THE CONTRACTOR SHALL HAVE A COMPLETE SET OF CONTRACT DOCUMENTS AS WELL AS ALL APPROVALS AND
- 5. THE CONTRACTOR SHALL REPAIR ALL DRIVEWAYS, DRIVEWAY PIPES, CURB AND GUTTER, SIDEWALKS AND STREET TO EXISTING CONDITION OR BETTER.

### PAVING/CURBING

- . WHERE PROPOSED CURB AND GUTTER TIES TO EXISTING CURB OR CURB AND GUTTER, A TRANSITION OF 10' SHALL BE MADE TO CONFORM TO THE EXISTING HEIGHTS AND SHAPES.
- 2. BEFORE ANY EARTHWORK IS DONE, THE CONTRACTOR SHALL STAKE OUT AND MARK THE LIMITS OF PAVEMENT AND OTHER ITEMS ESTABLISHED IN THE PLANS. THE CONTRACTOR SHALL PROVIDE ALL NECESSARY ENGINEERING AND SURVEYING FOR LINE AND GRADE CONTROL POINTS RELATED TO EARTHWORK.
- 3. ALL PAVEMENT SUB GRADES (EVEN WHEN ROCK IS ENCOUNTERED) SHALL BE SCARIFIED TO A DEPTH OF 8 INCHES AND COMPACTED TO A MINIMUM DENSITY OF 98 PERCENT OF ASTM D-698 DENSITY AT OPTIMUM MOISTURE CONTENT UNLESS OTHERWISE SHOWN IN THE CONSTRUCTION DOCUMENTS OR AS DIRECTED BY THE CERTIFIED MATERIALS TESTING AGENT. FILL SHALL BE PLACED AND COMPACTED IN MAXIMUM 8" LIFTS.
- 4. CONTRACTOR SHALL FURNISH AND INSTALL ALL PAVEMENT MARKINGS AND MISCELLANEOUS STRIPING AS SHOWN ON THE PLANS. ALL ROADWAY PAVEMENT MARKINGS SHALL BE THERMOPLASTIC AND ADHERE TO NCDOT STANDARDS.
- 5. THE CONTRACTOR SHALL CLEAR AND GRUB THE SITE AND PLACE, COMPACT, AND MOISTURE CONDITION ALL FILL PER THE PROJECT GEOTECHNICAL ENGINEER'S SPECIFICATIONS. THE FILL MATERIAL TO BE USED SHALL BE APPROVED BY THE GEOTECHNICAL ENGINEER PRIOR TO PLACEMENT.
- 6. ALL CURB JOINTS SHALL EXTEND THROUGH THE CURB. MINIMUM LENGTH OF OFFSET JOINTS AT RADIUS POINTS IS 1.5 FEET. ALL JOINTS SHALL BE SEALED WITH JOINT SEALANT.
- TESTING OF MATERIALS REQUIRED FOR THE CONSTRUCTION OF THE PAVING IMPROVEMENTS SHALL BE PERFORMED BY AN APPROVED AGENCY FOR TESTING MATERIALS. THE TESTING LABORATORY AND THE PAYMENT OF SUCH TESTING SERVICES SHALL BE MADE BY THE OWNER. IT SHALL BE THE CONTRACTOR'S RESPONSIBILITY THAT THE CERTIFIED MATERIAL TESTING AGENT HAS PERFORMED THE WORK AND THAT THE WORK CONSTRUCTED DOES MEET THE REQUIREMENTS OF THE CITY'S SPECIFICATIONS AND/OR THE PROJECT SPECIFICATIONS, WHICHEVER IS MORE STRINGENT.
- 8. ALL SIGNS, PAVEMENT MARKINGS, AND OTHER TRAFFIC CONTROL DEVICES ON PUBLIC STREETS SHALL CONFORM TO MUTCD, NCDOT, AND ROLESVILLE STANDARDS.

### STORM DRAINAGE

- 1. THE CONTRACTOR SHALL VERIFY AND COORDINATE ALL DIMENSIONS SHOWN, INCLUDING THE HORIZONTAL AND VERTICAL LOCATION OF CURB INLETS AND GRATE INLETS AND ALL UTILITIES CROSSING THE STORM SEWER.
- 2. THE SITE UTILITY CONTRACTOR SHALL PROVIDE ALL MATERIALS AND APPURTENANCES NECESSARY FOR COMPLETE INSTALLATION OF THE STORM SEWER.
- 3. THE ROLESVILLE INSPECTOR SHALL INSPECT ALL "PUBLIC" CONSTRUCTION. THE CONTRACTOR'S PRICE SHALL INCLUDE ALL INSPECTION FEES.
- 4. ALL RCP STORM SEWER MAINS AND LATERALS SHALL BE MINIMUM CLASS III REINFORCED CONCRETE PIPE.
- 5. ALL PVC PIPE USED IN DRAINAGE SYSTEM SHALL BE MINIMUM SDR-35 OR APPROVED EQUAL.6. ALL PVC TO RCP CONNECTIONS SHALL BE CONSTRUCTED WITH CONCRETE COLLARS.
- 7. THE LOCATIONS OF STORM SEWER STRUCTURES SHOWN ON THESE PLANS (AND PROVIDED IN ASSOCIATED CAD FILES) ARE APPROXIMATE. THE CONTRACTOR SHALL STAKE ALL CURB INLET STRUCTURES SUCH THAT INLET TOPS ALIGN HORIZONTALLY WITH PROPOSED CURB LOCATIONS (PER DETAIL, IF PROVIDED). WHERE PROPOSED STORM SEWERS TIE TO EXISTING STRUCTURES, PIPES, ETC., THE CONTRACTOR SHALL FIELD ADJUST PROPOSED STORM SEWERS TO MATCH THE LOCATIONS OF THESE EXISTING FEATURES.
- 8. RIM ELEVATIONS FOR STORM CATCH BASINS ARE MEASURED TO THE GUTTER FLOW LINE.

### TRAFFIC CONTROL NOTES

- 1. WITHIN THE SIGHT TRIANGLES AND SIGHT EASEMENTS SHOWN ON THESE PLANS, NO OBSTRUCTION SHALL BE LOCATED IN WHOLE OR PART BETWEEN (2) FEET AND (8) FEET IN HEIGHT ABOVE THE CURB LINE ELEVATION OR THE NEAREST TRAVELED WAY, IF NO CURBING EXISTS. OBSTRUCTIONS INCLUDE, BUT ARE NOT LIMITED TO, ANY BERM, FOLIAGE, FENCE, WALL, SIGN, PARKED VEHICLE OR OTHER OBJECT.
- 2. ALL CONSTRUCTION SHALL BE IN ACCORDANCE WITH ALL ROLESVILLE AND/OR N.C.D.O.T. STANDARDS AND SPECIFICATIONS
- 3. REFER TO MANUAL ON UNIFORM TRAFFIC CONTROL DEVICES (LATEST EDITION) FOR DETAILS OF STANDARD TRAFFIC CONTROL SIGNS AND STANDARDS.

### SEEDBED PREPARATION

- 1. CHISEL COMPACTED AREAS AND SPREAD TOPSOIL THREE INCHES DEEP OVER ADVERSE SOIL CONDITIONS, IF
- 2. RIP THE ENTIRE AREA TO SIX INCHES DEEP.
- 3. REMOVE ALL LOOSE ROCK, ROOTS AND OTHER OBSTRUCTIONS, LEAVING SURFACE REASONABLY SMOOTH AND
- 4. APPLY AGRICULTURAL LIME, FERTILIZER AND SUPERPHOSPHATE UNIFORMLY AND MIX WITH SOIL (SEE MIXTURE
- BELOW).\*

  5. CONTINUE TILLAGE UNTIL A WELL—PULVERIZED, FIRM, REASONABLY UNIFORM SEEDBED IS PREPARED FOUR TO SIX
- INCHES DEEP.

  6. SEED ON A FRESHLY PREPARED SEEDBED AND COVER SEED LIGHTLY WITH SEEDING EQUIPMENT OR CULTIPACK
- AFTER SEEDING.

  7. MULCH IMMEDIATELY AFTER SEEDING AND ANCHOR MULCH.

TYPE

- 8. INSPECT ALL SEEDED AREAS AND MAKE NECESSARY REPAIRS OR RESEEDINGS WITHIN THE PLANTING SEASON, IF POSSIBLE. IF STAND SHOULD BE MORE THAN 60% DAMAGED, RE-ESTABLISH FOLLOWING THE ORIGINAL LIME, FERTILIZER AND SEEDING RATES.
- 9. CONSULT S&EC ENVIRONMENTAL ENGINEERS ON MAINTENANCE TREATMENT AND FERTILIZATION AFTER PERMANENT COVER IS ESTABLISHED.
- 10. \*AGRICULTURAL LIMESTONE 2 TONS/ ACRES (3 TONS/ACRE IN CLAY SOILS) FERTILIZER 1,000 LBS. / ACRE -10-10-10 SUPERPHOSPHATE- 500 LBS> / ACRE -20% ANALYSIS MULCH -2 TONS / ACRE SMALL GRAIN STRAW ANOTHER ASPHALT EMULSION @ 300 GALS./ ACRE

PLANTING RATE

25 LBS/ACRE

### SEEDING SCHEDULE

(NOV 1 - MAR 1)

_	SHOULDERS, SIDE DITCHES, SLUPES (MAX 3)	<u>: 1,7</u>
AUG 15 - NOV 1	TALL FESCUE	300 LBS/ACRE
NOV 1 - MAR 1	TALL FESCUE & ABRUZZI RYE	300 LBS/ACRE
	*** *** *** *** ***	25 LBS/ACRE
MAR 1 - APR 15	TALL FESCUE	300 LBS/ACRE
APR 15 - JUN 30	HULLED COMMON BERMUDAGRASS	
JUL 1 - AUG 15	TALL FESCUE AND ***BROWNTOP MILLET	120 LBS/ACRE 35 LBS/ACRE
	***OR SORGHUM-SUDAN HYBRIDS	30 LBS/ACRE
	OK SOKGHOW-SODAN ITT BIXIDS	30 EBS/ACINE
SLOPES (3	3:1 TO 2:1)	
MAR 1 - JUN 1	SERICEA LESPEDEZA (SCARIFIED)	50 LBS/ACRE
(MAR 1 - APR 15)	AND ADD TALL FESCUE	120 LBS/ACRE
(MAR 1 - JUN 30)	OR ADD WEEPING LOVEGRASS	10 LBS/ACRE
(MAR 1 - JUN 30)	OR ADD HULLED COMMON	25 LBS/ACRE
	BERMUDAGRASS	
JUN 1 - SEP 1	***TALL FESCUE AND	120 LBS/ACRE
	***BROWNTOP MILLET	35 LBS/ACRE
	***OR SORGHUM-SUDAN HYBRIDS	30 LBS/ACRE
SEP 1 - MAR 1	SERICEA LESPEDEZA (UNHULLED-	70 LBS/ACRE
	UNSCARIFED) AND TALL FESCUE	120 LBS/ACRE
	,	

SHOULDERS SIDE DITCHES SLODES (MAY 3.1)

CONSULT CONSERVATION ENGINEER OR SOIL CONSERVATION SERVICE FOR ADDITIONAL INFORMATION CONCERNING OTHER ALTERNATIVES FOR VEGETATION OF DENUDED AREAS. THE ABOVE VEGETATION RATES ARE THOSE WHICH DO WELL UNDER LOCAL CONDITIONS; OTHER SEEDING RATE COMBINATIONS ARE POSSIBLE.

ADD ABRUZZI RYE

MOWING, OTHERWISE FESCUE MAY BE SHADED OUT.

\*\*\*TEMPORARY - RESEED ACCORDING TO OPTIMUM SEASON FOR DESIRED PERMANENT

\*NOTE: THIS SEEDING SCHEDULE IS FOR EROSION AND SEDIMENT CONTROL ONLY. SEE LANDSCAPE PLAN FOR FINAL SEEDING.

THE CONTRACTOR SHALL PROVIDE GROUND COVER ON DESIGNATED AREAS AND SLOPES GREATER THAN 3:1 WITHIN 7 DAYS FOLLOWING COMPLETION OF ANY PHASE OF GRADING. CONTRACTOR SHALL PROVIDE GROUND COVER IN 14 DAYS ON ALL OTHER AREAS FOLLOWING COMPLETION OF ANY PHASE OF GRADING. PERMANENT GROUND COVER FOR ALL DISTURBED AREAS SHALL BE PROVIDED WITHIN 15 WORKING DAYS OR 90 CALENDAR DAYS (WHICHEVER IS SHORTER) FOLLOWING COMPLETION OF CONSTRUCTION.

NURSE CROP: WHEN SEEDING BERMUDA GRASS SEED CONTRACTOR SHALL ADD 25 LB/AC OF ANNUAL RYE GRASS AS NURSE CROP UNTIL PERMANENT ESTABLISHMENT OF BERMUDA GRASS

### EROSION CONTROL NOTES

REQUIRED PRIOR TO PROJECT COMPLETION AND ACCEPTANCE.

OF CONSTRUCTION

- 1. UNLESS OTHERWISE INDICATED, ALL VEGETATIVE AND STRUCTURAL EROSION AND SEDIMENT CONTROL MEASURES SHALL BE CONSTRUCTED AND MAINTAINED IN ACCORDANCE WITH THE MINIMUM STANDARDS AND SPECIFICATIONS OF THE NORTH CAROLINA EROSION AND SEDIMENT CONTROL HANDBOOK.
- 2. THE CONTRACTOR SHALL INSTALL AND MAINTAIN THROUGHOUT THE PROJECT CONSTRUCTION ALL EROSION CONTROL MEASURES SHOWN WITHIN THESE PLANS IN ACCORDANCE WITH APPLICABLE NORTH CAROLINA DEPARTMENT OF ENVIRONMENTAL QUALITY (NCDEQ) AND WAKE COUNTY EROSION AND SEDIMENT CONTROL
- 3. ALL CONSTRUCTION WORK SHALL BE IN COMPLIANCE WITH REGULATIONS OF THE NATIONAL POLLUTANT DISCHARGE ELIMINATION SYSTEM (NPDES) STORM WATER GENERAL PERMIT.
- 4. ALL EROSION AND SEDIMENT CONTROL MEASURES ARE TO BE PLACED PRIOR TO CLEARING AND/OR LAND DISTURBANCE.
- 5. A COPY OF THE APPROVED EROSION AND SEDIMENT CONTROL PLAN AND PERMIT SHALL BE MAINTAINED ON THE SITE AT ALL TIMES.
- 6. THE CONTRACTOR SHALL DILIGENTLY AND CONTINUOUSLY MAINTAIN ALL EROSION CONTROL DEVICES AND STRUCTURES TO MINIMIZE EROSION. THE CONTRACTOR SHALL MAINTAIN CLOSE CONTACT WITH THE NCDENR EROSION CONTROL INSPECTOR SO THAT PERIODIC INSPECTIONS CAN BE PERFORMED AT APPROPRIATE STAGES
- 7. APPROVAL OF THIS PLAN IS NOT AN AUTHORIZATION TO GRADE ADJACENT PROPERTIES. WHEN FIELD CONDITIONS WARRANT OFF—SITE GRADING, PERMISSION MUST BE OBTAINED FROM THE AFFECTED PROPERTY OWNERS. CONTACT PROJECT ENGINEER AND PROJECT EROSION CONTROL INSPECTOR TO ENSURE ADDITIONAL EROSION CONTROL MEASURES ARE INSTALLED PRIOR TO OFF—SITE GRADING.
- 8. PRIOR TO COMMENCING LAND DISTURBING ACTIVITIES IN AREAS OTHER THAN INDICATED ON THESE PLANS (INCLUDING, BUT NOT LIMITED TO OFF-SITE BORROW OR WASTE AREAS, STAGING OR STORAGE AREAS), THE CONTRACTOR SHALL PREPARE AND SUBMIT A SUPPLEMENTARY EROSION CONTROL PLAN TO THE OWNER FOR REVIEW AND TO THE WAKE COUNTY FOR APPROVAL. CONTRACTOR SHALL PAY ALL FEES REQUIRED AND SHALL INSTALL NECESSARY MEASURES AT NO SEPARATE PAYMENT. THE CONTRACTOR SHALL PROVIDE THE OWNER AND THE ENGINEER A COPY OF THE AMENDED PERMIT.
- 9. EROSION AND SEDIMENT CONTROL MEASURES SHALL BE MAINTAINED CONTINUOUSLY, RELOCATED WHEN AND AS NECESSARY, AND SHALL BE CHECKED AFTER EVERY RAINFALL. SEEDED AREAS SHALL BE CHECKED REGULARLY AND SHALL BE WATERED, FERTILIZED, RESEEDED AND MULCHED AS NECESSARY TO OBTAIN A DENSE STAND OF GRASS
- 10. STABILIZATION IS THE BEST FORM OF EROSION CONTROL. ALL DISTURBED AREAS WHICH ARE NOT OTHERWISE STABILIZED SHALL BE TOP SOILED AND SEEDED, TEMPORARILY OR PERMANENTLY IN ACCORDANCE WITH THE NORTH CAROLINA SEDIMENT CONTROL REGULATIONS. PERMANENT SEEDING AND GRASS ESTABLISHMENT IS
- 11. CONTRACTOR TO ENSURE THAT SEDIMENT LADEN RUNOFF DOES NOT LEAVE SITE LIMITS OR ENTER PROTECTED AREAS. ANY SEDIMENT DEPOSITED BEYOND DISTURBED AREA WITHIN SITE LIMITS SHALL BE REMOVED.
- 12. ROLLED EROSION CONTROL PRODUCTS (RECP'S) SHOULD BE USED TO AID PERMANENT VEGETATED STABILIZATION OF SLOPES 2:1 OR GREATER AND WITH MORE THAN 10' OF VERTICAL RELIEF. RECP'S SHOULD ALSO BE USED WHEN MULCH CANNOT BE ADEQUATELY TACKED AND WHERE IMMEDIATE GROUND COVER IS REQUIRED TO PREVENT EROSION DAMAGE.
- 13. ALL TEMPORARY EROSION AND SEDIMENT CONTROL MEASURES SHALL BE REMOVED WITHIN 21 DAYS AFTER FINAL SITE STABILIZATION OR AFTER THE TEMPORARY MEASURES ARE NO LONGER NEEDED. TRAPPED SEDIMENT AND THE DISTURBED SOIL AREAS RESULTING FROM THE DISPOSITION OF TEMPORARY MEASURES SHALL BE PERMANENTLY STABILIZED TO PREVENT FURTHER EROSION AND SEDIMENTATION.
- 14. WHERE SEDIMENT IS TRANSPORTED ONTO A PAVED OR PUBLIC ROAD SURFACE, THE ROAD SURFACE SHALL BE CLEANED THOROUGHLY AT THE END OF EACH DAY. SEDIMENT SHALL BE REMOVED FROM THE ROADS BY SHOVELING OR SWEEPING AND TRANSPORTED TO A SEDIMENT CONTROL DISPOSAL AREA. STREET WASHING SHALL BE ALLOWED ONLY AFTER SEDIMENT IS REMOVED IN THIS MANNER.
- 15. WHEN A CRUSHED STONE CONSTRUCTION ENTRANCE HAS BEEN COVERED WITH SOIL OR HAS BEEN PUSHED INTO THE SOIL BY CONSTRUCTION TRAFFIC, IT SHALL BE REPLACED WITH A DEPTH OF STONE EQUAL TO THAT OF THE ORIGINAL APPLICATION.
- 16. TEMPORARY CONSTRUCTION ENTRANCES SHALL BE REQUIRED AT ALL CONSTRUCTION STAGING AREA ENTRANCES
   AND ALL CONSTRUCTION ACCESS LOCATIONS INTO NON-PAVED AREAS. TWO TO THREE INCH STONE SHALL BE
   USED FOR THE TEMPORARY GRAVEL CONSTRUCTION ENTRANCE.
   17. ALL DRAINAGE INLETS SHALL BE PROTECTED FROM SILTATION. INEFFECTIVE PROTECTION DEVICES SHALL BE
- IMMEDIATELY REPLACED AND THE INLET CLEANED. FLUSHING IS NOT AN ACCEPTABLE METHOD OF CLEANING.

  18. DURING CONSTRUCTION OF THE PROJECT, SOIL STOCKPILES SHALL BE STABILIZED OR PROTECTED WITH SEDIMENT
- TRAPPING MEASURES. THE APPLICANT IS RESPONSIBLE FOR THE TEMPORARY PROTECTION AND PERMANENT STABILIZATION OF ALL SOIL STOCKPILES ON SITE AS WELL AS SOIL INTENTIONALLY TRANSPORTED FROM THE PROJECT SITE.

  19. SEDIMENT BASINS AND TRAPS, PERIMETER DIKES, SEDIMENT BARRIERS AND OTHER MEASURES INTENDED TO TRAP
- SEDIMENT BASINS AND TRAPS, PERIMETER DIKES, SEDIMENT BARRIERS AND OTHER MEASURES INTENDED TO TRAP
  SEDIMENT SHALL BE CONSTRUCTED AS A FIRST STEP IN ANY LAND—DISTURBING ACTIVITY AND SHALL BE MADE
  FUNCTIONAL BEFORE UPSLOPE LAND DISTURBANCE TAKES PLACE.
- 20. ALL DISTURBED AREAS ARE TO DRAIN TO APPROVED SEDIMENT CONTROL MEASURES AT ALL TIMES DURING LAND DISTURBING ACTIVITIES AND DURING SITE DEVELOPMENT UNTIL FINAL STABILIZATION IS ACHIEVED.
- 21. DURING DEWATERING OPERATIONS, WATER SHALL BE PUMPED INTO AN APPROVED FILTERING DEVICE PRIOR TO DISCHARGE TO RECEIVING OUTLET.22. THE CONTRACTOR SHALL INSPECT ALL EROSION CONTROL MEASURES PERIODICALLY AND AFTER EACH
- RUNOFF-PRODUCING EVENT. ANY NECESSARY REPAIRS OR CLEANUP TO MAINTAIN THE EFFECTIVENESS OF THE EROSION CONTROL DEVICES SHALL BE MADE IMMEDIATELY.

  23. ALL TEMPORARY EROSION CONTROL MEASURES SHALL BE REMOVED BY CONTRACTOR ONCE STABILIZATION OR A SUFFICIENT GROUND COVER HAS BEEN ESTABLISHED OR AS DIRECTED BY THE ENGINEER. WAKE COUNTY
- INSPECTOR'S FINAL APPROVAL IS REQUIRED.

24. STABILIZATION MEASURES SHALL BE APPLIED TO STRUCTURES SUCH AS DAMS, DIKES AND DIVERSIONS

- IMMEDIATELY AFTER INSTALLATION.

  25. ADDITIONAL EROSION CONTROL MEASURES MAY BE REQUIRED DEPENDING UPON FIELD CONDITIONS.
- 26. LIMITS OF GRADING SHOWN ON THE PLAN ARE MAXIMUM LIMITS FOR EROSION CONTROL PURPOSES ONLY. SURVEYOR TO DETERMINE ACTUAL LIMIT.
- 27. ANY GRADING BEYOND THE DENUDED LIMITS SHOWN ON THE PLAN IS A VIOLATION OF THE WAKE COUNTY
- EROSION CONTROL ORDINANCE, AND IS SUBJECT TO A FINE.

  28. GRADING MORE THAN 12.000 SF WITHOUT AN APPROVED EROSION CONTROL PLAN IS A VIOLATION OF THE WAKE

### ABBREVIATIONS

\*NOT ALL ABBREVIATIONS MAY BE USED FOR THIS PROJECT.

COUNTY EROSION CONTROL ORDINANCE AND IS SUBJECT TO A FINE.

- CB CATCH BASIN
- YI YARD INLET CO — CLEAN OUT DI — DROP INLET

TYP. – TYPICAL

- EX EXISTING
  FES FLARED—END—SECTION
  JB JUNCTION BOX
- LOD LIMITS OF DISTURBANCE PVC – POLYVINYL CHLORIDE

RCP - REINFORCED CONCRETE PIPE


SURVEY NOTE:
EXISTING TOPOGRAPHICAL INFORMATION IS BASED ON A
TOPOGRAPHIC SURVEY OBTAINED ON 02/23/2023 BY CMP
PROFESSIONAL LAND SURVEYORS, 333 S. WHITE STREET, WAKE

FOREST, NC, 27588, PHONE: (919) 556-3148. CONTRACTOR SHALL BE

RESPONSIBLE FOR VERIFYING ALL EXISTING INFORMATION, DEPICTED OR NOT, PRIOR TO CONSTRUCTION AND REPORT POTENTIAL CONFLICTS TO OWNER AND ENGINEER.



© 2023 KIMLEY-HORN AND ASSOCIATES, INC.
2 WWW.KIMLEY-HORN.COM PHONE: 919-677-2000 FAX: 916
421 FAYETTEVILLE STREET, SUITE 600, RALEIGH, NC 276

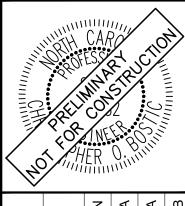


DATE
10/31/2023
SCALE AS SHOWN
DESIGNED BY JAA
DRAWN BY JAA


JERAL NOTES

Ш

EPARED FOR ENTERPRISES

ROLESVI PREPARED FO &S JAVA ENTE

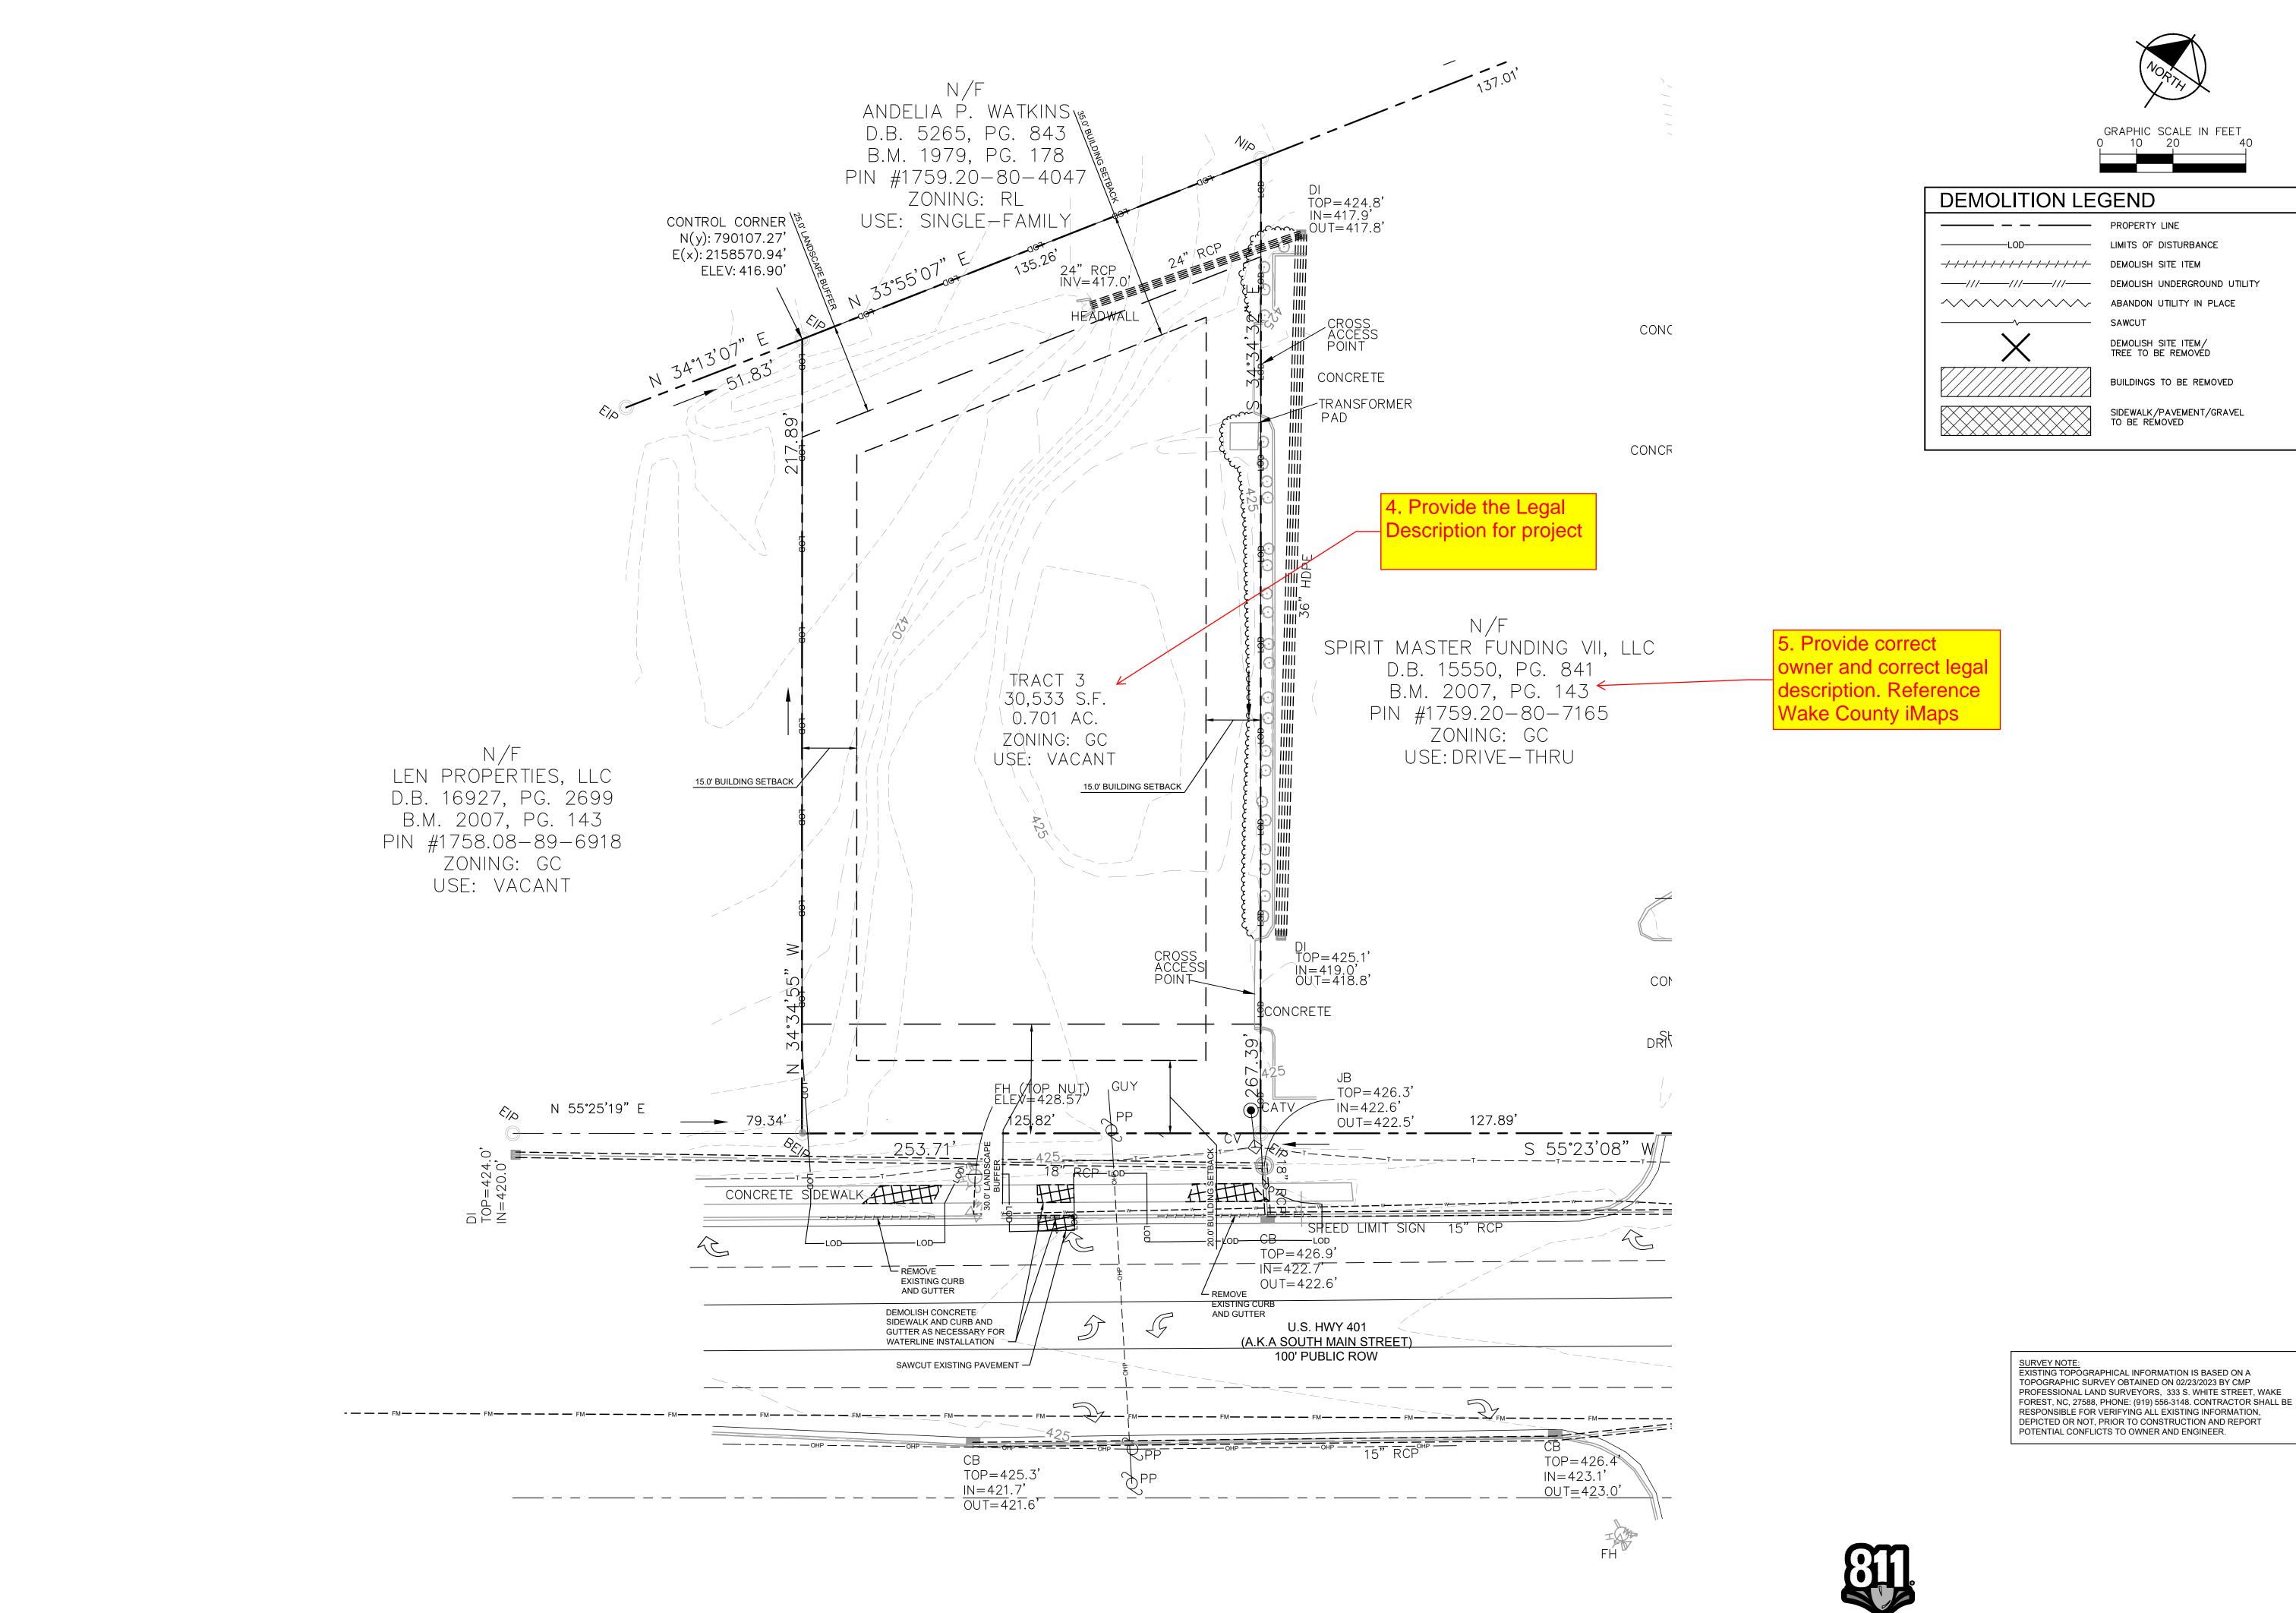


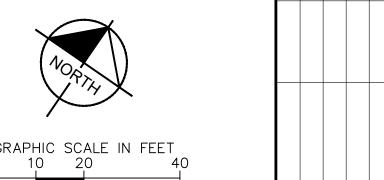

(A) (A) (B) (C) (A)

Horn


SHEET NUMBER C1.0

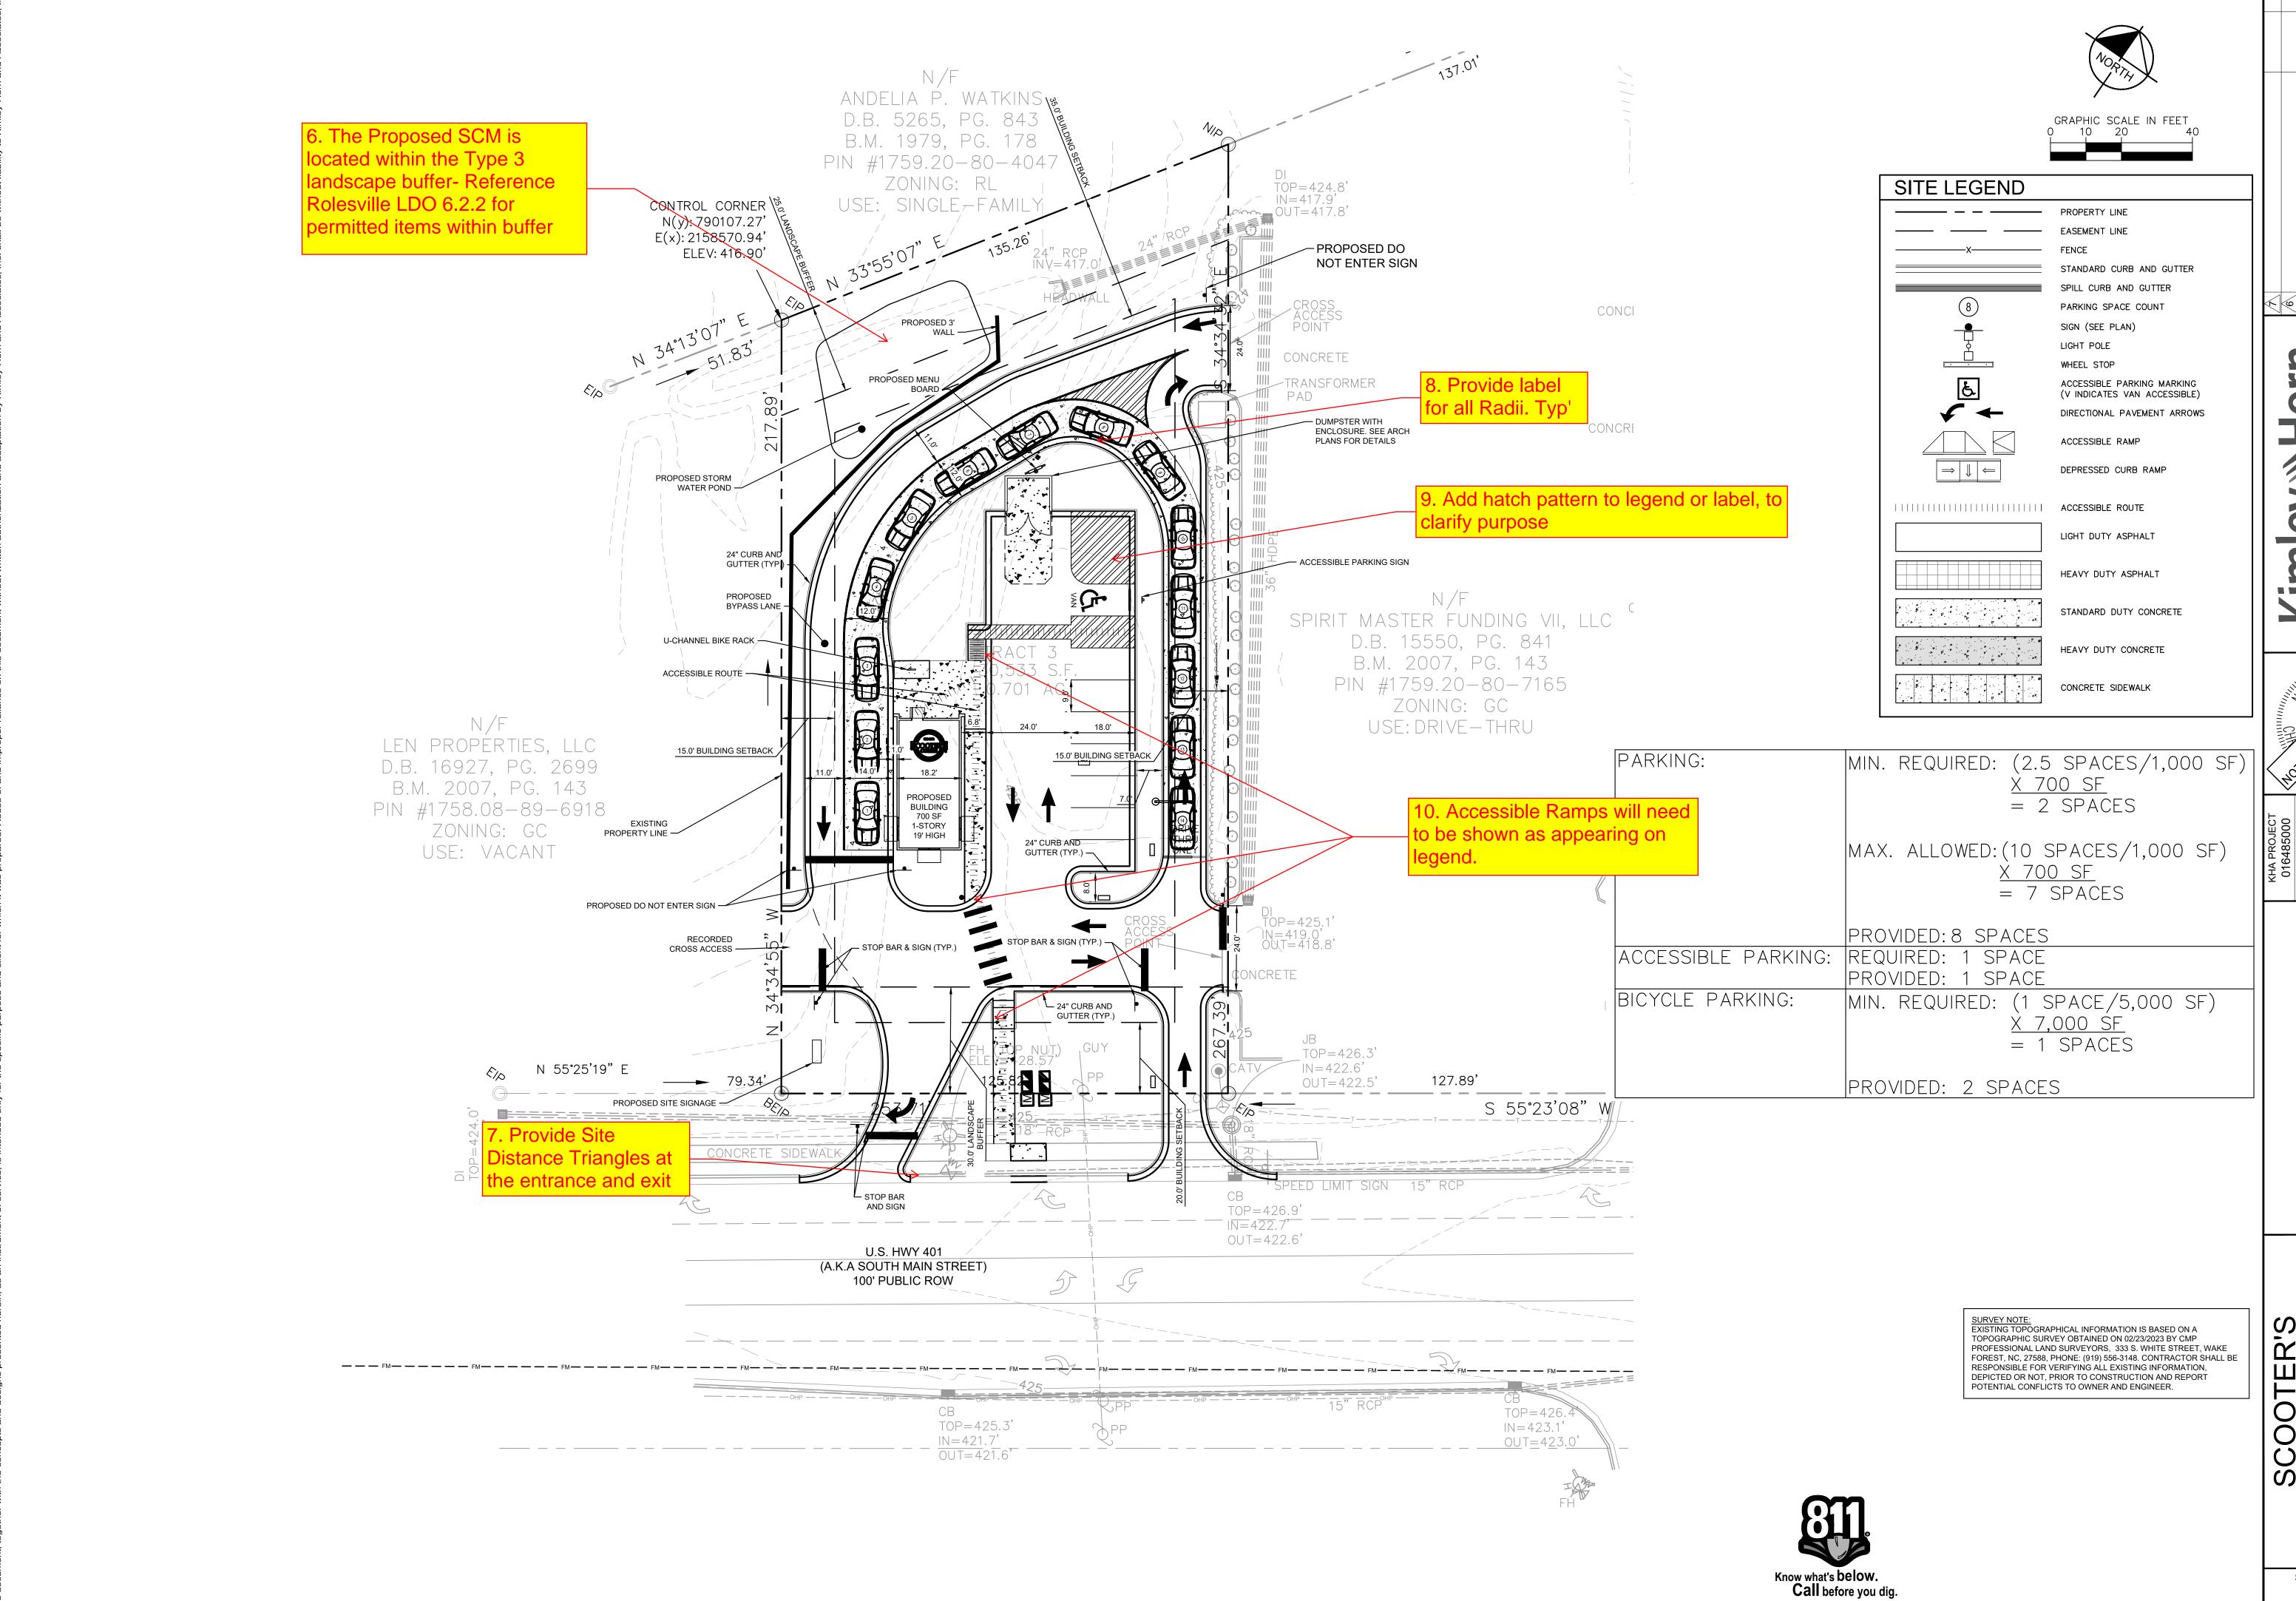


U Kim


SITE


SHEET NUMBER C2.0

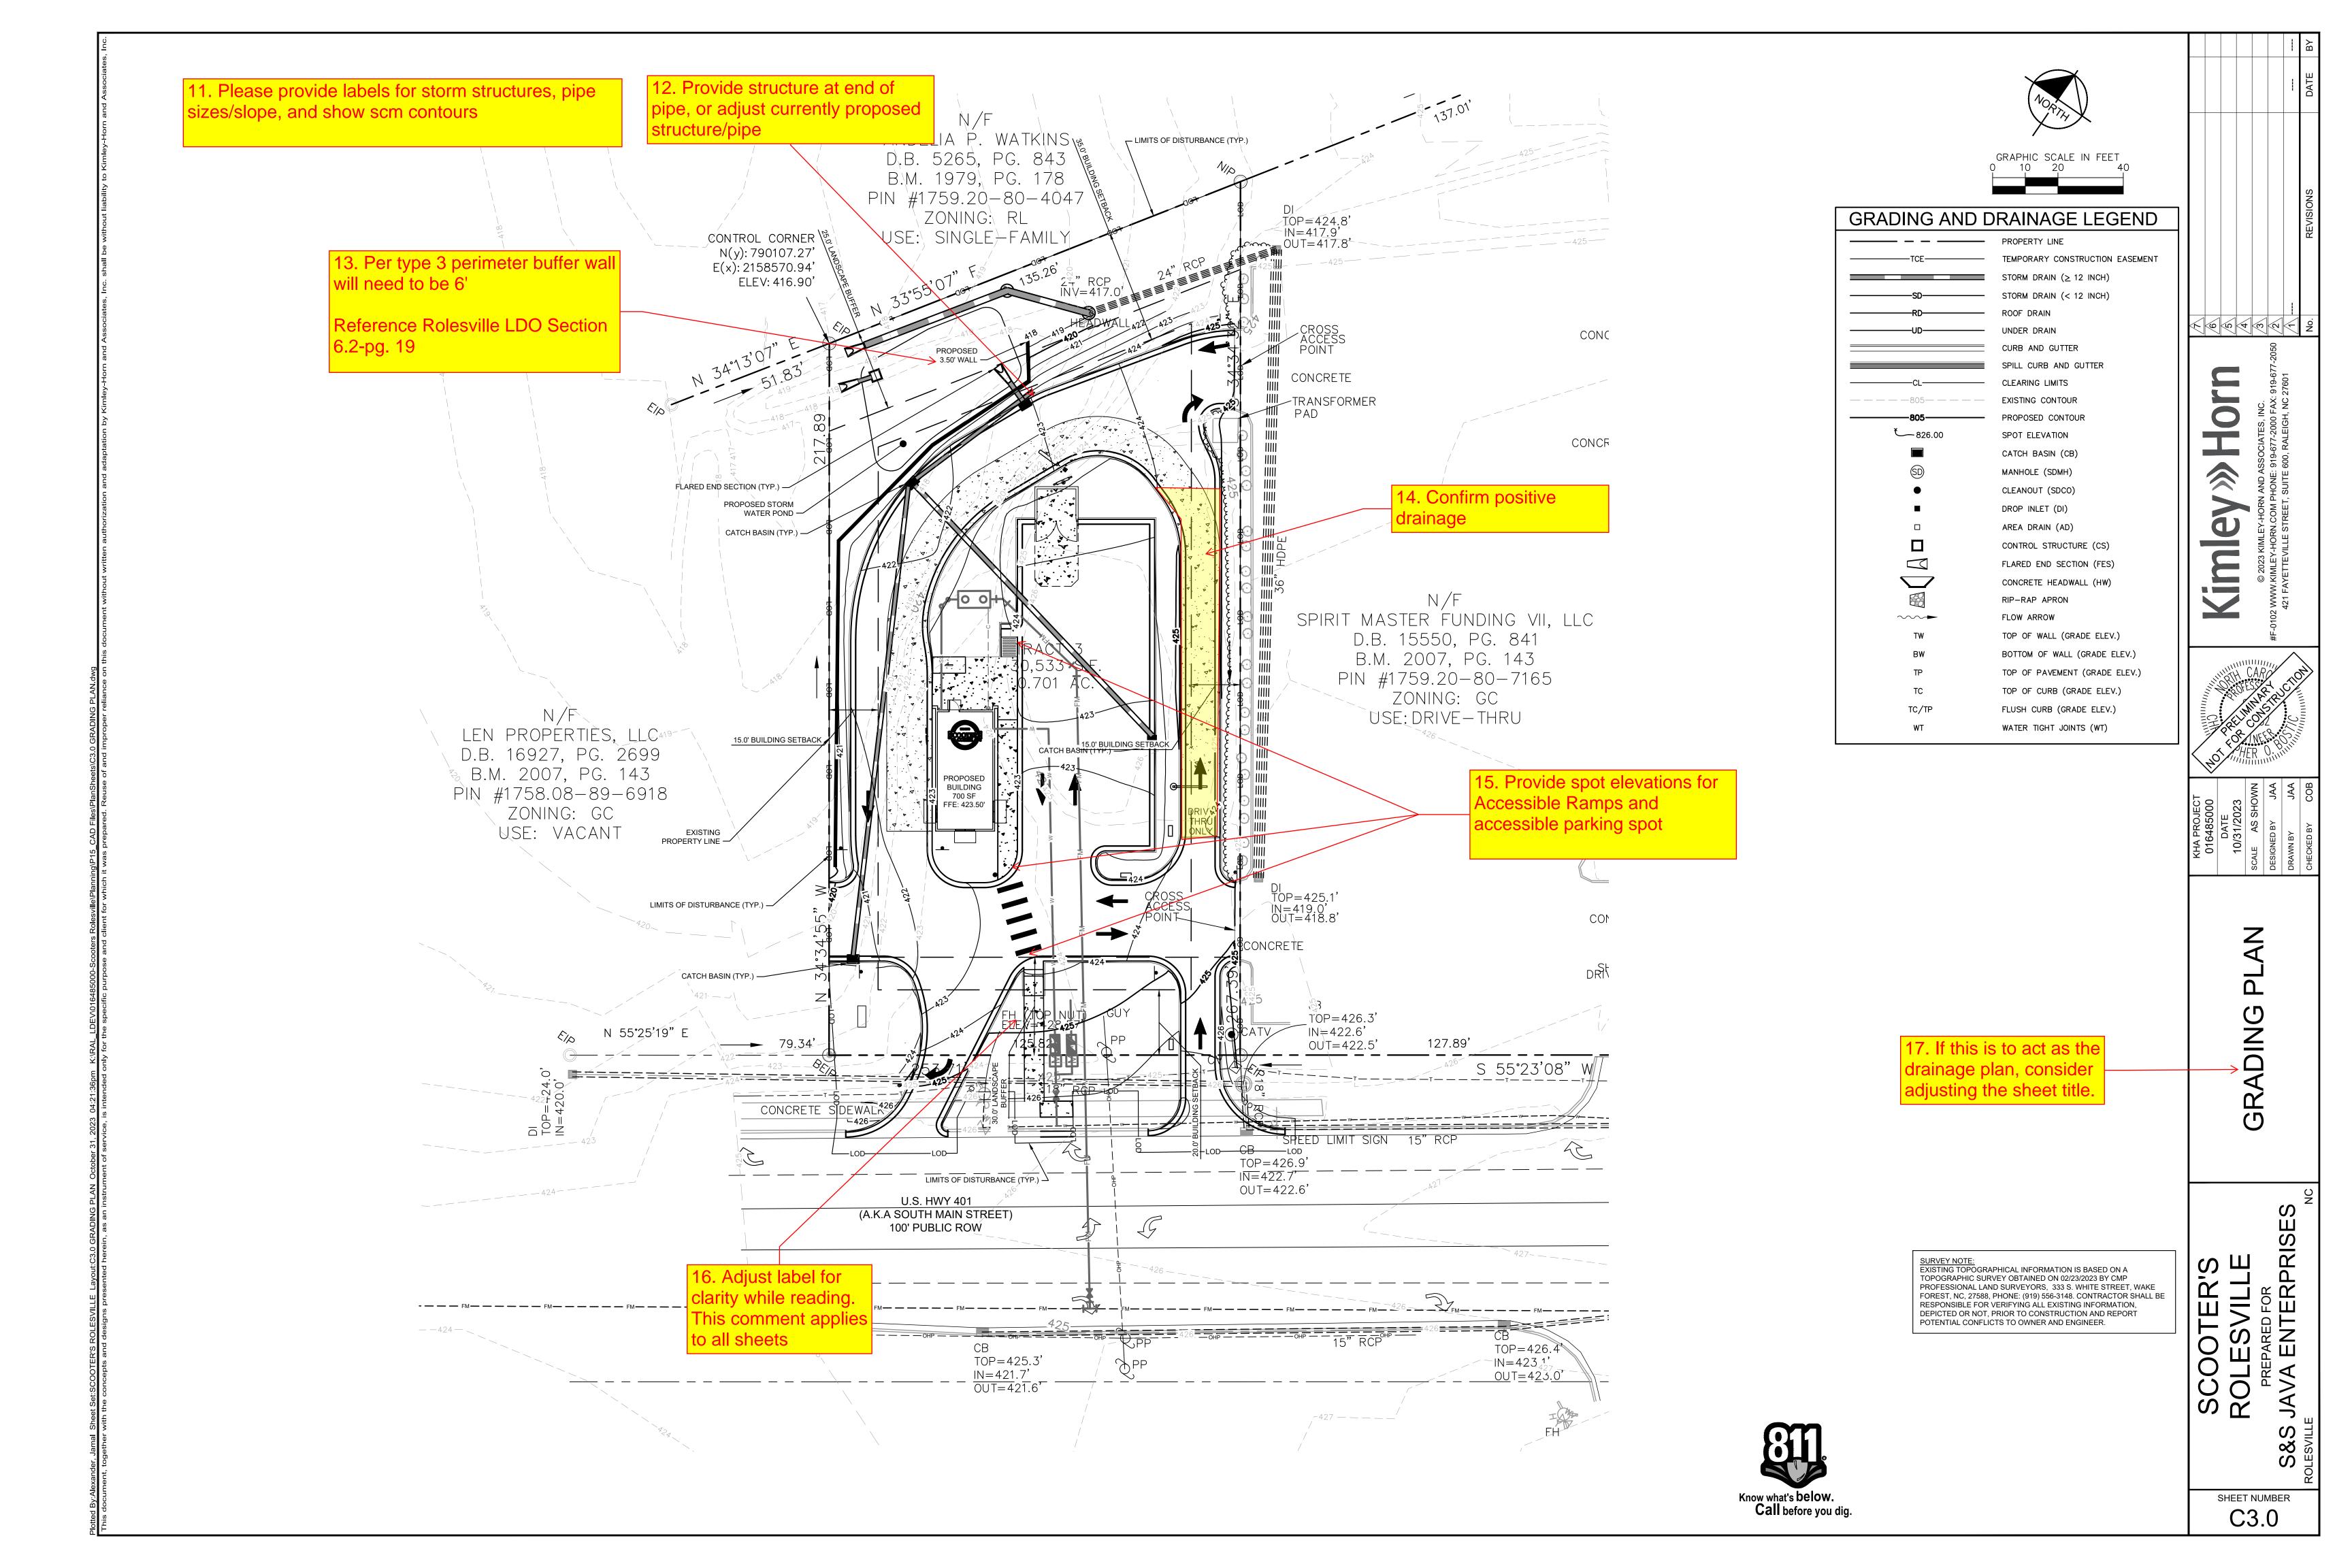

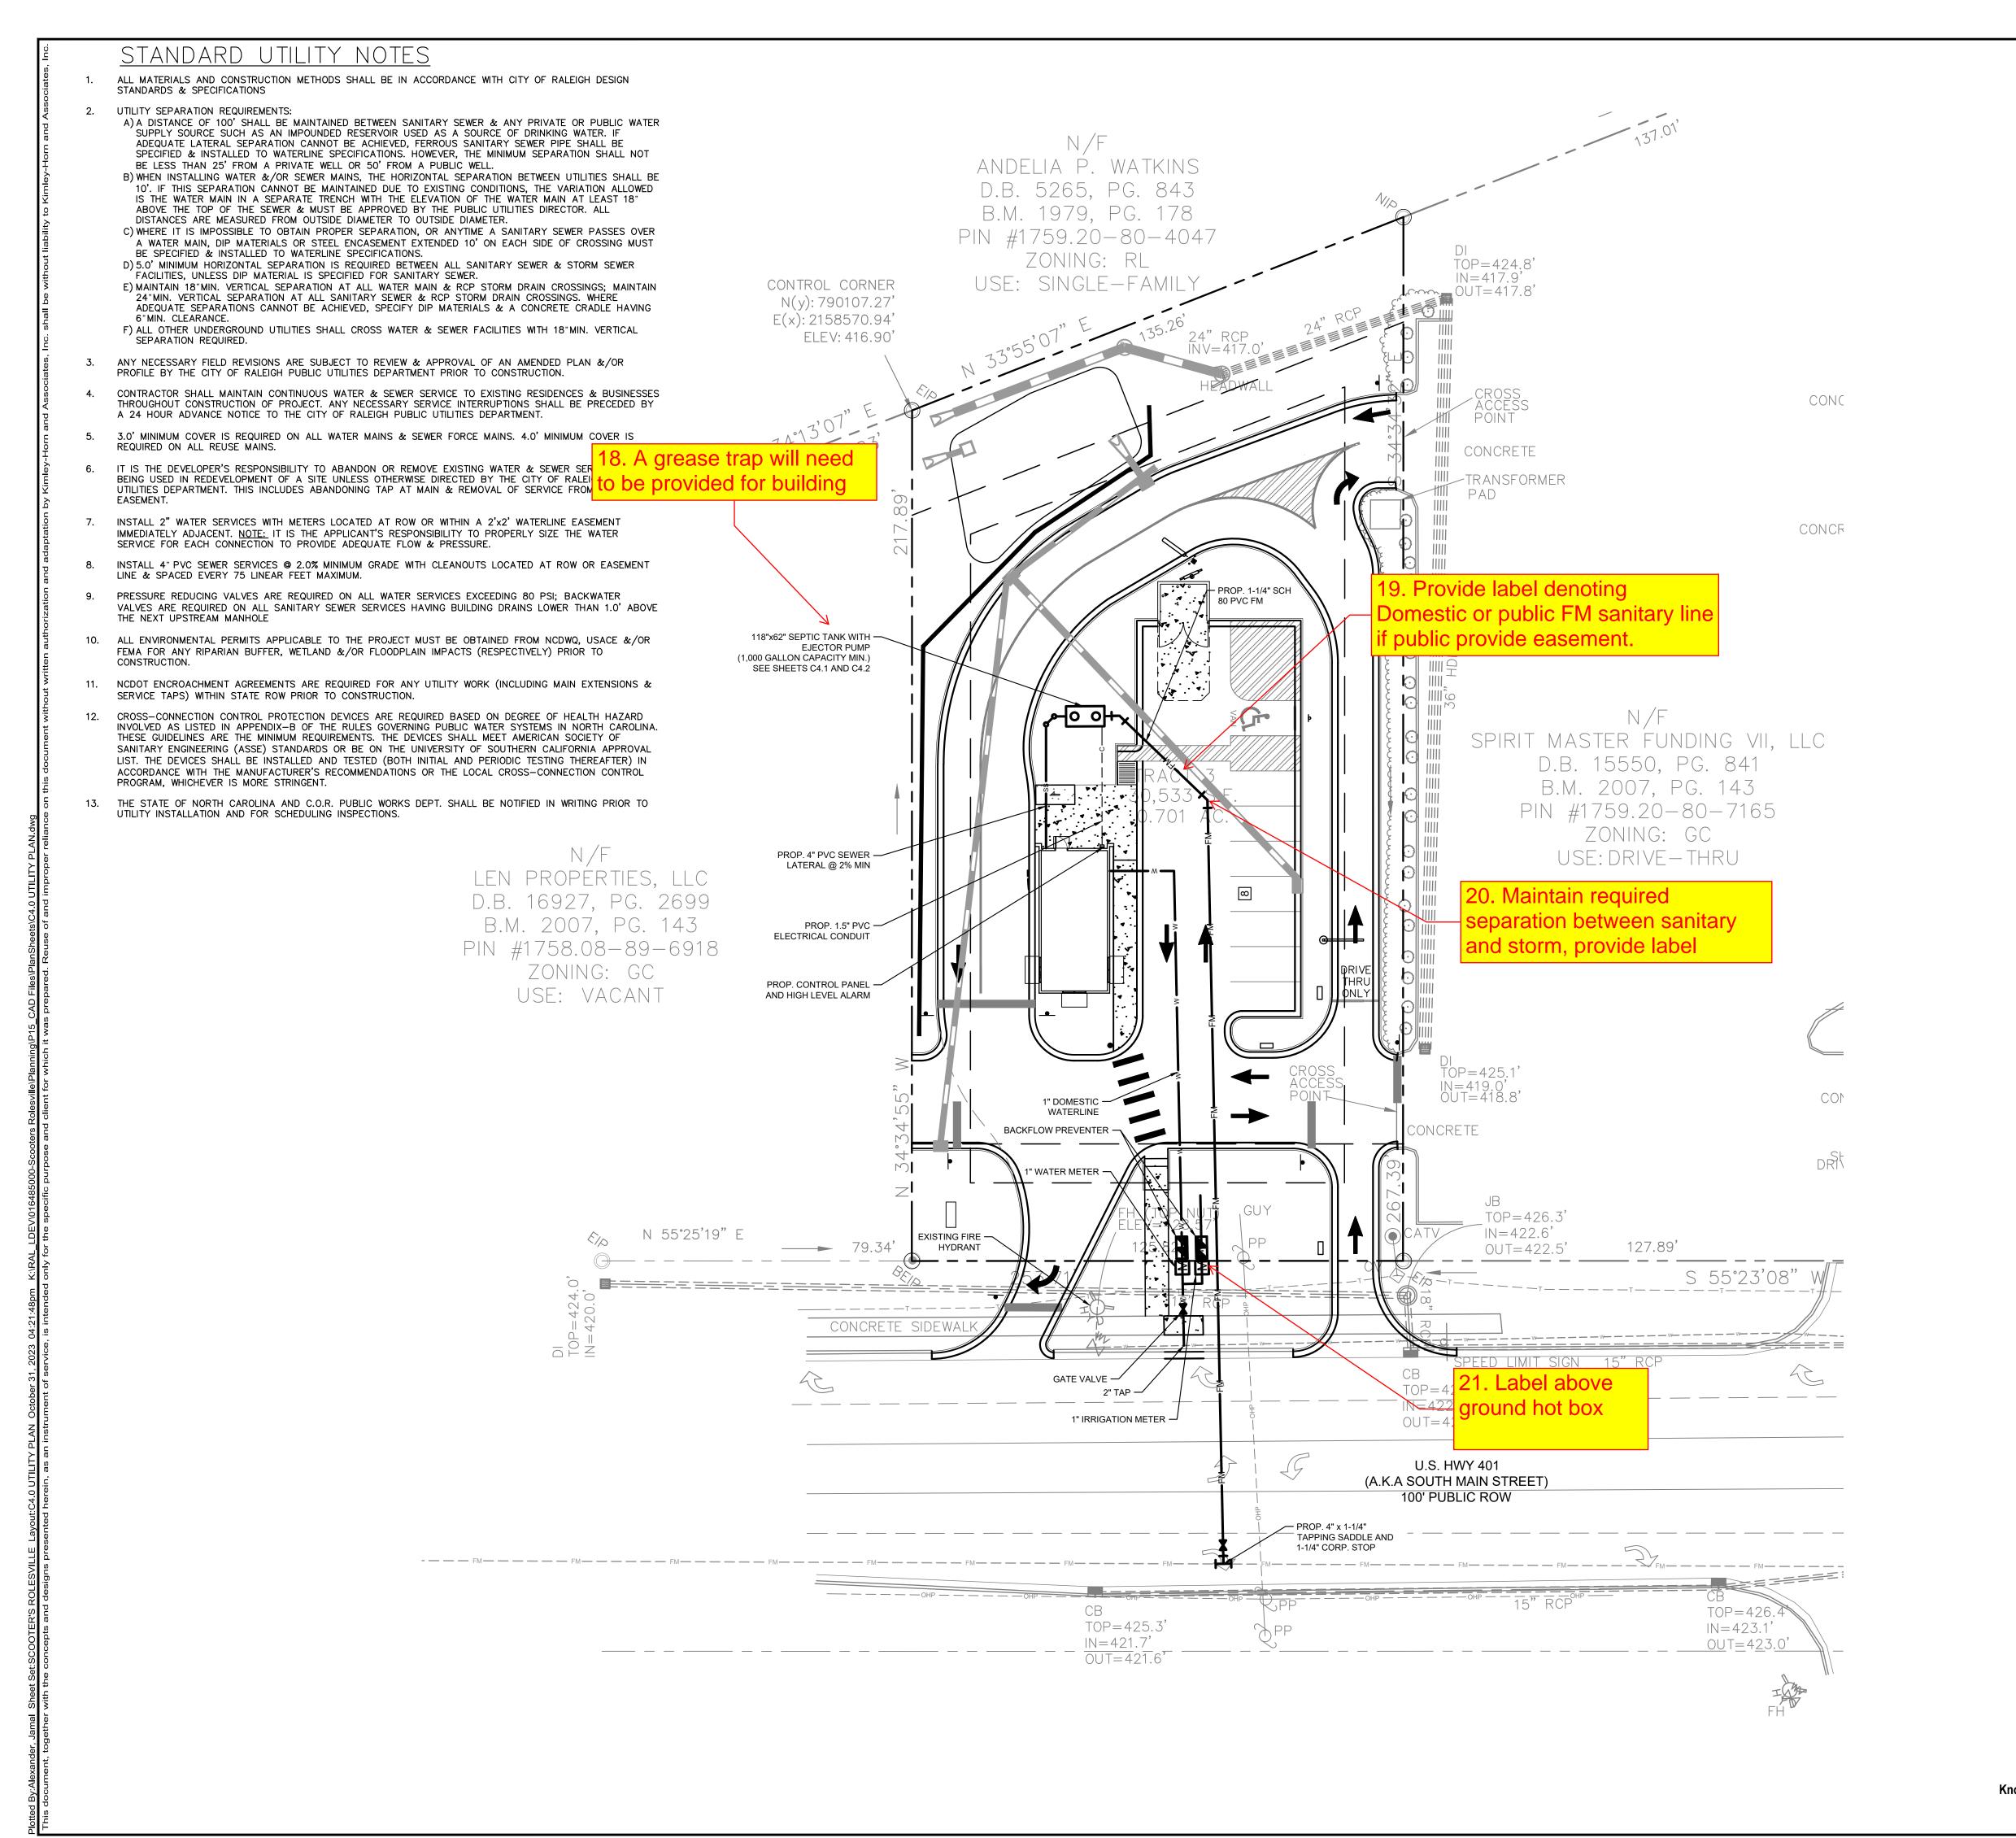



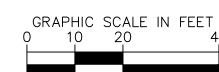

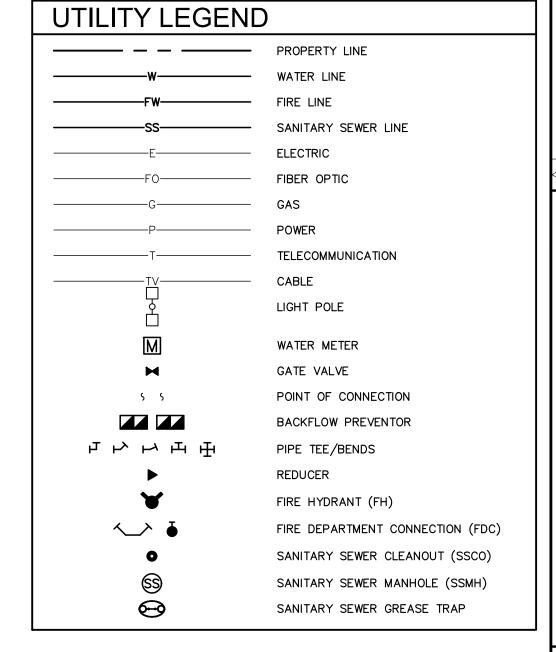

### STANDARD UTILITY NOTES (CONT.)

- 14. TRAFFIC CONTROLS FOR ANY UTILITY WORK WITHIN THE PUBLIC RIGHT-OF-WAY SHALL BE IN COMPLIANCE WITH STANDARDS OF THE NORTH CAROLINA MANUAL ON UNIFORM TRAFFIC CONTROL DEVICES.
- 15. IN THE EVENT AN ITEM IS NOT COVERED BY THESE PLANS, THEN THE STANDARDS AND SPECIFICATIONS CONTAINED IN THE CITY OF RALEIGH PUBLIC UTILITIES DEPARTMENT HANDBOOK COVERING SUCH ITEMS SHALL APPLY.
- 16. IF CITY OF RALEIGH WATER AND SANITARY SEWER PERMITS ARE REQUIRED,
- 17. LOCATIONS AND SIZES OF EXISTING WATER AND SEWER LINES SHOWN ON THESE PLANS WITHIN THE PROPERTY LIMITS OF THE SITE ARE ASSUMED BASED ON SURVEY OF SURFACE FEATURES (MANHOLES, VALVES, VAULTS, METERS, ETC.) PREPARED BY GSC SURVEYING, INC., 4072 BARRETT DRIVE, RALEIGH, N.C. 27609. IT IS SOLELY THE RESPONSIBILITY OF THE CONTRACTOR TO FIELD VERIFY THE HORIZONTAL AND VERTICAL LOCATION OF THE EXISTING UTILITIES PRIOR TO COMMENCING WORK. ANY DEVIATIONS FROM WHAT IS INDICATED ON THESE PLANS SHALL BE REPORTED TO THE THE DEVELOPER AND ENGINEER, IN WRITING,
- 18. CONTRACTOR SHALL PROVIDE A MEANS TO KEEP ALL NEW PIPING ISOLATED FROM EXISTING PIPING UNTIL ALL NEW PIPING HAS BEEN TESTED, AND ACCEPTED FOR SERVICE.
- 19. EXISTING UTILITIES SHALL BE PROTECTED DURING ALL CONSTRUCTION.
- 20. THE SITE UTILITY CONTRACTOR SHALL PROVIDE ALL MATERIALS AND APPURTENANCES NECESSARY FOR COMPLETE INSTALLATION OF THE UTILITIES. ALL PUBLIC PIPE, STRUCTURES, AND FITTINGS SHALL BE INSPECTED BY THE CITY INSPECTOR PRIOR TO BEING COVERED. THE INSPECTOR MUST ALSO BE PRESENT DURING DISINFECTION AND PRESSURE TESTING OF ALL MAINS. THE CONTRACTOR'S BID PRICE SHALL INCLUDE ALL INSPECTION FEES.
- 21. UTILITY WORK SHALL BE INSPECTED AND ACCEPTED BY CITY OF RALEIGH PRIOR TO PLACING INTO SERVICE.
- 22. THERE SHALL BE A MINIMUM 3' CLEAR DISTANCE AROUND ALL FIRE HYDRANTS.
- 23. THE CONTRACTOR SHALL BE RESPONSIBLE FOR PROVIDING "AS—BUILT" PLANS, PER CITY OF RALEIGH REQUIREMENTS, TO THE ENGINEER SHOWING THE LOCATION OF WATER AND SEWER SERVICES AND ANY DEVIATIONS FROM PLANS MADE DURING CONSTRUCTION. THE ENGINEER WILL PROVIDE THESE RECORD PLANS TO THE CITY OF RALEIGH.

SURVEY NOTE:
EXISTING TOPOGRAPHICAL INFORMATION IS BASED ON A
TOPOGRAPHIC SURVEY OBTAINED ON 02/23/2023 BY CMP
PROFESSIONAL LAND SURVEYORS, 333 S. WHITE STREET, WAKE
FOREST, NC, 27588, PHONE: (919) 556-3148. CONTRACTOR SHALL BE
RESPONSIBLE FOR VERIFYING ALL EXISTING INFORMATION,
DEPICTED OR NOT, PRIOR TO CONSTRUCTION AND REPORT
POTENTIAL CONFLICTS TO OWNER AND ENGINEER.



ES, INC.
2000 FAX: 919-677-2050
2.EIGH, NC 27601

© 2023 KIMLEY-HORN AND ASSOCIAT #F-0102 WWW.KIMLEY-HORN.COM PHONE: 919-677-421 FAYETTEVILLE STREET, SUITE 600, RAL



SCALE AS SHOWN
DESIGNED BY JAA
DRAWN BY JAA

TILITY PLAN

OLESVILLE
PREPARED FOR
VA ENTERPRISES

PREF S&S JAVA

SHEET NUMBER C4.0

CONDUIT SEAL -(TO CONTROL PANEL) - SPLICE BOX (NEMA 4X) 24" DIA. PVC RISER WITH 24" -GASKETED FIBERGLASS LID — HANGING DISCHARGE ASSEMBLY SLOPE GRADE AWAY — FROM RISERS (TYP.) EFFLUENT DISCHARGE (1.25" SCH 80) 24" DIA. FRTA24-RVF — PVC RISER ADAPTER - HIGH PRESSURE FLOAT SWITCH — FLEX HOSE 4" INLET WITH — LEVEL CONTROL FLOAT ASSEMBLY **BOOTED OPENING** - BRASS CHECK VALVE — SANITARY TEE — VAULT INLET PORTS 4" SCH 40 PVC — SUPPORTS ROTH 1000 GAL MODEL RMT-1000E - FILTER CARTRIDGE — 48" BIOTUBE PUMP

MECHANICAL SECTION VIEW


C4.1

SCALE: NTS

PROPOSED STEP SYSTEM SHALL BE EQUIPPED WITH AN "ORENCO S1" CONTR PANEL OR APPROVED EQUAL. CONTACT MICHAEL CLAYTON (MCLAYTON@AQWA.NET, 252-292-1667) FOR STEP SYSTEM SPECIFICATIONS.

SEPTIC TANK GENERAL INFORMATION					
AVERAGE DAILY FLOW	306 GPD				
TANK	1000 GAL ROTH TANK				
TANK DIMENSIONS	118"x62"x52"				
DISCHARGE PIPING	1.25"Ø SCH 80 PVC				
CONTROL PANEL	ORENCO S1				
HORSEPOWER	1 HP (NON-OVERLOADING OVER ENTIRE PUMP CURVE)				
VOLTAGE/PHASE/CYCLES	240 V / 1 PHASE / 60 HZ				
PUMP	ORENCO PF100511				
PRIMARY LEVEL SENSING METHOD	FLOATS (3)				
FLOAT TYPE	MF2P, 21 V				
FLOAT SETTINGS	9", 12" (FROM TOP OF TANK)				
FLOAT FUNCTIONS	HIGH LEVEL, ON/OFF				

### **Pump Curves**

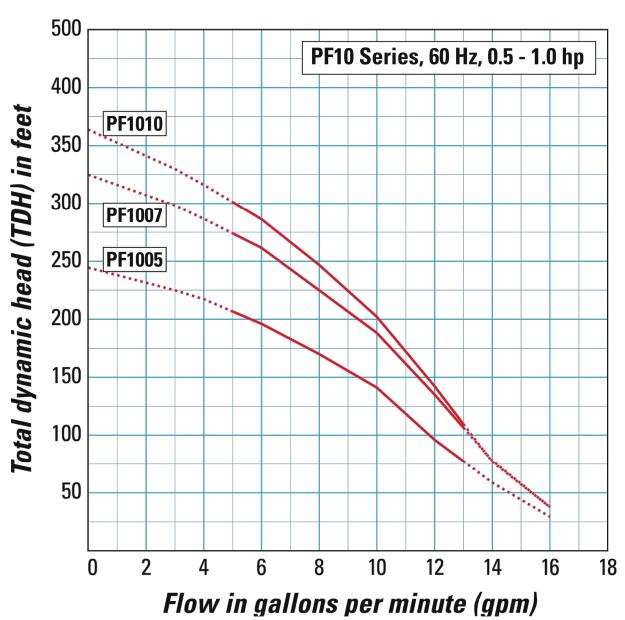


MECHANICAL

SHEET NUMBER

C4.1

SURVEY NOTE:
EXISTING TOPOGRAPHICAL INFORMATION IS BASED ON A
TOPOGRAPHIC SURVEY OBTAINED ON 02/23/2023 BY CMP
PROFESSIONAL LAND SURVEYORS, 333 S. WHITE STREET, WAKE FOREST, NC, 27588, PHONE: (919) 556-3148. CONTRACTOR SHALL BE RESPONSIBLE FOR VERIFYING ALL EXISTING INFORMATION, DEPICTED OR NOT, PRIOR TO CONSTRUCTION AND REPORT POTENTIAL CONFLICTS TO OWNER AND ENGINEER.



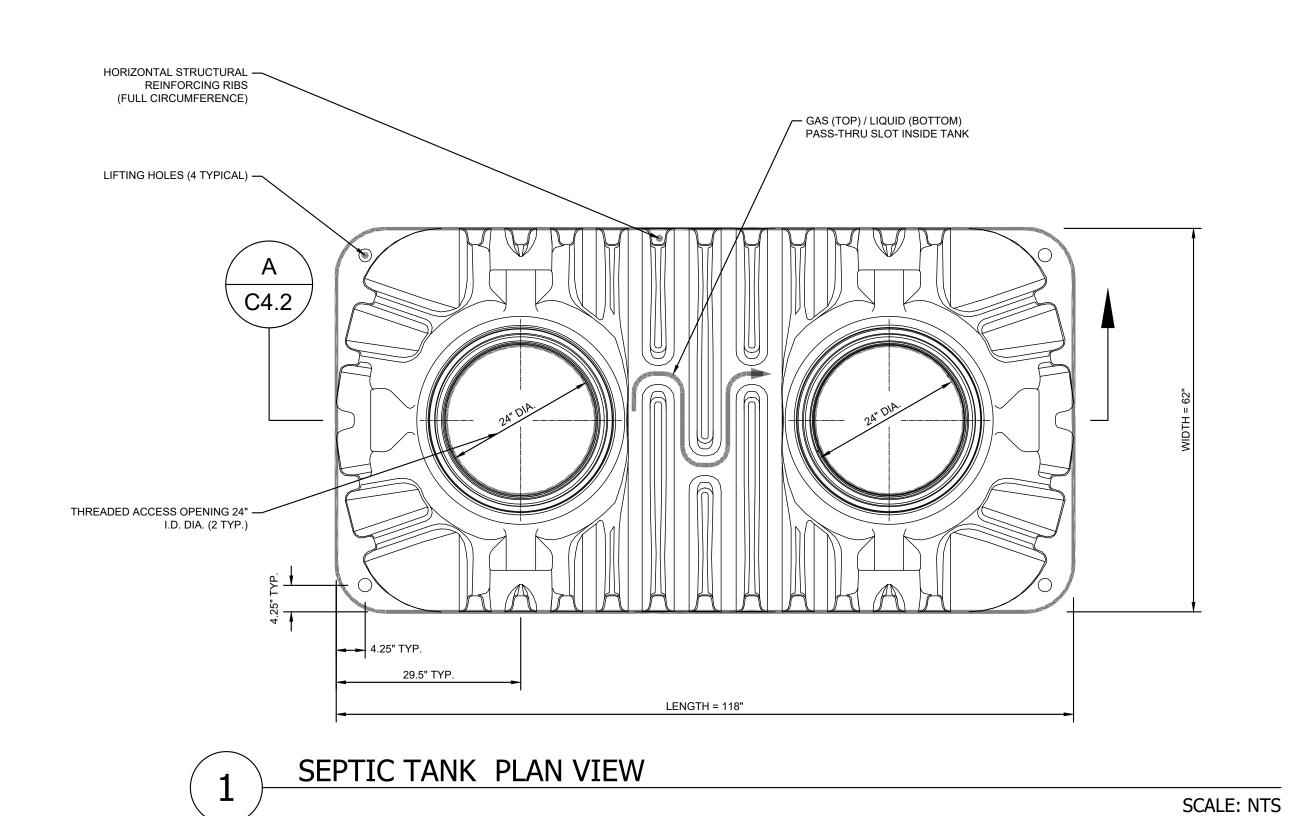

NLET PORT 597
OUTLET PORT 599

LENGTH = 1187

2 SEPTIC TANK ELEVATION VIEW

SCALE: NTS

THREADED ACCESS
OPENING
24" I.D. DIA.

A0" LIQUID LEVEL

A0" LIQUID LEVEL

A0" LIQUID LEVEL

PARTITION WALL

PARTITION WALL

1/3 TANK LENGTH

A SEPT C4.2

SEPTIC TANK SECTION VIEW

SCALE: NTS

SURVEY NOTE:
EXISTING TOPOGRAPHICAL INFORMATION IS BASED ON A
TOPOGRAPHIC SURVEY OBTAINED ON 02/23/2023 BY CMP
PROFESSIONAL LAND SURVEYORS, 333 S. WHITE STREET, WAKE
FOREST, NC, 27588, PHONE: (919) 556-3148. CONTRACTOR SHALL BE
RESPONSIBLE FOR VERIFYING ALL EXISTING INFORMATION,
DEPICTED OR NOT, PRIOR TO CONSTRUCTION AND REPORT
POTENTIAL CONFLICTS TO OWNER AND ENGINEER.




SEPTIC TANK
scale AS
DETAILS


DESIGNED BY
DRAWN BY
CHECKED BY

SCOOTER'S
ROLESVILLE
PREPARED FOR
S&S JAVA ENTERPRISES

SHEET NUMBER C4.2

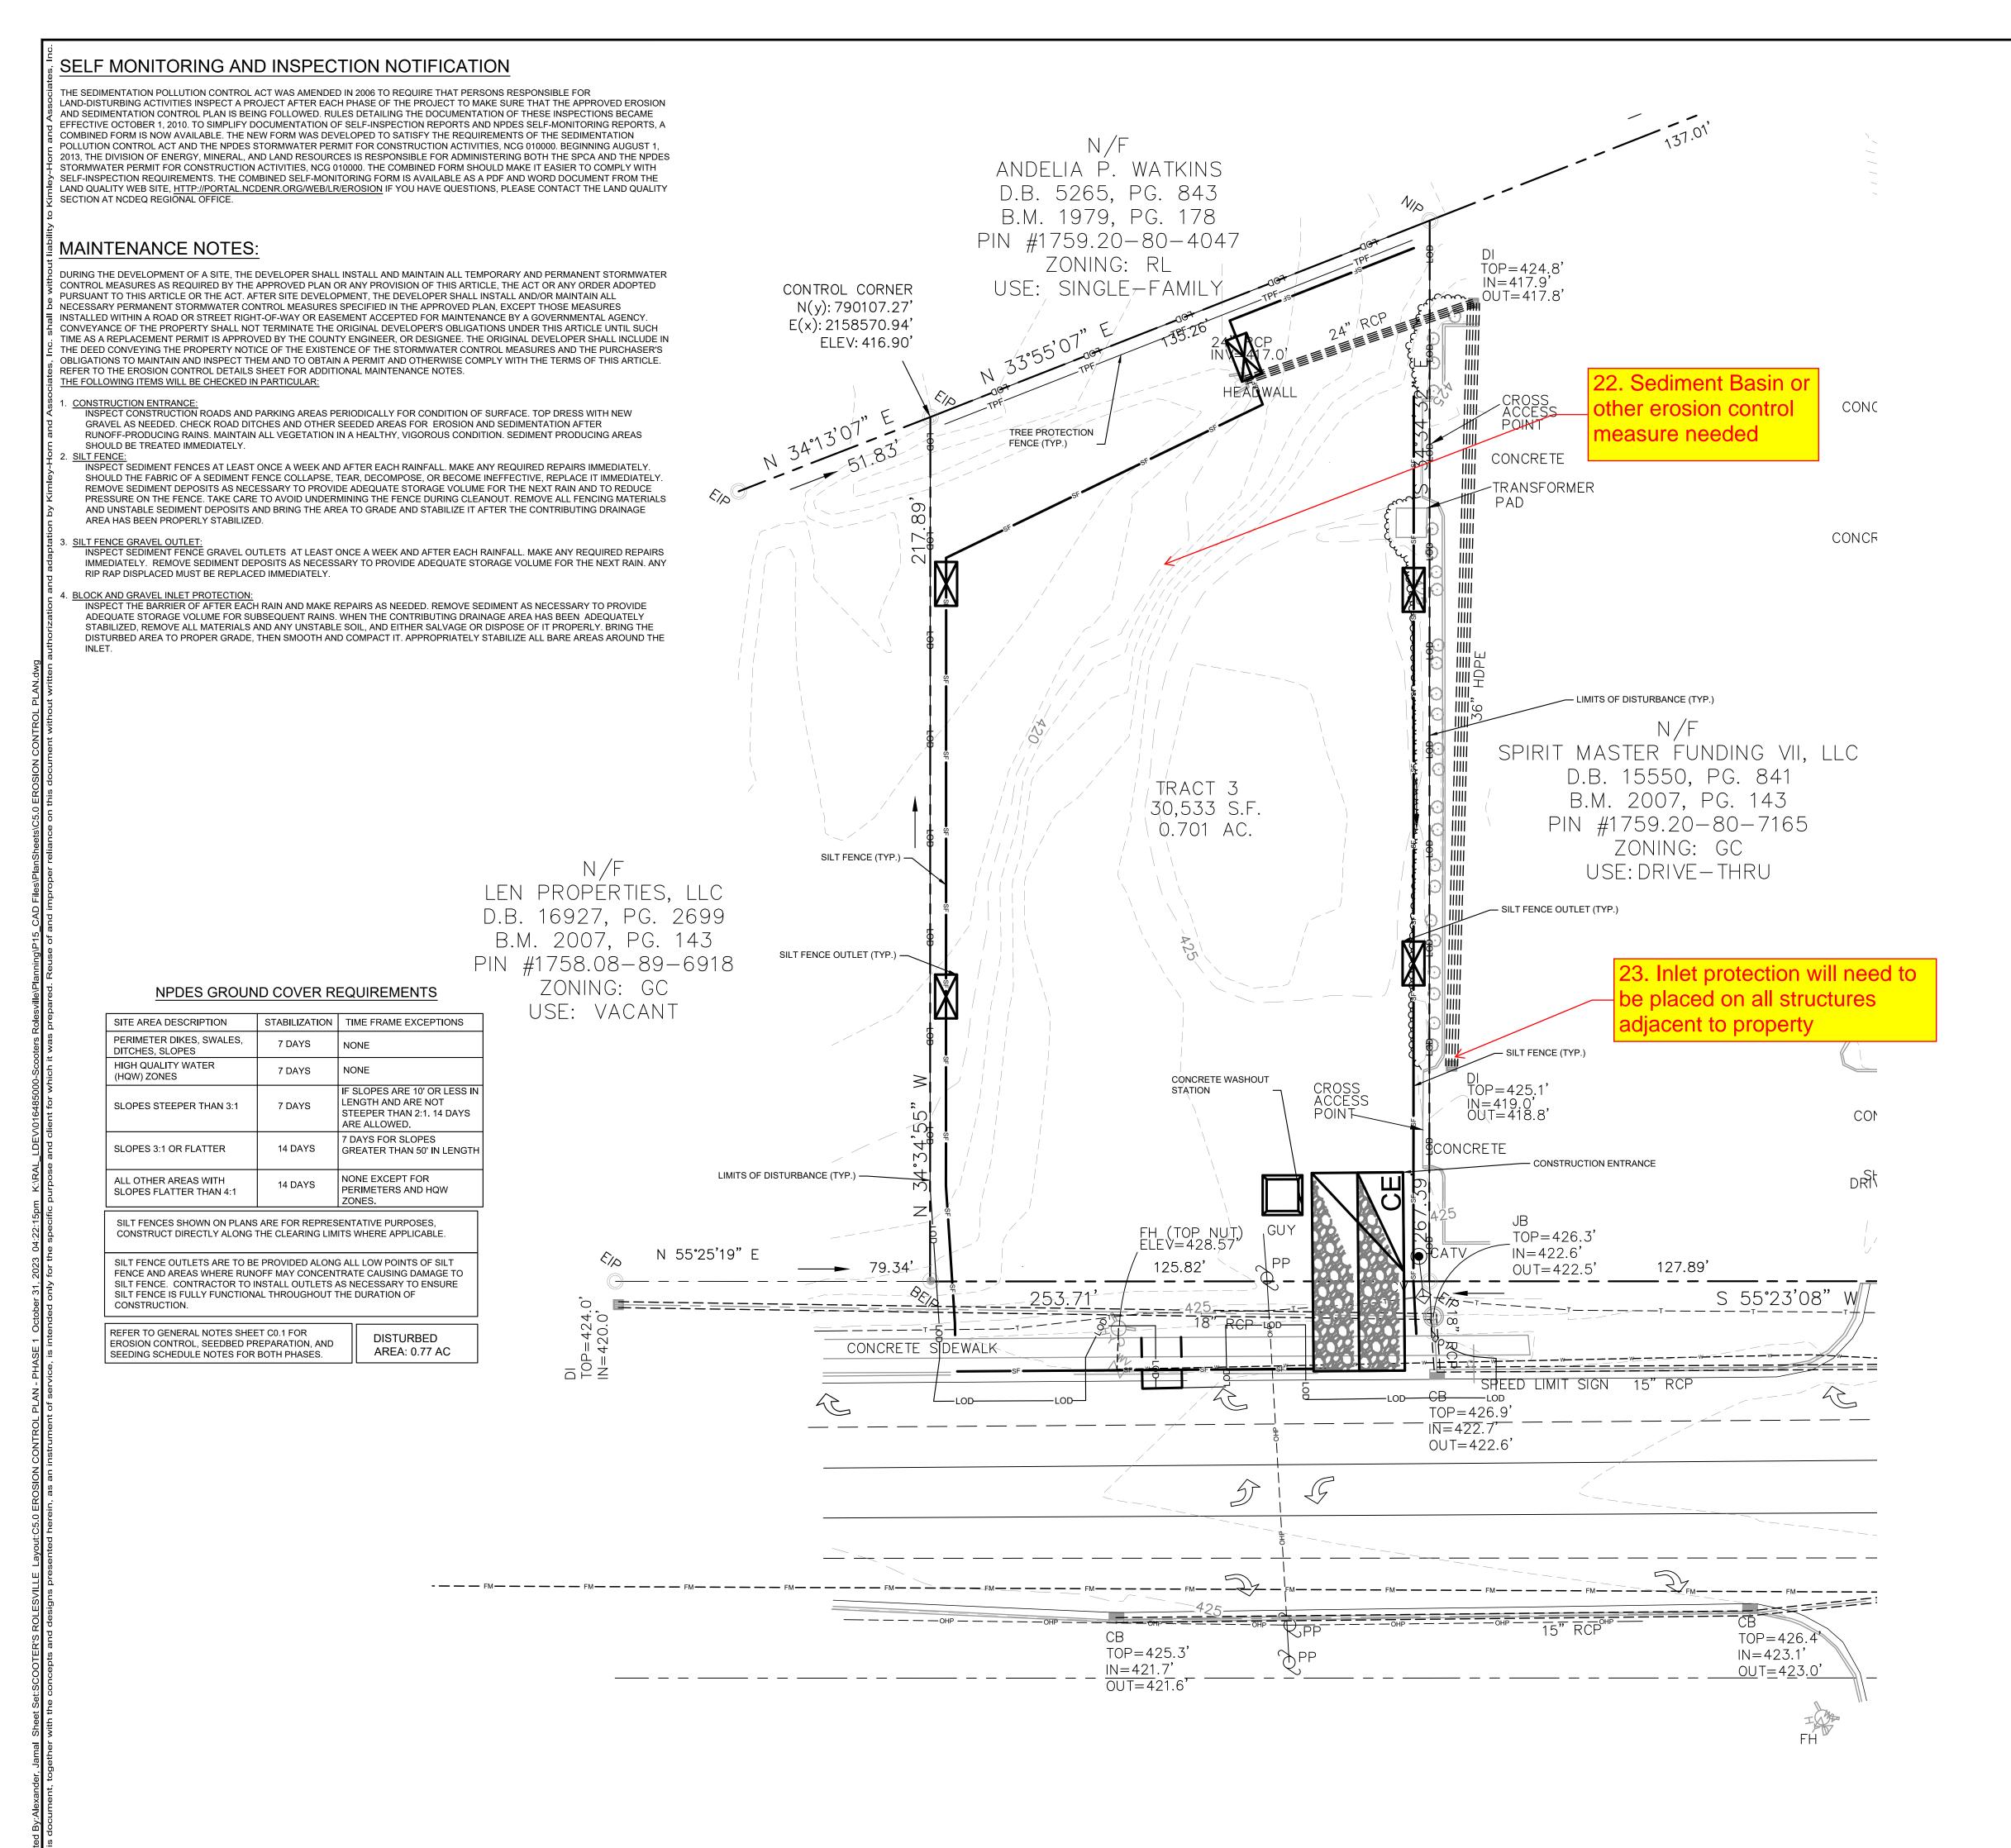



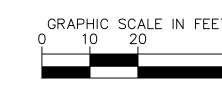

### **EROSION CONTROL LEGEND** TEMPORARY CONSTRUCTION EASEMENT CLEARING LIMITS TREE PROTECTION FENCE COMBINATION TREE PROTECTION/ → TD → TD → TEMPORARY DIVERSION DITCH → TD(CW) — CLEAN WATER DIVERSION DITCH SEDIMENT BASIN POROUS BAFFLES >>>> PUMP DISCHARGE HOSE EXISTING CONTOUR PROPOSED CONTOUR DRAINAGE AREA BOUNDARY CONSTRUCTION ENTRANCE $\geq$ SILT FENCE OUTLET CONCRETE WASHOUT STATION ROCK CHECK DAM INLET PROTECTION ROCK PIPE INLET PROTECTION TEMPORARY SLOPE DRAIN RIP-RAP OUTLET PROTECTION SILT BAG DESIGNATED AREAS TO BE STABILIZED WITHIN 7 DAYS TEMPORARY EROSION CONTROL MATTING

### PHASE 1 CONSTRUCTION SEQUENCE

- 1. THE FOLLOWING PHASE 1 CONSTRUCTION SEQUENCE IS FURNISHED AS A GENERAL GUIDE FOR PREPARATION OF A SEQUENCE OF CONSTRUCTION EVENTS.
- 2. SCHEDULE AN ON-SITE PRE-CONSTRUCTION CONFERENCE WITH WAKE COUNTY ENVIRONMENTAL CONSULTANT TO DISCUSS EROSION CONTROL MEASURES.
- 3. OBTAIN LAND-DISTURBING PERMIT FROM WAKE COUNTY.
- 4. INSTALL TEMPORARY CONSTRUCTION ENTRANCE, SILT FENCE, INLET PROTECTION, , TREE PROTECTION, AND OTHER MEASURES AS SHOWN ON PLANS, CLEARING ONLY AS NECESSARY TO INSTALL THESE DEVICES (SEE LOD FOR INITIAL CLEARING LIMITS). SEED, MAT, MULCH, AND ANCHOR DIVERSION DITCHES AND BASIN IMMEDIATELY AFTER CONSTRUCTION AS APPROPRIATE.
- 5. CALL FOR ON—SITE INSPECTION BY WAKE COUNTY ENVIRONMENTAL CONSULTANT ONCE ALL EROSION CONTROL MEASURES ARE INSTALLED. OBTAIN CERTIFICATE OF COMPLIANCE FROM WAKE COUNTY
- 6. ONCE CERTIFICATE OF COMPLIANCE HAS BEEN OBTAINED, APPLY FOR NCDEQ eNOI ON NCDEO WERSITE
- 7. UPON APPROVAL, CLEARING AND DEMOLITION MAY BEGIN. MAINTAIN ALL EROSION CONTROL MEASURES SHALL BE RESTORED TO ORIGINAL DIMENSIONS WHEN SEDIMENT ACCUMULATES TO 50% OF DESIGN DEPTH.
- 8. INSPECT AND REPAIR EROSION CONTROL MEASURES AFTER EVERY RAINFALL EVENT OF 1/2" OR GREATER OR EVERY SEVEN (7) CALENDAR DAYS.
- 9. FOR PHASED EROSION CONTROL PLANS, CONTRACTOR SHALL MEET WITH EROSION CONTROL INSPECTOR PRIOR TO COMMENCING EACH PHASE OF EROSION CONTROL MEASURES. SEED AND MULCH DENUDED AREA WITHIN 15 CALENDAR DAYS AFTER ANY PHASE OF GRADING. MAINTAIN SOIL EROSION CONTROL MEASURES UNTIL PERMANENT GROUND COVER IS ESTABLISHED.
- 10. ALL EROSION CONTROL MEASURES SHALL BE CONSTRUCTED IN ACCORDANCE WITH THE NCDENR EROSION AND SEDIMENT CONTROL PLANNING AND DESIGN MANUAL, U.S. DEPARTMENT OF AGRICULTURE, AND TOWN OF CARY EROSION CONTROL ORDINANCE.
- 11. REFER TO SHEET CO.1 GENERAL NOTES FOR GENERAL EROSION CONTROL NOTES AND MAINTENANCE.

LIMITS OF DISTURBANCE: 0.77 AC

SURVEY NOTE:
EXISTING TOPOGRAPHICAL INFORMATION IS BASED ON A
TOPOGRAPHIC SURVEY OBTAINED ON 02/23/2023 BY CMP
PROFESSIONAL LAND SURVEYORS, 333 S. WHITE STREET, WAKE
FOREST, NC, 27588, PHONE: (919) 556-3148. CONTRACTOR SHALL BE
RESPONSIBLE FOR VERIFYING ALL EXISTING INFORMATION,
DEPICTED OR NOT, PRIOR TO CONSTRUCTION AND REPORT
POTENTIAL CONFLICTS TO OWNER AND ENGINEER.




© 2023 KIMLEY-HORN AND ASSOCIATES, INC 0.2023 KIMLEY-HORN AND ASSOCIATES, INC 421 FAYETTEVILLE STREET, SUITE 600, RALEIGH, N





10/31/2023
SCALE AS SHOWN
DESIGNED BY JAA
DRAWN BY JAA


ROSION CONTRO

ROLESVILLE
PREPARED FOR
AVA ENTERPRISES

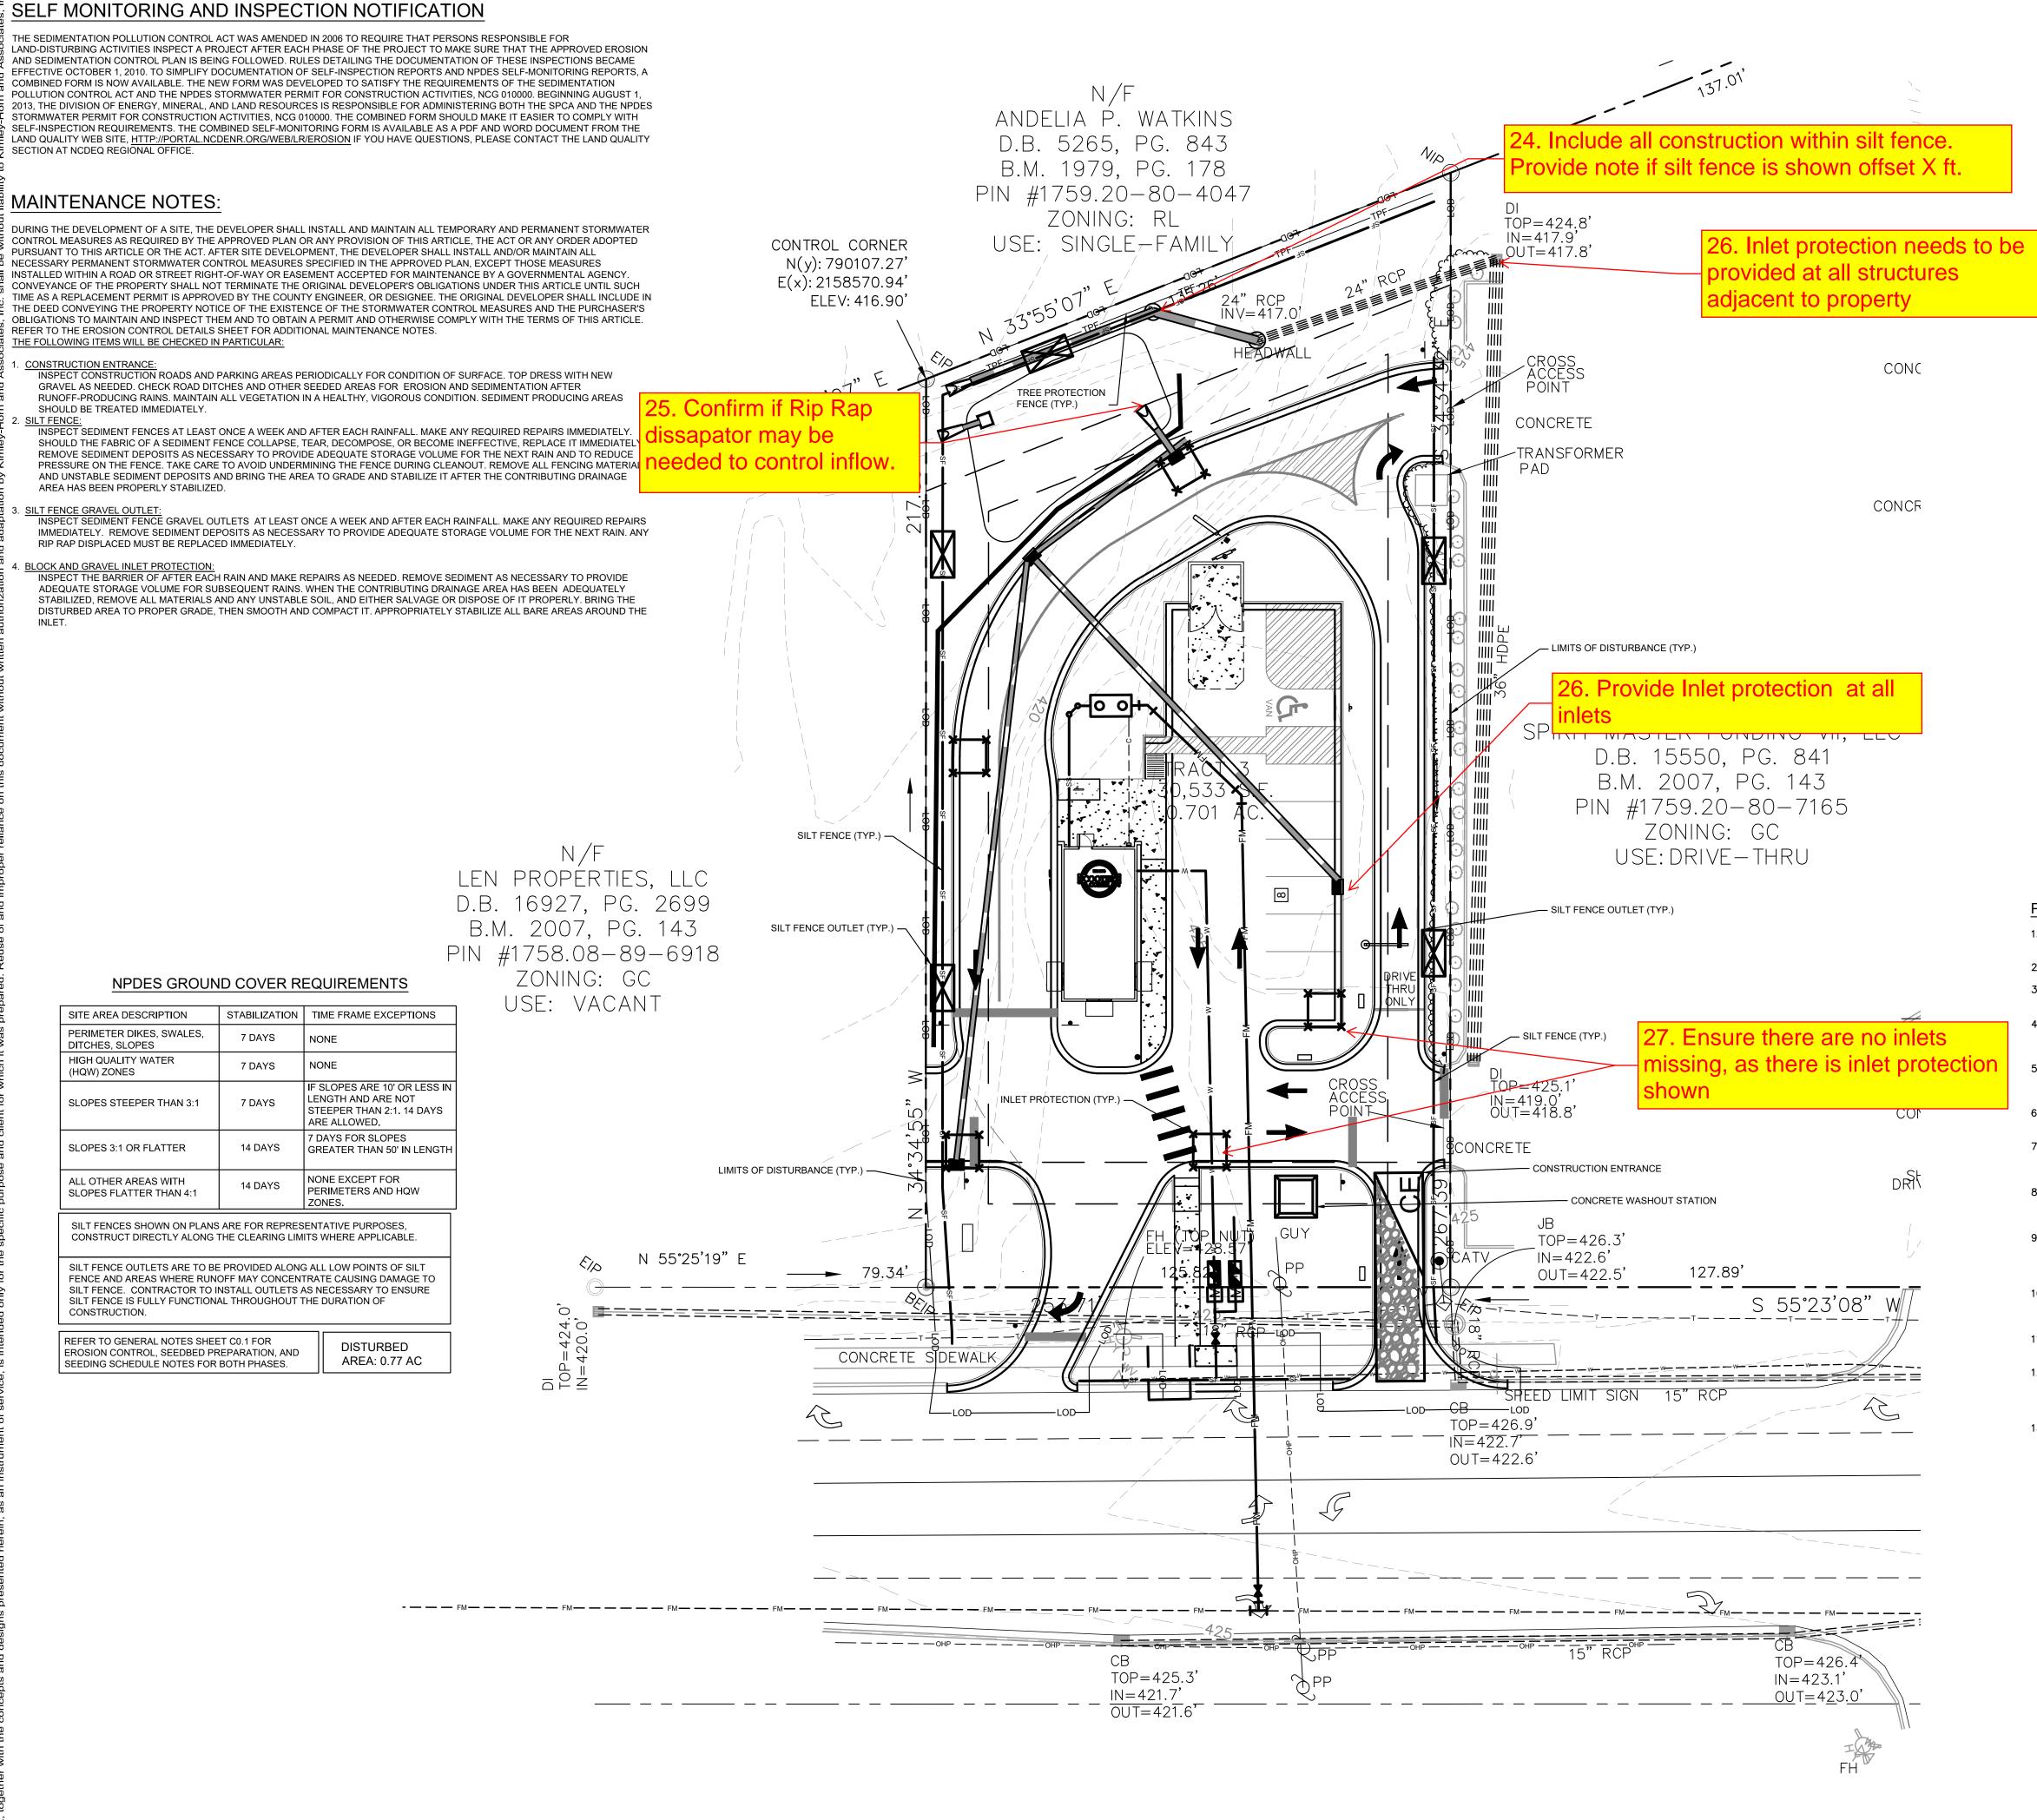

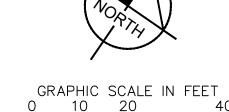

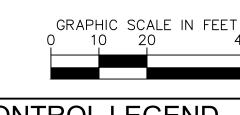

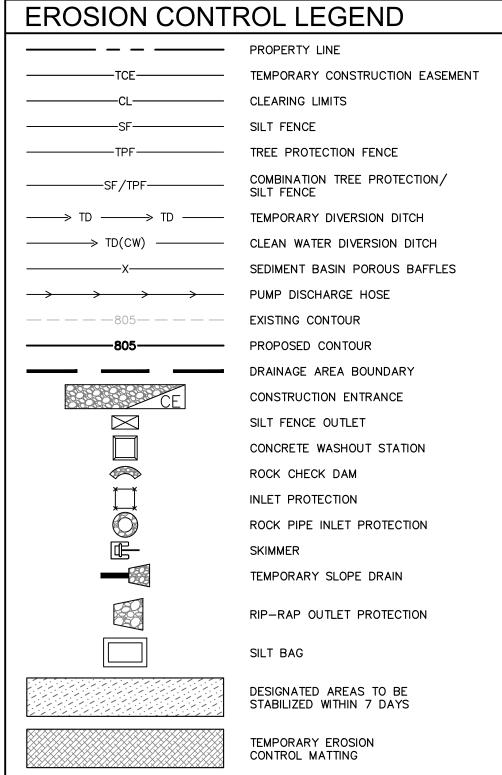

### PHASE 2 CONSTRUCTION SEQUENCE

- 1. THE FOLLOWING PHASE 2 CONSTRUCTION SEQUENCE IS FURNISHED AS A GENERAL GUIDE FOR PREPARATION OF A SEQUENCE OF CONSTRUCTION EVENTS.
- 2. MAINTAIN CONSTRUCTION ENTRANCE AND SILT FENCE.
- 3. CALL FOR ON-SITE INSPECTION BY INSPECTOR ONCE ALL PHASE 2 EROSION CONTROL MEASURES ARE INSTALLED. OBTAIN CERTIFICATE OF COMPLIANCE FROM WAKE COUNTY.
- CONTRACTOR IS TO CUT AND/OR FILL AREAS TO BRING THE SITE TO THE PROPOSED GRADES SHOWN ON THE GRADING AND DRAINAGE PLANS. GRADING ACTIVITY SHALL BE LIMITED TO WITHIN THE CLEARING LIMITS. MAINTAIN ALL EROSION CONTROL MEASURES AS NECESSARY.
- 5. PROVIDE GROUND COVER ON SLOPES GREATER THAN 3:1 WITHIN 7 DAYS FOLLOWING COMPLETION OF ANY PHASE OF GRADING. PROVIDE GROUND COVER TO ALL OTHER AREAS WITHIN 14 DAYS FOLLOWING COMPLETION OF ANY PHASE OF GRADING OR INACTIVITY.
- 6. INSTALL STORM DRAINAGE AND PROTECT INLETS WITH BLOCK AND GRAVEL INLET CONTROLS, SEDIMENT TRAPS, OR OTHER APPROVED MEASURES AS SHOWN ON THE PLAN.
- 7. STABILIZE SITE AS AREAS ARE BROUGHT UP TO FINISH GRADE WITH VEGETATION, PAVING, DITCH LININGS, ETC. SEED AND MULCH DENUDED AREAS PER GROUND STABILIZATION TIME
- 8. INSPECT AND REPAIR EROSION CONTROL MEASURES AFTER EVERY RAINFALL EVENT OF 1/2" OR
- GREATER OR EVERY SEVEN (7) CALENDAR DAYS.
- 9. ALL EROSION CONTROL MEASURES SHALL BE CONSTRUCTED IN ACCORDANCE WITH THE NCDENR EROSION AND SEDIMENT CONTROL PLANNING AND DESIGN MANUAL, U.S. DEPARTMENT OF AGRICULTURE, AND CITY OF GREENVILLE EROSION CONTROL ORDINANCE.
- 10. REFER TO SHEET CO.1 GENERAL NOTES FOR GENERAL EROSION CONTROL NOTES AND MAINTENANCE.
- 11. ALL EROSION CONTROL MEASURES TO REMAIN IN PLACE UNTIL +/- 80% STABILIZATION IS ACHIEVED.
- 12. ONCE CONSTRUCTION IS COMPLETE AND ENTIRE SITE IS STABILIZED, CALL FOR FINAL INSPECTION BY WAKE COUNTY ENVIRONMENTAL CONSULTANT. IF APPROVED, REMOVE REMAINING EROSION CONTROL MEASURES. ALL REMAINING PERMANENT EROSION CONTROL DEVICES SHOULD NOW BE INSTALLED.
- 13. WHEN VEGETATION HAS BECOME ESTABLISHED, CALL FOR A FINAL INSPECTION BY WAKE COUNTY ENVIRONMENTAL CONSULTANT. OBTAIN A CERTIFICATE OF COMPLETION.

LIMITS OF DISTURBANCE: 0.77 AC

SURVEY NOTE:
EXISTING TOPOGRAPHICAL INFORMATION IS BASED ON A
TOPOGRAPHIC SURVEY OBTAINED ON 02/23/2023 BY CMP
PROFESSIONAL LAND SURVEYORS, 333 S. WHITE STREET, WAKE
FOREST, NC, 27588, PHONE: (919) 556-3148. CONTRACTOR SHALL BE
RESPONSIBLE FOR VERIFYING ALL EXISTING INFORMATION,
DEPICTED OR NOT, PRIOR TO CONSTRUCTION AND REPORT
POTENTIAL CONFLICTS TO OWNER AND ENGINEER.



677-2050 2 | REVISIONS | REVISIONS

© 2023 KIMLEY-HORN AND ASSOCIATES, INC.

WWW.KIMLEY-HORN.COM PHONE: 919-677-2000 FAX:
21 FAYETTEVILLE STREET, SUITE 600, RALEIGH, NC.




10/31/2023
SCALE AS SHOWN
DESIGNED BY JAA
DRAWN BY JAA

ROSION CONTROPLANTE PLAN - PHASE 2

ROLESVILLE
PREPARED FOR
JAVA ENTERPRISES

SHEET NUMBER
C5.1

∞

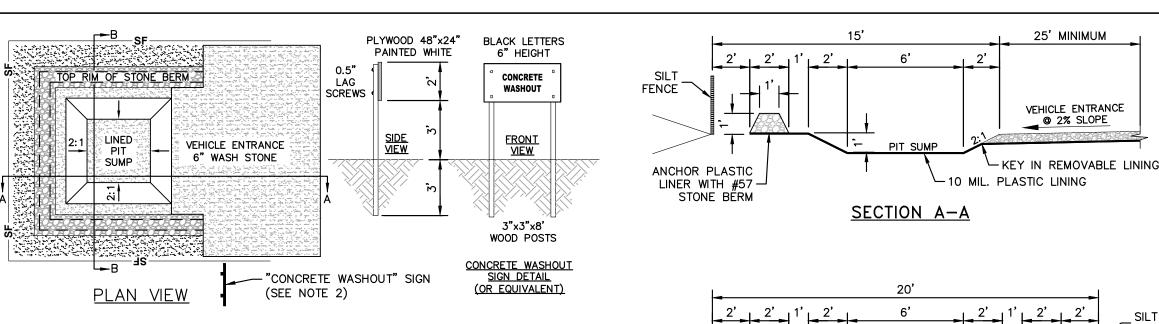

FENCE ANCHOR PLASTIC -LINER WITH #57 10 MIL. PLASTIC LINING STONE BERM SECTION B-B

KHA DETAIL NO: 01.102.R01

25' MINIMUM

@ 2% SLOPE

TYPE PLANTING RATE RYE (GRAIN) 120 LBS/ACRE PIEDMONT JAN. 1 - MAY 1 ANNUAL LESPEDEZA (KOBE) 50 LBS/ACRE JAN. 1 - MAY 1 PIEDMONT MAY 1 - AUG. 15 GERMAN MILLET 40 LBS/ACRE PIEDMONT MAY 1 - AUG. 15 | SMALL-STEMMED SUDANGRASS | 50 LBS/ACRE PIEDMONT AUG. 15 - DEC. 30 RYE (GRAIN) 120 LBS/ACRE PIEDMONT DEC. 1 - APR. 15 RYE (GRAIN) 120 LBS/ACRE COASTAL PLAIN ANNUAL LESPEDEZA (KOBE) DEC. 1 - APR. 15 50 LBS/ACRE COASTAL PLAIN APR. 15 - AUG. 15 GERMAN MILLET 40 LBS/ACRE COASTAL PLAIN AUG. 15 - DEC. 30 RYE (GRAIN) 120 LBS/ACRE COASTAL PLAIN FEB. 15 - MAY 15 RYE (GRAIN) 120 LBS/ACRE | MOUNTAINS - ABOVE 2500 FEET FEB. 1 - MAY 1 RYE (GRAIN) 120 LBS/ACRE | MOUNTAINS - BELOW 2500 FEET FEB. 15 - MAY 15 ANNUAL LESPEDEZA (KOREAN) | 50 LBS/ACRE | MOUNTAINS - ABOVE 2500 FEET ANNUAL LESPEDEZA (KOREAN) | 50 LBS/ACRE | MOUNTAINS - BELOW 2500 FEET 40 LBS/ACRE GERMAN MILLET MOUNTAINS MAY 15 - AUG. 15 | SMALL-STEMMED SUDANGRASS | 50 LBS/ACRE MOUNTAINS AUG. 15 - DEC. 15 RYE (GRAIN) 120 LBS/ACRE MOUNTAINS

SEEDBED PREPARATION: TILL OR DISK THE PREPARED AREAS TO BE SEEDED TO A MINIMUM DEPTH OF FOUR 6. COMPLETE GRADING BEFORE PREPARING SEEDBEDS, AND INSTALL ALL NECESSARY

EROSION CONTROL PRACTICES SUCH AS, DIKES, WATERWAYS, AND BASINS. REMOVE STONES LARGER THAN THREE INCHES ON ANY SIDE, STICKS, ROOTS AND OTHER 7. IF SOILS BECOME COMPACTED DURING GRADING, LOOSEN THEM TO A DEPTH OF 6-8

NCHES USING A RIPPER, HARROW, OR CHISEL PLOW. THE USE OF AN APPROPRIATE MULCH WILL HELP ENSURE ESTABLISHMENT UNDER NORMAL CONDITIONS, AND IS ESSENTIAL TO SEEDING SUCCESS UNDER HARSH SITE

LATE WINTER THROUGH SUMMER: FOLLOW RECOMMENDATIONS OF SOIL TESTS OR APPLY 2000 LB/ACRE GROUND AGRICULTURAL LIMESTONE AND 750 LB/ACRE 10-10-10

FALL: FOLLOW RECOMMENDATIONS OF SOIL TESTS OR APPLY 2000 LB/ACRE GROUND AGRICULTURAL LIMESTONE AND 1000 LB/ACRE 10-10-10 FERTILIZER.

APPLY 4000 LB/ACRE STRAW. ANCHOR STRAW BY TACKING WITH ASPHALT, NETTING, OR A MULCH ANCHORING TOOL. A DISK WITH BLADES SET NEARLY STRAIGHT CAN BE USED AS A MULCH ANCHORING TOOL.

**MAINTENANCE:** LATE WINTER THROUGH SUMMER: REFERTILIZE IF GROWTH IS NOT FULLY ADEQUATE. RESEED, FERTILIZE AND MULCH IMMEDIATELY FOLLOWING EROSION OR OTHER DAMAGE. FALL: REPAIR AND REFERTILIZE DAMAGED AREAS IMMEDIATELY. TOPDRESS WITH 50 LB/ACRE OF NITROGEN IN MARCH. IF IT IS NECESSARY TO EXTEND TEMPORARY COVER BEYOND JUNE 15, OVERSEED WITH 50 LB/ACRE KOBE (PIEDMONT AND COASTAL PLAIN)

OR KOREAN (MOUNTAINS) LESPEDEZA IN LATE FEBRUARY OR EARLY MARCH.

REBAR FOR BAG

FILTER BAG —

CATCH BASIN -

DUMP LOOPS -

REMOVAL FROM INLET

KHA DETAIL NO: 01.104.R01

— DEFLECTOR

OUTLET

<u>INSTALLATION</u>

KHA DETAIL NO: 01.201.R0

SURVEY NOTE:
EXISTING TOPOGRAPHICAL INFORMATION IS BASED ON A

TOPOGRAPHIC SURVEY OBTAINED ON 02/23/2023 BY CMP

POTENTIAL CONFLICTS TO OWNER AND ENGINEER.

PROFESSIONAL LAND SURVEYORS, 333 S. WHITE STREET, WAKE

FOREST, NC, 27588, PHONE: (919) 556-3148. CONTRACTOR SHALL BE RESPONSIBLE FOR VERIFYING ALL EXISTING INFORMATION, DEPICTED OR NOT, PRIOR TO CONSTRUCTION AND REPORT





- @ @ 4 @ W



Ш

SE Ω

∞

SHEET NUMBER

TEMPORARY SEEDING SCHEDULE AND SEEDBED PREPARATION

1. LAY BLANKETS LOOSELY AND STAKE OR STAPLE TO MAINTAIN DIRECT

2. \* DIMENSIONS SHOWN ARE MINIMUM, MANUFACTURED PRODUCTS MAY HAVE

OUTFALL MATTING SPECIFICATIONS, PLEASE REFER TO NCESCPDM STANDARD

3. SLOPE SURFACE SHALL BE FREE OF ROCKS, SOIL CLODS, STICKS, GRASS.

4. THE DETAIL SHOWN IS FOR SLOPE MATTING. FOR CHANNEL OR PIPE

5. ALL MATTING TO BE ERONET™ S150® EROSION CONTROL BLANKET OR


CONTACT WITH THE SOIL. DO NOT STRETCH.

#6.17 AND MANUFACTURER'S GUIDELINES.

APPROVED EQUIVALENT.

ADDITIONAL REQUIREMENTS THAT MUST BE MET.

MAT/BLANKETS SHALL HAVE GOOD SOIL CONTACT.

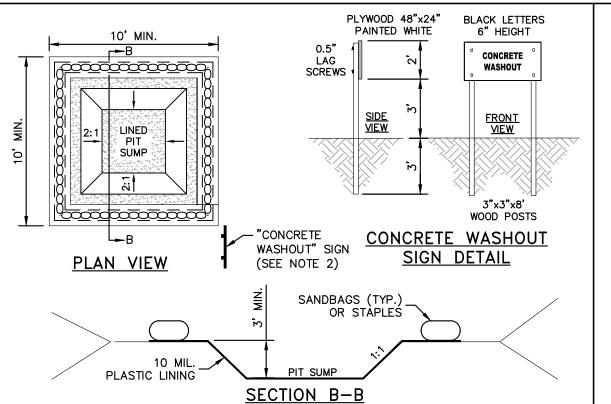

1. ACTUAL LAYOUT TO BE DETERMINED IN THE FIELD. 2. A CONCRETE WASHOUT SIGN SHALL BE INSTALLED WITHIN 30' OF THE TEMPORARY

NCDOT #57

**MAINTENANCE** 

STONE AS NEEDED.

WASHED STÖNE -

1. ACTUAL LAYOUT TO BE DETERMINED IN THE FIELD.

**CONCRETE WASHOUT STATION** 

REMOVED FROM THE SITE AND DISPOSED OF OR RECYCLED.

CONCRETE WASHOUT FACILITY.

STABILIZED TO PREVENT EROSION.

2. A CONCRETE WASHOUT SIGN SHALL BE INSTALLED WITHIN 30' OF THE TEMPORARY

3. MATERIALS USED TO CONSTRUCT TEMPORARY CONCRETE WASHOUT FACILITIES SHALL BE

TEMPORARY CONCRETE WASHOUT FACILITIES SHALL BE BACKFILLED, REPAIRED, AND

5. PIT CAPACITY IS MINIMUM OF 6 CUBIC FEET PER 10 CUBIC YARDS OF CONCRETE.

4. HOLES, DEPRESSIONS OR OTHER GROUND DISTURBANCE CAUSED BY THE REMOVAL OF THE

- CONCRETE WASHOUT FACILITY. 3. MATERIALS USED TO CONSTRUCT TEMPORARY CONCRETE WASHOUT FACILITIES SHALL BE REMOVED FROM THE SITE AND DISPOSED OF OR RECYCLED.
- 4. HOLES, DEPRESSIONS OR OTHER GROUND DISTURBANCE CAUSED BY THE REMOVAL OF THE TEMPORARY CONCRETE WASHOUT FACILITIES SHALL BE BACKFILLED, REPAIRED, AND STABILIZED TO PREVENT EROSION.
- 5. PIT CAPACITY IS MINIMUM OF 6 CUBIC FEET PER 10 CUBIC YARDS OF CONCRETE. CONCRETE WASHOUT STATION

N.T.S. KHA DETAIL NO: 01.102.R01

-STANDARD METAL

POSTS 2'-0" IN

GALVANIZED HARDWARE WIRE

(19 GAUGE, 1/4" MESH

OPENINGS.)

- #57 WASHED STONE PLACED TO A

HEIGHT OF 16" MIN. ABOVE TOP OF BOX

EXTENDS TO THE TOP OF BOX.

6" OVERLAP IN SLICE - NON-WOVEN GEOTEXTILE FILTER CLOTH FABRIC 4' ABOVE SOURCE WATER, IF REQUIRED KEY/ANCHOR TO TOE OF SLOPE. TEMPORARY MATTING N.T.S.

12" MIN. SPACING TYP.\*

36" MIN. SPACING TYP.\*

KHA DETAIL NO: 01.105.RC

-KEY/ANCHOR MATERIAL AT

TOP OF SLOPE.


FILTER BAG WITH DEBRIS TRAP 19-GAUGE AND BYPASS HARDWARE CLOTH (1 MESH OPENINGS) - REMOVABLE FLUME (TRAP) (HDPE PLASTIC OR FIBERGLASS) SUPPORT FRAME -TOP VIEW (GRATE NOT SHOWN)

	CAPACIT	CITY CHART			
INLET SIZE	LINER DEPTH	STORAGE CAPACITY*	CLEAN FLOW RATE*		
24" X 24"	12"	1.67 CU. FT.	470 GPM		
24" X 24"	24"	4.18 CU. FT.	914 GPM		
24" X 24"	36"	6.69 CU. FT.	1,357 GPM		
24" X 36"	12"	2.55 CU. FT.	641 GPM		
24" X 36"	24"	6.38 CU. FT.	1,201 GPM		
24" X 36"	36"	10.20 CU. FT.	1,761 GPM		
36" X 36"	12"	3.36 CU. FT.	772 GPM		
36" X 36"	24"	8.39 CU. FT.	1,402 GPM		
36" X 36"	36"	13.43 CU. FT.	2,032 GPM		
	24" X 24" 24" X 24" 24" X 36" 24" X 36" 24" X 36" 24" X 36" 36" X 36"	INLET SIZE LINER DEPTH  24" X 24" 12"  24" X 24" 24"  24" X 36" 12"  24" X 36" 24"  24" X 36" 36"  36" X 36" 12"  36" X 36" 24"	24" X 24"       12"       1.67 CU. FT.         24" X 24"       24"       4.18 CU. FT.         24" X 24"       36"       6.69 CU. FT.         24" X 36"       12"       2.55 CU. FT.         24" X 36"       24"       6.38 CU. FT.         24" X 36"       36"       10.20 CU. FT.         36" X 36"       12"       3.36 CU. FT.         36" X 36"       24"       8.39 CU. FT.		

\* STORAGE CAPACITY REFLECTS MAXIMUM SOLIDS COLLECTION PRIOR TO IMPEDING BYPASS. \*\* FLOW RATES ARE "CALCULATED CLEAN FLOW RATES" BASED ON LINER MATERIAL FLOW RATE OF 70 GPM/SQ. FT. (RECOMMEND APPLYING FACTOR OF .25 TO .50 TO FLOW RATES TO ALLOW FOR SEDIMENT AND DEBRIS)

			CAPACII	T CHARI	
MODEL NO.		INLET SIZE	LINER DEPTH	STORAGE CAPACITY*	CLEAN FLOW RATE**
FF-2	424HC	24" X 24"	12"	1.67 CU. FT.	470 GPM
"	"	24" X 24"	24"	4.18 CU. FT.	914 GPM
"	"	24" X 24"	36"	6.69 CU. FT.	1,357 GPM
FF-2	436HC	24" X 36"	12"	2.55 CU. FT.	641 GPM
"	n	24" X 36"	24"	6.38 CU. FT.	1,201 GPM
"	n	24" X 36"	36"	10.20 CU. FT.	1,761 GPM
FF-363	6HC-GO	36" X 36"	12"	3.36 CU. FT.	772 GPM
"	***	36" X 36"	24"	8.39 CU. FT.	1,402 GPM
,,	"	36" X 36"	36"	13.43 CU. FT.	2,032 GPM

CATCH BASIN SILT PROTECTION INSERT N.T.S.

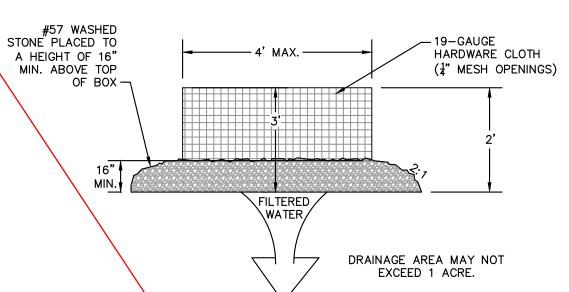

CONSTRUCTION SPECIFICATIONS 1. UNIFORMLY GRADE A SHALLOW DEPRESSION APPROACHING THE INLET.

2. DRIVE 5-FOOT STEEL POSTS 2 FEET INTO THE GROUND SURROUNDING THE INLET. SPACE POSTS EVENLY AROUND THE PERIMETER OF THE INLET, A MAXIMUM OF 4 FEET APART.

SURROUND THE POSTS WITH WIRE MESH HARDWARE CLOTH. SECURE THE WIRE MESH TO THE STEEL POSTS AT THE TOP, MIDDLE, AND BOTTOM. PLACING A 2-FOOT FLAP OF THE WIRE MESH UNDER THE GRAVEL FOR ANCHORING IS RECOMMENDED.

4. PLACE CLEAN GRAVEL (NC DOT \*5 OR #57 STONE) ON A 2:1 SLOPE WITH A HEIGHT OF 16 INCHES AROUND THE WIRE, AND SMOOTH TO AN EVEN GRADE. 5. ONCE THE CONTRIBUTING DRAINAGE AREA HAS BEEN STABILIZED, REMOVE ACCUMULATED

6. COMPACT THE AREA PROPERLY AND STABILIZE IT WITH GROUNDCOVER.

SEDIMENT, AND ESTABLISH FINAL GRADING ELEVATIONS.

CATCH BASIN AND YARD INLET PROTECTION N.T.S.

INSPECT INLETS AT LEAST WEEKLY AND AFTER EACH SIGNIFICANT


OF ANY DEBRIS OR OTHER OBJECTS TO PROVIDE ADEQUATE FLOW

UNDERCUT THE WIRE MESH DURING SEDIMENT REMOVAL. REPLACE

(1/2 INCH OR GREATER) RAINFALL EVENT. CLEAR THE MESH WIRE

FOR SUBSEQUENT RAINS. TAKE CARE NOT TO DAMAGE OR

KHA DETAIL NO: 01.202.R0

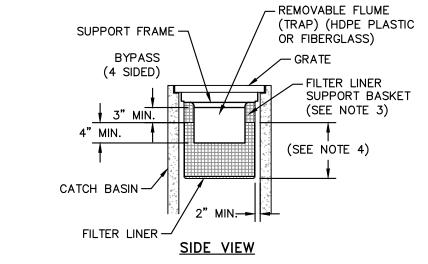

EXTRANEOUS MATERIALS THAT SURFACE.

TEST REPORT, FOLLOW SOIL AMENDMENTS BELOW.

OTHER SEEDING RATE COMBINATIONS ARE POSSIBLE.

FOLLOWING COMPLETION OF ANY PHASE OF GRADING.

LANDSCAPE PLAN FOR FINAL SEEDING.

COMPLETION OF CONSTRUCTION.

1. INLET MAINTENANCE SHALL BE

TO STREET ACCEPTANCE.

INSTALLATION.

THE ENGINEER.

DOCUMENTED IN PROJECT LOG BOOK.

2. FILTER TYPES SHALL BE APPROVED BY

3. FILTER BAGS MAY BE REMOVED WHEN

4. FILTER BAGS SHALL BE REMOVED PRIOR

REPLACED ON A REGULAR BASIS (NOT BE MORE THAN HALF FULL AT ANY

6. FILTER BAGS SHALL NOT BE ALLOWED IN

CATCH BASIN INLET PROTECTION

EXISTING CITY OR NCDOT ROADS.

5. FILTER BAGS SHALL BE CLEANED OR

SITE IS STABILIZED AT THE DIRECTION OF

THE CITY INSPECTOR PRIOR TO

IF NOT INCORPORATED DURING THE SOIL PREPARATION PROCESS, ADD pH MODIFIER AND

FERTILIZERS AT THE RATE SPECIFIED IN THE SOIL TEST REPORT. IF THERE IS NO SOIL

RE-COMPACT THE AREA UTILIZING A CULTIPACKER ROLLER. THE FINISHED GRADE SHALL

SEEDER, OR HYDROSEEDER. SMALL GRAINS SHOULD BE PLANTED NO MORE THAN 1 INCH

DEEP. AND GRASSES AND LEGUMES NO MORE THAN 1 INCH. BROADCAST SEED MUST BE

OR CULTIPACKER. HYDROSEEDED MIXTURES SHOULD INCLUDE A WOOD FIBER (CELLULOSE)

COVERED BY RAKING OR CHAIN DRAGGING, AND THEN LIGHTLY FIRMED WITH A ROLLER

CONSULT CONSERVATION ENGINEER OR SOIL CONSERVATION SERVICE FOR ADDITIONAL

THIS SEEDING SCHEDULE IS FOR EROSION AND SEDIMENT CONTROL ONLY. SEE

4. CONTRACTOR SHALL PROVIDE GROUND COVER IN 14 DAYS ON ALL OTHER AREAS

WORKING DAYS OR 90 CALENDAR DAYS (WHICHEVER IS SHORTER) FOLLOWING

INFORMATION CONCERNING OTHER ALTERNATIVES FOR VEGETATION OF DENUDED AREAS.

THE CONTRACTOR SHALL PROVIDE GROUND COVER ON DESIGNATED AREAS AND SLOPES

5. PERMANENT GROUND COVER FOR ALL DISTURBED AREAS SHALL BE PROVIDED WITHIN 15

GREATER THAN 3:1 WITHIN 7 DAYS FOLLOWING COMPLETION OF ANY PHASE OF GRADING.

GRATE -

**EXPANSION** 

RESTRAINT -

THE ABOVE VEGETATION RATES ARE THOSE WHICH DO WELL UNDER LOCAL CONDITIONS;

BE A SMOOTH EVEN SOIL SURFACE WITH A LOOSE, UNIFORMLY FINE TEXTURE.

5. EVENLY APPLY SEED USING A CYCLONE SEEDER (BROADCAST), DRILL, CULTIPACKER

### <u>NOTES</u>

- 1. CATCH BASIN INSERTS ARE AVAILABLE IN SIZES TO FIT MOST INDUSTRY-STANDARD CATCH BASINS (SEE CAPACITY CHART). CUSTOM SIZES ARE AVAILABLE.
- 2. FILTER SUPPORT FLANGES SHALL BE CONSTRUCTED FROM STAINLESS STEEL (TYPE 304) DEBRIS TRAP (FLUME) SHALL BE CONSTRUCTED FROM EITHER PETROLEUM RESÍSTANT FIBERGLÀSS OR HDPE PLASTIC
- 3. FILTER LINER SUPPORT BASKET SHALL BE CONSTRUCTED FROM A BIAXIAL GEOGRID WITH A MINIMUM ULTIMATE TENSILE STRENGTH OF 900 X 1400, AS TESTED IN ACCORDANCE WITH ASTM D-4595. 4. INSERT LINERS ARE AVAILABLE IN STANDARD DEPTHS OF 12", 24" OR 36" (REFER


### MAINTENANCE SPECIFICATIONS

INSPECT THE PROTECTION INSERT AND REMOVE ALL ACCUMULATED SEDIMENT AND DEBRIS FROM VICINITY OF UNIT AFTER EACH STORM EVENT. IF THE CONTAINMENT IS MORE THAN 1/3 FULL OF SEDIMENT, EMPTY THE PROTECTION INSERT BY LIFTING THE UNIT OUT OF THE INLET AND REPLACING.

TO CAPACITY CHART). CUSTOM LINER DEPTHS MAY BE SPECIFIED.

KHA DETAIL NO: 01.203.R0

Know what's below. Call before you dig.

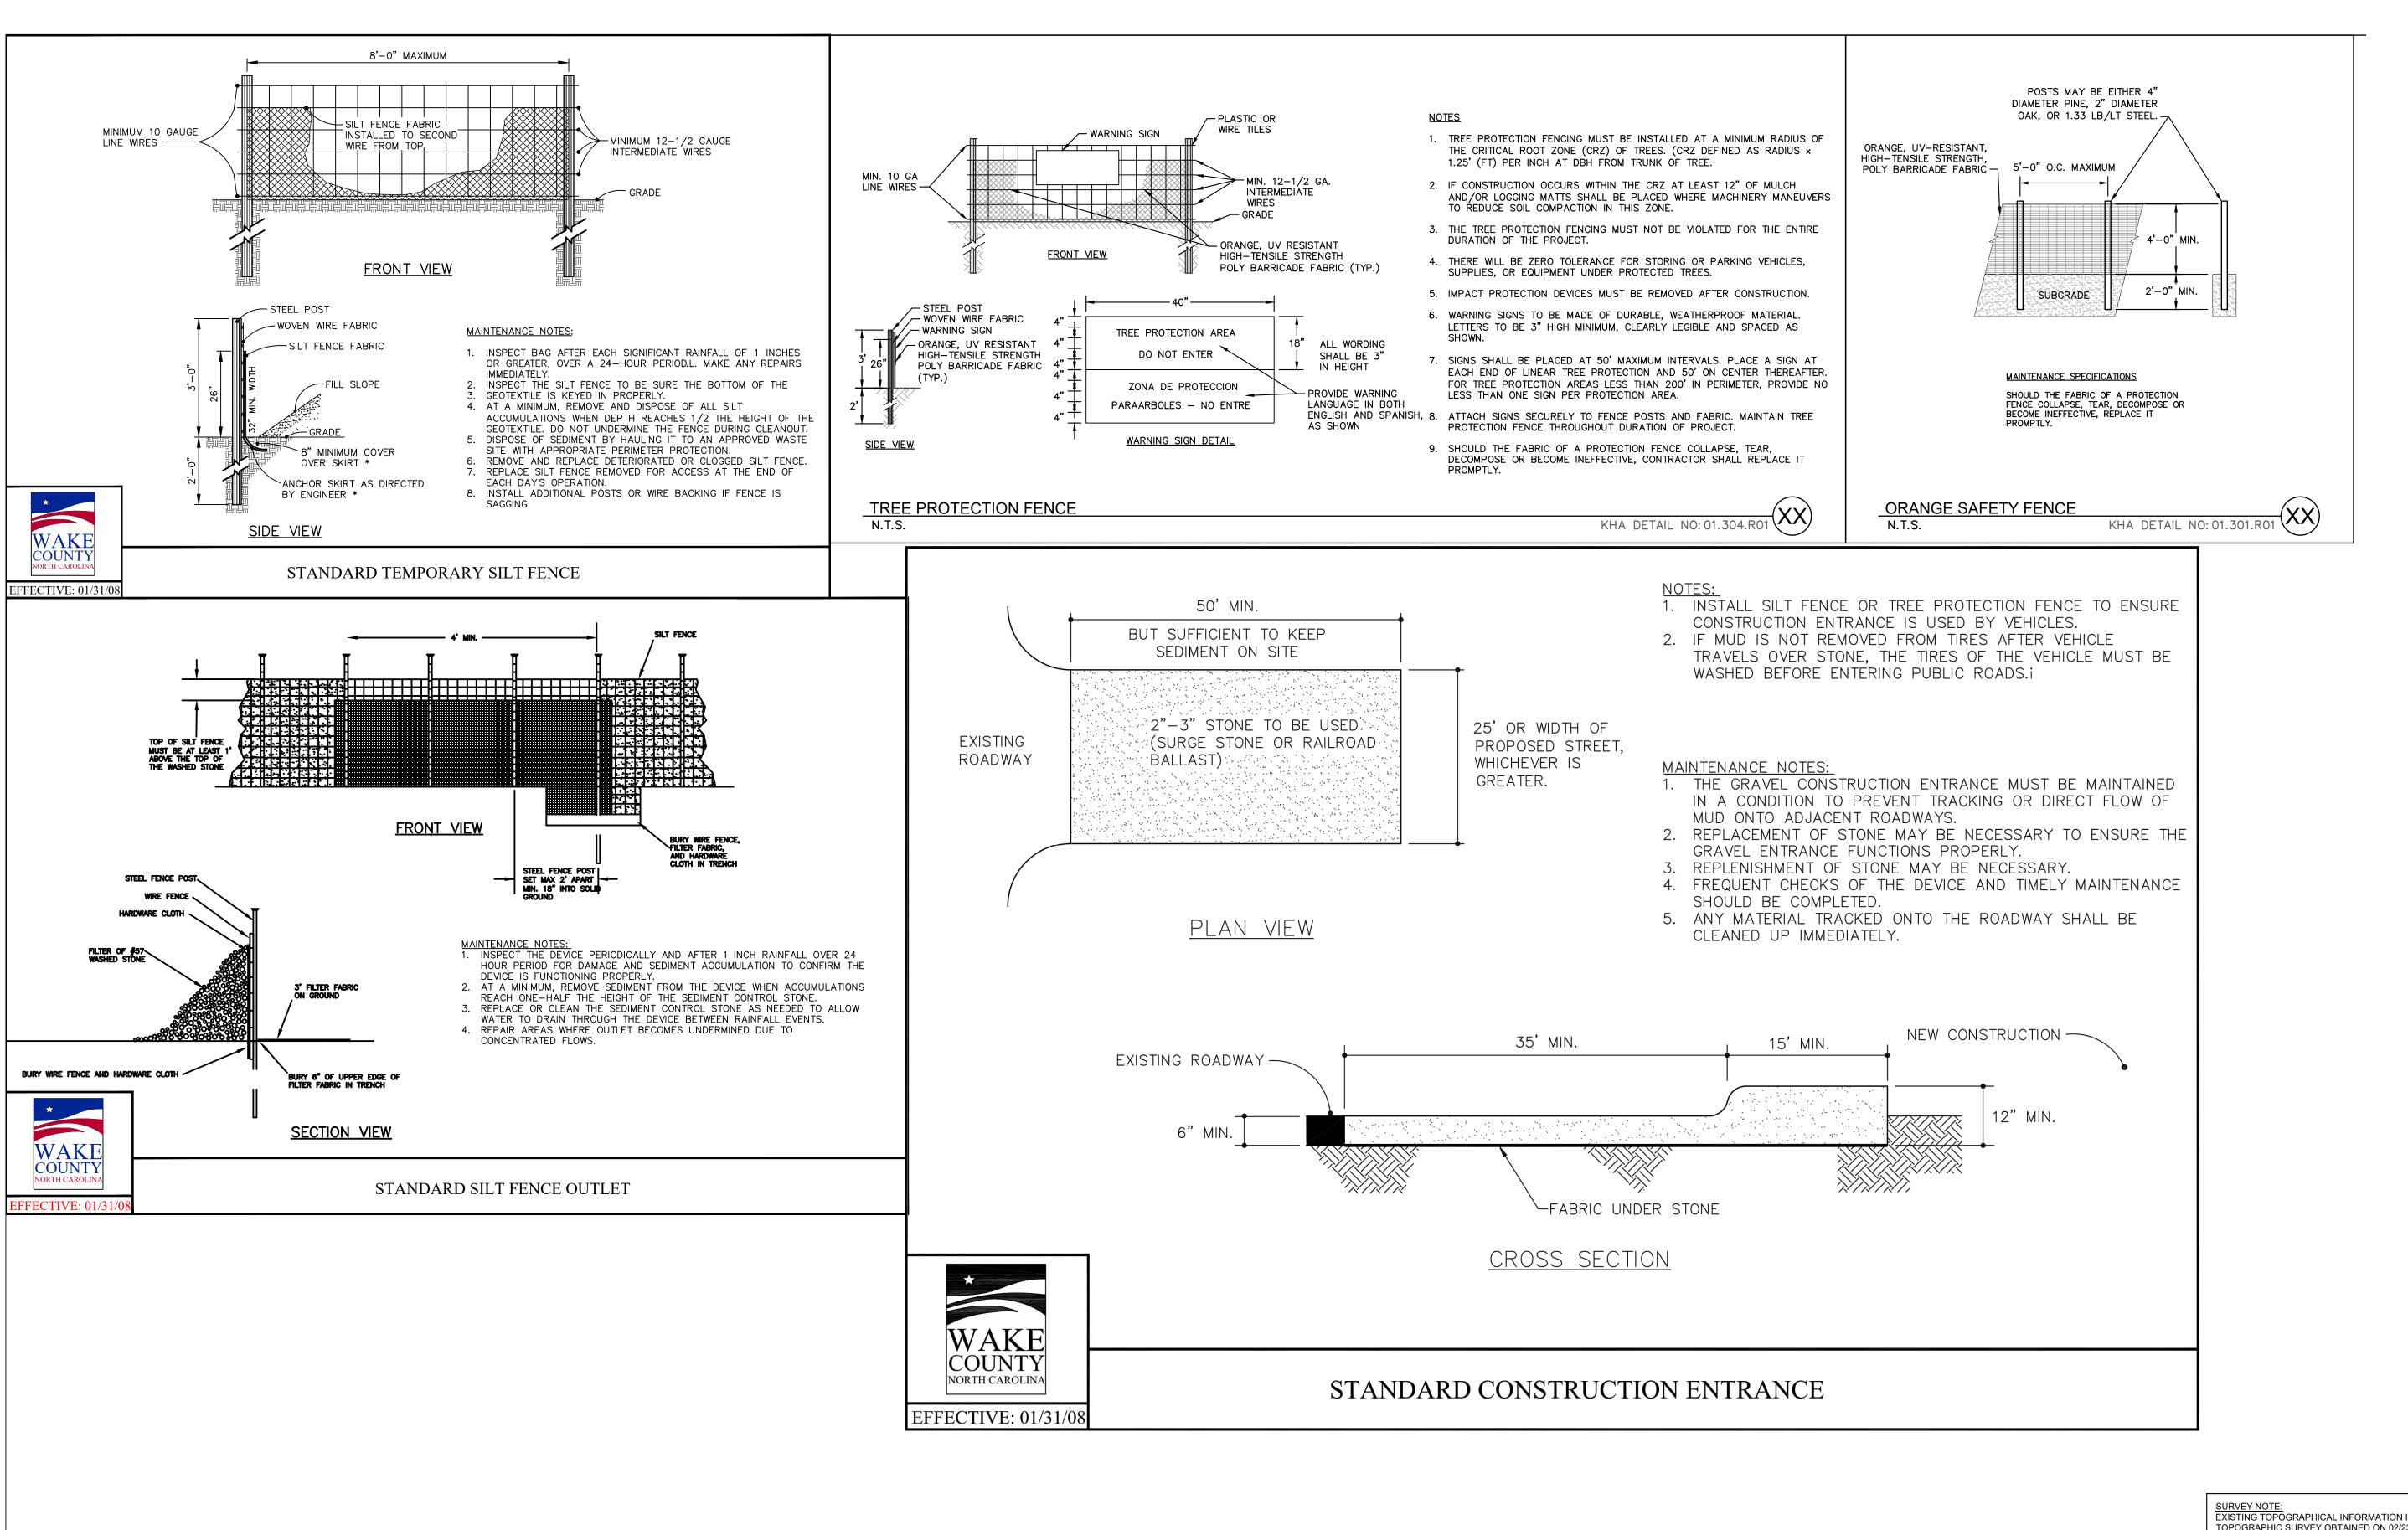

SURVEY NOTE: EXISTING TOPOGRAPHICAL INFORMATION IS BASED ON A TOPOGRAPHIC SURVEY OBTAINED ON 02/23/2023 BY CMP PROFESSIONAL LAND SURVEYORS, 333 S. WHITE STREET, WAKE FOREST, NC, 27588, PHONE: (919) 556-3148. CONTRACTOR SHALL BE RESPONSIBLE FOR VERIFYING ALL EXISTING INFORMATION, DEPICTED OR NOT, PRIOR TO CONSTRUCTION AND REPORT

POTENTIAL CONFLICTS TO OWNER AND ENGINEER.



(0) (4) (6) (4)



CONTRO


Ш

ARED FOR ENTERPRISES

SHEET NUMBER

S&S

C5.3

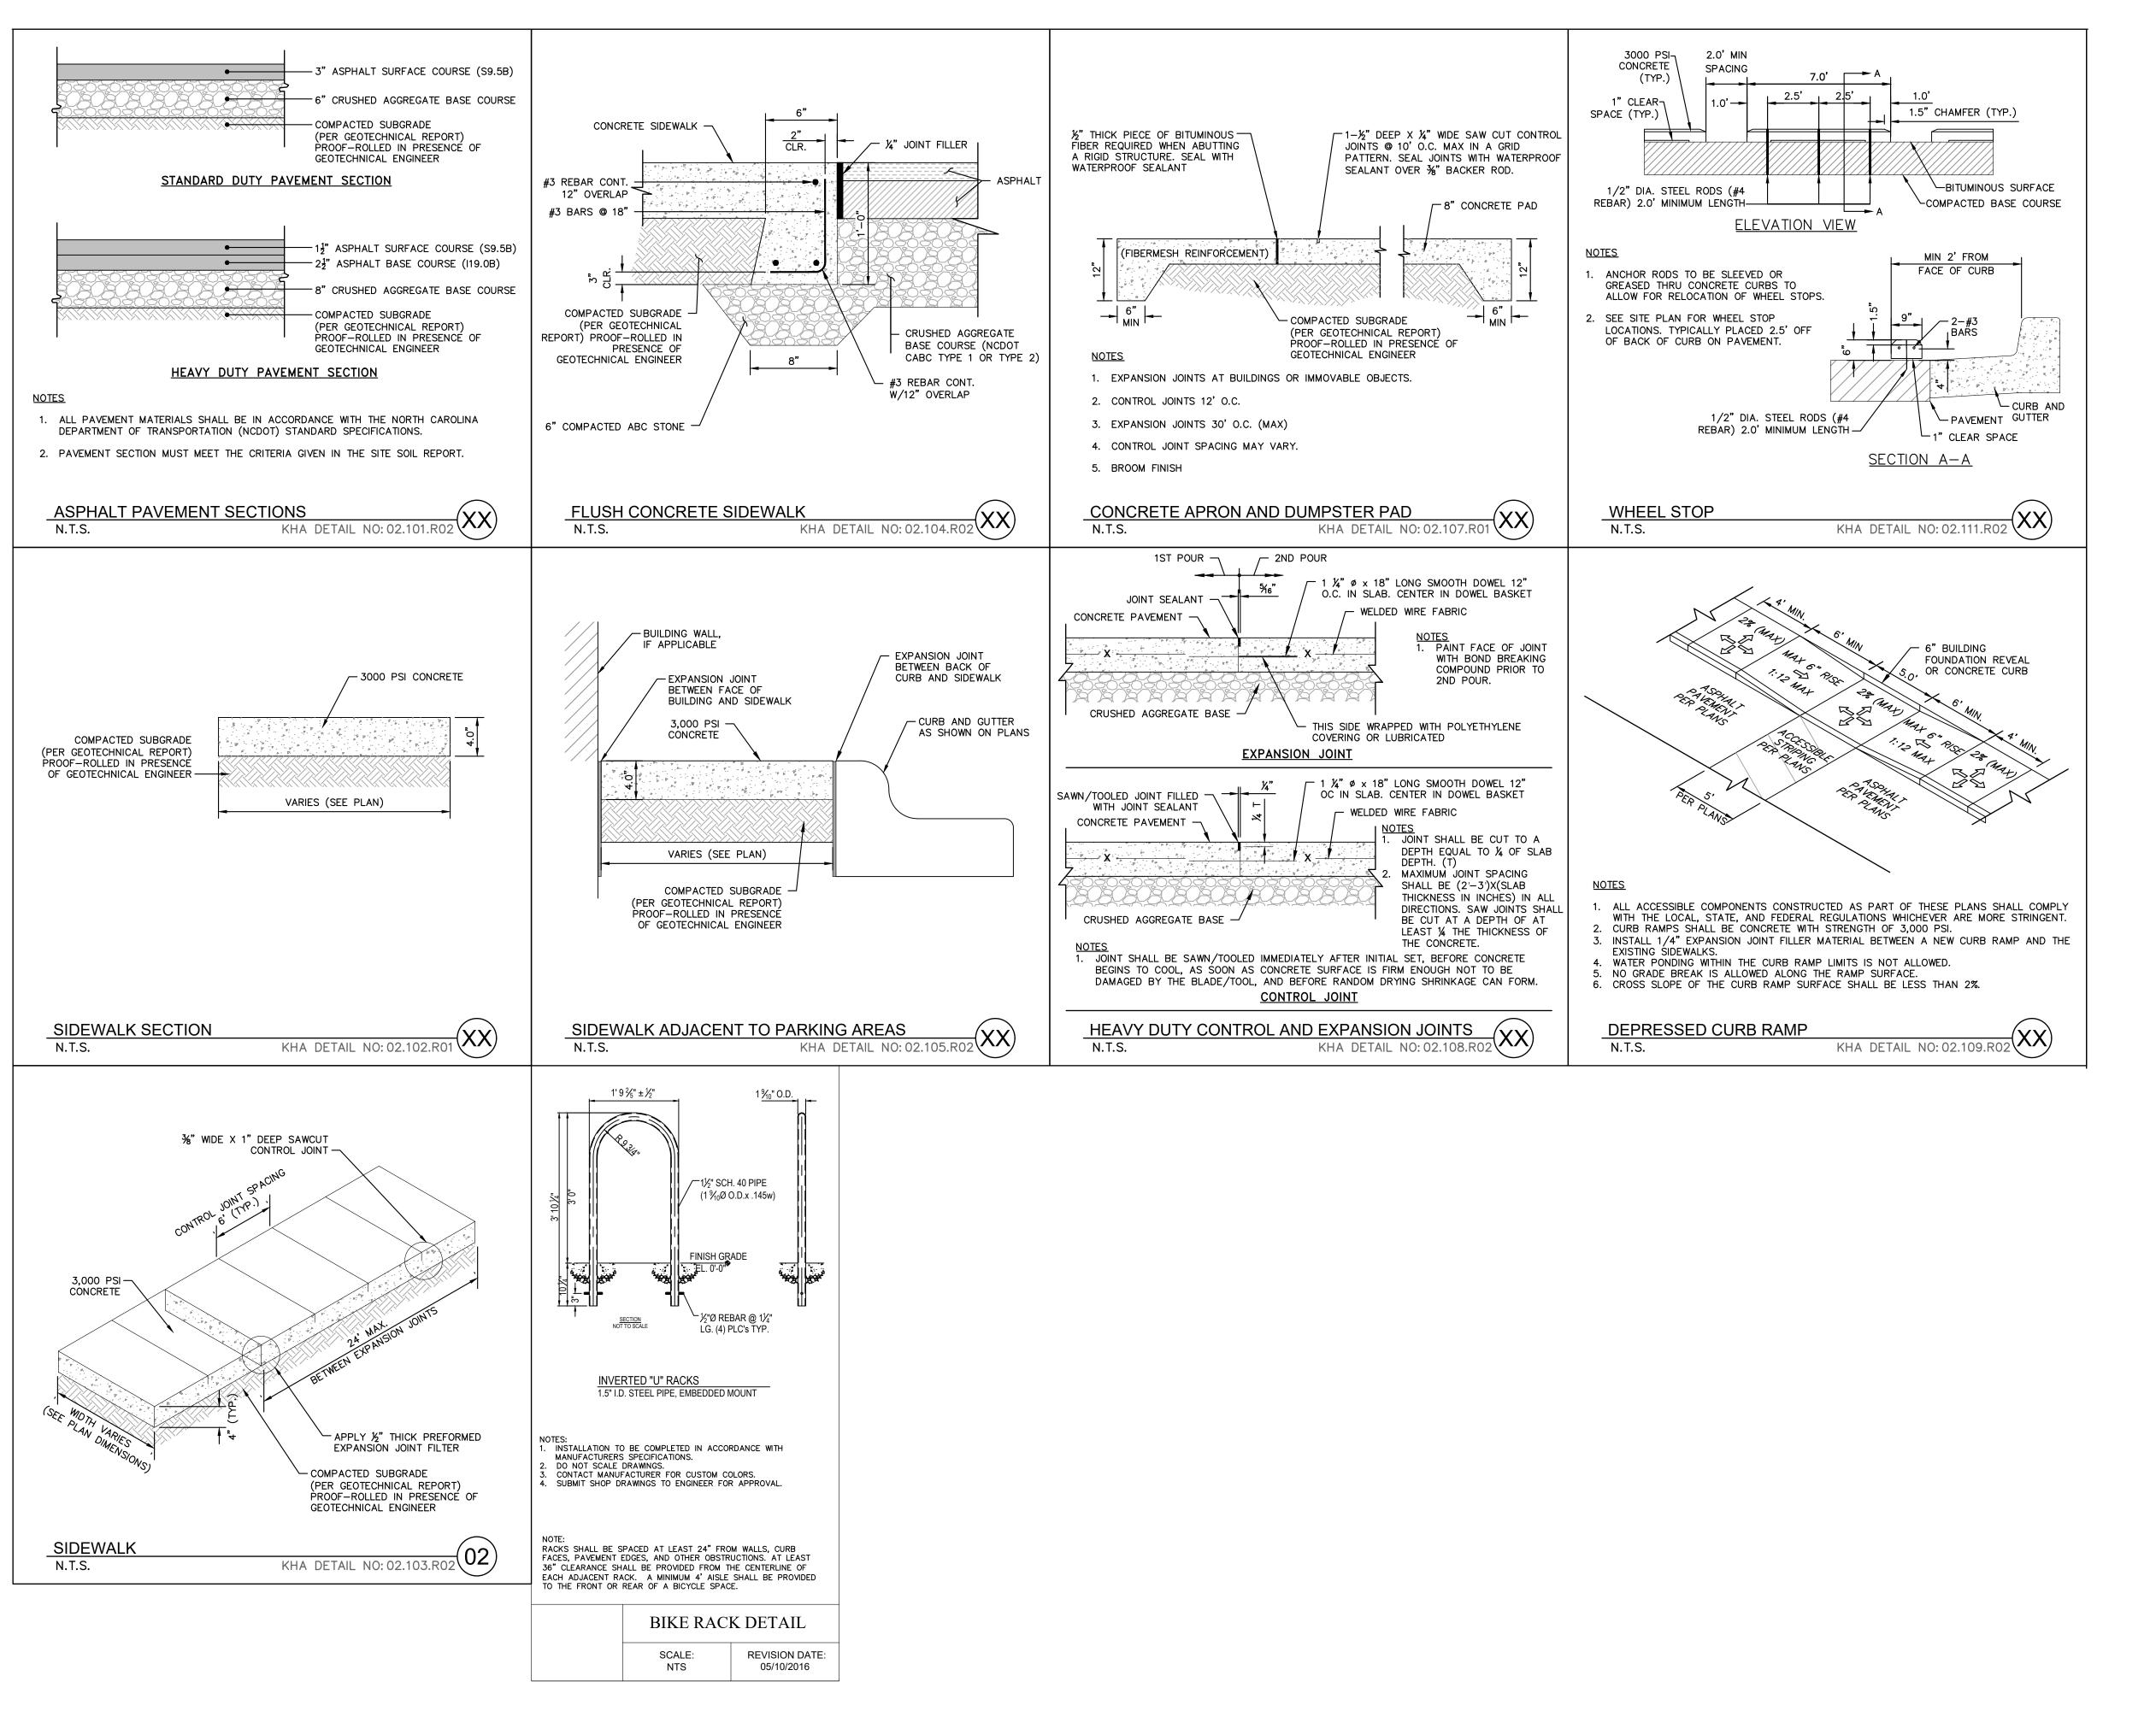

SURVEY NOTE:
EXISTING TOPOGRAPHICAL INFORMATION IS BASED ON A
TOPOGRAPHIC SURVEY OBTAINED ON 02/23/2023 BY CMP
PROFESSIONAL LAND SURVEYORS, 333 S. WHITE STREET, WAKE
FOREST, NC, 27588, PHONE: (919) 556-3148. CONTRACTOR SHALL BE
RESPONSIBLE FOR VERIFYING ALL EXISTING INFORMATION,
DEPICTED OR NOT, PRIOR TO CONSTRUCTION AND REPORT
POTENTIAL CONFLICTS TO OWNER AND ENGINEER.



ES, INC.

1GH, NC 27601

No. REVISIONS

DA.

© 2023 KIMLEY-HORN AND ASSOCIATES, INC.
#F-0102 WWW.KIMLEY-HORN.COM PHONE: 919-677-2000 FAX: 919-677-421 FAYETTEVILLE STREET, SUITE 600, RALEIGH, NC 27601




SCALE AS SHOWN
DESIGNED BY JAA
DRAWN BY JAA


SITE DETAILS

PREPARED FOR /A ENTERPRISES

SHEET NUMBER

8 S

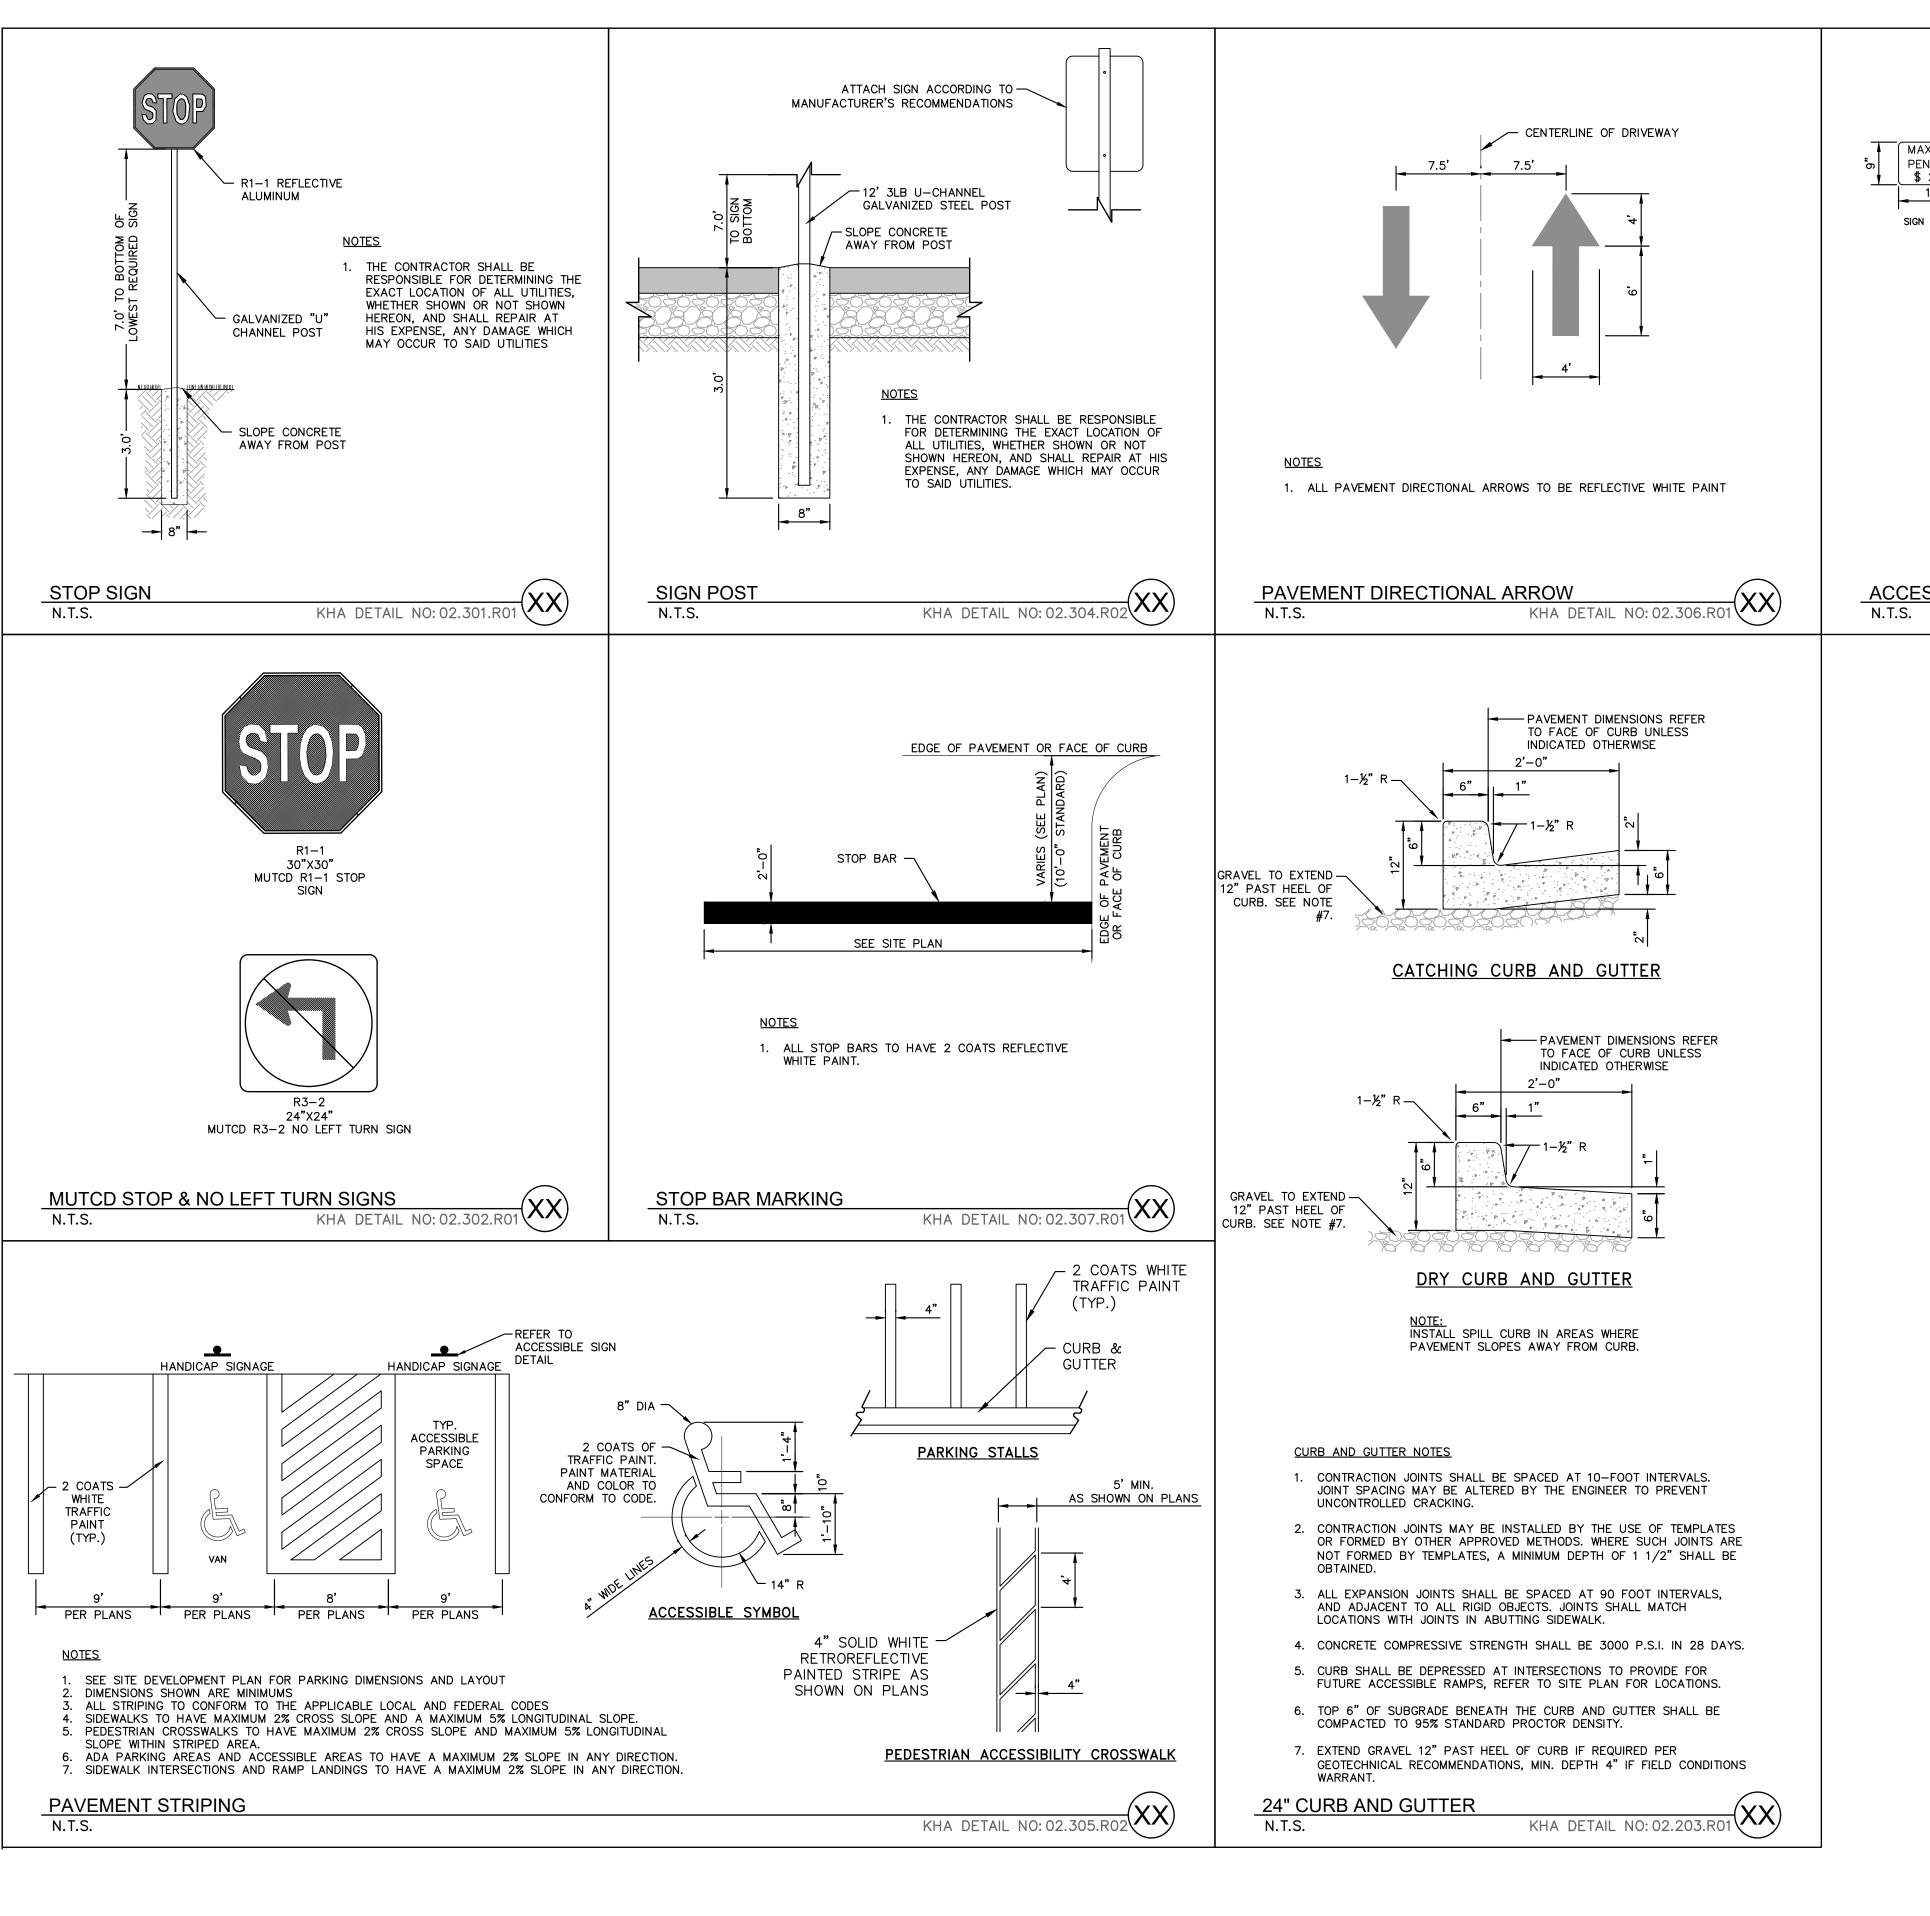

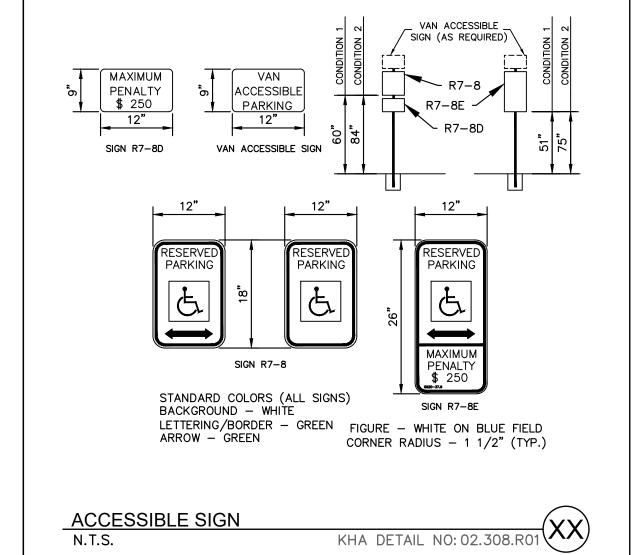



SURVEY NOTE:
EXISTING TOPOGRAPHICAL INFORMATION IS BASED ON A
TOPOGRAPHIC SURVEY OBTAINED ON 02/23/2023 BY CMP
PROFESSIONAL LAND SURVEYORS, 333 S. WHITE STREET, WAKE
FOREST, NC, 27588, PHONE: (919) 556-3148. CONTRACTOR SHALL BE
RESPONSIBLE FOR VERIFYING ALL EXISTING INFORMATION,
DEPICTED OR NOT, PRIOR TO CONSTRUCTION AND REPORT
POTENTIAL CONFLICTS TO OWNER AND ENGINEER.




SCOOTER'S
ROLESVILLE
PREPARED FOR
S&S JAVA ENTERPRI

S

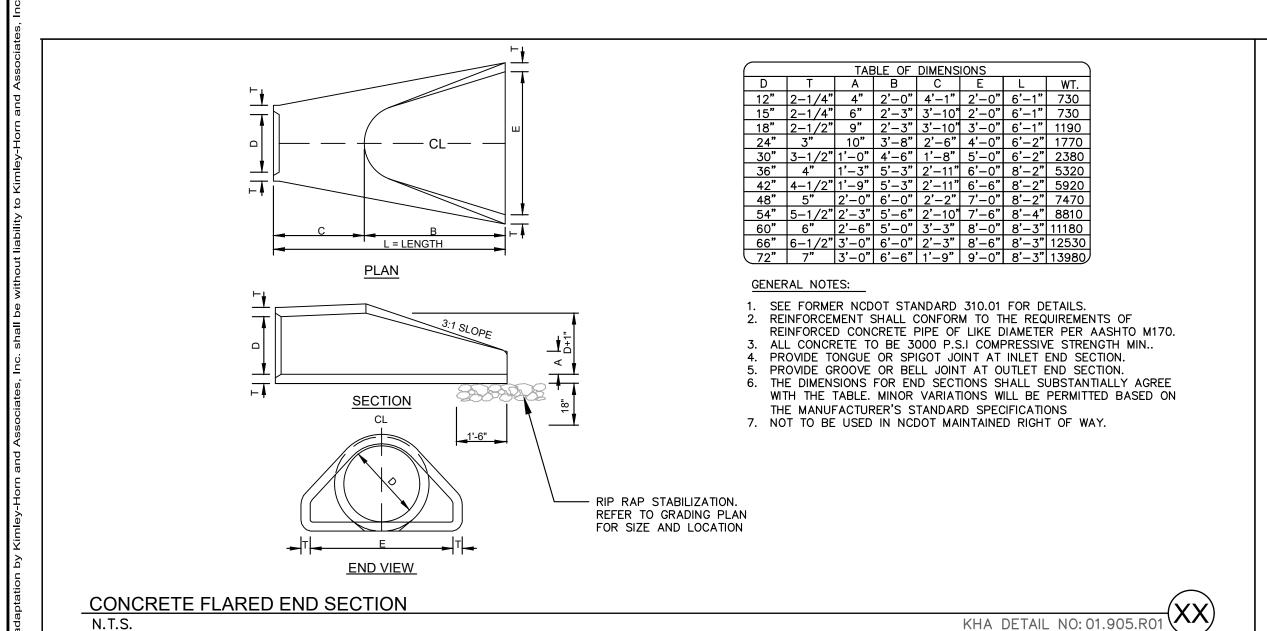


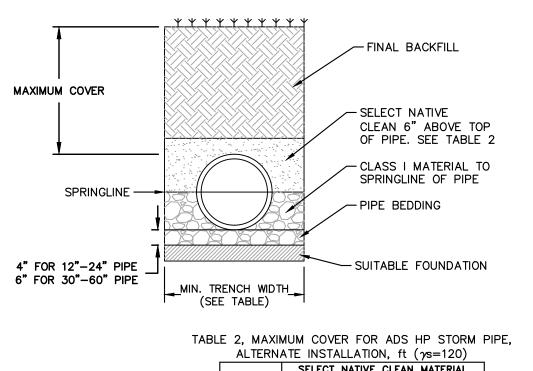

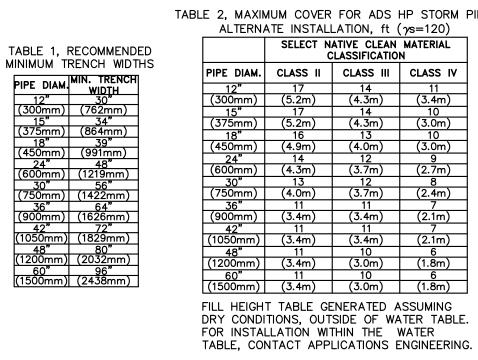


- MEASURES SHOULD BE TAKEN TO PREVENT MIGRATION OF NATIVE FINES INTO BACKFILL MATERIAL, WHEN REQUIRED.
- 2. SOIL CLASSIFICATIONS ARE PER THE LATEST VERSION OF ASTM D2321. CLASS IVB MATERIALS (MH, CH) AS DEFINED IN PREVIOUS VERSIONS OF ASTM D2321 ARE NOT APPROPRIATE BACKFILL MATERIALS.
- FOUNDATION WHERE THE TRENCH BOTTOM IS UNSTABLE, THE CONTRACTOR SHALL EXCAVATE TO A DEPTH REQUIRED BY THE ENGINEER AND REPLACE WITH SUITABLE MATERIAL AS SPECIFIED BY THE ENGINEER. AS AN ALTERNATIVE AND AT THE DISCRETION OF THE DESIGN ENGINEER, THE TRENCH BOTTOM MAY BE STABILIZED USING A GEOTEXTILE MATERIAL.
- <u>BEDDING</u> SUITABLE MATERIAL SHALL BE CLASS I. THE CONTRACTOR SHALL PROVIDE DOCUMENTATION FOR MATERIAL SPECIFICATION TO ENGINEER. UNLESS OTHERWISE NOTED BY THE ENGINEER MINIMUM BEDDING THICKNESS SHALL BE 4" (100mm) FOR 4"-24" (100mm-600mm); 6" (150mm) FOR 30"-60" (750mm-1500mm).
- BACKFILL FOR PIPES OUTSIDE OF PAVEMENT CLASS I MATERIAL TO BE USED FOR BACKFILL UP TO THE SPRINGLINE OF PIPE. THE CONTRACTOR SHALL PROVIDE DOCUMENTATION FOR MATERIAL SPECIFICATION TO ENGINEER. UNLESS OTHERWISE NOTED BY THE ENGINEER. CLASS I MATERIAL MUST BE COMPACTED IN 6" (200mm) LIFTS.
- MINIMUM COVER MINIMUM COVER, H, IN NON-TRAFFIC APPLICATIONS (GRASS OR LANDSCAPE AREAS IS 12" (300mm) FROM THE TOP OF PIPE TO GROUND SURFACE. ADDITIONAL COVER MAY BE REQUIRED TO PREVENT FLOTATION.
- SELECT NATIVE CLEAN BACKFILL SHALL BE WELL PLACED, MODERATELY COMPACTED (85% SPD) CLASS IV OR BETTER PER ASTM D2321 WITH NO FOREIGN DEBRIS INCLUDING ROCKS, LARGE CLUMPS ORGANIC MATERIAL, OR FROZEN MATERIAL.
- B. HP STORM ALTERNATE TRENCH DETAIL ONLY APPLIES TO BACKFILL INSTALLATIONS IN NON-TRAFFIC APPLICATIONS PER TN 2.04A. ALTERNATE TRENCH USE MUST BE APPROVED BY DESIGN ENGINEER. DETAIL DOES NOT SUPERSEDE ADS STANDARD DETAIL STD-108.


HP STORM TRENCH INSTALLATION DETAIL KHA DETAIL NO: 03.101.R01 (XX) N.T.S.

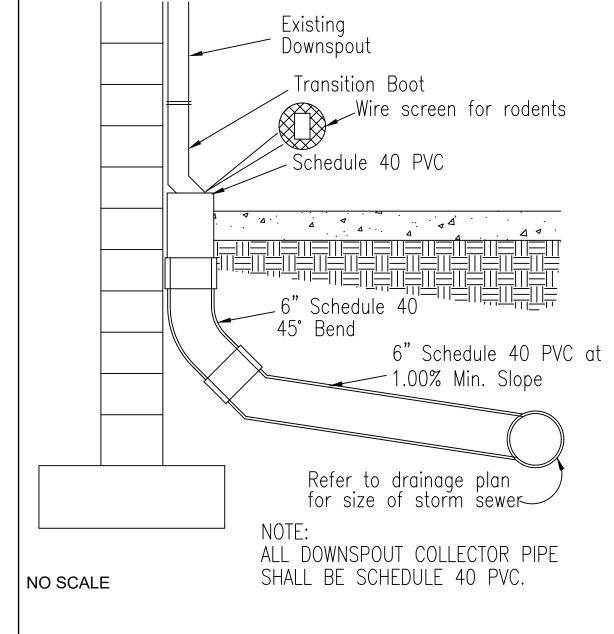

TYPICAL ROOF DRAIN CONNECTION

NOT TO SCALE

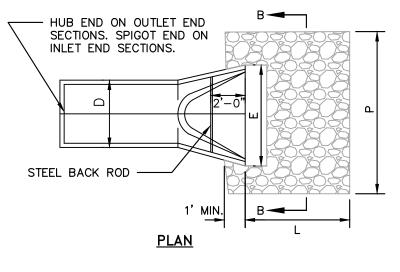

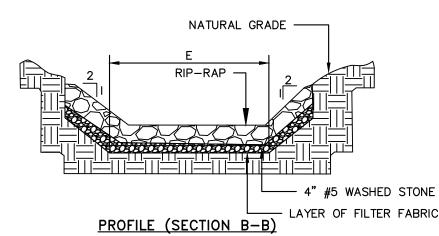

SIZING CHART									
STRUCTURE	Q-FULL (CFS)	E (FT)	L (FT)	P (FT)	D (IN)	STONE THICKNESS (IN)	STONE DIAMETER (IN)	STONE CLASS	VELOCITY (FPS)
NOTES									
1. THE LENGTH DISSIPATOR M									

- 1. END OF THE PIPE OR CULVERT AT THE DISCHARGE OUTLET AT A MAXIMUM SLOPE OF 2:1 AND A HEIGHT NOT LESS THAN TWO THIRDS THE PIPE DIAMETER OR CULVERT
- THERE SHALL BE NO OVERFLOW FROM THE END OF THE APRON TO THE SURFACE OF THE RECEIVING CHANNEL. THE AREA TO BE PAVED OR RIP-RAPPED SHALL BE UNDERCUT SO THAT THE INVERT OF THE APRON SHALL BE AT THE SAME GRADE (FLUSH) WITH THE SURFACE OF THE RECEIVING CHANNEL. THE APRON SHALL HAVE A CUTOFF OR TOE WALL AT THE DOWNSTREAM END.
- 3. THE WIDTH OF THE END OF THE APRON SHALL BE EQUAL TO THE BOTTOM WIDTH OF THE RECEIVING CHANNEL.
- 4. MAXIMUM TAPER TO RECEIVING CHANNEL 5:1.

2. RIP-RAP APRONS DESIGNED FOR FULL FLOW CAPACITY

- 5. ALL SUBGRADE BELOW THE STRUCTURE TO BE COMPACTED TO 95% OR GREATER.
- 6. THE PLACING OF FILL, EITHER LOOSE OR COMPACTED IN THE RECEIVING CHANNEL SHALL NOT BE ALLOWED.
- 7. NO BENDS OR CURVES IN THE HORIZONTAL ALIGNMENT OF THE APRON WILL BE

N.T.S.

IN GENERAL, ONCE A RIPRAP INSTALLATION HAS BEEN PROPERLY DESIGNED AND INSTALLED IT REQUIRES VERY LITTLE MAINTENANCE. RIPRAP SHOULD BE INSPECTED PERIODICALLY FOR SCOUR OR DISLODGED STONES. CONTROL OF WEED AND BRUSH GROWTH MAY BE NEEDED IN SOME LOCATIONS.

CONSTRUCTION SPECIFICATIONS:

1. ENSURE THAT THE SUBGRADE FOR THE FILTER AND RIPRAP FOLLOWS THE REQUIRED LINES AND GRADES SHOWN IN THE PLAN. COMPACT ANY FILL REQUIRED IN THE SUBGRADE TO THE DENSITY OF THE SURROUNDING UNDISTURBED MATERIAL. LOW AREAS IN THE SUBGRADE ON UNDISTURBED SOIL MAY ALSO BE FILLED BY INCREASING THE RIPRAP THICKNESS.

- 2. THE RIPRAP AND GRAVEL FILTER MUST CONFORM TO THE SPECIFIED GRADING LIMITS SHOWN ON THE PLANS.
- 3. FILTER CLOTH, WHEN USED, MUST MEET DESIGN REQUIREMENTS AND BE PROPERLY PROTECTED FROM PUNCHING OR TEARING DURING INSTALLATION. REPAIR ANY DAMAGE BY REMOVING THE RIPRAP AND PLACING ANOTHER PIECE OF FILTER CLOTH OVER THE DAMAGED AREA. ALL CONNECTING JOINTS SHOULD OVERLAP SO THE TOP LAYER IS ABOVE THE DOWNSTREAM LAYER A MINIMUM OF 1 FOOT. IF THE DAMAGE IS EXTENSIVE, REPLACE THE ENTIRE FILTER CLOTH.
- 4. RIPRAP MAY BE PLACED BY EQUIPMENT, BUT TAKE CARE TO AVOID DAMAGING THE
- 5. THE MINIMUM THICKNESS OF THE RIPRAP SHOULD BE 1.5 TIMES THE MAXIMUM STONE
- 6. RIPRAP MAY BE FIELD STONE OR ROUGH QUARRY STONE. IT SHOULD BE HARD, ANGULAR, HIGHLY WEATHER-RESISTANT AND WELL GRADED.
- 7. CONSTRUCT THE APRON ON ZERO GRADE WITH NO OVERFILL AT THE END. MAKE THE TOP OF THE RIPRAP AT THE DOWNSTREAM END LEVEL WITH THE RECEIVING AREA OR
- 8. ENSURE THAT THE APRON IS PROPERLY ALIGNED WITH THE RECEIVING STREAM AND PREFERABLY STRAIGHT THROUGHOUT ITS LENGTH. IF A CURVE IS NEEDED TO FIT SITE CONDITIONS, PLACE IT IN THE UPPER SECTION OF THE APRON.
- 9. IMMEDIATELY AFTER CONSTRUCTION, STABILIZE ALL DISTURBED AREAS WITH VEGETATION.

RIP-RAP APRON AT FLARED END SECTION



\* (Maximum fill) 10' - Class II pipe

\* FILL HEIGHT IS MEASURED FROM THE TOP OF THE PIPE


TO THE BOTTOM OF THE PAVEMENT STRUCTURE

(For fills > 40' & < 80' use LRFD Direct Design Method)

20' - Class III pipe

30' - Class IV pipe

40' - Class V pipe

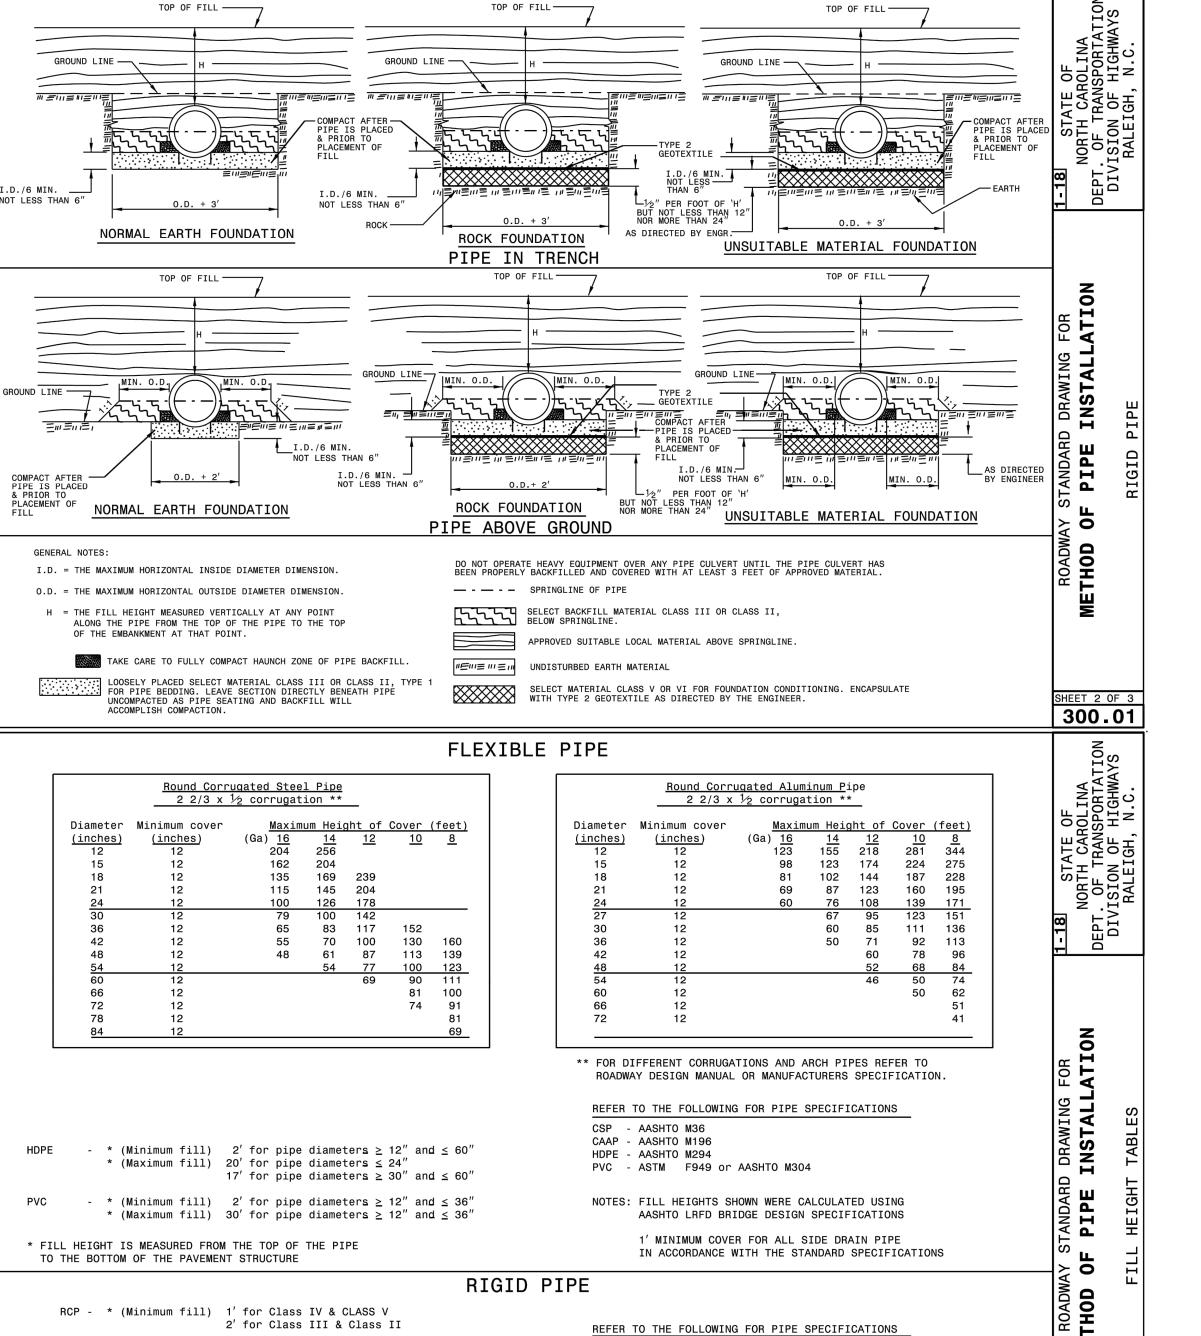

SURVEY NOTE:
EXISTING TOPOGRAPHICAL INFORMATION IS BASED ON A TOPOGRAPHIC SURVEY OBTAINED ON 02/23/2023 BY CMP PROFESSIONAL LAND SURVEYORS, 333 S. WHITE STREET, WAKE FOREST, NC, 27588, PHONE: (919) 556-3148. CONTRACTOR SHALL BE RESPONSIBLE FOR VERIFYING ALL EXISTING INFORMATION, DEPICTED OR NOT. PRIOR TO CONSTRUCTION AND REPORT POTENTIAL CONFLICTS TO OWNER AND ENGINEER.

HEET 3 OF 3

300.01



RCP - AASHTO M170

NOTES: FILL HEIGHTS SHOWN WERE CALCULATED USING

AASHTO LRFD BRIDGE DESIGN SPECIFICATIONS

1' MINIMUM COVER FOR ALL SIDE DRAIN PIPE

IN ACCORDANCE WITH THE STANDARD SPECIFICATIONS


6 6 4 6 6

Y 0

SE Д S

> SHEET NUMBER C9.0

∞୪

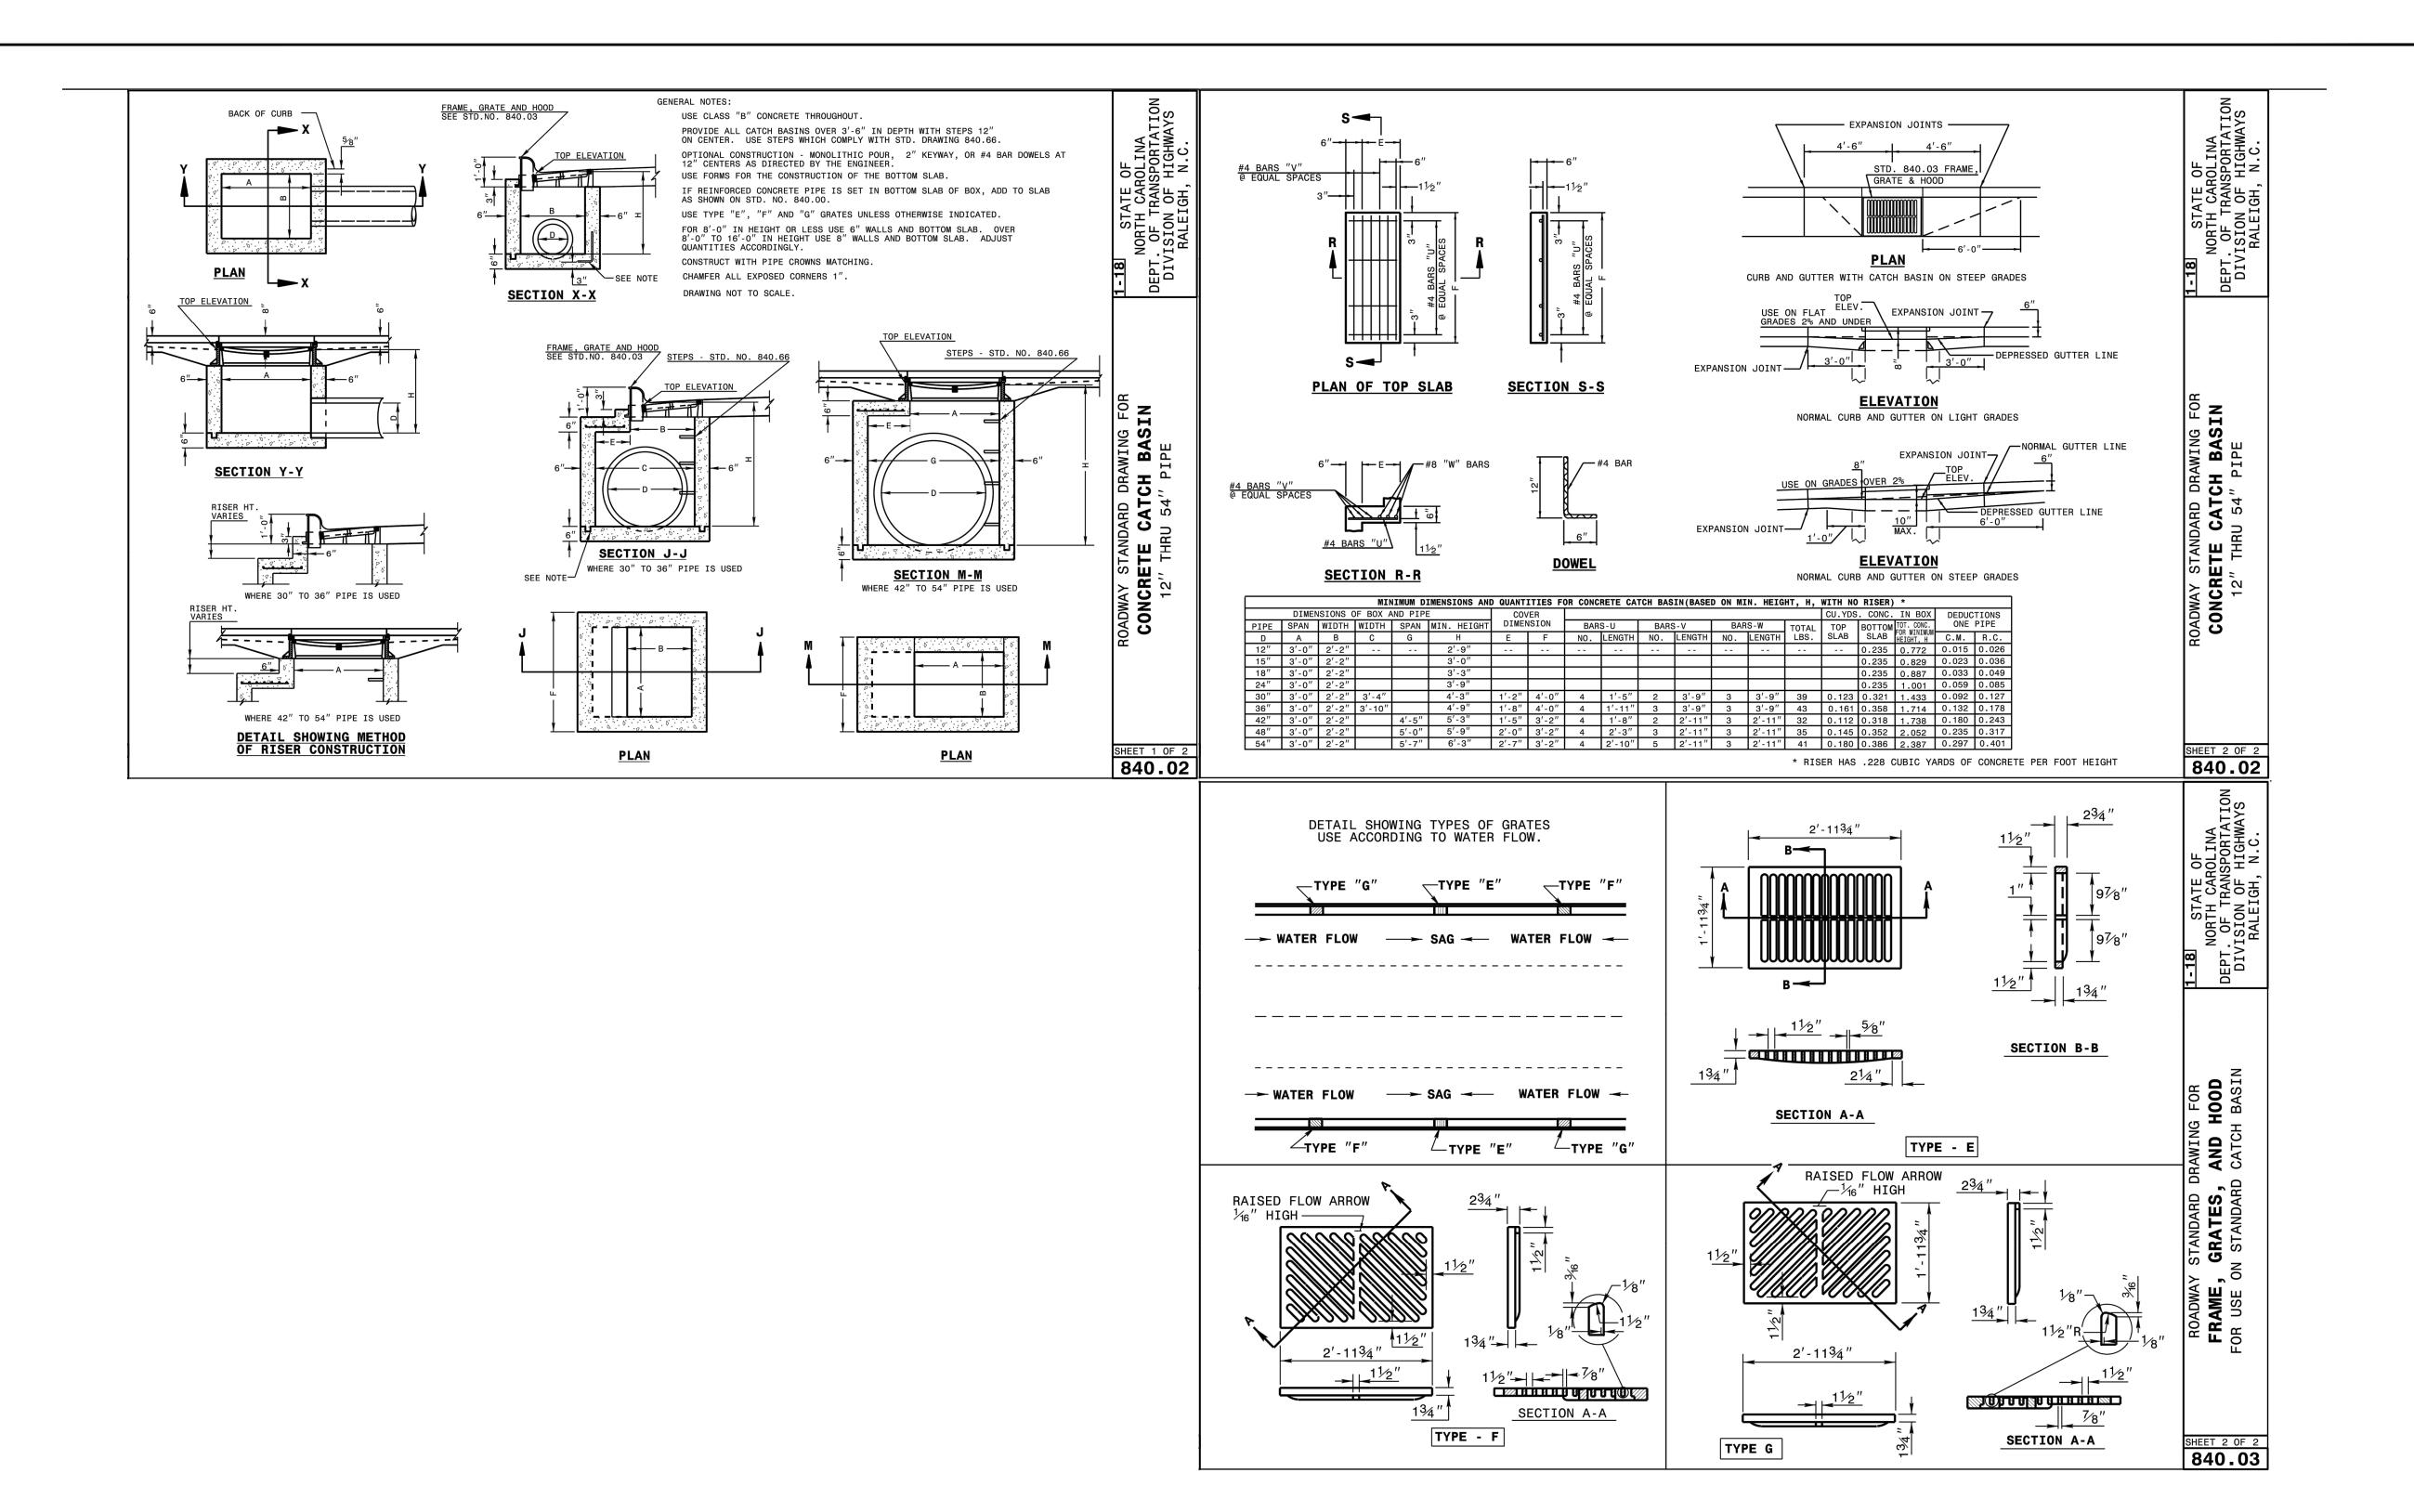

SURVEY NOTE:
EXISTING TOPOGRAPHICAL INFORMATION IS BASED ON A
TOPOGRAPHIC SURVEY OBTAINED ON 02/23/2023 BY CMP
PROFESSIONAL LAND SURVEYORS, 333 S. WHITE STREET, WAKE FOREST, NC, 27588, PHONE: (919) 556-3148. CONTRACTOR SHALL BE RESPONSIBLE FOR VERIFYING ALL EXISTING INFORMATION, DEPICTED OR NOT, PRIOR TO CONSTRUCTION AND REPORT POTENTIAL CONFLICTS TO OWNER AND ENGINEER.




DETAIL STORM

(0) (4) (6) (4)


S&S


SHEET NUMBER C9.1

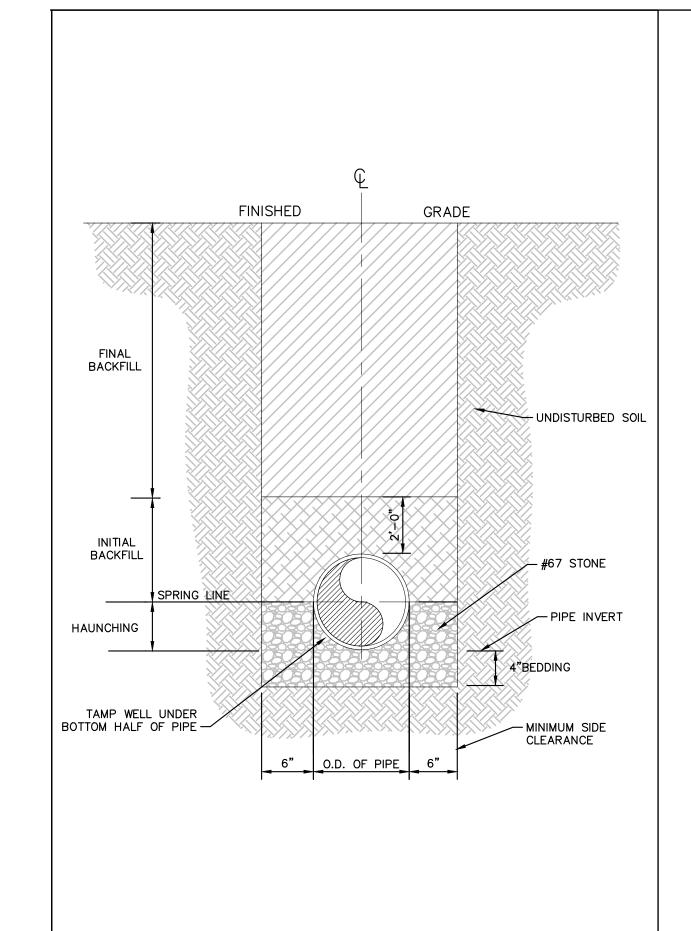



### <u>NOTES</u>


- FOR TRENCHES REQUIRING SHORING AND BRACING, DIMENSIONS SHALL BE TAKEN FROM THE INSIDE FACE OF THE SHORING AND BRACING.
- 2. NO ROCKS OR BOULDERS 4" OR LARGER TO BE USED IN INITIAL BACKFILL.
- 3. ALL BACKFILL MATERIAL SHALL BE SUITABLE NATIVE MATERIAL.
- 4. BACKFILL SHALL BE TAMPED IN 6" LIFTS IN TRAFFIC AREAS, 12" IN NON—TRAFFIC AREAS.

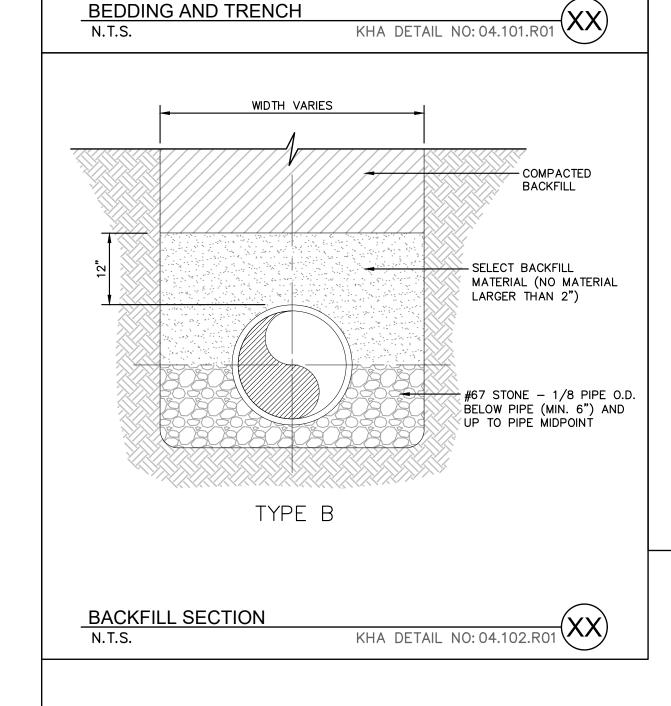

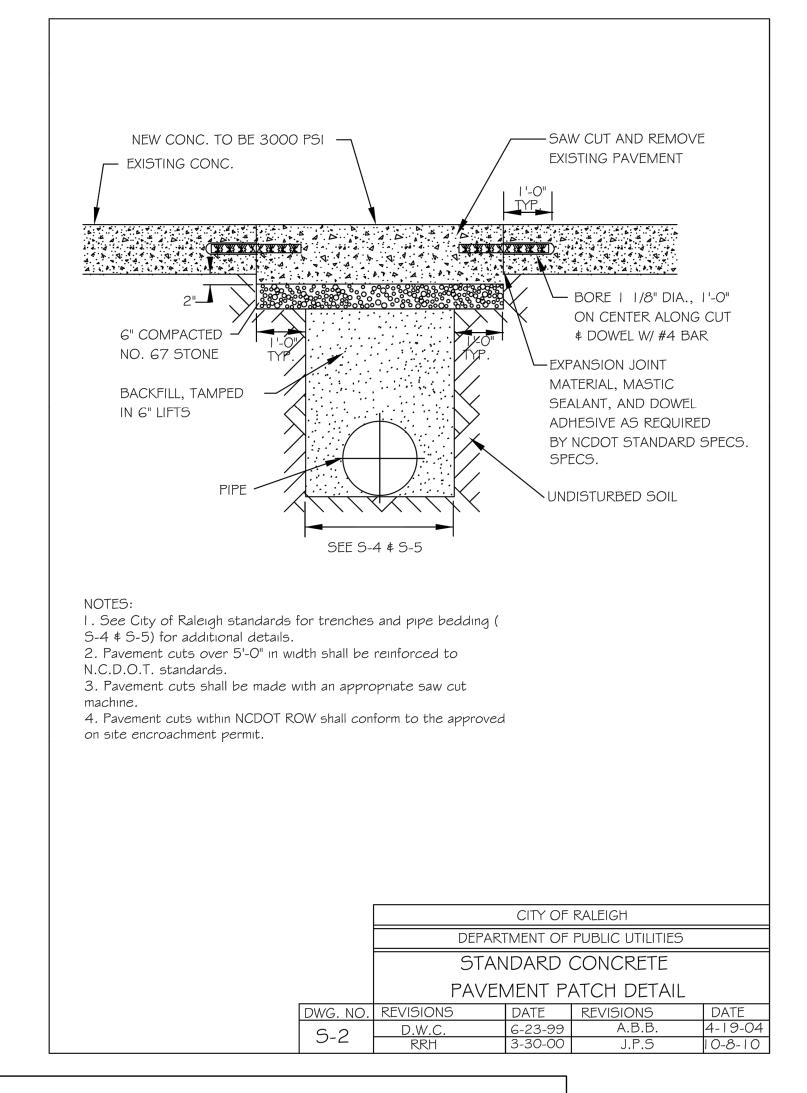

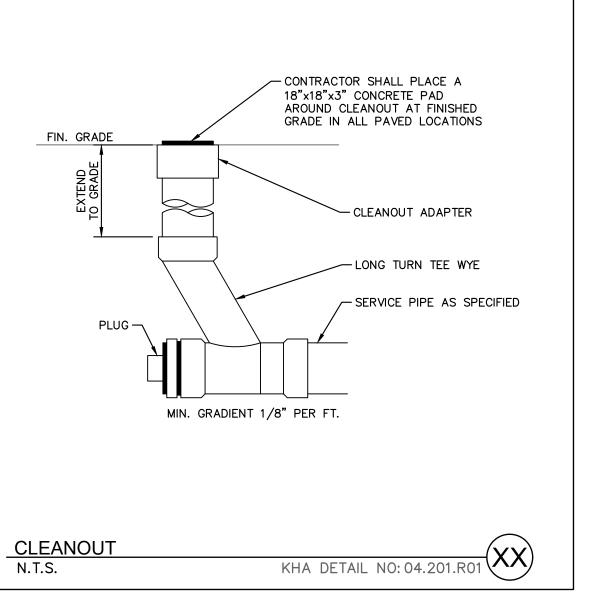

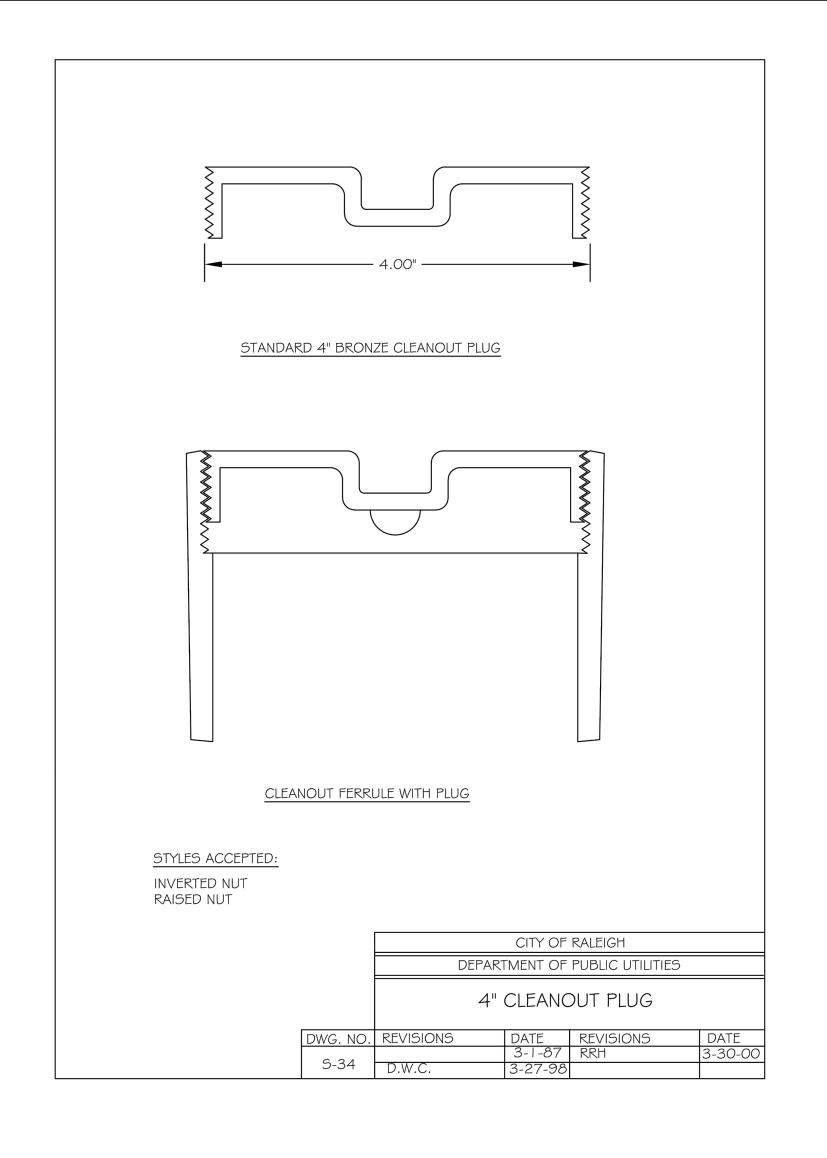

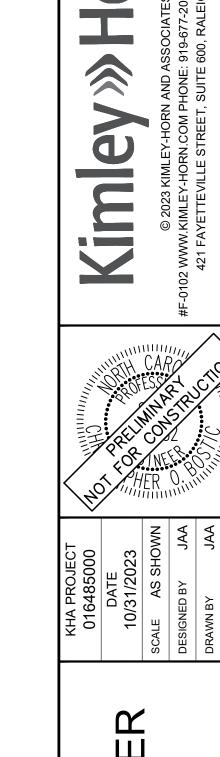

F @ @ 4 @ 0 F

SURVEY NOTE:

EXISTING TOPOGRAPHICAL INFORMATION IS BASED ON A
TOPOGRAPHIC SURVEY OBTAINED ON 02/23/2023 BY CMP
PROFESSIONAL LAND SURVEYORS, 333 S. WHITE STREET, WAKE
FOREST, NC, 27588, PHONE: (919) 556-3148. CONTRACTOR SHALL BE
RESPONSIBLE FOR VERIFYING ALL EXISTING INFORMATION,

DEPICTED OR NOT, PRIOR TO CONSTRUCTION AND REPORT POTENTIAL CONFLICTS TO OWNER AND ENGINEER.




ROLESVILLE
PREPARED FOR
S&S JAVA ENTERPRISES


SE


ANITAR DET


S

SHEET NUMBER C10.0

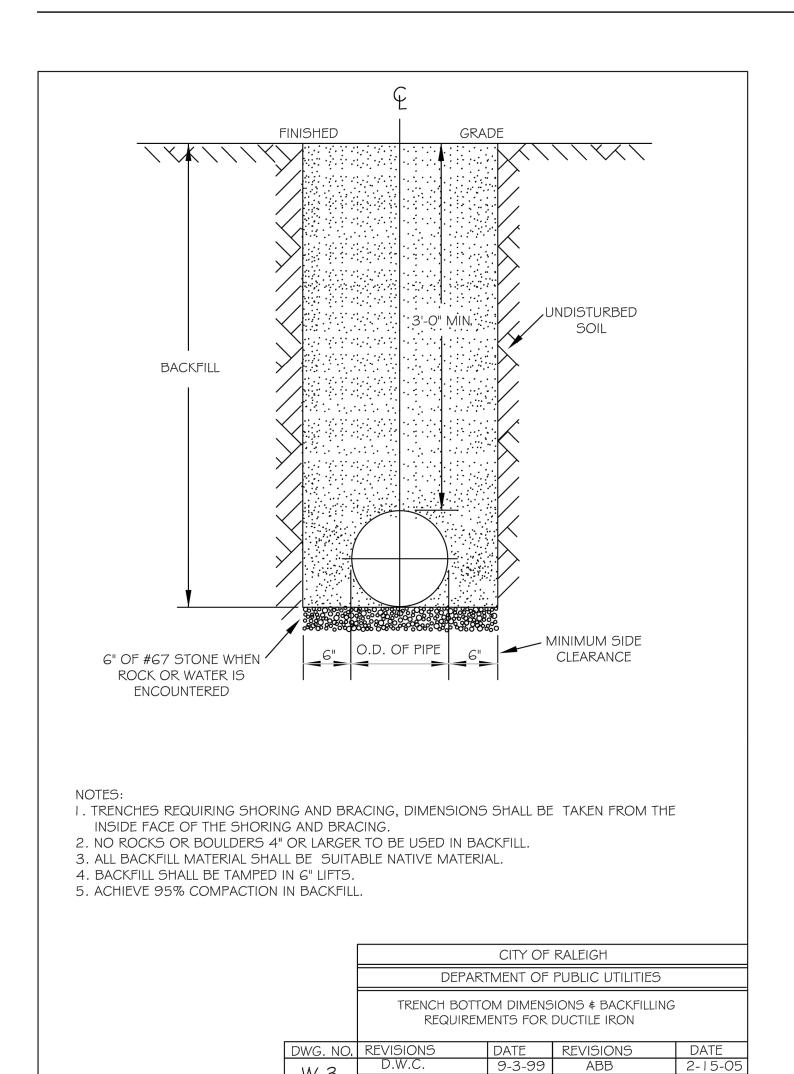

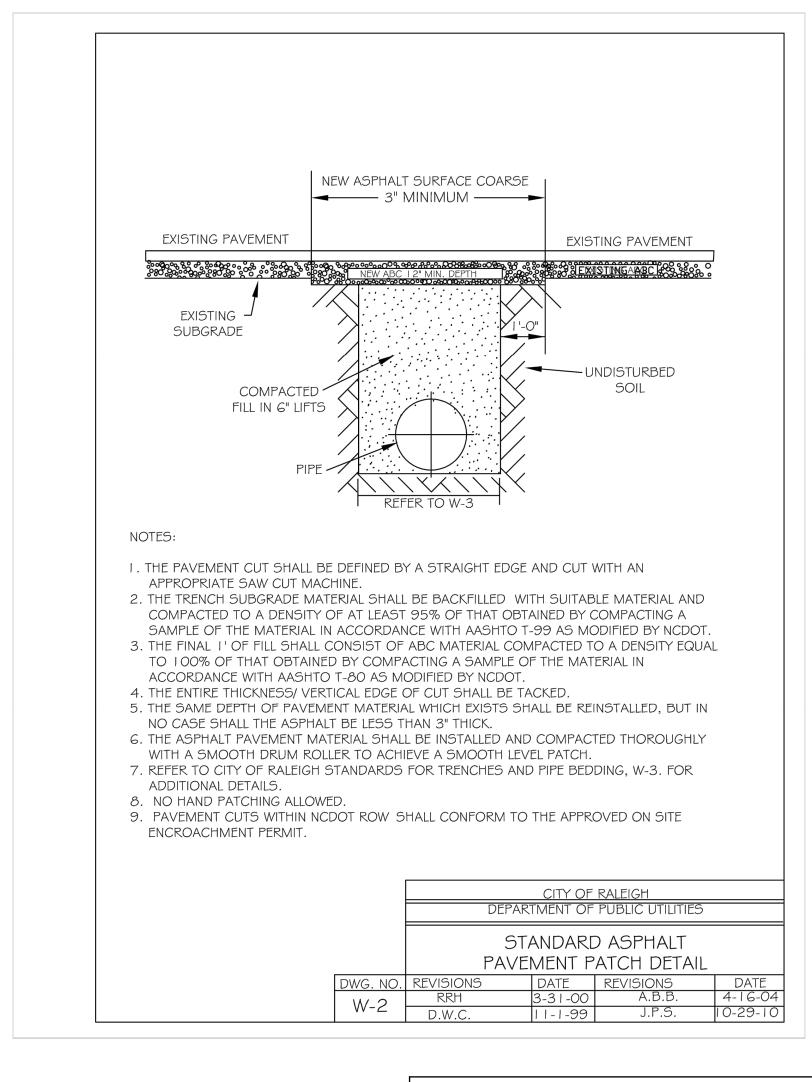

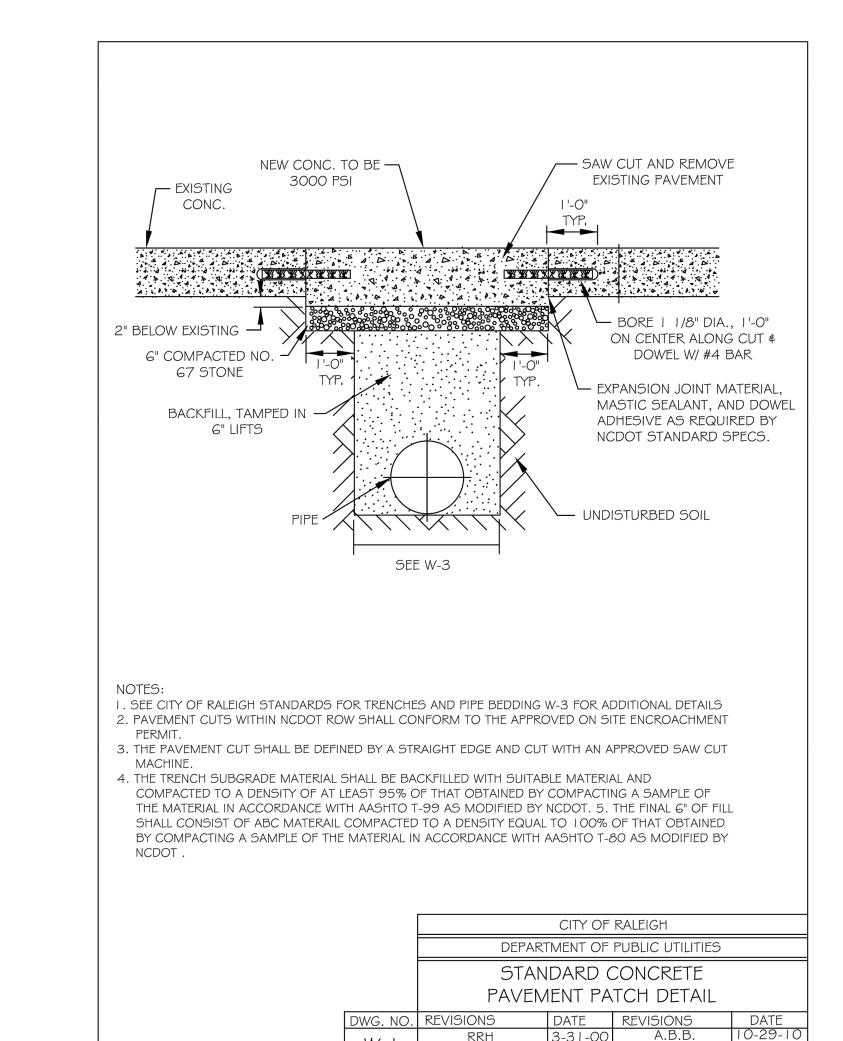

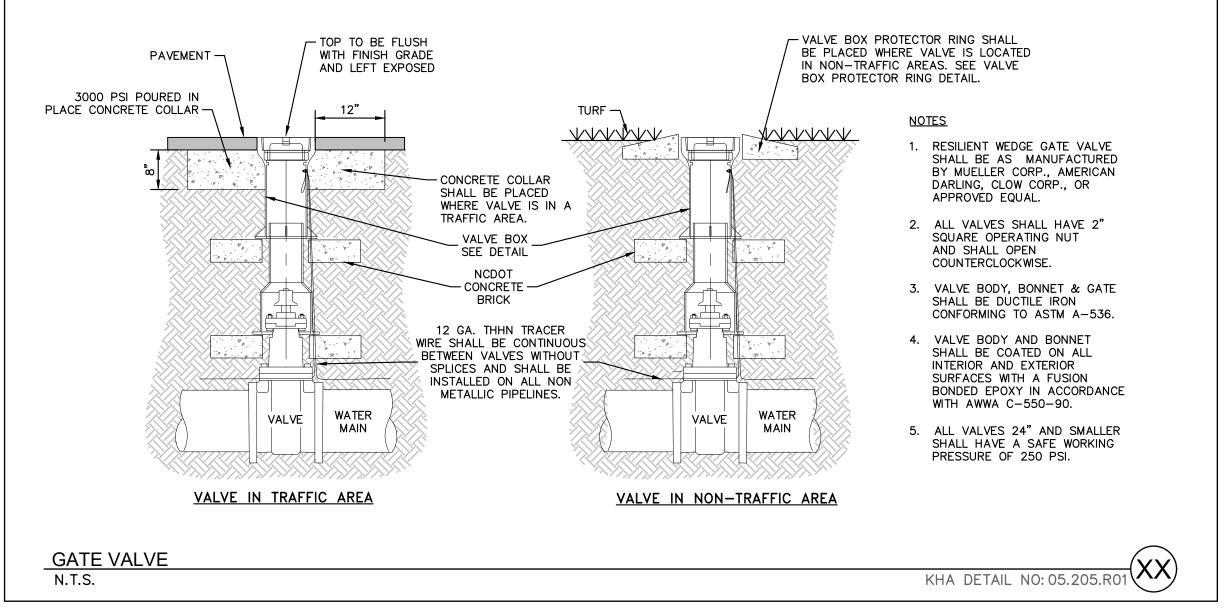

SURVEY NOTE:
EXISTING TOPOGRAPHICAL INFORMATION IS BASED ON A
TOPOGRAPHIC SURVEY OBTAINED ON 02/23/2023 BY CMP
PROFESSIONAL LAND SURVEYORS, 333 S. WHITE STREET, WAKE
FOREST, NC, 27588, PHONE: (919) 556-3148. CONTRACTOR SHALL BE
RESPONSIBLE FOR VERIFYING ALL EXISTING INFORMATION,
DEPICTED OR NOT, PRIOR TO CONSTRUCTION AND REPORT
POTENTIAL CONFLICTS TO OWNER AND ENGINEER.



© 2023 KIMLEY-HORN AND ASSOCIATES, INC. #F-0102 WWW.KIMLEY-HORN.COM PHONE: 919-677-2000 FAX: 9421 FAYETTEVILLE STREET, SUITE 600, RALEIGH, NC 2




10/31/2023
SCALE AS SHOWN
DESIGNED BY JAA


WATER DETAILS


ROLESVILLE
PREPARED FOR
JAVA ENTERPRISES


SHEET NUMBER


**∞** 

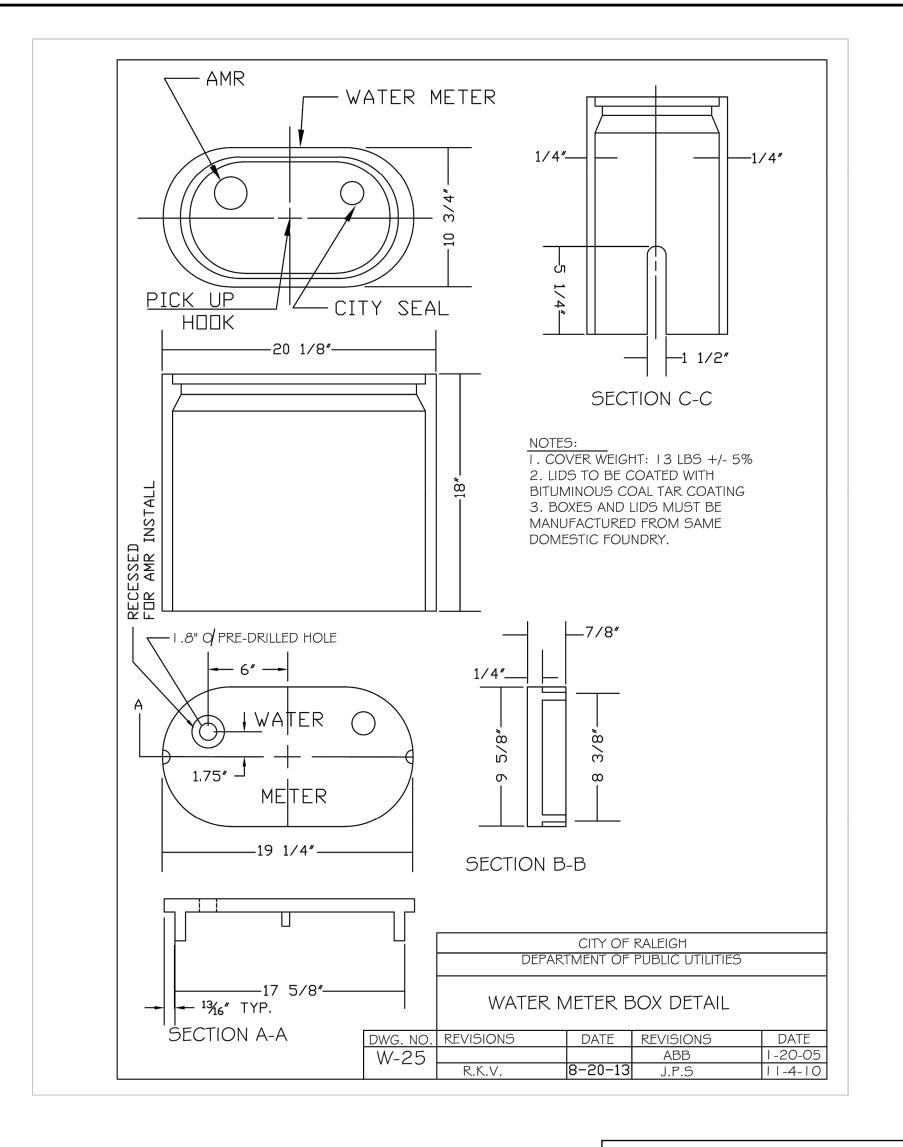


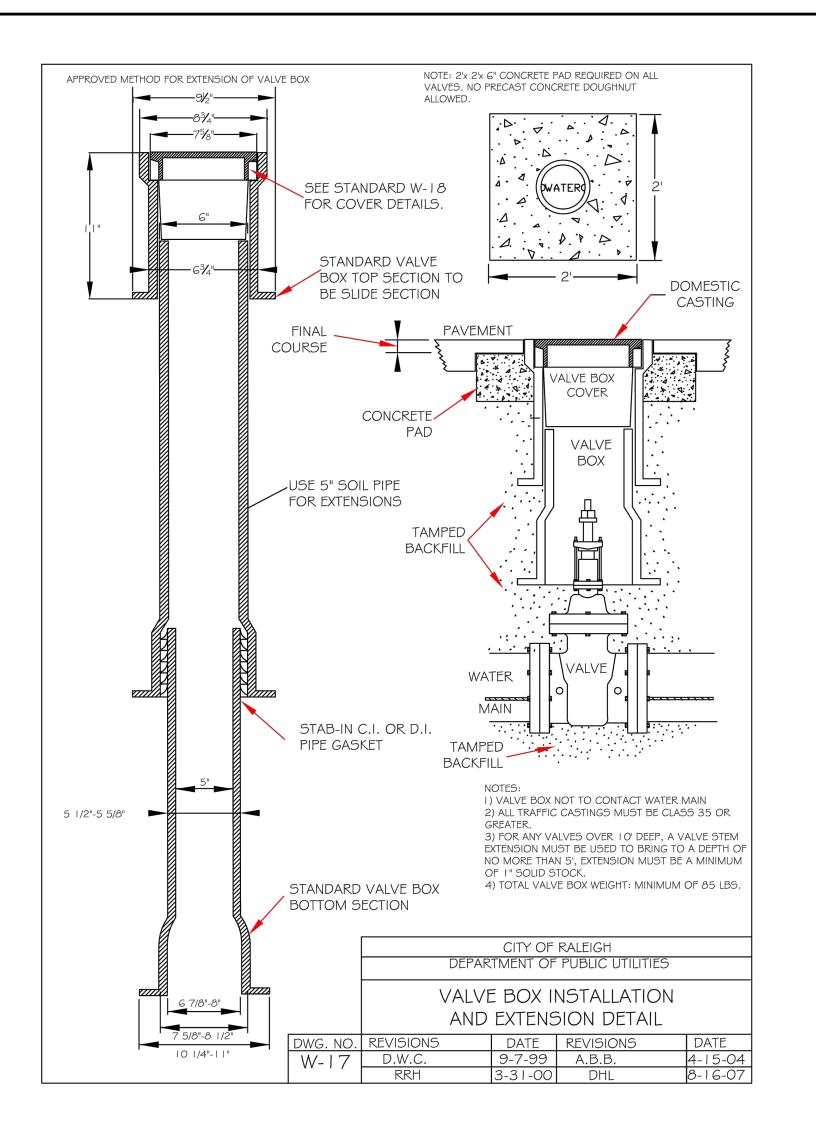

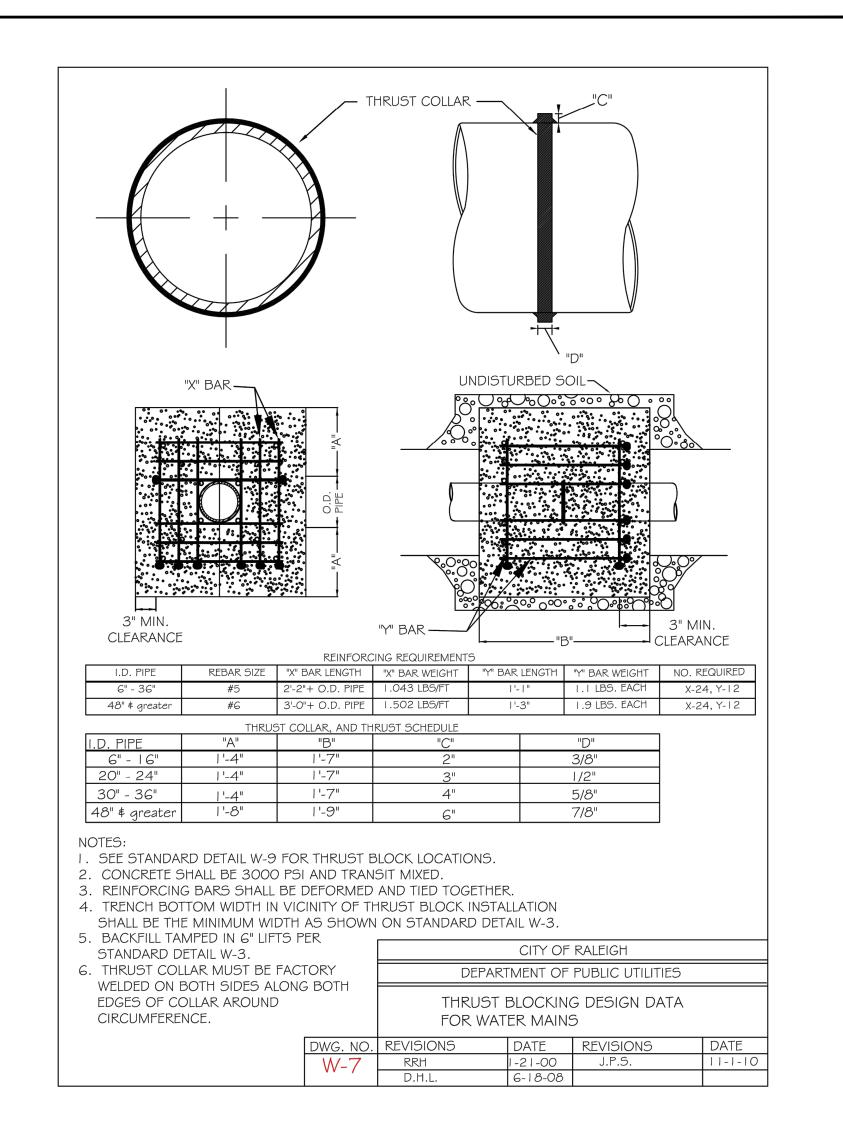

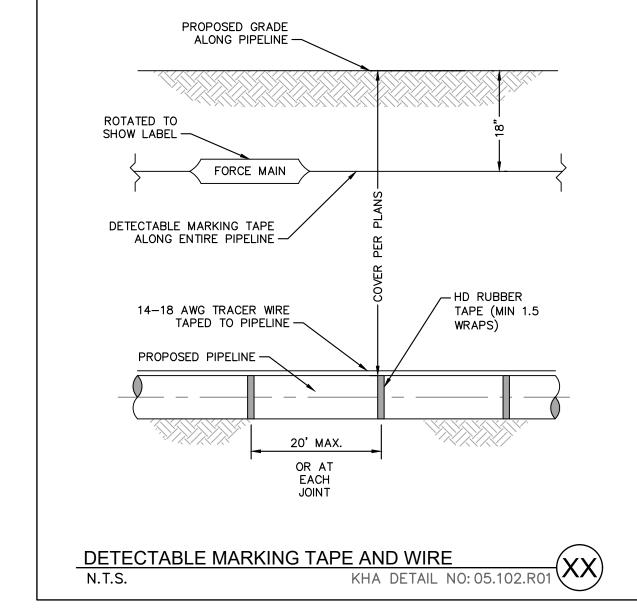

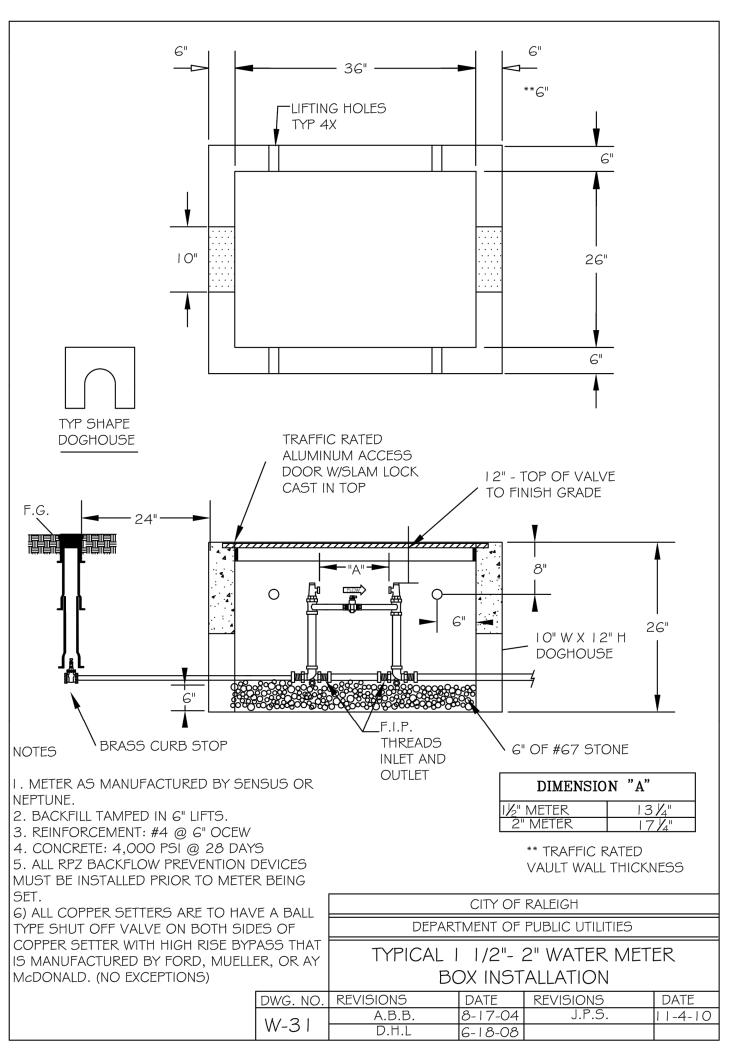

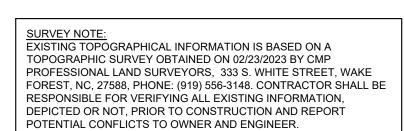



SCOOTER'S
ROLESVILLE
PREPARED FOR
S&S JAVA ENTERPRISES

**WATER** 

< 6 6 6 4 6 6 F

SHEET NUMBER
C11.1

### LANDSCAPE NOTES:

- 1. ALL LANDSCAPED AREAS ARE TO RECEIVE A MINIMUM OF 3" OF TOPSOIL. DO NOT MOUND MULCH AGAINST ROOT FLARES.
- 2. ALL PLANT MATERIAL SHALL BE HEALTHY, VIGOROUS, AND FREE OF PESTS AND DISEASE.
- 3. ALL MATERIALS ARE SUBJECT TO THE APPROVAL OF THE LANDSCAPE ARCHITECT BEFORE, DURING, AND AFTER INSTALLATION.
- 4. ALL TREES MUST BE GUYED OR STAKED AS SHOWN IN THE DETAILS.
- 5. ALL PLANTING AREAS SHALL BE COMPLETELY MULCHED AS SPECIFIED.
- 6. ANY DISTURBED GRASS AREA IS TO BE REPLANTED. ALL SLOPES 3:1 OR GREATER SHALL BE SEEDED WITH SLOPE MASTER NO-MOW MIX OR OWNER APPROVED EQUAL.
- 7. PRIOR TO CONSTRUCTION, THE CONTRACTOR SHALL BE RESPONSIBLE FOR LOCATING ALL UNDERGROUND UTILITIES AND SHALL AVOID DAMAGE TO ALL UTILITIES DURING THE COURSE OF THE WORK. LOCATIONS OF EXISTING BURIED UTILITY LINES SHOWN ON THE PLANS ARE BASED UPON BEST AVAILABLE INFORMATION AND ARE TO BE CONSIDERED APPROXIMATE. IT SHALL BE THE RESPONSIBILITY OF THE CONTRACTOR 1) TO VERIFY THE LOCATIONS OF UTILITY LINES AND ADJACENT TO THE WORK AREA 2) TO PROTECT OF ALL UTILITY LINES DURING THE CONSTRUCTION PERIOD 3) TO REPAIR ANY AND ALL DAMAGE TO UTILITIES, STRUCTURES, SITE APPURTENANCES, ETC. WHICH OCCURS AS A RESULT OF THE CONSTRUCTION.
- 8. THE CONTRACTOR SHALL BE RESPONSIBLE FOR VERIFYING ALL QUANTITIES SHOWN ON THESE PLANS BEFORE PRICING THE WORK.
- 9. CONTRACTOR SHALL BE RESPONSIBLE FOR DELIVERY SCHEDULE AND PROTECTION BETWEEN DELIVERY AND PLANTING TO MAINTAIN HEALTHY PLANT CONDITIONS.
- 10. THE CONTRACTOR SHALL BE RESPONSIBLE FOR FULLY MAINTAINING (INCLUDING BUT NOT LIMITED TO: WATERING, SPRAYING, MULCHING, FERTILIZING, ETC.) ALL OF THE PLANT MATERIALS AND LAWN FOR THE WARRANTY PERIOD.
- 11. ANY PLANT MATERIAL WHICH IS DISEASED, DISTRESSED, DEAD, OR REJECTED (PRIOR TO SUBSTANTIAL COMPLETION) SHALL BE PROMPTLY REMOVED FROM THE SITE AND REPLACED WITH MATERIAL OF THE SAME SPECIES, QUANTITY, AND SIZE AND MEETING ALL PLANT LIST SPECIFICATIONS.
- 12. THE CONTRACTOR SHALL COMPLETELY GUARANTEE ALL PLANT MATERIAL FOR WARRANTY PERIOD. THE CONTRACTOR SHALL PROMPTLY MAKE ALL REPLACEMENTS DURING THE NORMAL PLANTING SEASON.
- 13. STANDARDS SET FORTH IN "AMERICAN STANDARD FOR NURSERY STOCK" REPRESENT GUIDELINE SPECIFICATIONS ONLY AND SHALL CONSTITUTE MINIMUM QUALITY REQUIREMENTS FOR PLANT MATERIAL.
- 14. ALL LANDSCAPING SHALL BE INSTALLED ACCORDING TO SOUND NURSERY PRACTICES, AND SHALL BE STATE STANDARD OR BETTER
- 15. ALL INVASIVE / EXOTIC SPECIES AND PROHIBITED TREE SPECIES SHALL BE REMOVED FROM SITE, INCLUDING ROOT BALLS TO THE EXTENT POSSIBLE WITH NO DAMAGE TO ADJACENT EXISTING TREES.
- 16. CONTRACTOR TO DESIGN BUILD SYSTEM AND VERIFY ALL PRODUCTS WITH LANDSCAPE ARCHITECT.
- 17. TREE SUPPORT MATERIALS ARE TO BE REMOVED FROM EACH TREE ONCE IT IS "ESTABLISHED" (AS APPROVED BY THE LANDSCAPE ARCHITECT).
- 18. CONTRACTOR SHALL BE RESPONSIBLE FOR ENSURING ALL UTILITIES ARE ADEQUATELY SCREENED WITH THE REQUIRED PLANTING MATERIAL AND VERIFY PLANT SPECIES WITH LANDSCAPE ARCHITECT.
- 19. ALL PLANT SPECIFICATIONS IN THE PLANT SCHEDULE SHALL BE CONSIDERED THE MINIMUM ALLOWABLE SPECIFICATIONS. CONTRACTOR SHALL PROCURE PLANT MATERIALS AND UPSIZE AS NECESSARY TO MEET THE MOST STRINGENT SPECIFICATION.

PERIMETER BUFFER REQUIREMEN	TS 6.2.2.1	
Type 3 Perimeter Buffer: 136 lf	Required	Provided
Width	25 feet	Provided
Canopy Trees	4 canopy trees per 100 linear feet = 6 canopy trees	6 Canopy Trees
Understory Trees	2 understory trees per 100 linear feet = 3 understory trees	3 Understory Trees
Shrubs	60 shrubs per 100 linear feet = 82 shrubs	83 shrubs
STREET BUFFER 6.2.2.2		
Street Buffer: 126 lf	Required	Provided
Width	30 feet	Provided
Street Tree	1 per 40 linear feet = 4 street trees	4 Street Trees
PARKING LANDSCAPING 6.2.4.4		
Parking Perimeter	Required	Provided
Shrubs	Continious row of shrubs within 5 feet of the parking lot edge	Provided

### PLANT SCHEDULE

TREES	CODE	<u>QTY</u>	BOTANICAL NAME	COMMON NAME	CONT.	SIZE	<u>HEIGHT</u>
2 · · ·	AR	6	ACER RUBRUM	RED MAPLE	5 GAL	3" CAL.	10-12` MIN
	CF	3	CORNUS FLORIDA	FLOWERING DOGWOOD	5 GAL	2" CAL. MIN	8` MIN.
	MG	4	MAGNOLIA GRANDIFLORA	SOUTHERN MAGNOLIA	5 GAL	3" CAL.	10-12` MIN
SHRUBS	CODE	QTY	BOTANICAL NAME	COMMON NAME	CONT.	SIZE	
$\odot$	AJ	26	AUCUBA JAPONICA	JAPANESE LAUREL	5 GAL	24" HT.	
$\odot$	BS	37	BUXUS SEMPERVIRENS	COMMON BOXWOOD	5 GAL	24" HT.	
$\odot$	CE	35	CRYPTOMERIA JAPONICA 'ELEGANS NANA'	DWARF JAPANESE CEDAR	5 GAL	24" HT.	
(°)	IB	29	ILEX CORNUTA 'BURFORDII'	BURFORD HOLLY	5 GAL	24" HT.	

### NOTES:

 ESTABLISH SOD IN ALL DISTURBED AREAS. SEE SPECIFICATIONS FOR MORE INFORMATION.
 ALL AREAS WITH PROPOSED LANDSCAPE MATERIAL SHALL RECEIVE A MINIMUM THREE (3) INCHES OF SHREDDED HARDWOOD MULCH. SEE LANDSCAPE PLAN FOR MULCH BOUNDARY LINES. SEE LANDSCAPE DETAILS FOR TYPICAL MULCH AREA DIMENSIONS. SURVEY NOTE:
EXISTING TOPOGRAPHICAL INFORMATION IS BASED ON A
TOPOGRAPHIC SURVEY OBTAINED ON 02/23/2023 BY CMP
PROFESSIONAL LAND SURVEYORS, 333 S. WHITE STREET, WAKE
FOREST, NC, 27588, PHONE: (919) 556-3148. CONTRACTOR SHALL BE
RESPONSIBLE FOR VERIFYING ALL EXISTING INFORMATION,
DEPICTED OR NOT, PRIOR TO CONSTRUCTION AND REPORT
POTENTIAL CONFLICTS TO OWNER AND ENGINEER.



2050 2 ---- --- ---- ---- DATE

© 2023 KIMLEY-HORN AND ASSOCIATES, INC. WW.KIMLEY-HORN.COM PHONE: 919-677-2000 FAX: 919-67 1 FAYETTEVILLE STREET, SUITE 600, RALEIGH, NC 27601




ALE AS SHOWN SIGNED BY JAA


ANDSCAPE PLAN

FARED FOR ENTERPRISES

ROLESVIL
PREPARED FOF

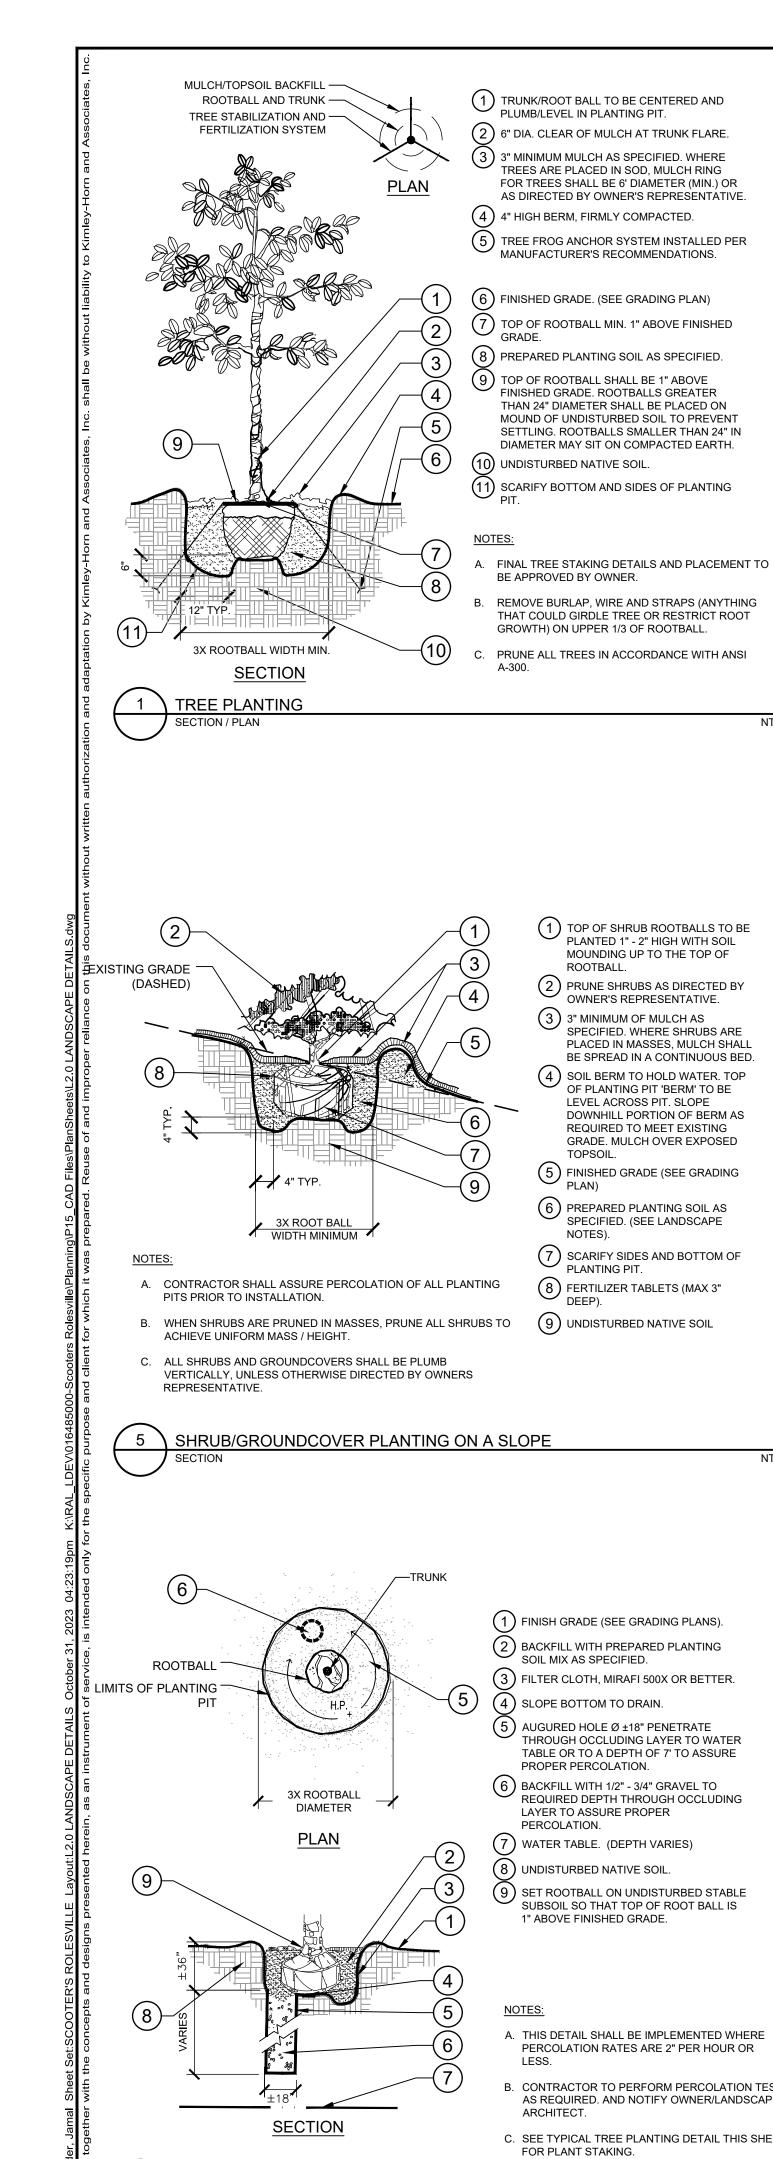

9 \ POOR DRAINAGE CONDITION

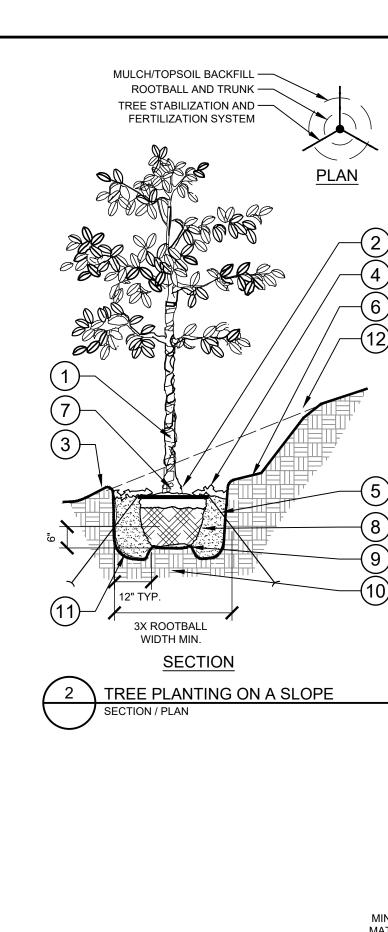

PLUMB/LEVEL IN PLANTING PIT.

TREES ARE PLACED IN SOD, MULCH RING

MANUFACTURER'S RECOMMENDATIONS.

FINISHED GRADE. ROOTBALLS GREATER

THAN 24" DIAMETER SHALL BE PLACED ON

MOUND OF UNDISTURBED SOIL TO PREVENT

SETTLING. ROOTBALLS SMALLER THAN 24" IN

DIAMETER MAY SIT ON COMPACTED EARTH.

THAT COULD GIRDLE TREE OR RESTRICT ROOT

1) TOP OF SHRUB ROOTBALLS TO BE PLANTED 1" - 2" HIGH WITH SOIL

MOUNDING UP TO THE TOP OF

PRUNE SHRUBS AS DIRECTED BY OWNER'S REPRESENTATIVE.

SPECIFIED. WHERE SHRUBS ARE PLACED IN MASSES, MULCH SHALL BE SPREAD IN A CONTINUOUS BED. 1) SOIL BERM TO HOLD WATER. TOP

OF PLANTING PIT 'BERM' TO BE

DOWNHILL PORTION OF BERM AS

LEVEL ACROSS PIT. SLOPE

REQUIRED TO MEET EXISTING

(5) FINISHED GRADE (SEE GRADING

SPECIFIED. (SEE LANDSCAPE

SCARIFY SIDES AND BOTTOM OF PLANTING PIT.

8 FERTILIZER TABLETS (MAX 3" DEEP).

9 UNDISTURBED NATIVE SOIL

(2) BACKFILL WITH PREPARED PLANTING

THROUGH OCCLUDING LAYER TO WATER

TABLE OR TO A DEPTH OF 7' TO ASSURE

REQUIRED DEPTH THROUGH OCCLUDING

9) SET ROOTBALL ON UNDISTURBED STABLE

SUBSOIL SO THAT TOP OF ROOT BALL IS

A. THIS DETAIL SHALL BE IMPLEMENTED WHERE

PERCOLATION RATES ARE 2" PER HOUR OR

. CONTRACTOR TO PERFORM PERCOLATION TEST AS REQUIRED. AND NOTIFY OWNER/LANDSCAPE

C. SEE TYPICAL TREE PLANTING DETAIL THIS SHEET

SOIL MIX AS SPECIFIED.

(4) SLOPE BOTTOM TO DRAIN.

PROPER PERCOLATION.

8) UNDISTURBED NATIVE SOIL.

1" ABOVE FINISHED GRADE.

FOR PLANT STAKING.

PERCOLATION.

(6) BACKFILL WITH 1/2" - 3/4" GRAVEL TO

LAYER TO ASSURE PROPER

(6) PREPARED PLANTING SOIL AS

GRADE. MULCH OVER EXPOSED

3) 3" MINIMUM OF MULCH AS

ROOTBALL.


TOPSOIL.

GROWTH) ON UPPER 1/3 OF ROOTBALL.

BE APPROVED BY OWNER.

FOR TREES SHALL BE 6' DIAMETER (MIN.) OR


AS DIRECTED BY OWNER'S REPRESENTATIVE.

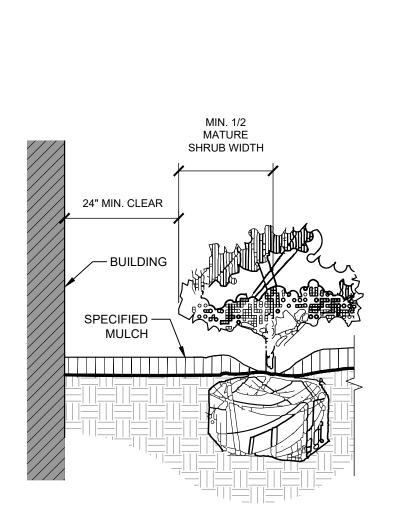

### 1. CLEAR ZONE: 36" MIN. FROM BUILDING TO CENTER OF NEAREST SHRUB.

2. INSTALL SPECIFIED MULCH: 24" MIN. FROM BUILDING. SPECIFIED MULCH TO BE INSTALLED AT A DEPTH OF 3" (MIN.)



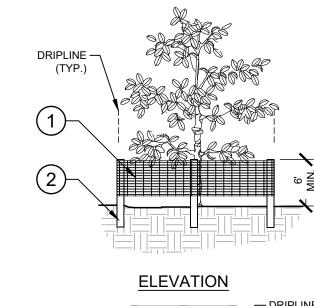

<u>PLAN</u>

CONNECTION

**INSTALLATION NOTES:** A. POST SELECTION SHOULD BE BASED ON EXPECTED STRENGTH NEEDS AND THE LENGTH OF TIME FENCE WILL BE IN PLACE. FLEXIBLE FIBERGLASS ROD POSTS ARE RECOMMENDED FOR PARKS, ATHLETIC EVENTS AND CROWD CONTROL INSTALLATIONS. METAL "T" POSTS OR TREATED WOOD POSTS ARE TYPICALLY USED FOR

(1) 6'H "PERIMETER PLUS" CONSTRUCTION FENCE BY CONWED PLASTICS OR OWNER'S

REPRESENTATIVE APPROVED EQUAL.

SUBMIT PRODUCT INFORMATION FOR

2) 8' TALL METAL "T" POSTS OR 2" x 2" X 8' PRESSURE TREATED WOOD POSTS WITH 24"

APPROVAL PRIOR TO INSTALLATION.

BURIAL BELOW GRADE.

(1) TRUNK/ROOT BALL TO BE CENTERED AND

(2) 6" DIA. CLEAR OF MULCH AT TRUNK FLARE.

. ) 3" MINIMUM OF HARDWOOD BARK MULCH

AS SPECIFIED. WHERE TREES ARE PLACED

IN SOD, MULCH RING FOR TREES SHALL BE

(5) TREE FROG ANCHOR SYSTEM INSTALLED PER

MANUFACTURER'S RECOMMENDATIONS.

(6) 4" MIN. OF TOPSOIL TO BRING TO FINISHED

(7) TOP OF ROOTBALL MIN. 1" ABOVE FINISHED

(8) PREPARED PLANTING SOIL AS SPECIFIED.

(9) ROOTBALLS GREATER THAN 24" DIAMETER

(11) SCARIFY BOTTOM AND SIDES OF PLANTING

UNDISTURBED SOIL TO PREVENT SETTLING.

DIAMETER MAY SIT ON COMPACTED EARTH.

A. FINAL TREE STAKING DETAILS AND PLACEMENT TO

REMOVE BURLAP, WIRE AND STRAPS (ANYTHING

THAT COULD GIRDLE TREE OR RESTRICT ROOT

GROWTH) ON UPPER 1/3 OF ROOTBALL.

C. PRUNE ALL TREES IN ACCORDANCE WITH ANSI

SHALL BE PLACED ON MOUND OF

ROOTBALLS SMALLER THAN 24" IN

(12) CUT BACK SLOPE TO PROVIDE A FLAT

(10) UNDISTURBED NATIVE SOIL.

SURFACE FOR PLANTING.

BE APPROVED BY OWNER.

6' DIAMETER (MIN.) OR AS DIRECTED BY

(3) 3. 4" HIGH BERM, FIRMLY COMPACTED.

PLUMB/LEVEL IN PLANTING PIT.

OWNER'S REPRESENTATIVE.

GRADE. (SEE GRADING PLAN)

BEST FACE OF SHRUB/

REFER TO PLANT

AT BED EDGE.

3X ROOT BALL WIDTH

MINIMUM

SHRUB/GROUNDCOVER PLANTING

REPRESENTATIVE.

A. CONTRACTOR SHALL ASSURE PERCOLATION OF ALL PLANTING PITS PRIOR TO INSTALLATION.

B. WHEN SHRUBS ARE PRUNED IN MASSES, PRUNE ALL SHRUBS TO ACHIEVE UNIFORM MASS / HEIGHT

C. ALL SHRUBS AND GROUNDCOVERS SHALL BE PLUMB VERTICALLY, UNLESS OTHERWISE DIRECTED BY OWNERS

MIN. 1/2 MATURE

SHRUB WIDTH

**GROUNDCOVER TO FACE** 

FRONT OF PLANTING BED.

SCHEDULE FOR SPACING.

MAINTAIN 12" DEAD ZONE

CONSTRUCTION AND OTHER APPLICATIONS. B. POSTS SHOULD BE DRIVEN INTO THE GROUND TO A DEPTH OF 1/3 OF THE HEIGHT OF THE POST. FOR EXAMPLE, A 6' POST SHOULD BE SET AT LEAST 2' INTO THE GROUND.


C. SPACE POSTS EVERY 6' (MIN.) TO 8' (MAX.). D. SECURE FENCING TO POST WITH NYLON CABLE TIES (AVAILABLE FROM CONWED PLASTICS). WOOD STRIPS MAY

PROTECTION BETWEEN TIES AND POSTS.

BE ALSO BE USED TO PROVIDE ADDITIONAL SUPPORT AND

NOTE: IF WIRE TIES ARE USED, AVOID DIRECT CONTACT WITH FENCE. WIRE MAY DAMAGE FENCE OVER TIME.

TREE PROTECTION FENCING

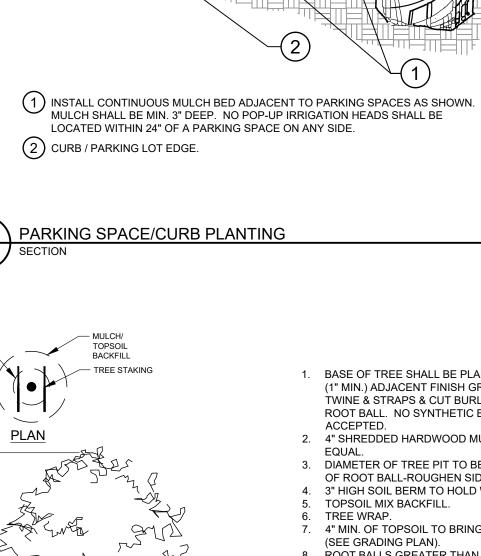

1. BASE OF TREE SHALL BE PLANTED SLIGHTLY ABOVE (1" MIN.) ADJACENT FINISH GRADE. REMOVE ALL TWINE & STRAPS & CUT BURLAP FROM TOP 1/3 OF ROOT BALL. NO SYNTHETIC BURLAP WILL BE 2. 4" SHREDDED HARDWOOD MULCH OR APPROVED 3. DIAMETER OF TREE PIT TO BE TWICE THE DIAMETER OF ROOT BALL-ROUGHEN SIDES OF TREE PIT. 4. 3" HIGH SOIL BERM TO HOLD WATER. 5. TOPSOIL MIX BACKFILL. 6. TREE WRAP. 7. 4" MIN. OF TOPSOIL TO BRING TO FINISHED GRADE (SEE GRADING PLAN). 8. ROOT BALLS GREATER THAN 24" DIAMETER SHALL BE PLACED ON MOUND OF UNDISTURBED SOIL TO PREVENT SETTLING ROOT BALLS SMALLER THAN 24" IN DIA. MAY SIT ON COMPACTED EARTH. UNDISTURBED SUBSOIL. 10. PREPARE PLANTING SOIL AS SPECIFIED. Tree Frog® RBK40pt FOR UP TO 4" TREE CALIPER OR Tree Frog® RBK60pt FOR GREATER THAN 4" AND UP

(1) TOP OF SHRUB ROOTBALLS TO

OF ROOTBALL.

MASS/HEIGHT.

(3) 3" MULCH LAYER AS

(4) EXCAVATE ENTIRE BED

5 FINISHED GRADE (SEE GRADING PLAN).

MIX AS SPECIFIED.

(7) SCARIFY OF PLANTING PIT

(9) UNDISTURBED NATIVE SOIL.

(10) FERTILIZER TABLETS (MAX 3"

SIDES AND BOTTOM.

(8) 4" HIGH BERM FIRMLY

COMPACTED.

(6) PREPARED PLANTING SOIL AS

SPECIFIED. (SEE LANDSCAPE NOTES) NOTE: WHEN GROUND-

COVERS AND SHRUBS USED IN

AMENDED WITH PLANTING SOIL

MASSES, ENTIRE BED TO BE

SPECIFIED.

2) PRUNE ALL SHRUBS TO

ACHIEVE A UNIFORM

BE PLANTED 1" - 2" HIGH WITH

SOIL MOUNDING UP TO THE TOP

SPECIFIED FOR GROUNDCOVER


TO 6" TREE CALIPER. REFER TO SITEWORK SPECIFICATIONS FOR APPROVED MATERIALS AND INSTALLATION REQUIREMENTS.

A. FINAL TREE STAKING DETAILS AND PLACEMENT TO BE APPROVED BY OWNER.

B. SET TREE AT ORIGINAL DEPTH. REMOVE BURLAP, WIRE AND STRAPS (ANYTHING THAT COULD GIRDLE TREE OR RESTRICT ROOT GROWTH) ON UPPER 1/3 OF ROOTBALL.

C. SEE LANDSCAPE NOTES FOR THE TYPE OF MULCH MATERIAL TO USE. D. PRUNE TREE AS DIRECTED BY LANDSCAPE ARCHITECT E. ASSURE PERCOLATION OF ALL PLANTING PITS

MULTI-TRUNK TREE PLANTING

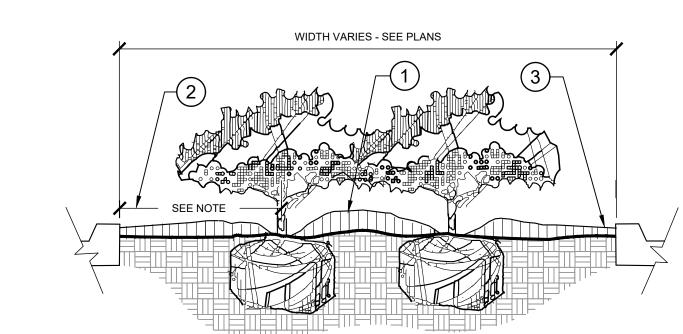

(1) CROWN ISLANDS @ 5:1 SLOPES (OR AS SPECIFIED ON THE LANDSCAPE PLANS).


2 ) CLEAR ZONE: 36" MIN. FROM BACK OF CURB TO CENTER OF NEAREST SHRUB. CLEAR ZONE SHALL CONTAIN 3" CONTINUOUS MULCH OR TURF, SEE PLANS. (3) 2" MIN VERTICAL CLEARANCE, TOP OF CURB TO TOP OF MULCH.


A. EXCAVATE A CONTINUOUS 24" DEEP PIT (FROM TOP OF CURB) FOR ENTIRE LENGTH AND WIDTH OF ISLAND & BACKFILL WITH APPROVED PLANTING MIX.

B. PROTECT AND RETAIN ALL CURBS AND BASE. COMPACTED SUBGRADE TO REMAIN FOR STRUCTURAL SUPPORT OF CURB SYSTEM (TYP).

C. ALL ISLANDS SHALL UTILIZE POOR DRAINAGE DETAIL WHEN PERCOLATION RATES ARE 2" PER HOUR

PLANTED PARKING LOT ISLANDS/MEDIANS

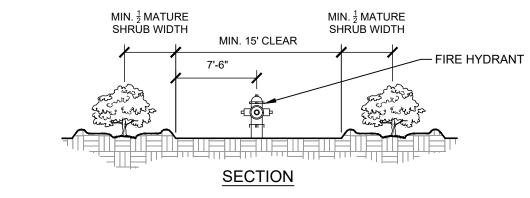

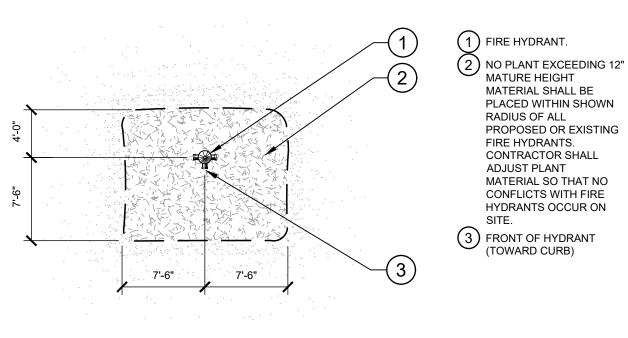

SHRUB PLANTING AT FIRE HYDRANT

Know what's below. Call before you dig.

66466

### A. SCOPE OF WORK

- THE WORK CONSISTS OF: FURNISHING ALL LABOR, MATERIALS, EQUIPMENT, TOOLS, TRANSPORTATION, AND ANY OTHER APPURTENANCES NECESSARY FOR THE COMPLETION OF THIS PROJECT AS SHOWN ON THE DRAWINGS, AS INCLUDED IN THE PLANT LIST, AND AS SPECIFIED
- WORK SHALL INCLUDE MAINTENANCE AND WATERING OF ALL CONTRACT PLANTING AREAS UNTIL CERTIFICATION OF ACCEPTANCE BY THE

### B. PROTECTION OF EXISTING STRUCTURES

- ALL EXISTING BUILDINGS, WALKS, WALLS, PAVING, PIPING, OTHER SITE CONSTRUCTION ITEMS, AND PLANTING ALREADY COMPLETED OR ESTABLISHED AND DESIGNATED TO REMAIN SHALL BE PROTECTED FROM DAMAGE BY THE CONTRACTOR UNLESS OTHERWISE SPECIFIED. ALL DAMAGE RESULTING FROM NEGLIGENCE SHALL BE REPAIRED OR REPLACED TO THE SATISFACTION OF THE OWNER, AT NO COST TO THE
- THE CONTRACTOR SHALL BE RESPONSIBLE FOR MAINTAINING ALL NECESSARY BMP DEVICES ACCORDING TO ALL REGULATORY AGENCY'S STANDARDS THROUGH THE DURATION OF ALL CONSTRUCTION ACTIVITIES.
- THE CONTRACTOR SHALL SUBMIT A DETAILED PROJECT SPECIFIC WORK ZONE TRAFFIC CONTROL PLAN UNLESS THE WORK REQUIRES NOTHING MORE THAN A DIRECT APPLICATION OF DOT DESIGN STANDARDS, INDEX 600. IF A DIRECT APPLICATION OF INDEX 600 IS PROPOSED, THE CONTRACTOR SHALL SUBMIT IN WRITING A STATEMENT INDICATING THE STANDARD INDEX AND PAGE NUMBER NO LESS THAN 10 BUSINESS DAYS PRIOR TO START OF CONSTRUCTION. WHEN A DIRECT APPLICATION OF DOT STANDARD INDEX 600 IS NOT ACCEPTABLE A PROJECT SPECIFIC WORK ZONE TRAFFIC CONTROL PLAN SHALL BE PREPARED BY A PROFESSIONAL ENGINEER WHO HAS SUCCESSFULLY COMPLETED ADVANCED TRAINING IN MAINTENANCE OF TRAFFIC, AS DEFINED BY DOT FOR APPROVAL BY THE COUNTY ENGINEER'S REPRESENTATIVE.
- 4. THE CONTRACTOR SHALL BE RESPONSIBLE FOR LOCATING ALL UTILITIES, WHETHER PUBLIC OR PRIVATE, PRIOR TO EXCAVATION. THE INFORMATION AND DATA SHOWN WITH RESPECT TO EXISTING UNDERGROUND FACILITIES AT OR CONTIGUOUS TO THE SITE IS APPROXIMATE AND BASED ON INFORMATION FURNISHED BY THE OWNER OF SUCH UNDERGROUND FACILITIES OR ON PHYSICAL APPURTENANCES OBSERVED IN THE FIELD. THE OWNER AND DESIGN PROFESSIONAL SHALL NOT BE RESPONSIBLE FOR THE ACCURACY AND COMPLETENESS OF ANY SUCH INFORMATION OR DATA. THE CONTRACTOR SHALL HAVE FULL RESPONSIBILITY FOR; REVIEWING AND CHECKING ALL SUCH INFORMATION AND DATA; LOCATING ALL UNDERGROUND FACILITIES DURING CONSTRUCTION; THE SAFETY AND PROTECTION THEREOF; REPAIRING ANY DAMAGE THERETO RESULTING FROM THE WORK. THE COST OF ALL WILL BE CONSIDERED AS HAVING BEEN INCLUDED IN THE CONTRACT PRICE. THE CONTRACTOR SHALL NOTIFY ANY AFFECTED UTILITY COMPANIES OR AGENCIES IN WRITING AT LEAST 48 HOURS PRIOR TO BEGINNING

### C. PROTECTION OF EXISTING PLANT MATERIALS

THE CONTRACTOR SHALL BE RESPONSIBLE FOR ALL UNAUTHORIZED CUTTING OR DAMAGE TO TREES AND SHRUBS EXISTING OR OTHERWISE CAUSED BY CARELESS EQUIPMENT OPERATION, MATERIAL STOCKPILING, ETC... THIS SHALL INCLUDE COMPACTION BY DRIVING OR PARKING INSIDE THE DRIP-LINE AND SPILLING OIL, GASOLINE, OR OTHER DELETERIOUS MATERIALS WITHIN THE DRIP-LINE. NO MATERIALS SHALL BE BURNED ON SITE. EXISTING TREES KILLED OR DAMAGED SO THAT THEY ARE MISSHAPEN AND/OR UNSIGHTLY SHALL BE REPLACED AT THE COST TO THE CONTRACTOR OF THREE HUNDRED DOLLARS (\$300) PER CALIPER INCH ON AN ESCALATING SCALE WHICH ADDS AN ADDITIONAL TWENTY (20) PERCENT PER INCH OVER FOUR (4) INCHES CALIPER AS FIXED AND AGREED LIQUIDATED DAMAGES. CALIPER SHALL BE MEASURED SIX (6) INCHES ABOVE GROUND LEVEL FOR TREES UP TO AND INCLUDING FOUR (4) INCHES IN CALIPER AND TWELVE (12) INCHES ABOVE GROUND LEVEL FOR TREES OVER FOUR (4) INCHES IN CALIPER.

2. SEE TREE MITIGATION PLAN AND NOTES, IF APPLICABLE

### D. MATERIALS

### GENERAL

MATERIAL SAMPLES LISTED BELOW SHALL BE SUBMITTED FOR APPROVAL, ON SITE OR AS DETERMINED BY THE OWNER. UPON APPROVAL DELIVERY OF MATERIALS MAY COMMENCE

ONE (1) CUBIC FOOT TOPSOIL MIX PLANTS ONE (1) OF EACH VARIETY (OR TAGGED IN NURSERY)

### 2. PLANT MATERIALS

- a. PLANT SPECIES AND SIZE SHALL CONFORM TO THOSE INDICATED ON THE DRAWINGS. ALL PLANTS SHALL BE DETERMINED BY THE STATE DIVISION OF PLANT INDUSTRY. ALL PLANTS SHALL BE HEALTHY, VIGOROUS, SOUND, WELL-BRANCHED, AND FREE OF DISEASE AND INSECTS INSECT EGGS AND LARVAE AND SHALL HAVE ADEQUATE ROOT SYSTEMS. TREES FOR PLANTING IN ROWS SHALL BE UNIFORM IN SIZE AND SHAPE. ALL MATERIALS SHALL BE SUBJECT TO APPROVAL BY THE OWNER. WHERE ANY REQUIREMENTS ARE OMITTED FROM THE PLANT LIST, THE PLANTS FURNISHED SHALL BE NORMAL FOR THE VARIETY. PLANTS SHALL BE PRUNED PRIOR TO DELIVERY ONLY WITH APPROVAL FROM OWNER OR OWNER'S REPRESENTATIVE. NO SUBSTITUTIONS SHALL BE MADE WITHOUT WRITTEN PERMISSION FROM THE OWNER'S
- b. MEASUREMENTS: THE HEIGHT AND/OR WIDTH OF TREES SHALL BE MEASURED FROM THE GROUND OR ACROSS THE NORMAL SPREAD OF BRANCHES WITH THE PLANTS IN THEIR NORMAL POSITION. THIS MEASUREMENT SHALL NOT INCLUDE THE IMMEDIATE TERMINAL GROWTH. PLANTS LARGER IN SIZE THAN THOSE SPECIFIED IN THE PLANT LIST MAY BE USED IF APPROVED BY THE OWNER. IF THE USE OF LARGER PLANTS IS APPROVED, THE BALL OF EARTH OR SPREAD OF ROOTS SHALL BE INCREASED IN PROPORTION TO THE SIZE OF THE PLANT.
- c. INSPECTION: PLANTS SHALL BE SUBJECT TO INSPECTION AND APPROVAL AT THE PLACE OF GROWTH, OR UPON DELIVERY TO THE SITE, AS DETERMINED BY THE OWNER, FOR QUALITY, SIZE, AND VARIETY. SUCH APPROVAL SHALL NOT IMPAIR THE RIGHT OF INSPECTION AND REJECTION AT THE SITE DURING PROGRESS OF THE WORK OR AFTER COMPLETION FOR SIZE AND CONDITION OF ROOT BALLS OR ROOTS, LATENT DEFECTS OR INJURIES. REJECTED PLANTS SHALL BE REMOVED IMMEDIATELY FROM THE SITE. NOTICE REQUESTING INSPECTION SHALL BE SUBMITTED IN WRITING BY THE CONTRACTOR AT LEAST ONE (1) WEEK PRIOR TO ANTICIPATED DATE.

### E. SOIL MIXTURE (PLANTING MEDIUM, PLANTING MIX, TOPSOIL MIX)

- 1. CONTRACTOR SHALL TEST EXISTING SOIL AND AMEND AS NECESSARY IN ACCORDANCE WITH THE GUIDELINES BELOW:
- 2. SOIL MIXTURE (PLANTING MEDIUM FOR PLANT PITS) SHALL CONSIST OF TWO PARTS OF TOPSOIL AND ONE PART SAND, AS DESCRIBED BELOW. CONTRACTOR TO SUBMIT SAMPLES AND PH TESTING RESULTS OF SOIL MIXTURE FOR OWNER'S REPRESENTATIVE APPROVAL PRIOR TO PLANT
- a. TOPSOIL FOR USE IN PREPARING SOIL MIXTURE FOR BACKFILLING PLANT PITS SHALL BE FERTILE, FRIABLE, AND OF A LOAMY CHARACTER; REASONABLY FREE OF SUBSOIL, CLAY LUMPS, BRUSH WEEDS AND OTHER LITTER; FREE OF ROOTS, STUMPS, STONES LARGER THAN 2" IN ANY DIRECTION, AND OTHER EXTRANEOUS OR TOXIC MATTER HARMFUL TO PLANT GROWTH. IT SHALL CONTAIN THREE (3) TO FIVE (5) PERCENT DECOMPOSED ORGANIC MATTER AND HAVE A PH BETWEEN 5.5 AND 7.0.
- b. <u>SAND</u> SHALL BE COARSE, CLEAN, WELL-DRAINING, NATIVE SAND.
- TREES SHALL BE PLANTED IN THE EXISTING NATIVE SOIL ON SITE, UNLESS DETERMINED TO BE UNSUITABLE AT WHICH POINT THE CONTRACTOR SHALL CONTACT OWNER'S REPRESENTATIVE TO DISCUSS ALTERNATE RECOMMENDATION PRIOR TO PLANTING.

1. WATER NECESSARY FOR PLANTING AND MAINTENANCE SHALL BE OF SATISFACTORY QUALITY TO SUSTAIN ADEQUATE PLANT GROWTH AND SHALL NOT CONTAIN HARMFUL, NATURAL OR MAN-MADE ELEMENTS DETRIMENTAL TO PLANTS. WATER MEETING THE ABOVE STANDARD SHALL BE OBTAINED ON THE SITE FROM THE OWNER. IF AVAILABLE, AND THE CONTRACTOR SHALL BE RESPONSIBLE TO MAKE ARRANGEMENTS FOR ITS USE BY HIS TANKS, HOSES, SPRINKLERS, ETC.... IF SUCH WATER IS NOT AVAILABLE AT THE SITE, THE CONTRACTOR SHALL PROVIDE SATISFACTORY WATER FROM SOURCES OFF THE SITE AT NO ADDITIONAL COST TO THE OWNER.

\* WATERING/IRRIGATION RESTRICTIONS MAY APPLY - REFER TO PROPERTY'S JURISDICTIONAL AUTHORITY.

### G. FERTILIZER

CONTRACTOR SHALL PROVIDE FERTILIZER APPLICATION SCHEDULE TO OWNER, AS APPLICABLE TO SOIL TYPE, PLANT INSTALLATION TYPE, AND SITE'S PROPOSED USE. SUGGESTED FERTILIZER TYPES SHALL BE ORGANIC OR OTHERWISE NATURALLY-DERIVED.

### \* FERTILIZER RESTRICTIONS MAY APPLY - REFER TO PROPERTY'S JURISDICTIONAL AUTHORITY.

- MULCH MATERIAL SHALL BE MOISTENED AT THE TIME OF APPLICATION TO PREVENT WIND DISPLACEMENT, AND APPLIED AT A DEPTH OF THREE (3) INCHES. CLEAR MULCH FROM EACH PLANT'S CROWN (BASE). MULCH SHALL BE "FLORIMULCH," EUCALYPTUS MULCH, OR SIMILAR SUSTAINABLY HARVESTED MULCH UNLESS SPECIFIED OTHERWISE.
- PROVIDE A THREE (3) INCH MINIMUM LAYER OF SPECIFIED MULCH OVER THE ENTIRE AREA OF EACH SHRUB BED, GROUND COVER, VINE BED, AND TREE PIT (6' MINIMUM) PLANTED UNDER THIS CONTRACT.

### DIGGING AND HANDLING

- PROTECT ROOTS OR ROOT BALLS OF PLANTS AT ALL TIMES FROM SUN, DRYING WINDS, WATER AND FREEZING, AS NECESSARY UNTIL PLANTING. PLANT MATERIALS SHALL BE ADEQUATELY PACKED TO PREVENT DAMAGE DURING TRANSIT. TREES TRANSPORTED MORE THAN TEN (10) MILES OR WHICH ARE NOT PLANTED WITHIN THREE (3) DAYS OF DELIVERY TO THE SITE SHALL BE SPRAYED WITH AN ANTITRANSPIRANT PRODUCT ("WILTPRUF" OR EQUAL) TO MINIMIZE TRANSPIRATIONAL WATER LOSS.
- 2. BALLED AND BURLAPPED (B&B), AND FIELD GROWN (FG) PLANTS SHALL BE DUG WITH FIRM, NATURAL BALLS OF SOIL OF SUFFICIENT SIZE TO ENCOMPASS THE FIBROUS AND FEEDING ROOTS OF THE PLANTS. NO PLANTS MOVED WITH A ROOT BALL SHALL BE PLANTED IF THE BALL IS

- CRACKED OR BROKEN. PLANTS SHALL NOT BE HANDLED BY STEMS.
- PLANTS MARKED "BR" IN THE PLANT LIST SHALL BE DUG WITH BARE ROOTS. CARE SHALL BE EXERCISED THAT THE ROOTS DO NOT DRY OUT DURING TRANSPORTATION AND PRIOR TO PLANTING.
- 4. PROTECTION OF PALMS: ONLY A MINIMUM OF FRONDS SHALL BE REMOVED FROM THE CROWN OF THE PALM TREES TO FACILITATE MOVING AND HANDLING. CLEAR TRUNK (CT) SHALL BE AS SPECIFIED AFTER THE MINIMUM OF FRONDS HAVE BEEN REMOVED. ALL PALMS SHALL BE BRACED
- EXCAVATION OF TREE PITS SHALL BE PERFORMED USING EXTREME CARE TO AVOID DAMAGE TO SURFACE AND SUBSURFACE ELEMENTS SUCH AS UTILITIES OR HARDSCAPE ELEMENTS, FOOTERS AND PREPARED SUB-BASES.

- ALL CONTAINER GROWN MATERIAL SHALL BE HEALTHY, VIGOROUS, WELL-ROOTED PLANTS ESTABLISHED IN THE CONTAINER IN WHICH THEY ARE SOLD. THE PLANTS SHALL HAVE TOPS WHICH ARE OF GOOD QUALITY AND ARE IN A HEALTHY GROWING CONDITION.
- AN ESTABLISHED CONTAINER GROWN PLANT SHALL BE TRANSPLANTED INTO A CONTAINER AND GROWN IN THAT CONTAINER SUFFICIENTLY LONG ENOUGH FOR THE NEW FIBROUS ROOTS TO HAVE DEVELOPED SO THAT THE ROOT MASS WILL RETAIN ITS SHAPE AND HOLD TOGETHER WHEN REMOVED FROM THE CONTAINER. CONTAINER GROWN STOCK SHALL NOT BE HANDLED BY THEIR STEMS.
- 3. ROOT BOUND PLANTS ARE NOT ACCEPTABLE AND WILL BE REJECTED.
- 4. RPG= "ROOTS PLUS GROWER" CONTAINER PRODUCTS SHALL BE USED WHERE SPECIFIED.

WHEN THE USE OF COLLECTED STOCK IS PERMITTED AS INDICATED BY THE OWNER OR OWNER'S REPRESENTATIVE. THE MINIMUM SIZES OF ROOTBALLS SHALL BE EQUAL TO THAT SPECIFIED FOR THE NEXT LARGER SIZE OF NURSERY GROWN STOCK OF THE SAME VARIETY.

PLANTS COLLECTED FROM WILD OR NATIVE STANDS SHALL BE CONSIDERED NURSERY GROWN WHEN THEY HAVE BEEN SUCCESSFULLY RE-ESTABLISHED IN A NURSERY ROW AND GROWN UNDER REGULAR NURSERY CULTURAL PRACTICES FOR A MINIMUM OF TWO (2) GROWING SEASONS AND HAVE ATTAINED ADEQUATE ROOT AND TOP GROWTH TO INDICATE FULL RECOVERY FROM TRANSPLANTING INTO THE NURSERY ROW.

### M MATERIALS LIST

QUANTITIES NECESSARY TO COMPLETE THE WORK ON THE DRAWINGS SHALL BE FURNISHED BY THE CONTRACTOR. QUANTITY ESTIMATES HAVE BEEN MADE CAREFULLY, BUT THE LANDSCAPE ARCHITECT OR OWNER ASSUMES NO LIABILITY FOR OMISSIONS OR ERRORS. SHOULD A DISCREPANCY OCCUR BETWEEN THE PLANS AND THE PLANT LIST QUANTITY, THE OWNER'S REPRESENTATIVE SHALL BE NOTIFIED FOR CLARIFICATION PRIOR TO BIDDING OR INSTALLATION. ALL DIMENSIONS AND/OR SIZES SPECIFIED SHALL BE THE MINIMUM ACCEPTABLE SIZE.

- FINE GRADING UNDER THIS CONTRACT SHALL CONSIST OF FINAL FINISHED GRADING OF LAWN AND PLANTING AREAS THAT HAVE BEEN ROUGH GRADED BY OTHERS. BERMING AS SHOWN ON THE DRAWINGS SHALL BE THE RESPONSIBILITY OF THE CONTRACTOR, UNLESS OTHERWISE
- THE CONTRACTOR SHALL FINE GRADE THE LAWN AND PLANTING AREAS TO BRING THE ROUGH GRADE UP TO FINAL FINISHED GRADE ALLOWING FOR THICKNESS OF SOD AND/OR MULCH DEPTH. CONTRACTOR SHALL FINE GRADE BY HAND AND/OR WITH ALL EQUIPMENT NECESSARY

INCLUDING A GRADING TRACTOR WITH FRONT-END LOADER FOR TRANSPORTING SOIL WITHIN THE SITE.

ALL PLANTING AREAS SHALL BE GRADED AND MAINTAINED FOR POSITIVE DRAINAGE TO SURFACE/SUBSURFACE STORM DRAIN SYSTEMS. AREAS ADJACENT TO BUILDINGS SHALL SLOPE AWAY FROM THE BUILDINGS. REFER TO CIVIL ENGINEER'S PLANS FOR FINAL GRADES, IF APPLICABLE.

### O. PLANTING PROCEDURES

- CLEANING UP BEFORE COMMENCING WORK: THE CONTRACTOR SHALL CLEAN WORK AND SURROUNDING AREAS OF ALL RUBBISH OR OBJECTIONABLE MATTER DAILY, ALL MORTAR, CEMENT, AND TOXIC MATERIAL SHALL BE REMOVED FROM THE SURFACE OF ALL PLANT BEDS THESE MATERIALS SHALL NOT BE MIXED WITH THE SOIL. SHOULD THE CONTRACTOR FIND SUCH SOIL CONDITIONS BENEATH THE SOIL WHICH WILL IN ANY WAY ADVERSELY AFFECT THE PLANT GROWTH, HE SHALL IMMEDIATELY CALL IT TO THE ATTENTION OF THE OWNER'S REPRESENTATIVE. FAILURE TO DO SO BEFORE PLANTING SHALL MAKE THE CORRECTIVE MEASURES THE RESPONSIBILITY OF THE CONTRACTOR.
- VERIFY LOCATIONS OF ALL UTILITIES, CONDUITS, SUPPLY LINES AND CABLES, INCLUDING BUT NOT LIMITED TO: ELECTRIC, GAS (LINES AND TANKS), WATER, SANITARY SEWER, STORMWATER SYSTEMS, CABLE, AND TELEPHONE. PROPERLY MAINTAIN AND PROTECT EXISTING UTILITIES. CALL STATE OFFICIAL (811) TO LOCATE UTILITIES AT LEAST 48 HOURS PRIOR TO CONSTRUCTION.
- SUBGRADE EXCAVATION: CONTRACTOR IS RESPONSIBLE TO REMOVE ALL EXISTING AND IMPORTED LIMEROCK AND LIMEROCK SUB-BASE FROM ALL LANDSCAPE PLANTING AREAS TO A MINIMUM DEPTH OF 36" OR TO NATIVE SOIL. CONTRACTOR IS RESPONSIBLE TO BACKFILL THESE PLANTING AREAS TO ROUGH FINISHED GRADE WITH CLEAN TOPSOIL FROM AN ON-SITE SOURCE OR AN IMPORTED SOURCE. IF LIMEROCK OR OTHER ADVERSE CONDITIONS OCCUR IN PLANTED AREAS AFTER 36" DEEP EXCAVATION BY THE CONTRACTOR, AND POSITIVE DRAINAGE CAN NOT BE ACHIEVED, CONTRACTOR SHALL UTILIZE POOR DRAINAGE CONDITION PLANTING DETAIL.
- FURNISH NURSERY'S CERTIFICATE OF COMPLIANCE WITH ALL REQUIREMENTS AS SPECIFIED HEREIN. INSPECT AND SELECT PLANT MATERIALS BEFORE PLANTS ARE DUG AT NURSERY OR GROWING SITE.
- COMPLY WITH APPLICABLE FEDERAL, STATE, COUNTY, AND LOCAL REGULATIONS GOVERNING LANDSCAPE MATERIALS AND WORK. CONFORM TO ACCEPTED HORTICULTURAL PRACTICES AS USED IN THE TRADE. UPON ARRIVAL AT THE SITE, PLANTS SHALL BE THOROUGHLY WATERED AND PROPERLY MAINTAINED UNTIL PLANTED. PLANTS STORED ONSITE SHALL NOT REMAIN UNPLANTED OR APPRO PERIOD EXCEEDING TWENTY-FOUR (24) HOURS. AT ALL TIMES WORKMANLIKE METHODS CUSTOMARY IN GOOD HORTICULTURAL PRACTICES
- 6. THE WORK SHALL BE COORDINATED WITH OTHER TRADES TO PREVENT CONFLICTS. COORDINATE PLANTING WITH IRRIGATION WORK TO ASSURE AVAILABILITY OF WATER AND PROPER LOCATION OF IRRIGATION APPURTENANCES AND PLANTS.
- ALL PLANTING PITS SHALL BE EXCAVATED TO SIZE AND DEPTH IN ACCORDANCE WITH THE USA STANDARD FOR NURSERY STOCK 260.1, UNLESS SHOWN OTHERWISE ON THE DRAWINGS, AND BACK FILLED WITH THE PREPARED PLANTING SOIL MIXTURE AS SPECIFIED IN SECTION E. TEST ALL TREE PITS WITH WATER BEFORE PLANTING TO ASSURE PROPER DRAINAGE PERCOLATION IS AVAILABLE. NO ALLOWANCE WILL BE MADE FOR LOST PLANTS DUE TO IMPROPER DRAINAGE. IF POOR DRAINAGE EXISTS, UTILIZE "POOR DRAINAGE CONDITION" PLANTING DETAIL. TREES SHALL BE SET PLUMB AND HELD IN POSITION UNTIL THE PLANTING MIXTURE HAS BEEN FLUSHED INTO PLACE WITH A SLOW, FULL HOSE STREAM. ALL PLANTING SHALL BE PERFORMED BY PERSONNEL FAMILIAR WITH PLANTING PROCEDURES AND UNDER THE SUPERVISION OF A QUALIFIED LANDSCAPE FOREMAN. PROPER "JETTING IN" SHALL BE ASSURED TO ELIMINATE AIR POCKETS AROUND THE ROOTS. "JET STICK" OR EQUAL IS
- 8. TAKE ALL NECESSARY PRECAUTIONS TO AVOID DAMAGE TO BUILDINGS AND BUILDING STRUCTURES WHILE INSTALLING TREES.
- 9. SOIL MIXTURE SHALL BE AS SPECIFIED IN SECTION E OF THESE SPECIFICATIONS.
- 10. TREES AND SHRUBS SHALL BE SET STRAIGHT AT AN ELEVATION THAT, AFTER SETTLEMENT, THE PLANT CROWN WILL STAND ONE (1) TO TWO (2) INCHES ABOVE GRADE. EACH PLANT SHALL BE SET IN THE CENTER OF THE PIT. PLANTING SOIL MIXTURE SHALL BE BACK FILLED, THOROUGHLY TAMPED AROUND THE BALL, AND SETTLED BY WATER (AFTER TAMPING).
- 11. AMEND PINE AND OAK PLANT PITS WITH ECTOMYCORRHIZAL SOIL APPLICATION PER MANUFACTURER'S RECOMMENDATION. ALL OTHER PLANT PITS SHALL BE AMENDED WITH ENDOMYCORRHIZAL SOIL APPLICATION PER MANUFACTURER'S RECOMMENDATION. PROVIDE PRODUCT INFORMATION SUBMITTAL PRIOR TO INOCULATION.
- 12. FILL HOLE WITH SOIL MIXTURE, MAKING CERTAIN ALL SOIL IS SATURATED. TO DO THIS, FILL HOLE WITH WATER AND ALLOW TO SOAK MINIMUM TWENTY (20) MINUTES, STIRRING IF NECESSARY TO GET SOIL THOROUGHLY WET. PACK LIGHTLY WITH FEET, ADD MORE WET SOIL MIXTURE. DO NOT COVER TOP OF BALL WITH SOIL MIXTURE. ALL BURLAP, ROPE, WIRES, BASKETS, ETC.., SHALL BE REMOVED FROM THE SIDES AND TOPS OF BALLS. BUT NO BURLAP SHALL BE PULLED FROM UNDERNEATH.
- PLANT. ALL SOFT WOOD OR SUCKER GROWTH AND ALL BROKEN OR BADLY DAMAGED BRANCHES SHALL BE REMOVED WITH A CLEAN CUT. ALL PRUNING TO BE PERFORMED BY CERTIFIED ARBORIST, IN ACCORDANCE WITH ANSI A-300. 14. SHRUBS AND GROUND COVER PLANTS SHALL BE EVENLY SPACED IN ACCORDANCE WITH THE DRAWINGS AND AS INDICATED ON THE PLANT LIST

13. TREES SHALL BE PRUNED, AT THE DIRECTION OF THE OWNER OR OWNER'S REPRESENTATIVE, TO PRESERVE THE NATURAL CHARACTER OF THE

- MATERIALS INSTALLED SHALL MEET MINIMUM SPECIMEN REQUIREMENTS OR QUANTITIES SHOW ON PLANS, WHICHEVER IS GREATER. CULTIVATE ALL PLANTING AREAS TO A MINIMUM DEPTH OF 6", REMOVE AND DISPOSE ALL DEBRIS. MIX TOP 4" THE PLANTING SOIL MIXTURE AS SPECIFIED IN SECTION E. THOROUGHLY WATER ALL PLANTS AFTER INSTALLATION.
- 15. TREE GUYING AND BRACING SHALL BE INSTALLED BY THE CONTRACTOR IN ACCORDANCE WITH THE PLANS TO INSURE STABILITY AND MAINTAIN TREES IN AN UPRIGHT POSITION. IF THE CONTRACTOR AND OWNER DECIDE TO WAIVE THE TREE GUYING AND BRACING, THE OWNER SHALL NOTIFY THE PROJECT LANDSCAPE ARCHITECT IN WRITING AND AGREE TO INDEMNIFY AND HOLD HARMLESS THE PROJECT LANDSCAPE ARCHITECT IN THE EVENT UNSUPPORTED TREES PLANTED UNDER THIS CONTRACT FALL AND DAMAGE PERSON OR PROPERTY
- 16. ALL PLANT BEDS SHALL BE KEPT FREE OF NOXIOUS WEEDS UNTIL FINAL ACCEPTANCE OF WORK. IF DIRECTED BY THE OWNER, "ROUND-UP" SHALL BE APPLIED FOR WEED CONTROL BY QUALIFIED PERSONNEL TO ALL PLANTING AREAS IN SPOT APPLICATIONS PER MANUFACTURER'S PRECAUTIONS AND SPECIFICATIONS. PRIOR TO FINAL INSPECTION, TREAT ALL PLANTING BEDS WITH AN APPROVED PRE-EMERGENT HERBICIDE AT AN APPLICATION RATE RECOMMENDED BY THE MANUFACTURER. (AS ALLOWED BY JURISDICTIONAL AUTHORITY)

### P. LAWN SODDING

1. THE WORK CONSISTS OF LAWN BED PREPARATION, SOIL PREPARATION, AND SODDING COMPLETE, IN STRICT ACCORDANCE WITH THE SPECIFICATIONS AND THE APPLICABLE DRAWINGS TO PRODUCE A TURF GRASS LAWN ACCEPTABLE TO THE OWNER.

- ALL AREAS THAT ARE TO BE SODDED SHALL BE CLEARED OF ANY ROUGH GRASS, WEEDS, AND DEBRIS BY MEANS OF A SOD CUTTER TO A DEPTH OF THREE (3) INCHES, AND THE GROUND BROUGHT TO AN EVEN GRADE. THE ENTIRE SURFACE SHALL BE ROLLED WITH A ROLLER WEIGHING NOT MORE THAN ONE-HUNDRED (100) POUNDS PER FOOT OF WIDTH. DURING THE ROLLING, ALL DEPRESSIONS CAUSED BY SETTLEMENT SHALL BE FILLED WITH ADDITIONAL SOIL, AND THE SURFACE SHALL BE REGRADED AND ROLLED UNTIL PRESENTING A SMOOTH AND EVEN FINISH TO THE
- PREPARE LOOSE BED FOUR (4) INCHES DEEP. HAND RAKE UNTIL ALL BUMPS AND DEPRESSIONS ARE REMOVED. WET PREPARED AREA

- a. THE CONTRACTOR SHALL SOD ALL AREAS THAT ARE NOT PAVED OR PLANTED AS DESIGNATED ON THE DRAWINGS WITHIN THE CONTRACT LIMITS, UNLESS SPECIFICALLY NOTED OTHERWISE.
- b. THE SOD SHALL BE CERTIFIED TO MEET STATE REQUIREMENTS & SPECIFICATIONS, ABSOLUTELY TRUE TO VARIETAL TYPE, AND FREE FROM WEEDS, FUNGUS, INSECTS AND DISEASE OF ANY KIND.
- c. SOD PANELS SHALL BE LAID TIGHTLY TOGETHER SO AS TO MAKE A SOLID SODDED LAWN AREA. SOD SHALL BE LAID UNIFORMLY AGAINST THE EDGES OF ALL CURBS AND OTHER HARDSCAPE ELEMENTS, PAVED AND PLANTED AREAS. ADJACENT TO BUILDINGS, A 24 INCH STONE MULCH STRIP SHALL BE PROVIDED. IMMEDIATELY FOLLOWING SOD LAYING, THE LAWN AREAS SHALL BE ROLLED WITH A LAWN ROLLER CUSTOMARILY USED FOR SUCH PURPOSES, AND THEN THOROUGHLY IRRIGATED. IF, IN THE OPINION OF THE OWNER, TOP-DRESSING IS NECESSARY AFTER ROLLING TO FILL THE VOIDS BETWEEN THE SOD PANELS AND TO EVEN OUT INCONSISTENCIES IN THE SOD, CLEAN SAND, AS APPROVED BY THE OWNER'S REPRESENTATIVE, SHALL BE UNIFORMLY SPREAD OVER THE ENTIRE SURFACE OF THE SOD AND THOROUGHLY WATERED IN. FERTILIZE INSTALLED SOD AS ALLOWED BY PROPERTY'S JURISDICTIONAL AUTHORITY.
- DURING DELIVERY, PRIOR TO, AND DURING THE PLANTING OF THE LAWN AREAS, THE SOD PANELS SHALL AT ALL TIMES BE PROTECTED FROM EXCESSIVE DRYING AND UNNECESSARY EXPOSURE OF THE ROOTS TO THE SUN. ALL SOD SHALL BE STACKED SO AS NOT TO BE DAMAGED BY SWEATING OR EXCESSIVE HEAT AND MOISTURE.

- a. WITHIN THE CONTRACT LIMITS, THE CONTRACTOR SHALL PRODUCE A DENSE, WELL ESTABLISHED LAWN. THE CONTRACTOR SHALL BE RESPONSIBLE FOR THE REPAIR AND RE-SODDING OF ALL ERODED, SUNKEN OR BARE SPOTS (LARGER THAN 12"X12") UNTIL CERTIFICATION OF ACCEPTANCE BY THE OWNER'S REPRESENTATIVE. REPAIRED SODDING SHALL BE ACCOMPLISHED AS IN THE ORIGINAL WORK (INCLUDING
- b. CONTRACTOR RESPONSIBLE FOR ESTABLISHING AND MAINTAINING SOD/LAWN UNTIL ACCEPTANCE BY THE OWNER'S REPRESENTATIVE. PRIOR TO AND UPON ACCEPTANCE, CONTRACTOR TO PROVIDE WATERING/IRRIGATION SCHEDULE TO OWNER. OBSERVE ALL APPLICABLE WATERING RESTRICTIONS AS SET FORTH BY THE PROPERTY'S JURISDICTIONAL AUTHORITY.

### Q. CLEANUP

UPON COMPLETION OF ALL PLANTING WORK AND BEFORE FINAL ACCEPTANCE, THE CONTRACTOR SHALL REMOVE ALL MATERIAL, EQUIPMENT, AND DEBRIS RESULTING FROM HIS WORK. ALL PAVED AREAS SHALL BE CLEANED AND THE SITE LEFT IN A NEAT AND ACCEPTABLE CONDITION AS APPROVED BY THE OWNER'S REPRESENTATIVE.

R. PLANT MATERIAL MAINTENANCE

ALL PLANTS AND PLANTING INCLUDED UNDER THIS CONTRACT SHALL BE MAINTAINED BY WATERING, CULTIVATING, SPRAYING, AND ALL OTHER OPERATIONS (SUCH AS RE-STAKING OR REPAIRING GUY SUPPORTS) NECESSARY TO INSURE A HEALTHY PLANT CONDITION BY THE CONTRACTOR UNTIL CERTIFICATION OF ACCEPTANCE BY THE OWNER'S REPRESENTATIVE.

S. FINAL INSPECTION AND ACCEPTANCE OF WORK

FINAL INSPECTION AT THE END OF THE WARRANTY PERIOD SHALL BE ON PLANTING, CONSTRUCTION AND ALL OTHER INCIDENTAL WORK PERTAINING TO THIS CONTRACT. ANY REPLACEMENT AT THIS TIME SHALL BE SUBJECT TO THE SAME ONE (1) YEAR WARRANTY (OR AS SPECIFIED BY THE LANDSCAPE ARCHITECT OR OWNER IN WRITING) BEGINNING WITH THE TIME OF REPLACEMENT AND ENDING WITH THE SAME INSPECTION AND ACCEPTANCE HEREIN DESCRIBED.


- THE LIFE AND SATISFACTORY CONDITION OF ALL PLANT MATERIAL INSTALLED (INCLUDING SOD) BY THE LANDSCAPE CONTRACTOR SHALL BE WARRANTED BY THE CONTRACTOR FOR A MINIMUM OF ONE (1) CALENDAR YEAR COMMENCING AT THE TIME OF CERTIFICATION OF ACCEPTANCE BY THE OWNER'S REPRESENTATIVE.
- ANY PLANT NOT FOUND IN A HEALTHY GROWING CONDITION AT THE END OF THE WARRANTY PERIOD SHALL BE REMOVED FROM THE SITE AND REPLACED AS SOON AS WEATHER CONDITIONS PERMIT. ALL REPLACEMENTS SHALL BE PLANTS OF THE SAME KIND AND SIZE AS SPECIFIED IN THE PLANT LIST. THEY SHALL BE FURNISHED PLANTED AND MULCHED AS SPECIFIED AT NO ADDITIONAL COST TO THE OWNER.
- IN THE EVENT THE OWNER DOES NOT CONTRACT WITH THE CONTRACTOR FOR LANDSCAPE AND IRRIGATION MAINTENANCE, THE CONTRACTOR SHOULD VISIT THE PROJECT SITE PERIODICALLY DURING THE ONE (1) YEAR WARRANTY PERIOD TO EVALUATE MAINTENANCE PROCEDURES BEING PERFORMED BY THE OWNER. CONTRACTOR SHALL NOTIFY THE OWNER IN WRITING OF MAINTENANCE PROCEDURES OR CONDITIONS WHICH THREATEN VIGOROUS AND HEALTHY PLANT GROWTH. SITE VISITS SHALL BE CONDUCTED A MINIMUM OF ONCE PER MONTH FOR A PERIOD OF TWELVE (12) MONTHS FROM THE DATE OF ACCEPTANCE.

· (0 (0 (4 (0 (0) (4




Schedule	chedule										
Symbol	Label	Image	QTY	Manufacturer	Catalog	Description	Number Lamps	Lamp Output	LLF	Input Power	Polar Plot
	А		7	RAB LIGHTING INC.	SLIM12Y/D10		1	2006	0.8	15	Max 1296cd
	В		130		NF/SP-PROW-120-24V- 3000K		1	180	0.8	2.89861	Max 57cd

Statistics						
Description	Symbol	Avg	Max	Min	Max/Min	Avg/M
Scooter Property	+	0.4 fc	17.7 fc	0.0 fc	N/A	N/A

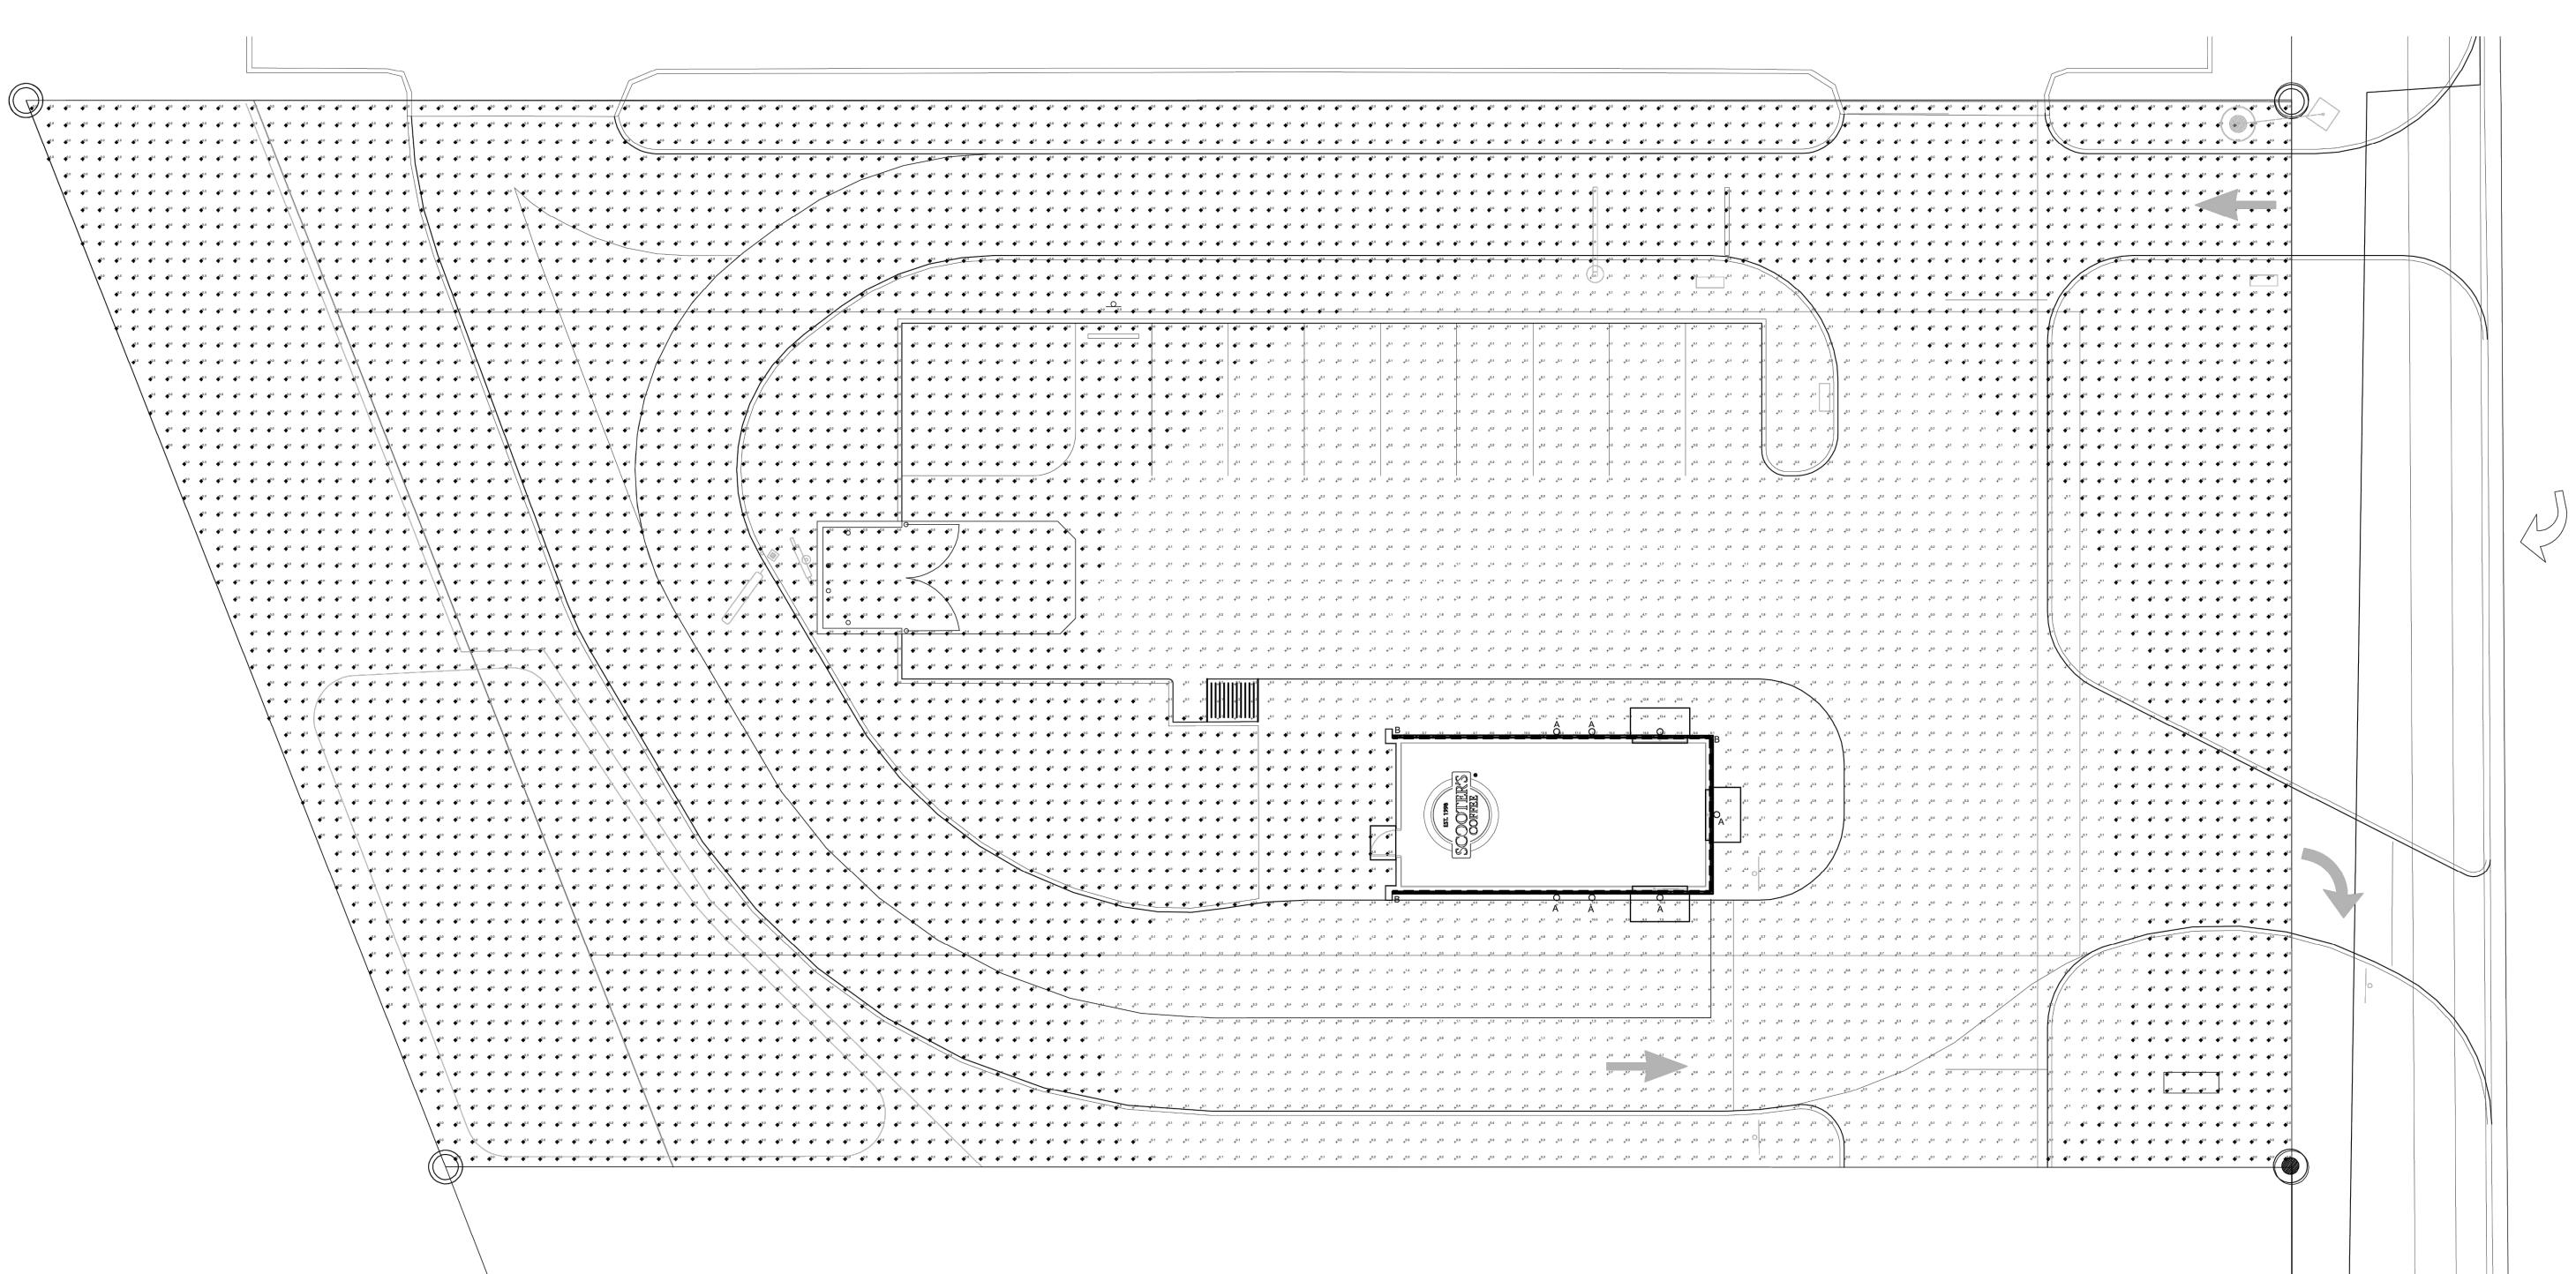

### 1 EXTERIOR SITE PHOTOMETRIC PLAN SCALE: 1'- 10'-0'



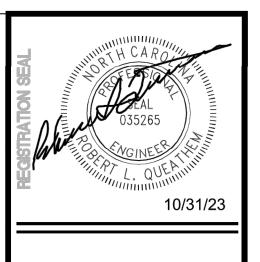

# 100' PUBLIC R/W

lacksquare


## TITLE: EXTERIOR SITE PHOTOMETRIC PLAN


RANCHISEE & STORE NUMBER:
COLESVILLE, NC 27571
RANCHISEE & STORE NUMBER:
COOTER'S COFFEE #562


KIOSK PROTOTYPE:
4.1 PROTOTYPE
MAY 2022
ISSUE DATE:
08/14/2023
PROJECT NO.
230522
DRAWN BY:
JDK
CHECKED BY:


SHEET NO.

E3.<sup>-</sup>

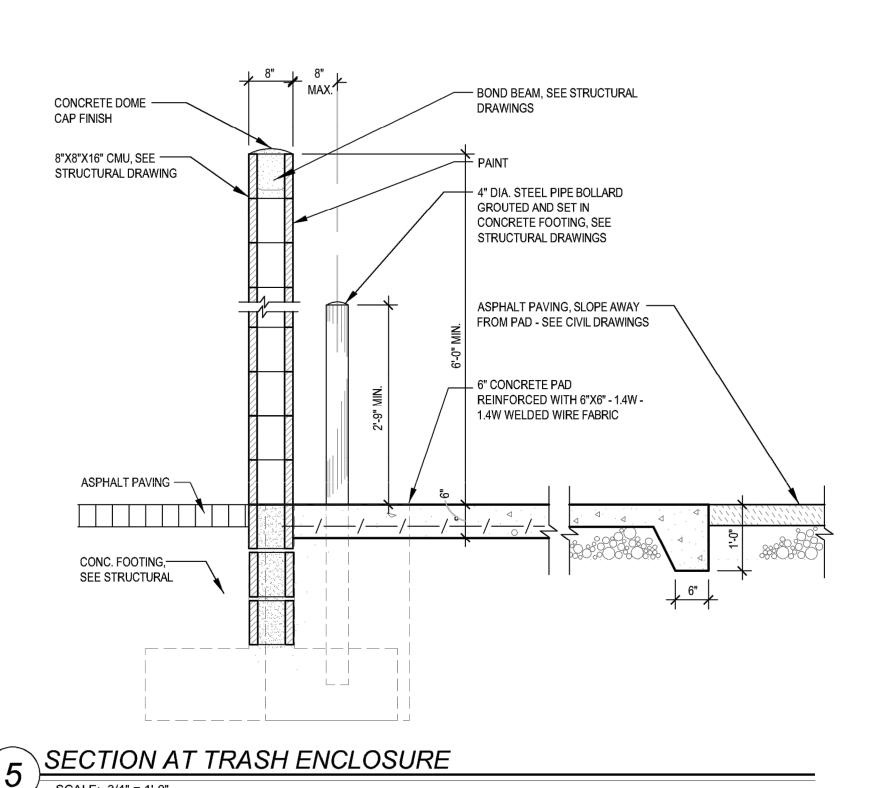

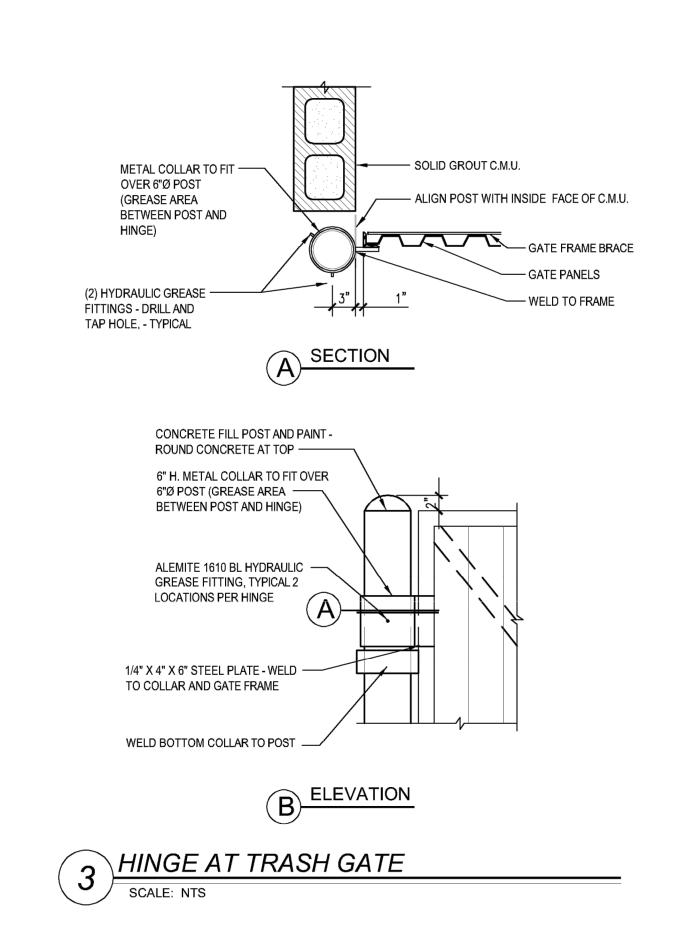

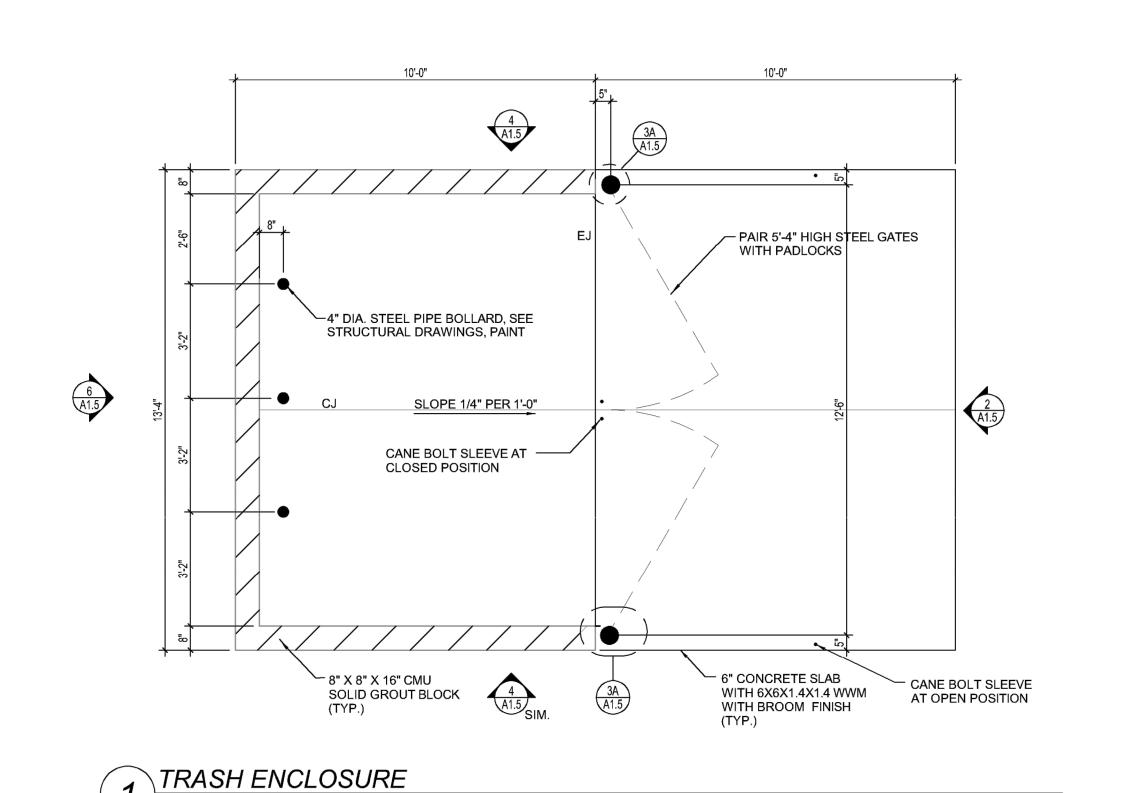

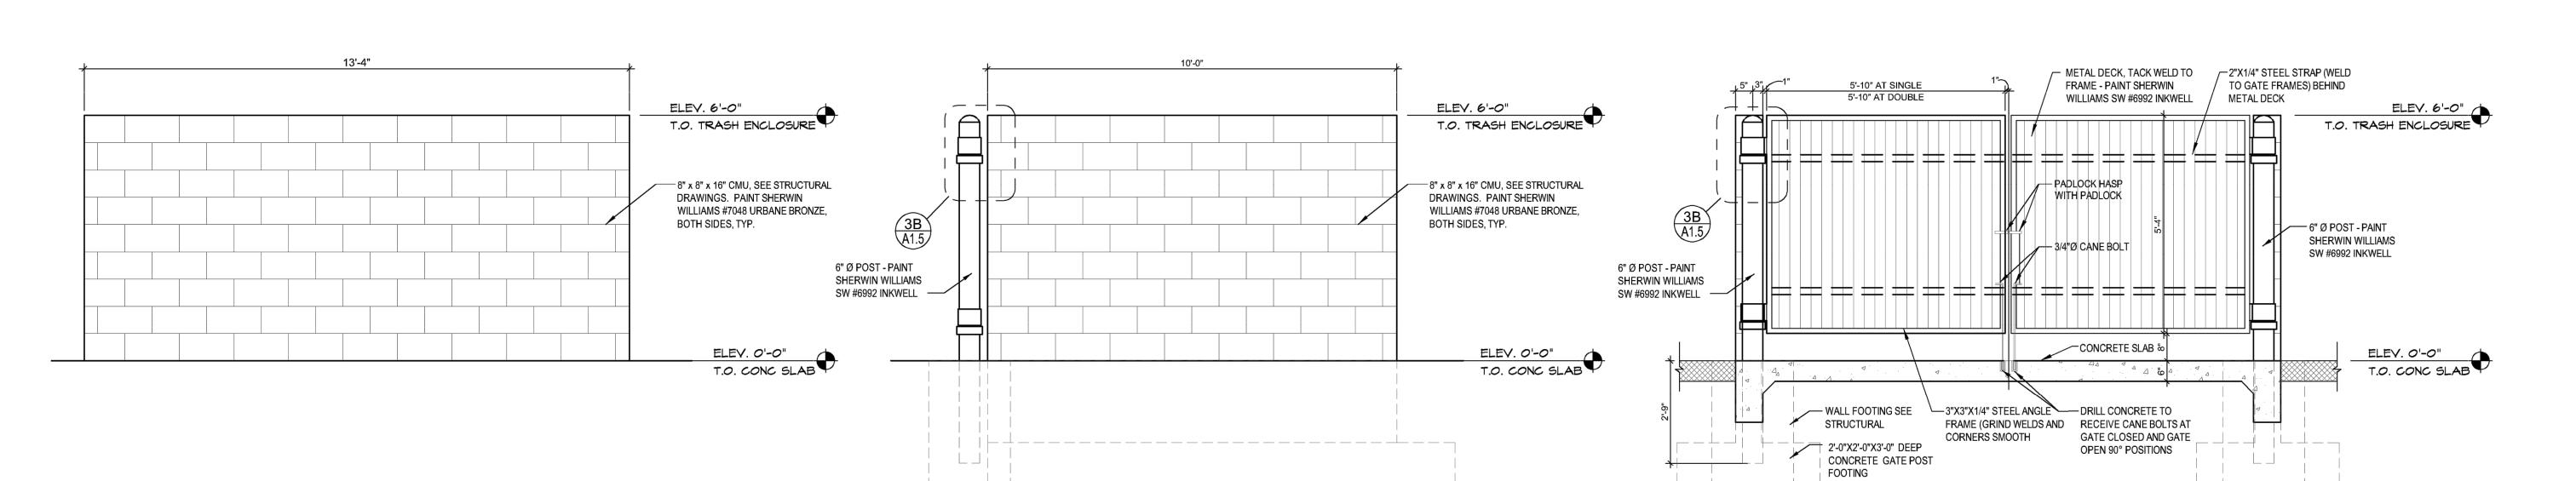

TRASH ENCLOSURE - BACK ELEVATION

SCALE: 1/2" = 1'-0"

TRASH ENCLOSURE - SIDE BACK ELEVATION

SCALE: 1/2" = 1'-0"

2 TRASH ENCLOSURE -FRONT ELEVATION

SCALE: 1/2" = 1'-0"

SCALE: 3/8" = 1'-0"



ORPORERING STORE PLANN


DALLAS / LAS VEGAS / ORLAN

SUITE 300

ST. LOUIS. MO 63

ARCHITECTURE
SAINT LOUIS / D
1950 CRAIG ROAD, SUIT



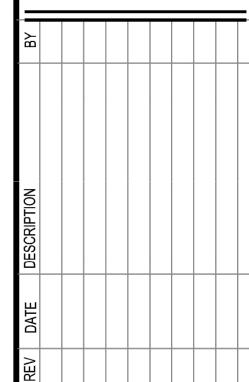

TITLE: TRASH ENCLOSURE PLAN, ELEVATIONS &

DETAIL

PROJECT ADDRESS:
306 S. MAIN ST.
ROLESVILLE, NC 27571
FRANCHISEE & STORE NUMBER:
SCOOTER'S COFFEE #562
P&S JAVA ENTERPRISES, INC.

KIOSK PROTOTYPE:
4.1 PROTOTYPE
MAY 2022
ISSUE DATE:
08/14/2023
PROJECT NO.
230522
DRAWN BY:
BB
CHECKED BY:
XXX

SHEET NO.

A1.5

### FINISH SCHEDULE



4 DRIVE THRU SIDE EXTERIOR ELEVATION


SCALE: 1/4" = 1'-0"



FRONT EXTERIOR ELEVATION

SCALE: 1/4" = 1'-0"

SIDE EXTERIOR ELEVATION

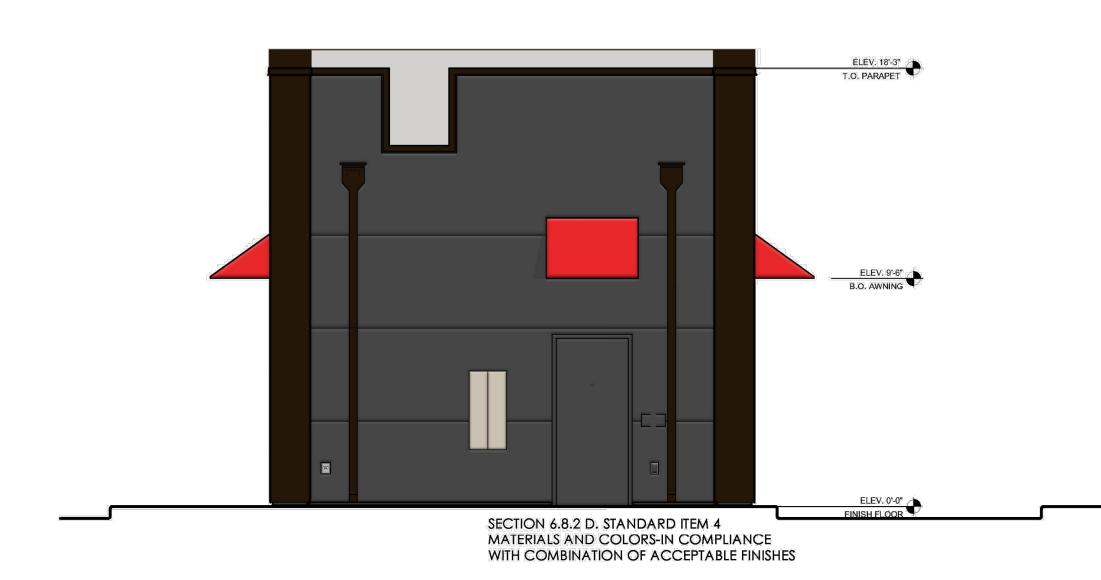

2 BACK EXTERIOR ELEVATION

SCALE: 1/4" = 1'-0"

ELEV. 19'-0' T.O. OF PARAPET	SLOPE — SECTION 6.8.2 D. STANDARD ITEM C HORIZONTAL MASS  ELEV. 18:37 T.O. PARAPET
SECTION 6.8.2 D. STANDARD ITEM B ROOF LINES-MATERIALS & ROOF DESIGN STANDARDS 7C. ROOF OVERHANG & TEXTURED MATERIALS  ELEV. 12'-2 1/2" T.O. LAP SIDING	SOFFEE DRIVE-THRU
B.O., AWNING/LIGHTING	SECTION 6.8.2 D. STANDARD ITEM 3 BUILDING BLANK WALL AREA-IN COMPLIANCE BY USING SUBSTANTIAL MATERIAL CHANGES & REVEAL ARCHITECTURAL ELEMENT IN STUCCO FINISH
SILL  ELEV. 0'-0"	87°
SECTION 6.8.2 D. STANDARD ITEM 2 TRANSPARENCY NOT REQUIRED (SERVICE AREA)	SECTION 6.8.2 D. STANDARD ITEM 4 MATERIALS AND COLORS-IN COMPLIANCE HORIZONTAL MASS WITH COMBINATION OF ACCEPTABLE FINISHES

MATERIALP	ERCENTAC	SES
DRIVE THRU SIDE I	EXTERIOR ELE	VATION
TOTAL WALL AREA	714 SQ. FT.	100%
STUCCO - INKWELL	0 SQ. FT.	0%
STUCCO - SKYLINE STEEL	201 SQ. FT.	28%
CARBON LEDGE STONE	229 SQ. FT.	32%
FIBERON COMPOSITE CLADDING	97 SQ. FT.	14%
WINDOWS/DOORS	39 SQ. FT.	5%
TRIMS	63 SQ. FT.	9%

MATERIALP	ERCENTAGES	3
BACK EXTER	RIOR ELEVATION	
TOTAL WALL AREA	357 SQ. FT.	100%
STUCCO - INKWELL	250 SQ. FT.	70%
STUCCO - SKYLINE STEEL	0 SQ. FT.	0%
CARBON LEDGE STONE	0 SQ. FT.	0%
FIBERON COMPOSITE	0 SQ. FT.	0%
M	24 SQ. FT.	7%
TRIMS	83 SQ. FT.	23%

	MATERIALPI	ERCENTAGES	;
	SIDE EXTERI	OR ELEVATION	
%	TOTAL WALL AREA	714 SQ. FT.	100%
%	STUCCO - INKWELL	0 SQ. FT.	0%
%	STUCCO - SKYLINE STEEL	201 SQ. FT.	28%
%	CARBON LEDGE STONE	229 SQ. FT.	32%
%	FIBERON COMPOSITE CLADDING	97 SQ. FT.	14%
%	WINDOWS/DOORS	39 SQ. FT.	5%
%	TRIMS	63 SQ. FT.	9%

MATERIAL PERCENTAGES
FRONT EXTERIOR ELEVATION

STUCCO - INKWELL STUCCO - SKYLINE

STEEL

CARBON LEDGE STONE
FIBERON COMPOSITE

CLADDING WINDOWS/DOORS

TRIMS

0 SQ. FT.

20 SQ. FT.

217 SQ. FT.

36 SQ. FT.

21 SQ. FT.

SECTION 6.8.2 D. STANDARD ITEM
MINIMUM DESIGN ITEMS-DESIGN HAS (4) ITEMS INCLUDING:
A-PROJECTION OF PARAPET/OVERHANG WITH WOOD FINISH ON UNDERSIDE
B-STACKED STONE COLUMN AT STREET FACING FACADE)
D-AWNINGS PROVIDED

F-COMPLEMENTARY CHANGE IN MATERIAL & TEXTURES USING STACKED STONE, WOOD AND STUCCO FINISHES F-FINISHES VARY IN COLOR

6408


ARCHITECT

ARCHITECT

10/30/23

J. GOGLIA ST. LOUIS, MO 63146

CRAIG ROAD, SUITE 300
S14) 415-2400
FAX (314) 415-26

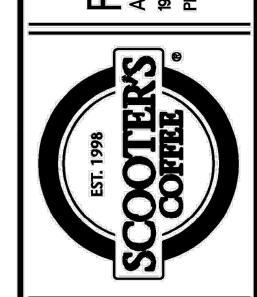

EXTERIOR COLOR

27571 NUMBER: FEE #562 PRISES, INC.

**ELEVATIONS** 


ROLESVILLE, NC 2757
FRANCHISEE & STORE NUMB
SCOOTER'S COFFEE
P&S JAVA ENTERPRIS


KIOSK PROTOTYPE:
4.1 PROTOTYPE
MAY 2022
ISSUE DATE:
08/14/2023
PROJECT NO.
230522
DRAWN BY:

CHECKED BY:

SHEET NO.

A2.0

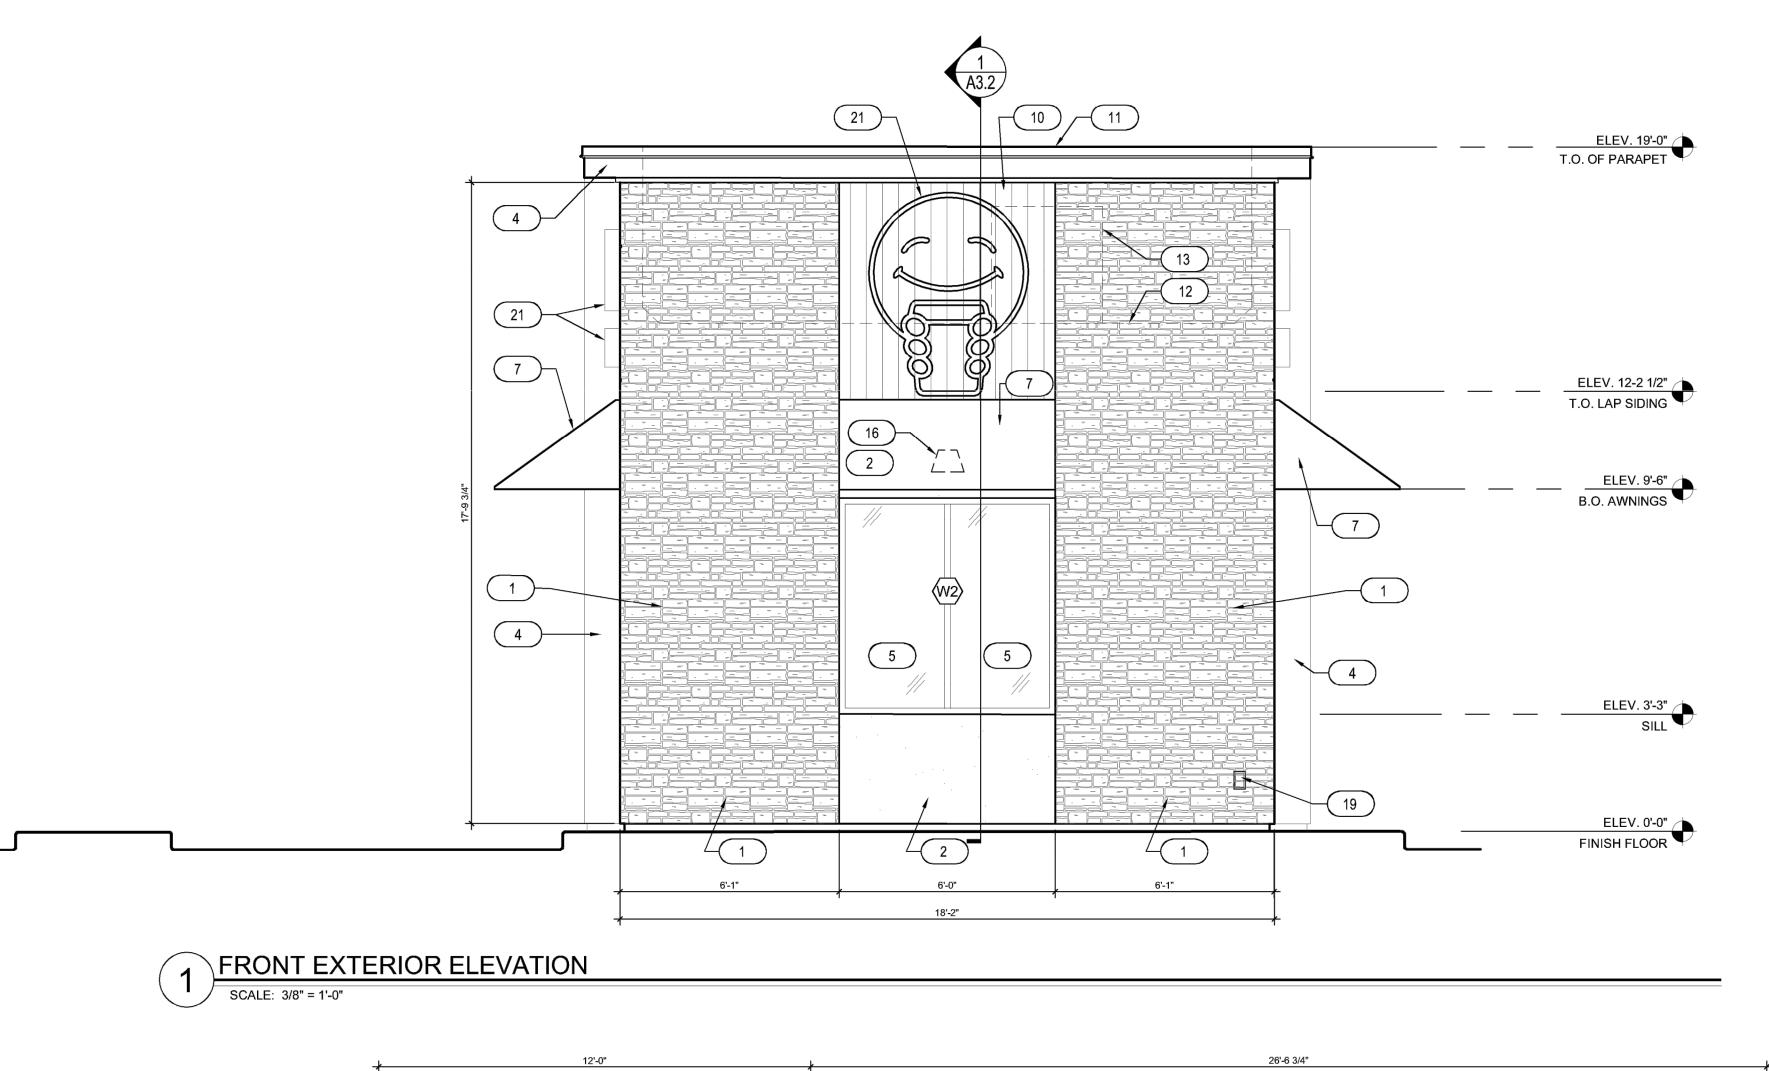

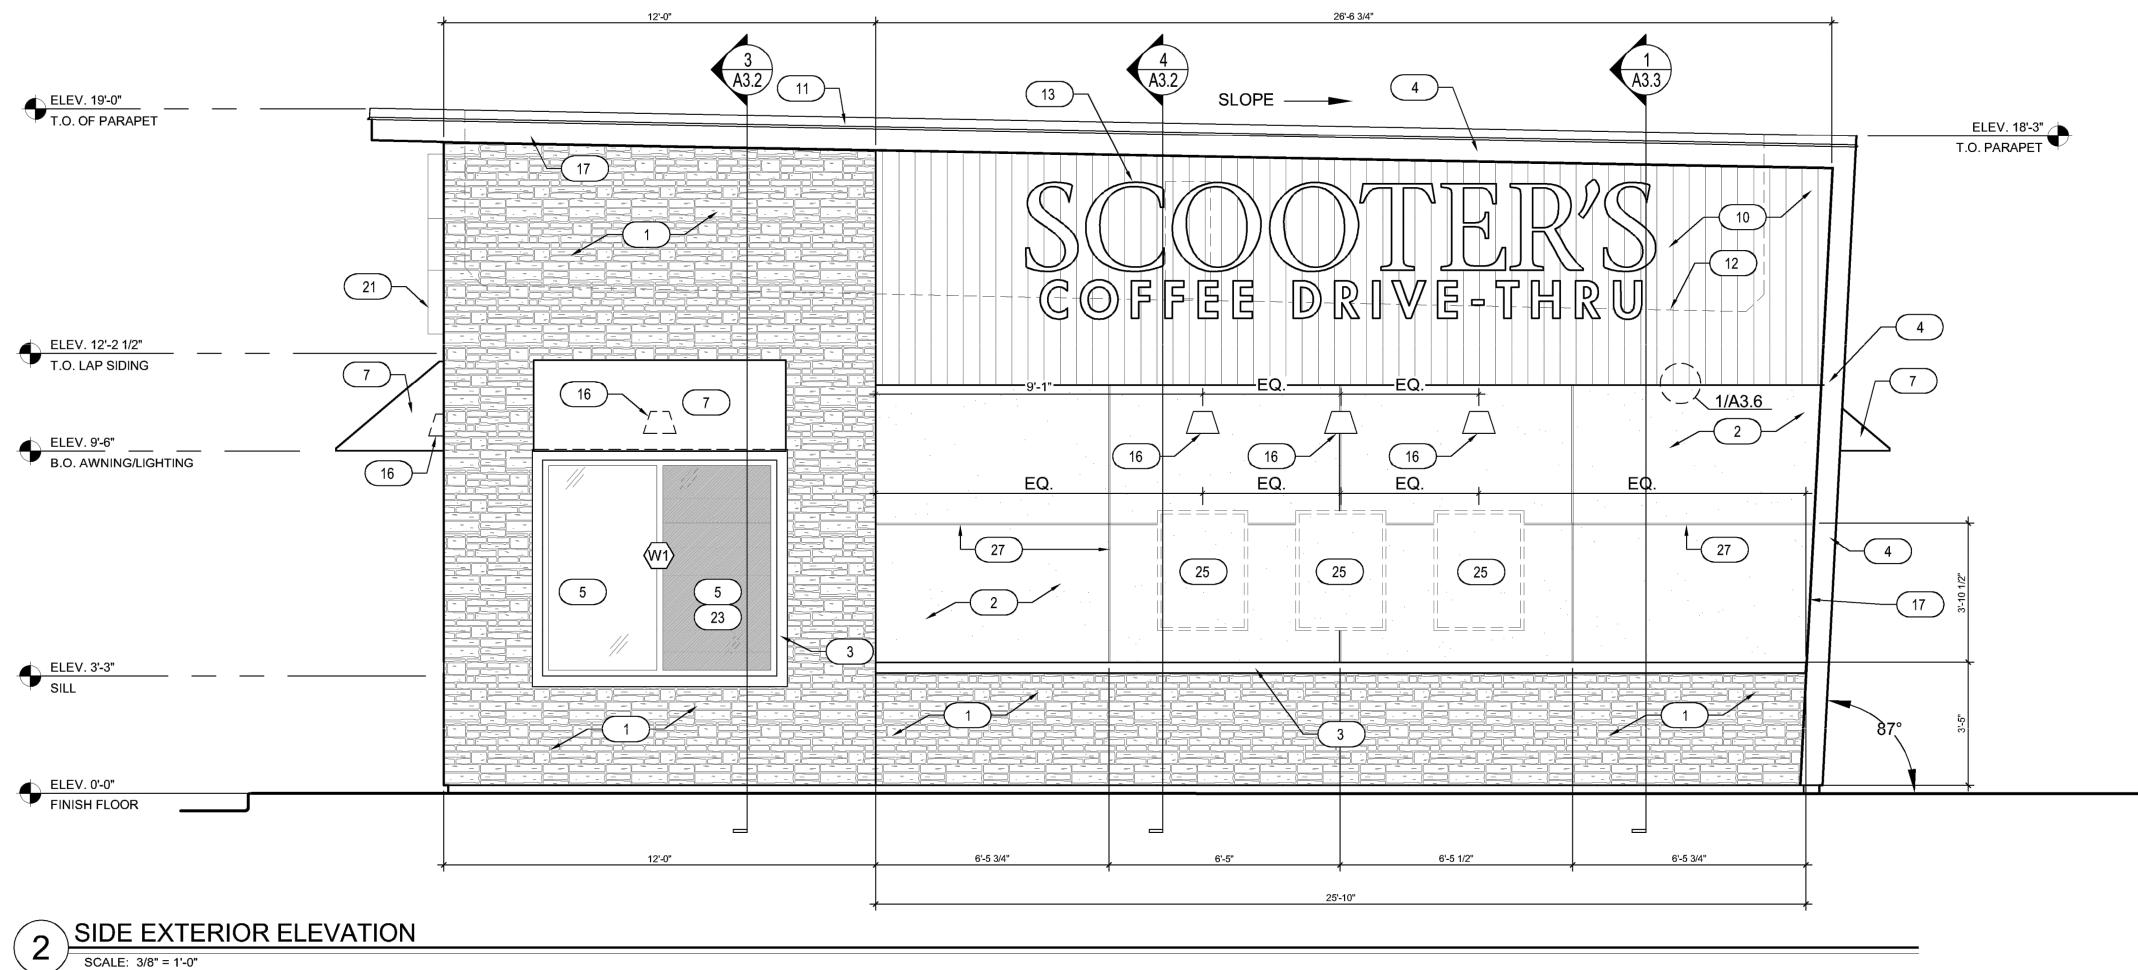

SCALE: 3/8" = 1'-0"

**KEYNOTES** 

1. CARBON LEDGE STONE BY REALSTONE SYSTEMS



3. 3 1/2" TRIM - COLOR: SHERWIN WILLIAMS SW2848 ROYCROFT PEWTER

4. METAL FASCIA - DARK BRONZE

5. INSULATED DARK BRONZE ALUMINUM WINDOWS WITH DUAL PANE TEMPERED

6. QUICKSERVE 48X48 WINDOW - COLOR: DARK BRONZE

AWNING BY OTHERS - COLOR: RED

8. INSULATED HOLLOW METAL DOOR & FRAME; PAINT SHERWIN WILLIAMS SW6992

9. WIDE ANGLE PEEP HOLE, BY DOOR MANUFACTURER

10. FIBERON COMPOSITE CLADDING

11. PARAPET CAP FLASHING - DARK BRONZE

12. LINE OF ROOF BEYOND

13. AIR CONDENSER, SEE MECHANICAL DRAWINGS

14. ROOF SCUPPER AND DOWNSPOUT, SEE DETAIL 8/A6.3

15. MAILBOX BY GC BLACK

16. WALL MOUNTED LIGHT FIXTURE, SEE ELECTRICAL DRAWINGS

17. LED LIGHT BAND, SEE ELECTRICAL DRAWINGS

18. SES PANEL, SEE ELECTRICAL DRAWINGS

19. ELECTRICAL OUTLETS, SEE ELECTRICAL DRAWINGS

20. HOSE BIBB, SEE PLUMBING DRAWINGS

21. PROPOSED SIGNAGE BY OTHERS, UNDER SEPARATE PERMIT

22. CONNECT DOWNSPOUTS TO UNDERGROUND PIPING, REF. CIVIL.

23. SPANDREL GLASS

24. NEW SECURITY CAMERA

25. CUSTOMER PROVIDED SIGN PANELS. PANELS TO BE MOUNTED TO FASCIA BY GC (WHEN PROVIDED) IN CUSTOMER SPECIFIED LOCATION USING PROPER HARDWARE AND FASTENERS (NON-CORROSIVE)


26. STUCCO - COLOR: SHERWIN WILLIAMS SW6993 INKWELL EGGSHELL FINISH

27. STUCCO REVEAL



``10/30/23



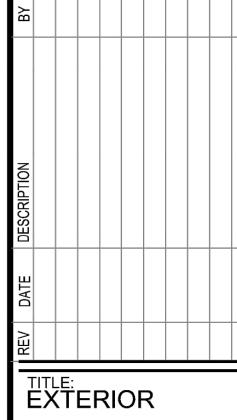


**ELEVATIONS** 

PROJECT ADDRESS:
306 S. MAIN ST.
ROLESVILLE, NC 27571

KIOSK PROTOTYPE: 4.1 PROTOTYPE MAY 2022 ISSUE DATE: 08/14/2023 PROJECT NO. 230522 DRAWN BY: CHECKED BY:

SHEET NO.

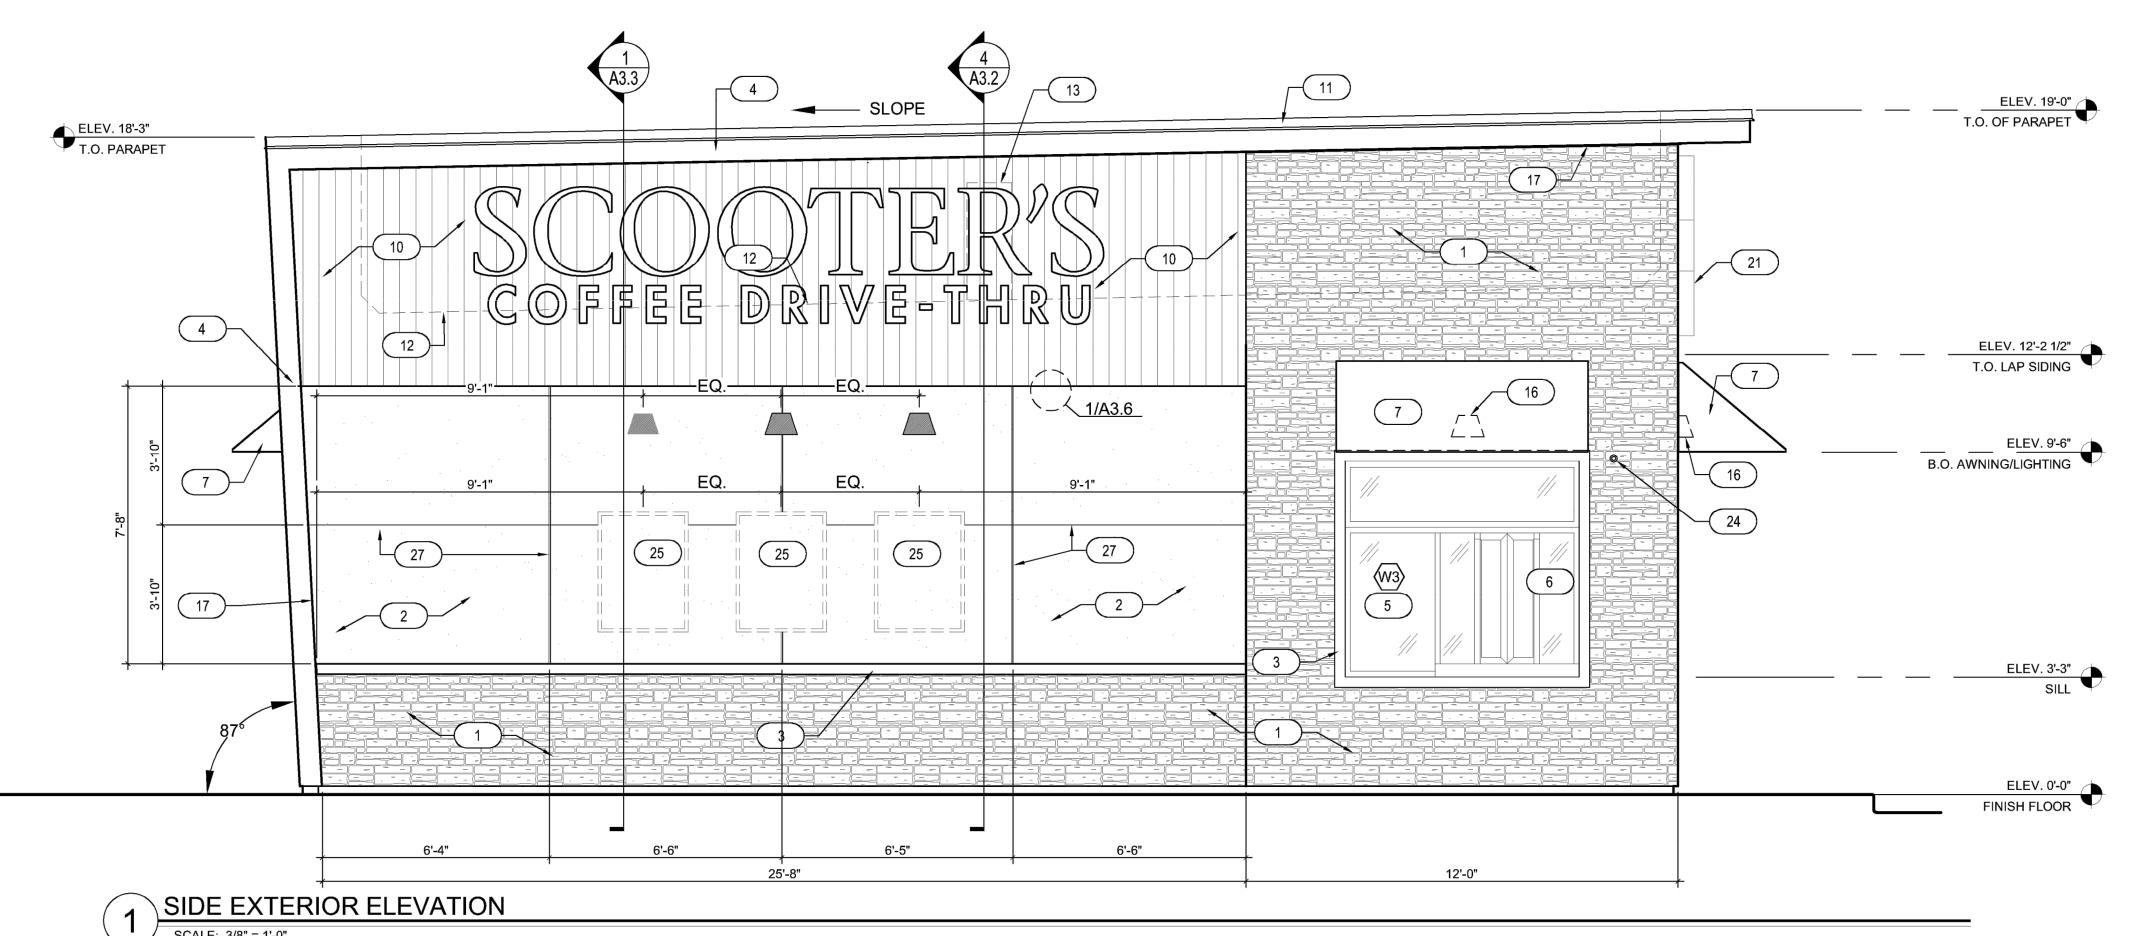


MATERIALP	ERCENTAC	SES
DRIVE THRU SIDE	EXTERIOR ELE	VATION
TOTAL WALL AREA	714 SQ. FT.	100%
STUCCO - INKWELL	0 SQ. FT.	0%
STUCCO - SKYLINE STEEL	201 SQ. FT.	28%
CARBON LEDGE STONE	229 SQ. FT.	32%
FIBERON COMPOSITE CLADDING	97 SQ. FT.	14%
WINDOWS/DOORS	39 SQ. FT.	5%
TRIMS	63 SQ. FT.	9%

MATERIALP	<b>ERCENTAG</b>	SES
BACK EXTER	RIOR ELEVATIO	N
TOTAL WALL AREA	357 SQ. FT.	100%
STUCCO - INKWELL	250 SQ. FT.	70%
STUCCO - SKYLINE STEEL	0 SQ. FT.	0%
CARBON LEDGE STONE	0 SQ. FT.	0%
FIBERON COMPOSITE CLADDING	0 SQ. FT.	0%
M	24 SQ. FT.	7%
TRIMS	83 SQ. FT.	23%

MATERIALP	ERCENTAG	SES
FRONT EXTER	RIOR ELEVATION	ON
TOTAL WALL AREA	324 SQ. FT.	100%
STUCCO - INKWELL	0 SQ. FT.	0%
STUCCO - SKYLINE STEEL	20 SQ. FT.	6%
CARBON LEDGE STONE	217 SQ. FT.	67%
FIBERON COMPOSITE CLADDING	36 SQ. FT.	11%
WINDOWS/DOORS	36 SQ. FT.	11%
TRIMS	21 SQ. FT.	6%

MATERIALP	ERCENTAGES	5
SIDE EXTER	IOR ELEVATION	
TOTAL WALL AREA	714 SQ. FT.	100%
STUCCO - INKWELL	0 SQ. FT.	0%
STUCCO - SKYLINE STEEL	201 SQ. FT.	28%
CARBON LEDGE STONE	229 SQ. FT.	32%
FIBERON COMPOSITE CLADDING	97 SQ. FT.	14%
WINDOWS/DOORS	39 SQ. FT.	5%
TRIMS	63 SQ. FT.	9%

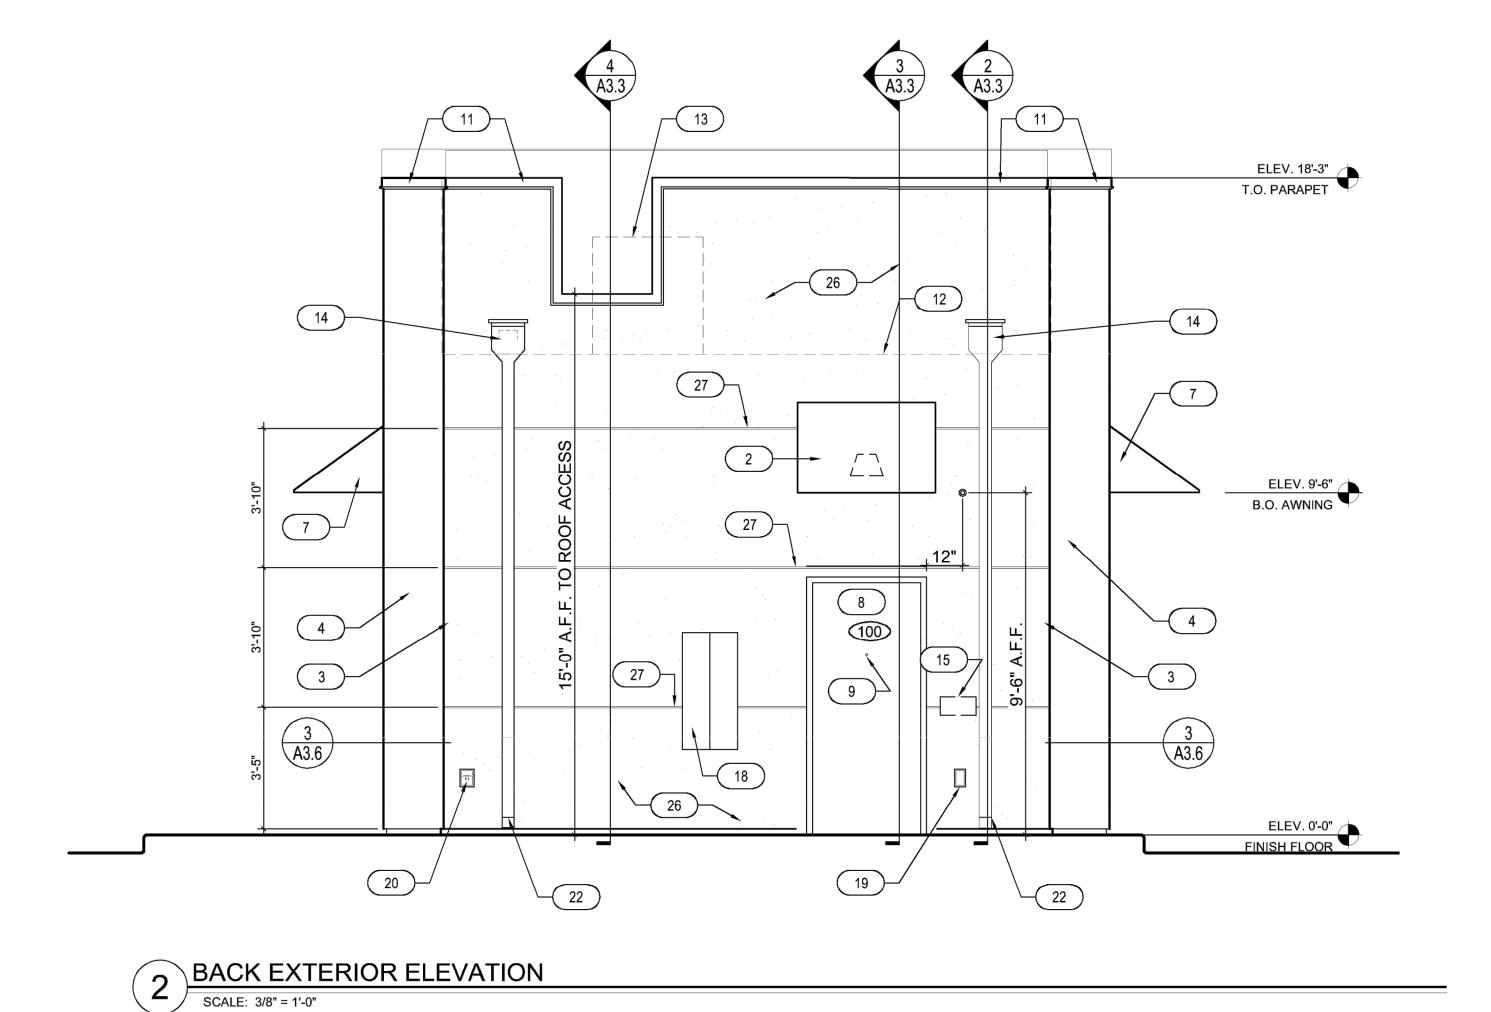

### **KEYNOTES**

- 1. CARBON LEDGE STONE BY REALSTONE SYSTEMS
- 2. STUCCO COLOR: SHERWIN WILLIAMS SW1015 SKYLINE STEEL
- 3. 3 1/2" TRIM COLOR: SHERWIN WILLIAMS SW2848 ROYCROFT PEWTER
- 4. METAL FASCIA DARK BRONZE
- 5. INSULATED DARK BRONZE ALUMINUM WINDOWS WITH DUAL PANE TEMPERED
- GLASS
- 6. QUICKSERVE 48X48 WINDOW COLOR: DARK BRONZE7. AWNING BY OTHERS COLOR: RED
- 8. INSULATED HOLLOW METAL DOOR & FRAME; PAINT SHERWIN WILLIAMS SW6992
- 9. WIDE ANGLE PEEP HOLE, BY DOOR MANUFACTURER
- 10. FIBERON COMPOSITE CLADDING
- 11. PARAPET CAP FLASHING DARK BRONZE
- 12. LINE OF ROOF BEYOND
- 13. AIR CONDENSER, SEE MECHANICAL DRAWINGS
- 14. ROOF SCUPPER AND DOWNSPOUT, SEE DETAIL 8/A6.3
- 15. MAILBOX BY GC BLACK
- 16. WALL MOUNTED LIGHT FIXTURE, SEE ELECTRICAL DRAWINGS
- 17. LED LIGHT BAND, SEE ELECTRICAL DRAWINGS
- 18. SES PANEL, SEE ELECTRICAL DRAWINGS
- 19. ELECTRICAL OUTLETS, SEE ELECTRICAL DRAWINGS
- 20. HOSE BIBB, SEE PLUMBING DRAWINGS
- 21. PROPOSED SIGNAGE BY OTHERS, UNDER SEPARATE PERMIT
- 22. CONNECT DOWNSPOUTS TO UNDERGROUND PIPING, REF. CIVIL.
- 23. SPANDREL GLASS
- 24. NEW SECURITY CAMERA
- 25. CUSTOMER PROVIDED SIGN PANELS. PANELS TO BE MOUNTED TO FASCIA BY GC (WHEN PROVIDED) IN CUSTOMER SPECIFIED LOCATION USING PROPER HARDWARE AND FASTENERS (NON-CORROSIVE)
- 26. STUCCO COLOR: SHERWIN WILLIAMS SW6993 INKWELL EGGSHELL FINISH
- 27. STUCCO REVEAL



9/CK J. GOMINI 10/30/23


GOGLIA ST. LOUIS, MO 63146

SCT, NCARB, RDI

ROAD, SUITE 300

FAX (348) 415-2300

SCOOTERS COPPER

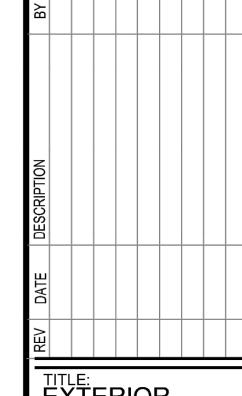

EXTERIOR ELEVATIONS

PROJECT ADDRESS:
306 S. MAIN ST.
ROLESVILLE, NC 27571
FRANCHISEE & STORE NUMBER:
SCOOTER'S COFFEE #562

KIOSK PROTOTYPE:
4.1 PROTOTYPE
MAY 2022
ISSUE DATE:
08/14/2023
PROJECT NO.
230522
DRAWN BY:
NES
CHECKED BY:

SHEET NO.

A2.2