
ARDEN SENIOR LIVING CENTER

ZONING CONDITIONS

- DEVELOPMENT OF THE PROPERTY SHALL BE IN SUBSTANTIAL CONFORMANCE WITH THE ACCOMPANYING EXHIBIT E CONCEPT PLAN. LOCATIONS SHOWN FOR COMMITTED ELEMENTS INCLUDING, BUT NOT LIMITED TO, SETBACKS, GREENWAYS, STREETS, AND OPEN SPACE AREAS SHOWN ON THE CONCEPT PLAN ARE CONCEPTUAL AND PROVIDED FOR ILLUSTRATION AND CONTEXT ONLY. FINAL LOCATIONS OF ELEMENTS SHALL BE DETERMINED AT SUBSEQUENT STAGES OF APPROVAL
- ONLY THE FOLLOWING USES SHALL BE PERMITTED ON THE PROPERTY: 2.1. RESIDENTIAL CARE AND ASSOCIATED ACCESSORY USE.
- 3. DEVELOPMENT SHALL BE LIMITED TO A MAXIMUM OF 164 RESIDENTIAL UNITS.

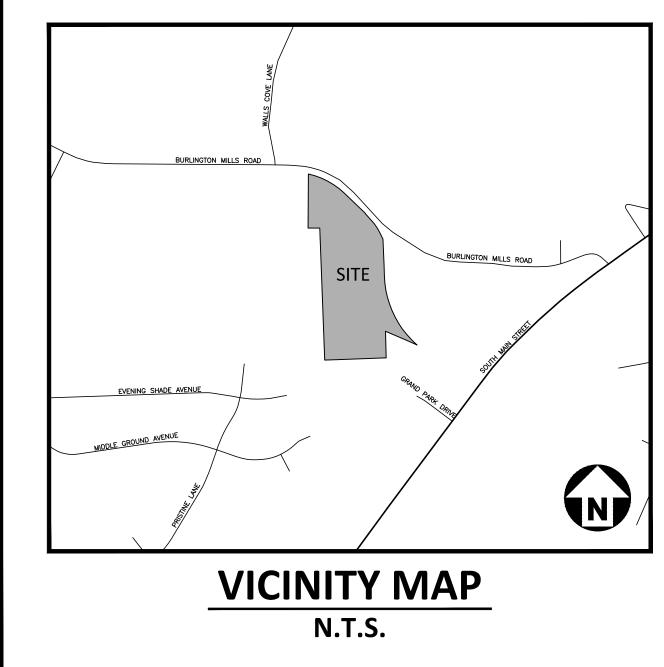

SITE AND OPEN SPACE AREAS			
TOTAL SITE AREA	10.42 AC		
RESIDENTIAL	10.42 AC		
RH-CZ(RESIDENTIAL CARE)	164		
TOTAL UNITS	164		
OVERALL DENSITY	15.72 DU/AC		
	15% OF TOTAL SITE AREA REQUIRED		
OPEN SPACE	1.56 AC REQUIRED		
	4.31 AC PROVIDED		

P	PARCEL OWNER LIST				
PIN	PIN OWNER				
1758-48-6155	BROTHERS FORTY SIX LLC	9.99 AC.			
1758-58-2090	WALLBROOK LANDO LLC	0.43 AC.			

BURLINGTON MILLS ROAD ROLESVILLE, NORTH CAROLINA

SITE DEVELOPMENT PLAN PROJECT NUMBER: SPEC23422 update the year to 2024 DATE: JANUARY 03, 2023

SITE DATA

CASE NUMBER

PIN

1.) TRC reviews the SDP for single lots at a Construction plan level.
If you as a design team wish to completed Site plan (SPD) and then propose Construction drawings later as a separate submittal as typical subdivision development (CID) let us kn
We started the initial review as a Construction Document (incomplete review as all CD le
items were not present)
No de la cita la compansión de constituir e constituir de la constituir de la constituir de la constituir de l
Next submittal for Engineering to provide a complete full review we need - storm package 10yr min/Culvert 25 yr/2yr gutter
- Drainage inlet maps
- pipe profiles

Utility profiles (water and sewer) for permitting.

1758486155; 1758582090

MA22-10

REAL ESTATE ID	074571; 0224145			
PROPOSED SITE AREA	10.42 AC			
EXISTING ZONING	GC-CZ			
PROPOSED ZONING	RESIDENTIAL CARE (RH-CZ)			
EXISTING NUMBER OF LOTS	2 (TOTAL)			
PROPOSED NUMBER OF LOTS	1 (TOTAL)			
WATERSHED OVERLAY	UPPER NEUSE			
WATER SUPPLY WATERSHED	NEUSE - MILBURNIE LAKE(MILBURNIE CREEK)			
RIVER BASIN	NEUSE			
COMMUNITY PLAN DESIGNATION	RESIDENTIAL CARE			
EXISTING USE	VACANT			
PROPOSED USE	164 RESIDENTIAL UNITS			
	• 136 - APARTMENT UNITS			
	• 14 - MULTIFAMILY DUPLEXES (28 UNITS)			
MAXIMUM UNITS ALLOWED	164 RESIDENTIAL UNITS			
DENSITY	MAXIMUM 15.72 DU/AC			
	PROPOSED 15.72 DU/AC (164 UNITS / 10.43 AC)			
BUILDING HEIGHT	MAXIMUM 60'			
	PROPOSED 1 STORY & 4 STORY WITH BASEMENT			
PARKING	REQUIRED 328 BEDSx 0.25/BED = 82 SPACES			
	PROPOSED 151 ON-STREET SPACES			
	42 GARAGE SPACES			
	193 TOTAL SPACES			
ACCESSIBLE PARKING	REQUIRED 193 SPACES × XXX% = 0 SPACES (2 VAN)			
	PROPOSED 16 SPACES (16 VAN)			
IMPERVIOUS AREA	EXISTING TOTAL IMPERVIOUS = 0.00 AC			
	PROPOSED TOTAL IMPERVIOUS = 5.45 AC			

3.) site plan shows all VA





The John R. McAdams Company, Inc 621 Hillsborough Street Suite 500 Raleigh, NC 27603 phone 919. 361. 5000 fax 919. 361. 2269 license number: C-0293, C-187

www.mcadamsco.com

CONTACT

JUAN MONTES montes@mcadamsco.com PHONE: 919. 361. 5000

CLIENT

BUVERMO INVESTMENTS, INC 7315 WISCONSIN AVENUE SUITE 925W BETHESDA, MARYLAND, 20814

SHEET INDEX PROJECT NOTES

<u>C0.00</u>

1 OF 1

-24-01 and

C3.00

C3.01

C3.02

C4.00

C4.01

C4.01

C8.00 C8.01

C8.02

C8.03 C8.04

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C8.06

L1.0

L1.1

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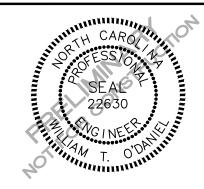
L4.1

L1.2-1.4

ALTA/NSPS SURVEY (PREPARED BY PENONI ASSOCIATES) ALTA/NSPS SURVEY (PREPARED BY PENONI ASSOCIATES) OVERALL SITE PLAN SITE PLAN AREA "A" SITE PLAN AREA "B" OVERALL GRADING AND STORM DRAINAGE PLAN GRADING AND STORM DRAINAGE PLAN AREA "A" GRADING AND STORM DRAINAGE PLAN AREA "B" OVERALL UTILITY PLAN UTILITY PLAN AREA "A" UTILITY PLAN AREA "B" SITE DETAILS STORM DRAINAGE DETAILS STORM DRAINAGE DETAILS WATER DETAILS WATER DETAILS SEWER DETAILS SEWER DETAILS DESIGNED BY OTHERS OPEN SPACE PLAN OVERALL PLANTING KEY PLAN ENLARGED PLANTING KEY PLAN AREAS PLANTING AND IRRIGATION NOTES & SPECIFICATIONS OVERALL AMENITY AREA HARDSCAPE PLAN L2.1-L2.2 ENLARGED HARDSCAPE PLAN AREAS L3.1-L3.3 LANDSCAPE DETAILS

WET POND SCM PLANTING PLAN

PROJECT DIRECTORY



REVISIONS

NO. DATE

PRELIMINARY PLAT **PLAN FOR:**

ARDEN SENIOR LIVING CENTER ROLESVILLE, NORTH CAROLINA PROJECT NUMBER: SPEC-23422

GENERAL NOTES:

- 1. ALL DIMENSIONS AND GRADES SHOWN ON THE PLANS SHALL BE FIELD VERIFIED BY THE CONTRACTOR PRIOR TO CONSTRUCTION. CONTRACTOR SHALL NOTIFY THE OWNER IF ANY DISCREPANCIES EXIST PRIOR TO PROCEEDING WITH CONSTRUCTION FOR NECESSARY PLAN OR GRADE CHANGES. NO EXTRA COMPENSATION SHALL BE PAID TO THE CONTRACTOR FOR ANY WORK DONE DUE TO DIMENSIONS OR GRADES SHOWN INCORRECTLY ON THESE PLANS IF SUCH NOTIFICATION HAS NOT BEEN GIVEN.
- 2. THERE MAY BE WETLANDS WITHIN THIS SITE. IT IS THE OWNER'S RESPONSIBILITY FOR WETLANDS JURISDICTION AND PERMIT DISTURBANCE PRIOR TO ANY GRADING ACTIVITY.

SITE PLAN NOTES

1. ALL CONSTRUCTION SHALL CONFORM TO THE LATEST TOWN OF ROLESVILLE AND/OR NCDOT STANDARDS AND SPECIFICATIONS AS APPLICABLE.

- 2. ALL DIMENSIONS SHOWN ON SITE PLAN ARE MEASURED TO BACK OF CURB UNLESS OTHERWISE NOTED.
- 3. CONTRACTOR SHALL MAINTAIN AN "AS-BUILT" SET OF DRAWINGS TO RECORD THE EXACT LOCATION OF ALL PIPING PRIOR TO CONCEALMENT. DRAWINGS SHALL BE GIVEN TO THE ENGINEER UPON COMPLETION OF THE PROJECT WITH A COPY OF THE TRANSMITTAL LETTER TO THE OWNER.
- 4. EXISTING IMPROVEMENTS DAMAGED DURING CONSTRUCTION SHALL BE REPLACED/RESTORED TO THEIR ORIGINAL CONDITION AND TO THE SATISFACTION OF THE OWNER, BY THE CONTRACTOR RESPONSIBLE FOR THE DAMAGE
- 5. THE CONTRACTOR SHALL NOTE THAT THE DRAWINGS MAY NOT SHOW EVERY OFFSET, TRANSITION, FITTING, ETC. THAT MAY BE REQUIRED. THE CONTRACTOR SHALL INSTALL SUCH STANDARD APPURTENANCES AS REQUIRED TO CLOSELY FOLLOW THE GRADES AND ALIGNMENTS DEPICTED ON THE PLANS.
- 6. CONTRACTOR SHALL NOTIFY "NC811" (811) OR (1-800-632-4949) AT LEAST 3 FULL BUSINESS DAYS PRIOR TO BEGINNING CONSTRUCTION OR EXCAVATION TO HAVE EXISTING UTILITIES LOCATED. CONTRACTOR SHALL CONTACT ANY LOCAL UTILITIES THAT PROVIDE THEIR OWN LOCATOR SERVICES INDEPENDENT OF "NC811" REPORT ANY DISCREPANCIES TO THE ENGINEER IMMEDIATELY.
- 7. CONTRACTOR IS RESPONSIBLE FOR COORDINATING CONSTRUCTION ACTIVITIES WITH THE APPROPRIATE UTILITY COMPANIES FOR ANY REQUIRED RELOCATIONS (I.E. POWER POLES, TELEPHONE PEDESTALS, WATER METERS. ETC.).
- 8. ALL DIMENSIONS AND GRADES SHOWN ON THE PLANS SHALL BE FIELD VERIFIED BY THE CONTRACTOR PRIOR TO CONSTRUCTION. CONTRACTOR SHALL NOTIFY THE ENGINEER IF ANY DISCREPANCIES EXIST PRIOR TO PROCEEDING WITH CONSTRUCTION, FOR NECESSARY PLAN OR GRADE CHANGES, NO EXTRA COMPENSATION SHALL BE PAID TO CONTRACTOR FOR ANY WORK DONE DUE TO DIMENSIONS OR GRADES SHOWN INCORRECTLY ON THESE PLANS IF SUCH NOTIFICATION HAS NOT BEEN GIVEN.
- 9. ACCESSIBLE RAMPS SHALL BE CONSTRUCTED IN ACCORDANCE WITH NCDOT DETAILS.
- 10. ALL SIDEWALKS THAT CONNECT TO THE PUBLIC RIGHT-OF-WAY MUST BE ACCESSIBLE TO PERSONS WHO ARE BLIND, HAVE LOW VISION AND PEOPLE WITH MOBILITY DISABILITIES. PEDESTRIAN EXISTING ROUTES AND ALTERNATE PEDESTRIAN ROUTES DURING CONSTRUCTION WILL BE REQUIRED TO BE COMPLIANT WITH THE PUBLIC RIGHTS OF WAY ACCESSIBILITY GUIDELINES (PROWAG), 2010 ADA STANDARDS FOR ACCESSIBLE DESIGN AND THE MANUAL ON UNIFORM TRAFFIC CONTROL DEVICES (MUTCD).
- 11. TYPICAL PAVEMENT SECTION DETAILS ARE SHOWN WITHIN THIS SET AND INTENDED TO BE A MINIMUM PAVEMENT SECTION REQUIREMENT. THE CURRENT GEOTECHNICAL REPORT SHALL OVER-RIDE ALL TYPICAL PAVEMENT SECTIONS SHOWN, IF THE GEOTECHNICAL ENGINEER DEEMS A HEAVIER SECTION IS REQUIRED.
- 12. EQUIPMENT AND PRODUCTS OTHER THAN THOSE SPECIFIED MAY BE USED PROVIDED APPROVAL HAS BEEN OBTAINED FROM THE OWNER IN WRITING PRIOR TO ORDERING OR INSTALLATION. THE CONTRACTOR SHALL WAIVE ANY CLAIM FOR ADDITIONAL COST RELATED TO SUBSTITUTION OF ALTERNATE EQUIPMENT.
- 13. ALL SIGNAGE ASSOCIATED WITH THE PUBLIC STREET SYSTEM SHALL ADHERE TO MUTCD STANDARDS AND SPECIFICATIONS.

NOTES:

- 1. ROADS LABELED AS PUBLIC WILL BE DEDICATED AS PUBLIC ROW TO BE MAINTANED BY THE TOWN OF ROLESVILLE.
- 2. ROADS LABELED AS PRIVATE WILL BE DEDICATED AS PRIVATE AND BE MAINTAINED BY THE HOA.
- 3. GREENWAY EASEMENTS LABELED AS PUBLIC WILL BE DEDICATED AS PUBLIC AND BE MAINTAINED BY THE TOWN OF ROLESVILLE.
- 4. SANITARY SEWER EASEMENTS WILL BE DEDICATED AS PUBLIC EASEMENTS TO THE CITY OF RALEIGH.

STORM DRAINAGE NOTES

- 1. ALL STORM DRAINAGE PIPES SHOWN SHALL BE REINFORCED CONCRETE (RCP) (MINIMUM CLASS III) UNLESS NOTED OTHERWISE. CONTRACTOR TO COORDINATE WITH THE GEOTECH TO VERIFY TYPE OF BEDDING REQUIRED BASED ON SOIL CONDITIONS. CONTRACTOR TO SELECT REQUIRED CLASS OF PIPE BASED ON DEPTH OF PIPE AND BEDDING PROVIDED PER THE AMERICAN CONCRETE PIPE ASSOCIATION GUIDELINES.
- 2. ALL STORM DRAINAGE CONSTRUCTION SHALL BE IN ACCORDANCE WITH THE TOWN OF ROLESVILLE STANDARDS.
- 3. ALL CONCRETE SHALL MEET A MINIMUM 3000 PSI COMPRESSIVE STRENGTH.
- 4 ALL PIPE IN STORM DRAIN STRUCTURES SHALL BE STRUCK EVEN WITH INSIDE WALL.
- 5. ALL PIPE JOINTS SHALL BE MADE WITH PREFORMED JOINT SEALER, WHICH CONFORMS TO AASHTO SPECIFICATION M-198 FOR TYPE B FLEXIBLE PLASTIC GASKETS UNLESS OTHERWISE NOTED.
- 6. THE INTERIOR SURFACES OF ALL STORM DRAINAGE STRUCTURES SHALL BE POINTED UP AND SMOOTHED TO AN ACCEPTABLE STANDARD, USING MORTAR MIXED TO MANUFACTURER'S SPECIFICATIONS.
- 7. ALL BACKFILL SHALL BE NON-PLASTIC IN NATURE, FREE FROM ROOTS, VEGETATION MATTER, WASTE CONSTRUCTION MATERIAL OR OTHER OBJECTIONABLE MATERIAL. SAID MATERIAL SHALL BE CAPABLE OF BEING COMPACTED BY MECHANICAL MEANS AND SHALL HAVE NO TENDENCY TO FLOW OR BEHAVE IN A PLASTIC MANNER UNDER THE TAMPING BLOWS OR PROOF ROLLING.
- 8. MATERIALS DEEMED BY THE OWNER'S REPRESENTATIVE OR GEOTECH AS UNSUITABLE FOR BACKFILL PURPOSES SHALL BE REMOVED AND REPLACED WITH SUITABLE MATERIAL.
- 9. BACKFILLING OF TRENCHES SHALL BE ACCOMPLISHED IMMEDIATELY AFTER PIPE IS LAID. THE FILL AROUND THE PIPE SHALL BE THOROUGHLY COMPACTED TO 95 % OF THE MAXIMUM DRY DENSITY OBTAINABLE WITH THE STANDARD PROCTOR TEST. THE TOP EIGHT (8) INCHES SHALL BE COMPACTED TO 100 PERCENT STANDARD PROCTOR.
- 10. UNDER NO CIRCUMSTANCES SHALL WATER BE ALLOWED TO RISE IN UNBACKFILLED TRENCHES AFTER PIPE HAS BEEN PLACED.
- 11. ALL CONCRETE PIPE AND PRECAST STORM STRUCTURES SHALL MEET NCDOT STANDARDS BY MANUFACTURER.
- 12. CONTRACTOR SHALL BE RESPONSIBLE FOR CHECKING ALL PIPE AND STRUCTURES FOR CRACKS OR BREAKS, PRIOR TO INSTALLATION. ANY DAMAGED ITEMS SHALL NOT BE INSTALLED.

GRADING NOTES

- 1. ALL DIMENSIONS AND GRADES SHOWN ON THE PLANS SHALL BE FIELD VERIFIED BY THE CONTRACTOR PRIOR TO CONSTRUCTION. CONTRACTOR SHALL NOTIFY THE ENGINEER IF ANY DISCREPANCIES EXIST PRIOR TO PROCEEDING WITH CONSTRUCTION, FOR NECESSARY PLAN OR GRADE CHANGES. NO EXTRA COMPENSATION SHALL BE PAID TO THE CONTRACTOR FOR ANY WORK DONE DUE TO DIMENSIONS OR GRADES SHOWN INCORRECTLY ON THESE PLANS IF SUCH NOTIFICATION HAS NOT BEEN GIVEN.
- 2. OCCUPATIONAL SAFETY AND HEALTH ADMINISTRATION (OSHA) STANDARDS FOR EXCAVATIONS; FINAL RULE 29CFR PART 1926, SUBPART "P" APPLIES TO ALL EXCAVATIONS EXCEEDING FIVE (5) FEET IN DEPTH. EXCAVATION EXCEEDING TWENTY (20) FEET IN DEPTH REQUIRES THE DESIGN OF A TRENCH SAFETY SYSTEM BY A REGISTERED PROFESSIONAL ENGINEER, PROVIDED BY CONTRACTOR RESPONSIBLE FOR EXCAVATION.
- 3. ALL CONSTRUCTION SHALL BE IN ACCORDANCE WITH THE TOWN OF ROLESVILLE AND/OR NCDOT STANDARDS AND SPECIFICATIONS AS APPLICABLE.
- 4. CONTRACTOR SHALL NOTIFY "NC811" (811) OR (1-800-632-4949) AT LEAST 3 FULL BUSINESS DAYS PRIOR TO BEGINNING CONSTRUCTION OR EXCAVATION TO HAVE EXISTING UTILITIES LOCATED. CONTRACTOR SHALL CONTACT ANY LOCAL UTILITIES THAT PROVIDE THEIR OWN LOCATOR SERVICES INDEPENDENT OF "NC811". REPORT ANY DISCREPANCIES TO THE ENGINEER IMMEDIATELY.
- 5. CONSTRUCTION, MAINTENANCE AND REMOVAL OF ALL EROSION CONTROL DEVICES ARE THE RESPONSIBILITY OF THE GENERAL CONTRACTOR. TIMING OF REMOVAL SHALL BE COORDINATED WITH THE EROSION CONTROL INSPECTOR.
- 6. EXISTING UTILITIES AND STRUCTURES SHOWN, BOTH UNDERGROUND AND ABOVE GROUND, ARE BASED ON A FIELD SURVEY AND THE BEST AVAILABLE RECORD DRAWINGS. THE CONTRACTOR SHALL VERIFY FIELD CONDITIONS PRIOR TO BEGINNING RELATED CONSTRUCTION. ANY DISCREPANCIES SHALL BE REPORTED TO THE ENGINEER IMMEDIATELY.
- 7. SOIL UNDER BUILDINGS, PAVED AREAS AND WITHIN SLOPES GREATER THAN 3:1 (H:V) SHALL BE APPROVED, PLACED AND COMPACTED AS RECOMMENDED BY THE GEOTECHNICAL ENGINEER.

RETAINING WALL NOTES

- IS RESPONSIBLE FOR ENSURING RETAINING WALLS ARE NOT LOCATED IN ANY STREAM BUFFERS, AND THEIR CONSTRUCTION DOES NOT ENCROACH INTO ANY ADJACENT PROPERTIES DUE TO ANY BATTER INCORPORATED IN THE DESIGN OF THE WALLS.
- THE CONTRACTOR'S RESPONSIBILITY TO OBTAIN FINAL CONSTRUCTION DRAWINGS FROM A REGISTERED ENGINEER AND GAIN ALL REQUIRED PERMITS NECESSARY FOR THE CONSTRUCTION OF THE RETAINING WALLS.
- RETAINING WALLS SHALL BE ASSUMED TO BE BACKFILLED WITH OFF-SITE BORROW DESIGNER, THAT READILY AVAILABLE ON-SITE SOILS CAN BE USED.
- THE TOP AND BOTTOM OF WALL ELEVATIONS SHOWN ON THESE PLANS IDENTIFY FINISHED GRADE FLEVATIONS ONLY. THE EXTENT THAT THE RETAINING WALL WILL BE BLOCK COURSE SHALL BE IDENTIFIED ON THE RETAINING WALL CONSTRUCTION DRAWINGS.
- 5. ALL RETAINING WALLS OVER 30" HIGH SHALL HAVE A SAFETY FENCE (DESIGN BY OTHERS).
- ANY TIEBACK SYSTEMS FOR THE RETAINING WALLS SHALL NOT BE ALLOWED WITHIN PUBLIC RIGHT-OF-WAY.

CITY OF RALEIGH PUBLIC UTILITIES STANDARD UTILITY NOTES (AS APPLICABLE)

- DETAILS & SPECIFICATIONS (REFERENCE: CORPUD HANDBOOK, CURRENT EDITION)
- 2. UTILITY SEPARATION REQUIREMENTS:
- OUTSIDE DIAMETER.
- INSTALLED TO WATERLINE SPECIFICATIONS.

- REQUIRED.
- RALEIGH PUBLIC UTILITIES DEPARTMENT PRIOR TO CONSTRUCTION.
- ON ALL REUSE MAINS.

ADVANCE NOTICE TO THE CITY OF RALEIGH PUBLIC UTILITIES DEPARTMENT.

- CONNECTION TO PROVIDE ADEQUATE FLOW & PRESSURE
- SPACED EVERY 75 LINEAR FEET MAXIMUM.

- (919) 996-2334 OR TIMOTHY.BEASLEY@RALEIGHNC.GOV_FOR MORE INFORMATION.
- (919) 996-5923 OR JOANIE.HARTLEY@RALEIGHNC.GOV FOR MORE INFORMATION.

THE RETAINING WALL ALIGNMENT SHOWN ON THESE PLANS DEPICTS THE LOCATION OF THE FRONT FACE OF THE RETAINING WALL AT THE TOP OF THE WALL. THE CONTRACTOR RETAINING WALLS ARE TO BE DESIGN-BUILD PROJECTS BY THE CONTRACTOR. IT SHALL BE

MATERIAL OR PROCESSED FILL, UNLESS THE CONTRACTOR CAN PROVIDE TO THE OWNER WITH CONFIRMATION FROM THE GEOTECHNICAL ENGINEER AND THE RETAINING WALL

EXTENDED BELOW GRADE TO THE FOOTING OR ABOVE GRADE TO THE TOP OF THE CAP

ALL MATERIALS & CONSTRUCTION METHODS SHALL BE IN ACCORDANCE WITH CITY OF RALEIGH DESIGN STANDARDS,

a. A DISTANCE OF 100' SHALL BE MAINTAINED BETWEEN SANITARY SEWER & ANY PRIVATE OR PUBLIC WATER SUPPLY SOURCE SUCH AS AN IMPOUNDED RESERVOIR USED AS A SOURCE OF DRINKING WATER. IF ADEQUATE LATERAL SEPARATION CANNOT BE ACHIEVED, FERROUS SANITARY SEWER PIPE SHALL BE SPECIFIED & INSTALLED TO WATERLINE SPECIFICATIONS. HOWEVER, THE MINIMUM SEPARATION SHALL NOT BE LESS THAN 25' FROM A PRIVATE WELL OR 50' FROM A PUBLIC WELL.

b. WHEN INSTALLING WATER &/OR SEWER MAINS, THE HORIZONTAL SEPARATION BETWEEN UTILITIES SHALL BE 10'. IF THIS SEPARATION CANNOT BE MAINTAINED DUE TO EXISTING CONDITIONS, THE VARIATION ALLOWED IS THE WATER MAIN IN A SEPARATE TRENCH WITH THE ELEVATION OF THE WATER MAIN AT LEAST 18" ABOVE THE TOP OF THE SEWER & MUST BE APPROVED BY THE PUBLIC UTILITIES DIRECTOR. ALL DISTANCES ARE MEASURED FROM OUTSIDE DIAMETER TO

c. WHERE IT IS IMPOSSIBLE TO OBTAIN PROPER SEPARATION, OR ANYTIME A SANITARY SEWER PASSES OVER A WATERMAIN, DIP MATERIALS OR STEEL ENCASEMENT EXTENDED 10' ON EACH SIDE OF CROSSING MUST BE SPECIFIED &

d. 5.0' MINIMUM HORIZONTAL SEPARATION IS REQUIRED BETWEEN ALL SANITARY SEWER & STORM SEWER FACILITIES, UNLESS DIP MATERIAL IS SPECIFIED FOR SANITARY SEWER.

e. MAINTAIN 18" MIN. VERTICAL SEPARATION AT ALL WATERMAIN & RCP STORM DRAIN CROSSINGS; MAINTAIN 18" MIN. VERTICAL SEPARATION AT ALL SANITARY SEWER & RCP STORM DRAIN CROSSINGS. WHERE ADEQUATE SEPARATIONS CANNOT BE ACHIEVED, SPECIFY DIP MATERIALS & A CONCRETE CRADLE HAVING 6" MIN. CLEARANCE (PER CORPUD DETAILS W-41 &

f. ALL OTHER UNDERGROUND UTILITIES SHALL CROSS WATER & SEWER FACILITIES WITH 18" MIN. VERTICAL SEPARATION

3. ANY NECESSARY FIELD REVISIONS ARE SUBJECT TO REVIEW & APPROVAL OF AN AMENDED PLAN &/OR PROFILE BY THE CITY OF

4. CONTRACTOR SHALL MAINTAIN CONTINUOUS WATER & SEWER SERVICE TO EXISTING RESIDENCES & BUSINESSES THROUGHOUT CONSTRUCTION OF PROJECT. ANY NECESSARY SERVICE INTERRUPTIONS SHALL BE PRECEDED BY A 24 HOUR

5. 3.0' MINIMUM COVER IS REQUIRED ON ALL WATER MAINS & SEWER FORCEMAINS. 4.0' MINIMUM COVER IS REQUIRED

IT IS THE DEVELOPER'S RESPONSIBILITY TO ABANDON OR REMOVE EXISTING WATER & SEWER SERVICES NOT BEING USED IN REDEVELOPMENT OF A SITE UNLESS OTHERWISE DIRECTED BY THE CITY OF RALEIGH PUBLIC UTILITIES DEPARTMENT. THIS INCLUDES ABANDONING TAP AT MAIN & REMOVAL OF SERVICE FROM ROW OR EASEMENT PER CORPUD HANDBOOK PROCEDURE.

7. INSTALL 3/4" COPPER WATER SERVICES WITH METERS LOCATED AT ROW OR WITHIN A 2'X2' WATERLINE EASEMENT IMMEDIATELY ADJACENT. NOTE: IT IS THE APPLICANT'S RESPONSIBILITY TO PROPERLY SIZE THE WATER SERVICE FOR EACH

8. INSTALL 4" PVC SEWER SERVICES @ 1.0% MINIMUM GRADE WITH CLEANOUTS LOCATED AT ROW OR EASEMENT LINE &

9. PRESSURE REDUCING VALVES ARE REQUIRED ON ALL WATER SERVICES EXCEEDING 80 PSI; BACKWATER VALVES ARE REQUIRED ON ALL SANITARY SEWER SERVICES HAVING BUILDING DRAINS LOWER THAN 1.0' ABOVE THE NEXT UPSTREAM MANHOLE.

10. ALL ENVIRONMENTAL PERMITS APPLICABLE TO THE PROJECT MUST BE OBTAINED FROM NCDWQ, USACE &/OR FEMA FOR ANY RIPARIAN BUFFER, WETLAND &/OR FLOODPLAIN IMPACTS (RESPECTIVELY) PRIOR TO CONSTRUCTION.

11. NCDOT / RAILROAD ENCROACHMENT AGREEMENTS ARE REQUIRED FOR ANY UTILITY WORK (INCLUDING MAIN EXTENSIONS & SERVICE TAPS) WITHIN STATE OR RAILROAD ROW PRIOR TO CONSTRUCTION.

12. GREASE INTERCEPTOR / OIL WATER SEPARATOR SIZING CALCULATIONS & INSTALLATION SPECIFICATIONS SHALL BE APPROVED BY THE CORPUD FOG PROGRAM COORDINATOR PRIOR TO ISSUANCE OF A BUILDING PERMIT. CONTACT TIM BEASLEY AT

13. CROSS-CONNECTION CONTROL PROTECTION DEVICES ARE REQUIRED BASED ON DEGREE OF HEALTH HAZARD INVOLVED AS LISTED IN APPENDIX-B OF THE RULES GOVERNING PUBLIC WATER SYSTEMS IN NORTH CAROLINA. THESE GUIDELINES ARE THE MINIMUM REQUIREMENTS. THE DEVICES SHALL MEET AMERICAN SOCIETY OF SANITARY ENGINEERING (ASSE) STANDARDS OR BE ON THE UNIVERSITY OF SOUTHERN CALIFORNIA APPROVAL LIST. THE DEVICES SHALL BE INSTALLED AND TESTED (BOTH INITIAL AND PERIODIC TESTING THEREAFTER) IN ACCORDANCE WITH THE MANUFACTURER'S RECOMMENDATIONS OR THE LOCAL CROSS-CONNECTION CONTROL PROGRAM, WHICHEVER IS MORE STRINGENT. CONTACT JOANIE HARTLEY AT



The John R. McAdams Company, 621 Hillsborough Street Suite 500 Raleigh, NC 27603 phone 919. 361. 5000 fax 919. 361. 2269 license number: C-0293, C-187

www.mcadamsco.com

CLIENT

BUVERMO INVESTMENTS, INC 7315 WISCONSIN AVENUE SUITE 925W BETHESDA, MARYLAND, 20814





REVISIONS

NO. DATE

PLAN INFORMATION

SHEET	
DATE	01. 03. 2024
SCALE	
DRAWN BY	BB
CHECKED BY	WTO
FILENAME	SPEC23422-Site-N
PROJECT NO.	SPEC-23422

PROJECT NOTES



CHICAGO TITLE INSURANCE COMPANY
COMMITMENT NUMBER: 22-13599CH
ADDITIONAL REFERENCE: 1028-5031
COMMITMENT DATE: AUGUST 8, 2022 AT 05:00 PM
SCHEDULE B - SECTION II
EXCEPTIONS

- 1. ANY DEFECT, LIEN, ENCUMBRANCE, ADVERSE CLAIM, OR OTHER MATTER THAT APPEARS FOR THE FIRST TIME IN THE PUBLIC RECORDS OR IS CREATED, ATTACHES, OR IS DISCLOSED BETWEEN THE COMMITMENT DATE AND THE DATE ON WHICH ALL OF THE SCHEDULE B, PART I REQUIREMENTS ARE MET. (NOT A SURVEY RELATED MATTER)
- 2. TAXES OR ASSESSMENTS FOR THE YEAR 2023, AND SUBSEQUENT YEARS, NOT YET DUE OR PAYABLE. (NOT A SURVEY RELATED MATTER)
- 3. ANY DISCREPANCY, CONFLICT, MATTERS REGARDING ACCESS, SHORTAGE IN AREA OR BOUNDARY LINES, ENCROACHMENT, ENCUMBRANCE, VIOLATION, VARIATION, OVERLAP, SETBACK, EASEMENT OR CLAIMS OF EASEMENT, RIPARIAN RIGHT, AND TITLE TO LAND WITHIN ROADS, WAYS, RAILROADS, WATERCOURSES, BURIAL GROUNDS, MARSHES, DREDGED OR FILLED AREAS OR LAND BELOW THE MEAN HIGH WATER MARK OR WITHIN THE BOUNDS OF ANY ADJOINING BODY OF WATER, OR OTHER ADVERSE CIRCUMSTANCE AFFECTING THE TITLE THAT WOULD BE DISCLOSED BY A CURRENT INSPECTION AND ACCURATE AND COMPLETE LAND SURVEY OF THE LAND. **(AS SHOWN ON SURVEY)**
- ANY RIGHT, EASEMENT, SETBACK, INTEREST, CLAIM, ENCROACHMENT, ENCUMBRANCE, VIOLATION, VARIATIONS OR OTHER ADVERSE CIRCUMSTANCE AFFECTING THE TITLE DISCLOSED BY PLAT(S) RECORDED IN BOOK OF MAPS 1961, PAGE 97; AND BOOK OF MAPS 2008, PAGE 1281.
 (PUBLIC RIGHT-OF-WAY FOR BURLINGTON MILLS ROAD HAS BEEN UPDATED BY DEPARTMENT OF TRANSPORTATION TAKE RECORDED IN DEED BOOK 18598 PAGE 229. SEE EXCEPTION 7)
- 5. ELECTRIC LINE RIGHT-OF-WAY EASEMENT WAKE ELECTRIC MEMBERSHIP CORPORATION RECORDED IN BOOK 3869, PAGE 23. **(DOES NOT APPEAR TO AFFECT SUBJECT PROPERTY)**
- 6. DEED OF EASEMENT FOR SIGHT DISTANCE TO THE NORTH CAROLINA DEPARTMENT OF TRANSPORTATION RECORDED IN BOOK 14283, PAGE 2030. (AS SHOWN ON SURVEY)
- 7. DEED FOR HIGHWAY RIGHT OF WAY TO THE DEPARTMENT OF TRANSPORTATION RECORDED IN BOOK 18598, PAGE 229. **(AS SHOWN ON SURVEY)**

FLOOD ZONE DESIGNATION

SAID SURVEYED PROPERTY IS LOCATED WITHIN AN AREA HAVING A ZONE DESIGNATION "X" AREA ON MINIMAL FLOOD HAZARD ON FLOOD INSURANCE RATE MAP NO. 3720175800K, DATED 7/19/2022, IN WAKE COUNTY, NORTH CAROLINA, WHICH IS THE CURRENT FLOOD INSURANCE RATE MAP FOR THE COMMUNITY IN WHICH SAID SURVEYED PROPERTY IS SITUATED.

> LEGAL DESCRIPTION FOR PROPERTY OF BROTHERS FORTY SIX, LLC PIN: 1758486155

LYING AND BEING SITUATE IN WAKE COUNTY, NC, AND BEING MORE PARTICULARLY DESCRIBED AS FOLLOWS:

BEING ALL OF TRACT 2 AS SHOWN ON A MAP ENTITLED "SUBDIVISION FOR WAKE COUNTY BOARD OF EDUCATION" ACCORDING TO THE PLAT THEREOF RECORDED IN BOOK OF MAPS 2008, PAGE 1281 IN THE OFFICE OF THE REGISTER OF DEEDS OF WAKE COUNTY, NORTH CAROLINA.

NOTES:

- 1. COORDINATES PROVIDED, REFERENCE NORTH CAROLINA STATE PLANE NAD83 (NSRS 2011) DATUM, REFERENCED FROM NC VRS NETWORK.
- 2. BOUNDARY INFORMATION NOTED HEREON AND VERIFIED BY A FIELD SURVEY IS WITHIN ALTA/NSPS DEFINED TOLERANCE FOR RELATIVE POSITIONAL PRECISION.
- 3. THERE WAS NO OBSERVED EVIDENCE OF CURRENT BUILDING ADDITIONS, EARTH MOVING WORK, CONSTRUCTION, SOLID WASTE DUMP, SANITARY LANDFILL OR SUMP ON SITE.
- 4. THE SURVEY AND INFORMATION, COURSES AND DISTANCES SHOWN
- THEREON ARE ACCURATE.
 5. EXCEPT AS SHOWN, THERE ARE NO APPARENT ENCROACHMENTS ONTO ADJOINING PREMISES, STREETS, ALLEYS OR EASEMENT AREAS BY ANY BUILDINGS, STRUCTURES OR OTHER IMPROVEMENTS, AND NO ENCROACHMENTS ONTO THE PREMISES BY BUILDINGS, STRUCTURES OR OTHER IMPROVEMENTS SITUATED ON ADJOINING PREMISES.
 6 EXCEPT AS SHOWN. THERE ARE NO VISIBLE OR APPARENT EASEMENTS OR
- EXCEPT AS SHOWN, THERE ARE NO VISIBLE OR APPARENT EASEMENTS OR RIGHTS OF WAY ACROSS THE PREMISES.
 THE PREMISES HAS DIRECT ACCESS TO BURLINGTON MILLS ROAD, A
- THE PARCEL IS CONTIGUOUS WITHOUT ANY GAPS OR GORES.
 THERE IS NO VISIBLE EVIDENCE OF CEMETERIES OR BURIAL GROUNDS FOUND.
- 10. NO BUILDINGS WERE OBSERVED ON THE SUBJECT PARCEL DURING THE COURSE OF THIS SURVEY.
- 11. NO EVIDENCE OF RECENT STREET OR SIDEWALK CONSTRUCTION OR REPAIRS WERE OBSERVED IN THE PROCESS OF CONDUCTING THE FIELDWORK .
- 12. TABLE A ITEM 6(a): NO ZONING REPORT OR LETTER PROVIDED TO THE SURVEYOR. PROPERTY IS ZONED RO BY WAKE COUNTY GIS.
- 13. TABLE A ITEM 11(b): UNDERGROUND UTILITIES LOCATED BY NORTH
- CAROLINA 811 TICKET NUMBER A222524072 DATED 9/09/2022.
 14. WETLANDS OR HAZARDOUS MATERIALS WERE NEITHER OBSERVED OR INVESTIGATED DURING THE PERFORMANCE OF THIS SURVEY.

LINE #	
L1	
L2	
L3	


CURVE #
C1
C2


LEGEND

.	STORM INLET BOTTOM OF DITCH	[^{15"} RC
	SITE, MAIL BOX	OE
	SITE, SIGN	
0	SANITARY SEWER, CLEAN-OUT	45.60' 45.60'
S	SANITARY SEWER, MANHOLE	
	_ VEGETATION, TREE LINE	
-0-	WATER, FIRE HYDRANT	
T	WATER, STUB OUT	N 00°13'39"
w w	WATER, UNDERGROUND	
	WATER, VALVE	
<i>UCUC</i>	_ COMMUNICATION, UNDERGROUND	
FO	FIBER OPTIC, MANHOLE	
FO	FIBER OPTIC, PEDESTAL	
@	FIBER OPTIC, STUB OUT	
	NATURAL GAS, VALVE	
	NATURAL GAS, UNDERGROUND	
EJB	POWER, JUNCTION BOX	
ф.	POWER, LIGHT	N/F
0E 0E	POWER, OVERHEAD	WAKE COUNTY BOARD OF EDUCATIO
E	POWER, PEDESTAL	PIN: 1758387160 DB 13179, PG 1360
	PROPERTY, LINE LEGAL RIGHT-OF-WAY	BM 2008, PG 1281 ROLESVILLE MIDDLE SCHO
	PROPERTY, CORNER FOUND PROPERTY, CORNER SET PROPERTY, CONCRETE MONUMENT PROPERTY, ADJOINING LINE EASEMENT LINE	ROLESVILLE MIDDLE SCHU

LINE TABLE				
BEARING	DISTANCE			
46°37'46" E	42.97'			
37°52'58" E	106.82'			
41°24'08" E	166.49'			

CURVE TABLE							
	RADIUS	DELTA	ARC LENGTH	TANGENT	CHORD LENGTH	CHORD BEARING	
	567.00'	031°27'47"	311.36'	159.71	307.46'	S 61°41'13" E	
	503.00'	001°27'41"	12.83'	6.42	12.83'	S 25°56'33" E	

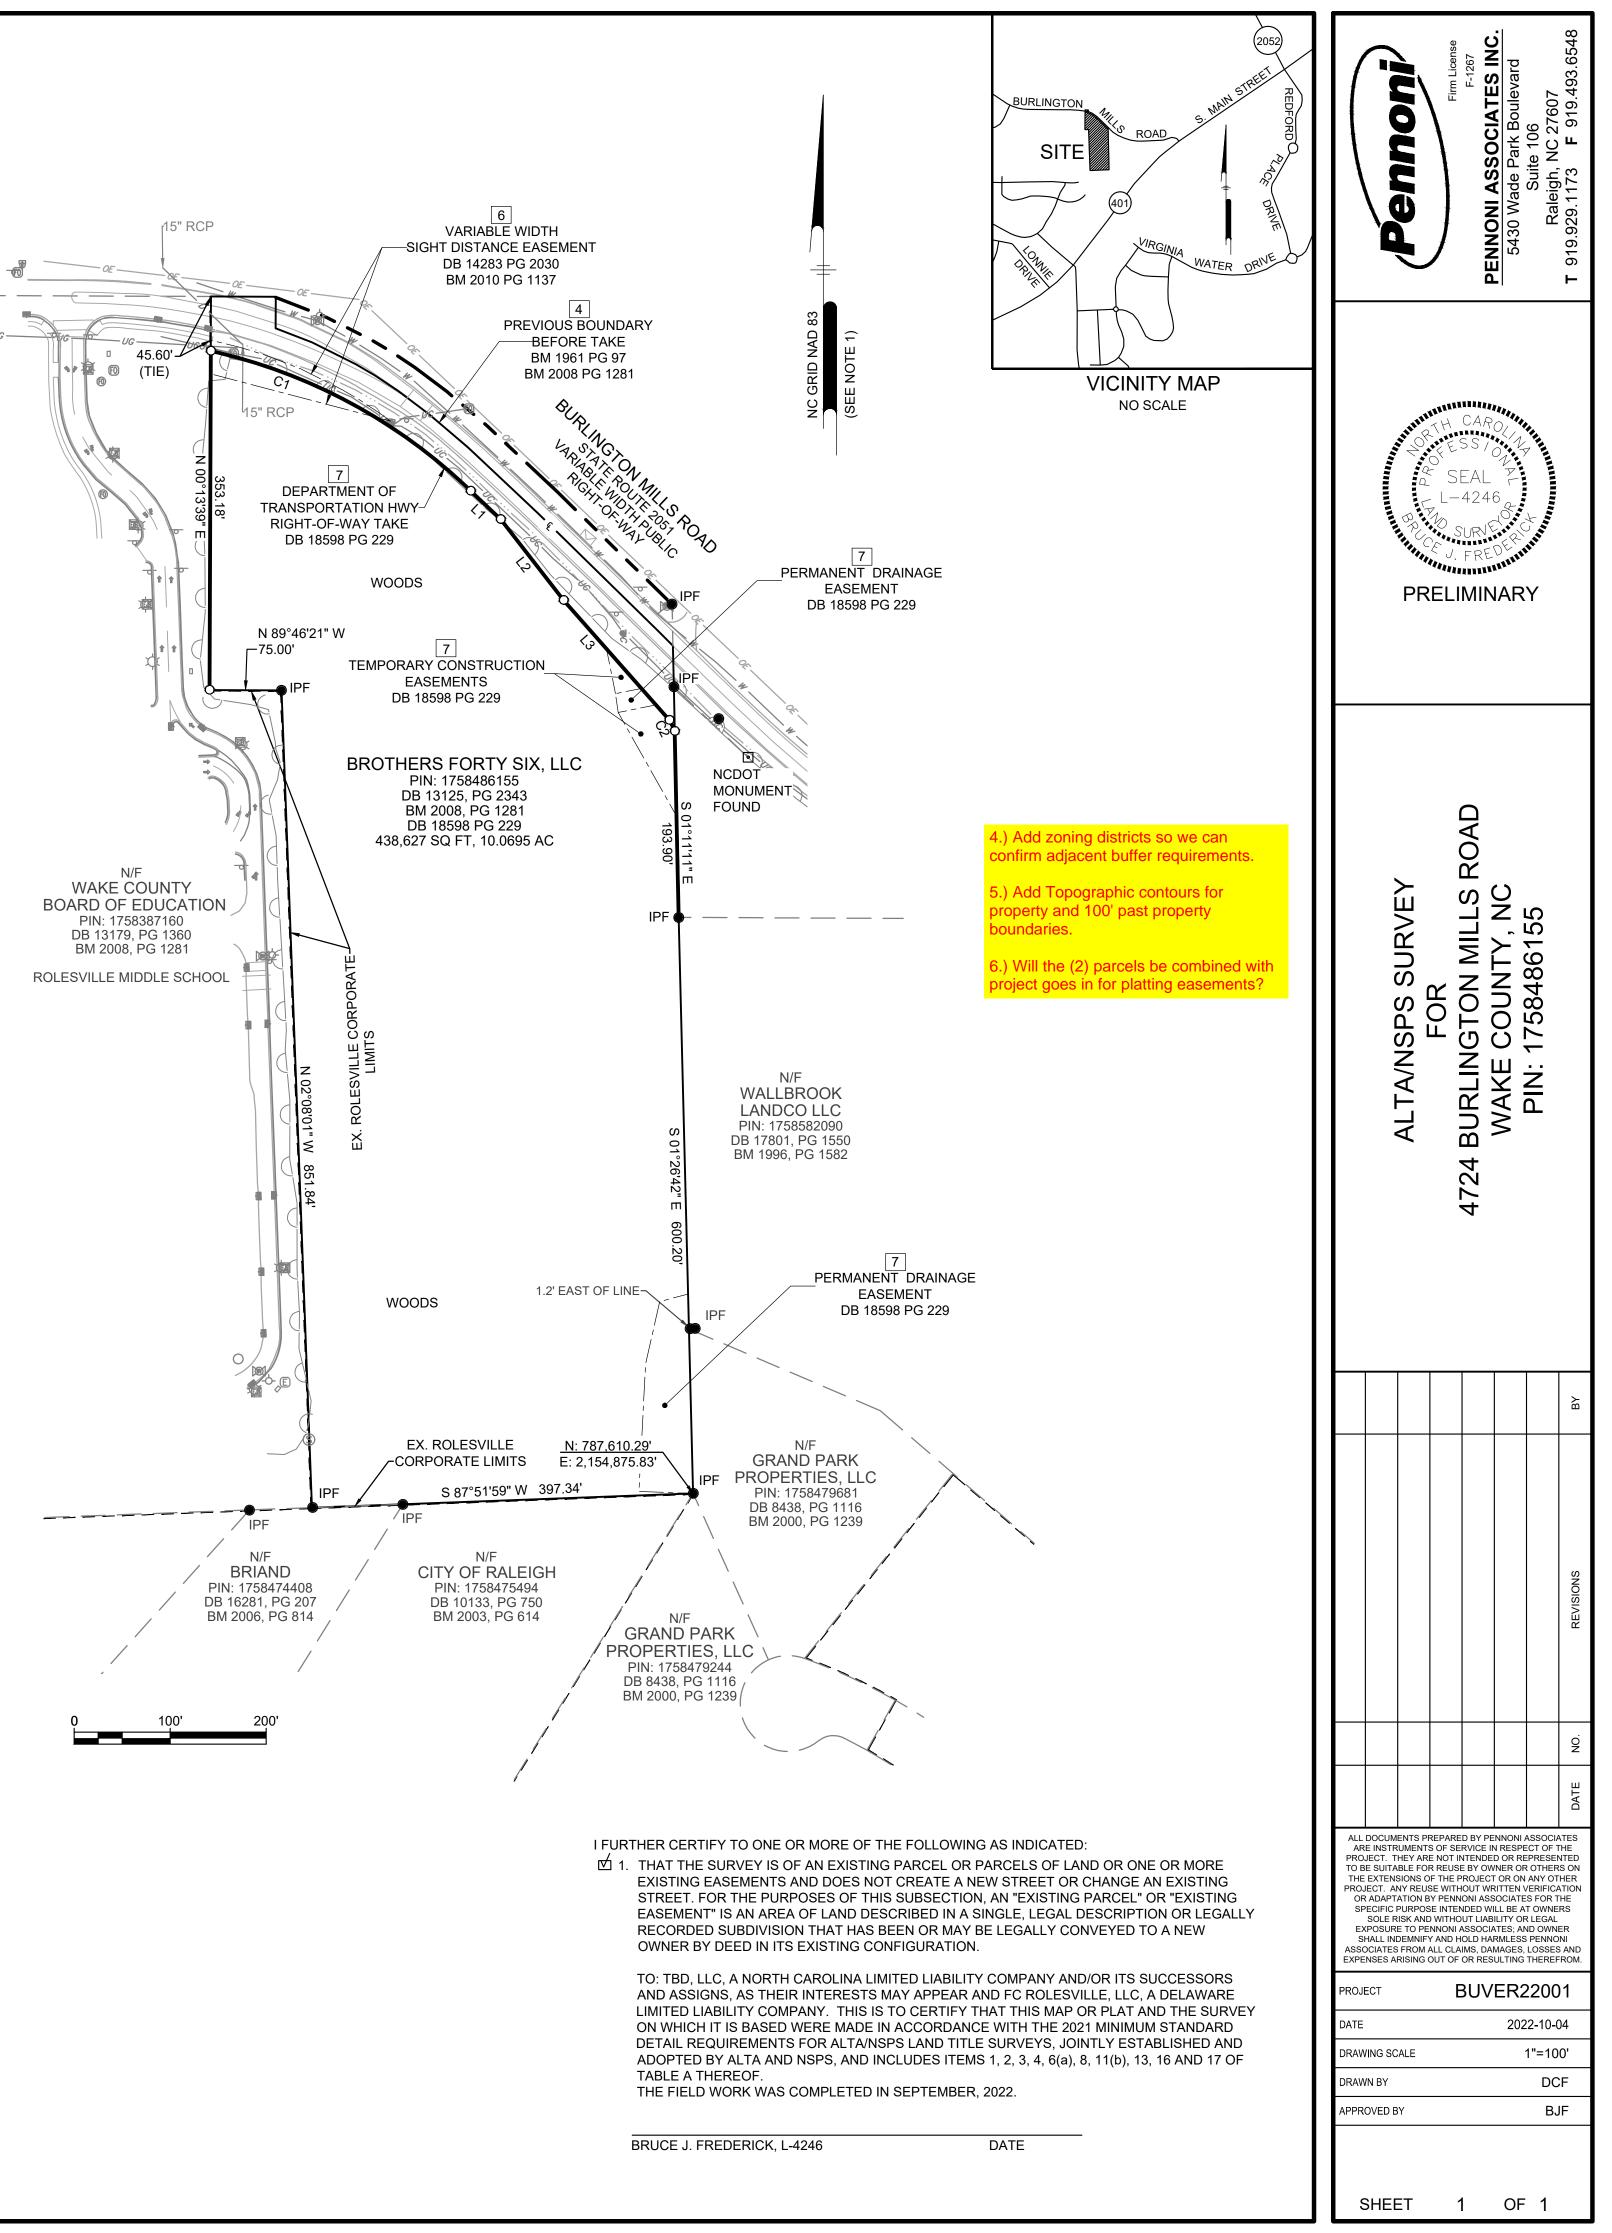

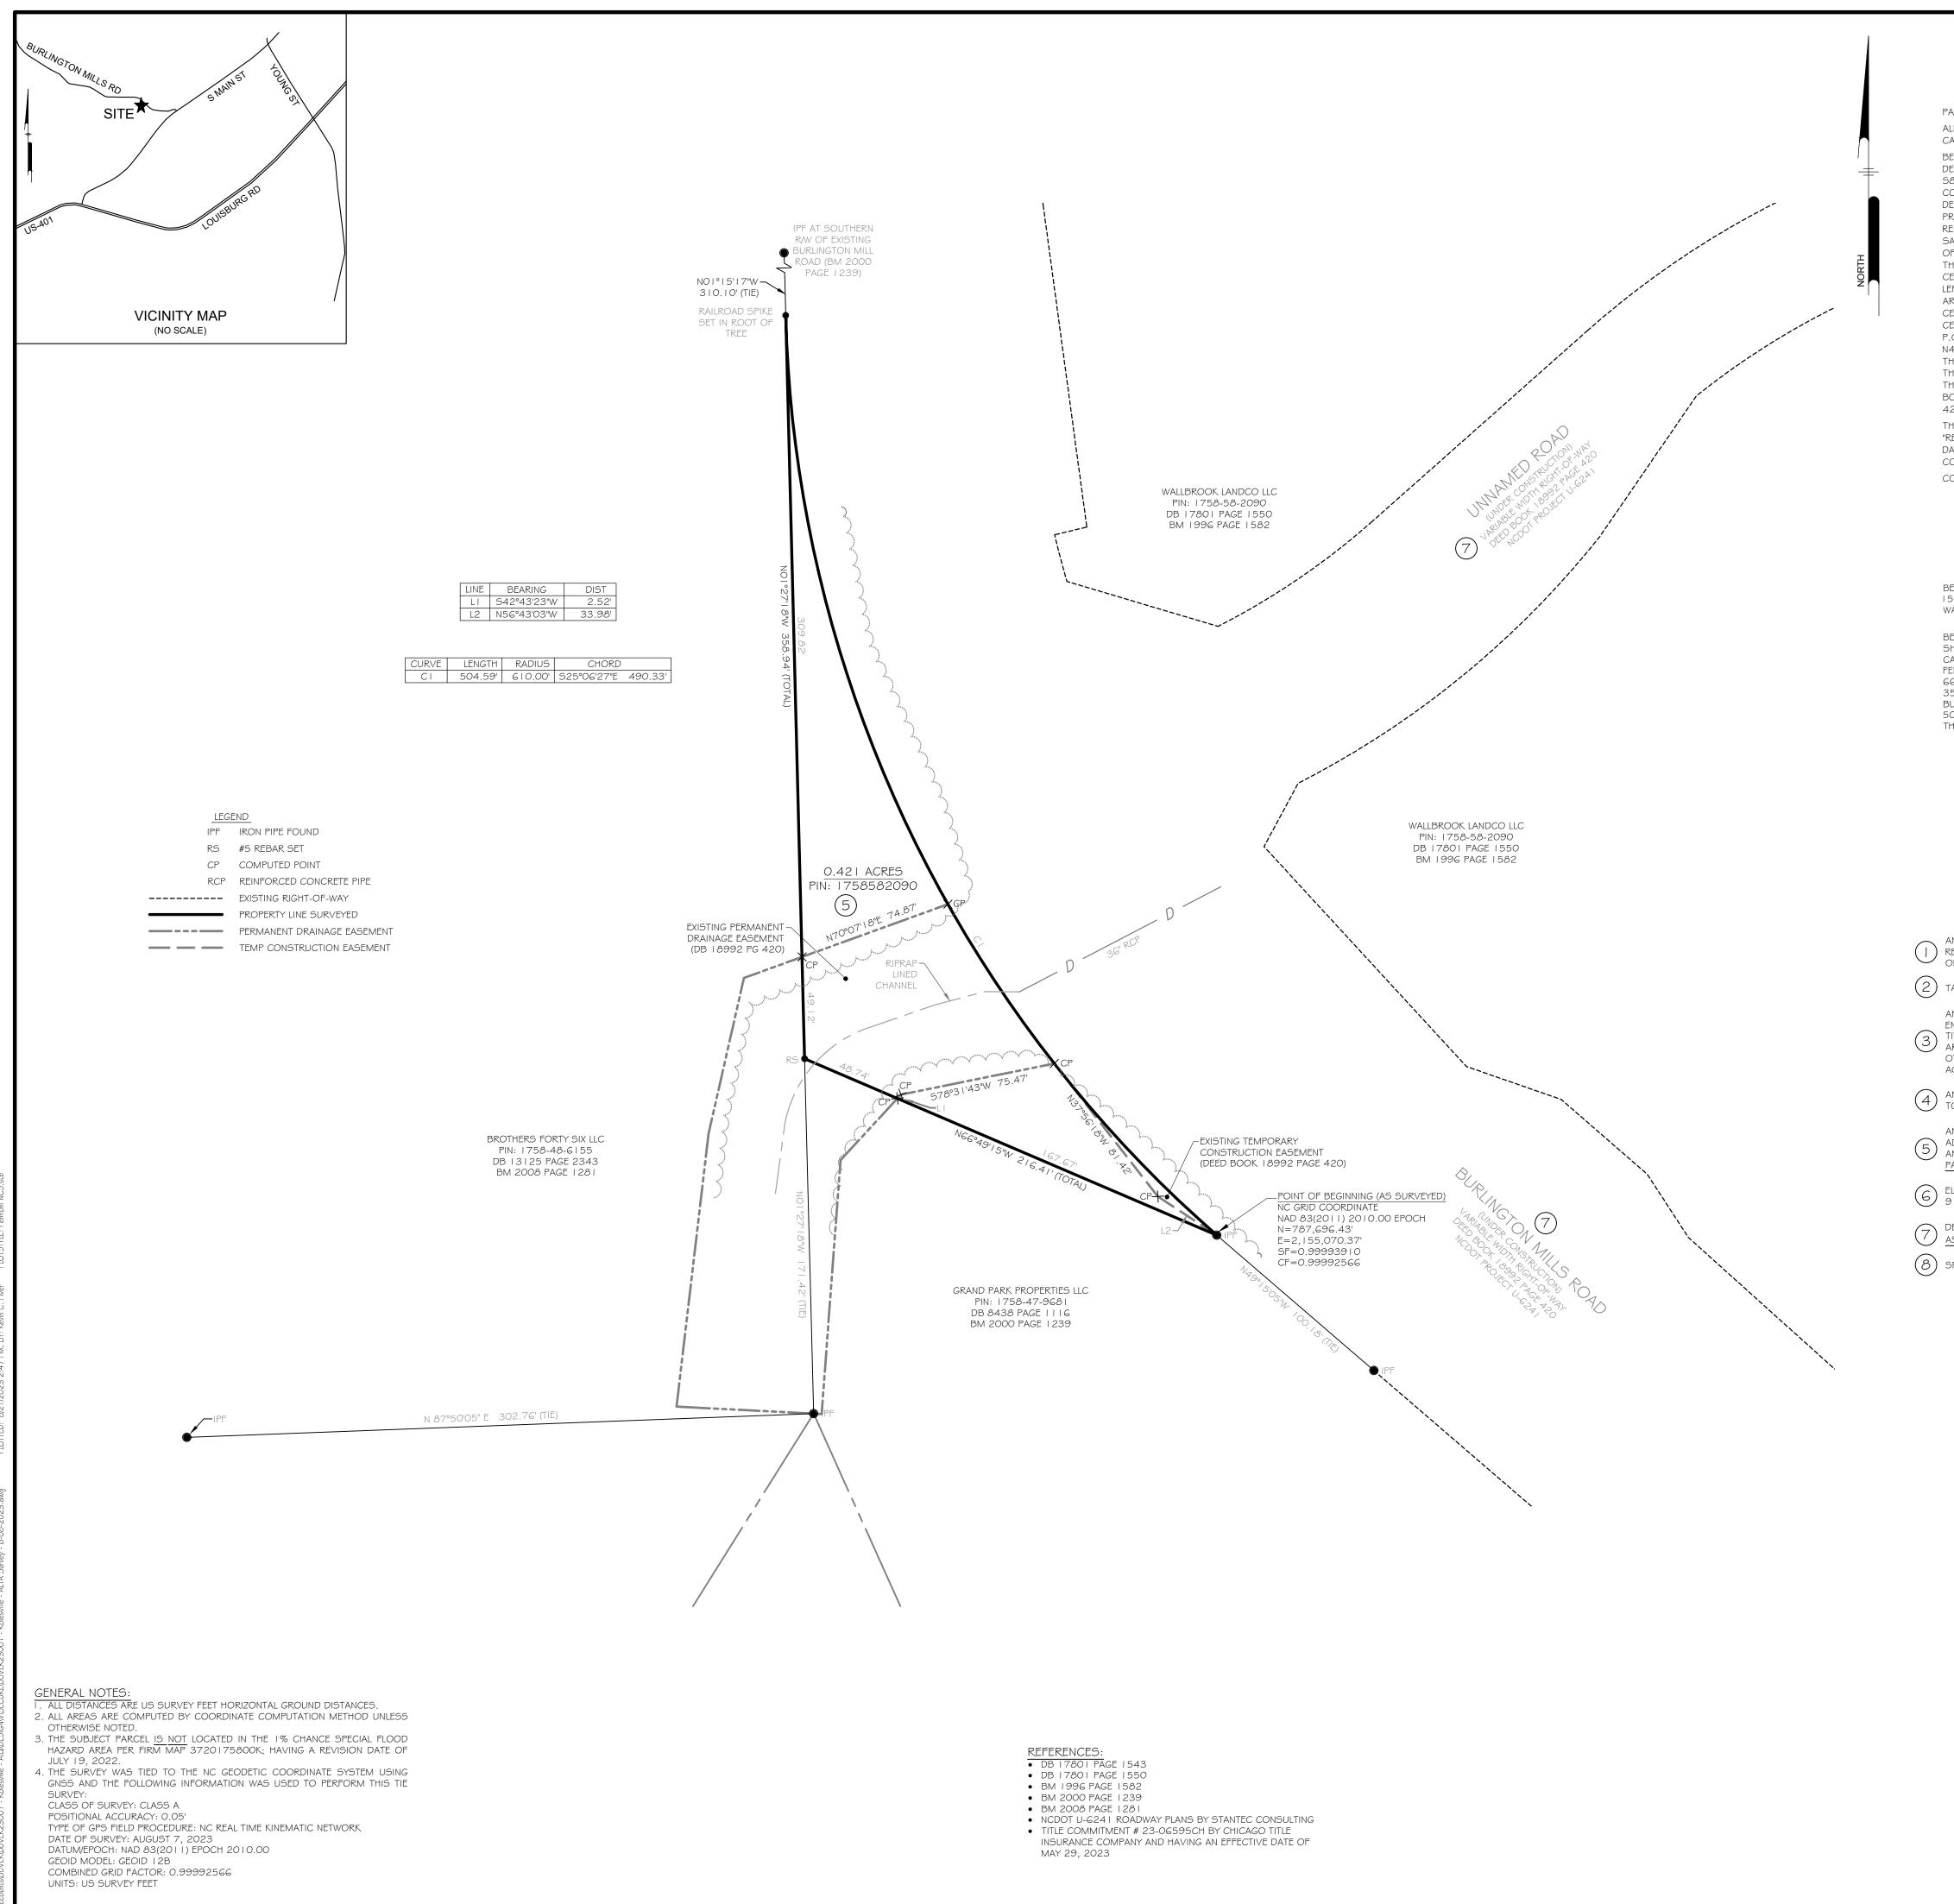

PROPERTY DESCRIPTION (RECORD)

PARCEL 2 (PIN #1758-58-2090)

ALL THAT CERTAIN REAL PROPERTY SITUATED IN THE TOWN OF ROLESVILLE, COUNTY OF WAKE, STATE OF NORTH CAROLINA, DESCRIBED AS FOLLOWS:

BEGINNING AT A FOUND IRON PIPE MARKING THE SOUTHWEST CORNER OF PARCEL 2 AS SAID PARCEL IS DESCRIBED IN DEED BOOK 15498, PAGE 1302, WAKE COUNTY RECORDS; THENCE ALONG THE SOUTH LINE OF SAID PARCEL 2 S89°45'0211E 399.74' TO THE SOUTHWEST RIGHT OF WAY LINE OF BURLINGTON MILLS ROAD (S.R. 2051); THENCE CONTINUING 589°45'0211E 200.72' TO THE NORTHWEST CORNER OF LOT 2-4 AS SAID LOT IS SHOWN AND SO DESIGNATED ON THAT CERTAIN PLAT ENTITLED "RECOMBINATION SURVEY FOR TOMMY TWITTY, TRACTS 2-2 # 2-3, TWITTY PROP.", BY W. GRAHAM CAWTHORNE, JR., RLS, DATED NOVEMBER 17, 1995, REVISED JANUARY 12, 1996 AND RECORDED IN BOOK OF MAPS 1996, PAGE 1582, WAKE COUNTY RECORDS; THENCE ALONG THE SOUTHWEST LINE OF SAID LOT 2-4 S37°53'38"E 39.01' TO A FOUND BENT IRON PIPE AT AN ANGLE POINT IN THE SOUTH RIGHT OF WAY LINE OF BURLINGTON MILLS ROAD; THENCE CONTINUING S37°53'38"E 454.70' TO A FOUND IRON PIPE AT AN ANGLE POINT IN THE NORTHWEST RIGHT OF WAY LINE OF LOUISBURG ROAD (U.S. 401); THENCE CONTINUING 537°53'38"E 45.31' TO THE CENTERLINE OF LOUISBURG ROAD; THENCE ALONG THE CENTERLINE OF SAID ROAD, ALONG THE ARC OF A CURVE TO THE LEFT, CONCAVE TO THE SOUTHEAST, HAVING A RADIUS OF 3,750.00', THROUGH A CENTRAL ANGLE OF 08°13'0611, AN ARC LENGTH OF 537.89' AND BEING SUBTENDED BY A CHORD BEARING S41°12'0911W 537.43'; THENCE LEAVING SAID CENTERLINE, ALONG THE NORTHEAST LINE OF LOTS I AND 2 AS SAID LOTS ARE SHOWN AND SO DESIGNATED ON THAT CERTAIN PLAT ENTITLED "SURVEY FOR GRAND PARK PROPERTIES, LOTS | AND 211, BY CAWTHORNE, MOSS & PANCIERA, P.C., DATED OCTOBER 7, 1998 AND RECORDED IN BOOK OF MAPS 1999, PAGE 1039, WAKE COUNTY RECORDS, N49°I G'09 I I W 479.09' TO A FOUND IRON PIPE MARKING AN ANGLE POINT IN SAID LOT 2; THENCE CONTINUING ALONG THE NORTHEAST LINE OF SAID LOT 2 NG6°40'58"W 215.40' TO A FOUND IRON PIPE AT THE NORTHWEST CORNER THEREOF, SAID PIPE ALSO BEING ON THE EAST LINE OF TRACT #3 AS SAID TRACT IS SHOWN AND SO DESIGNATED ON THAT CERTAIN PLAT ENTITLED "W. H. MARSHALL ESTATE", BY C. W. RUSSUM, RLS, DATED JULY, 1961 AND RECORDED IN BOOK OF MAPS 1961, PAGE 97, WAKE COUNTY RECORDS; THENCE ALONG SAID EAST LINE OF TRACT 3 NO1°36'18"W 428.68' TO THE POINT OF BEGINNING.

THIS PARCEL IS THE SAME AS LOT 2-3 AS SHOWN AND SO DESIGNATED ON THAT CERTAIN PLAT ENTITLED "RECOMBINATION SURVEY FOR TOMMY TWITTY, TRACTS 2-2 # 2-3, TWITTY PROP.", BY W. GRAHAM CAWTHORNE, JR., RLS, DATED NOVEMBER 17, 1995, REVISED JANUARY 12, 1996 AND RECORDED IN BOOK OF MAPS 1996, PAGE 1582, WAKE COUNTY RECORDS.

CONTAINING 11.168 ACRES, MORE OR LESS.

PROPERTY DESCRIPTION (AS SURVEYED)

BEING A PORTION OF THE PROPERTY OWNED BY THE WALLBROOK LANCO LLC AS DESCRIBED IN DEED BOOK 17801 PAGE 1550 AND DEPICTED IN BOOK OF MAPS 1996 PAGE 1582 IN THE WAKE COUNTY REGISTRY, SAID PROPERTY IS SITUATED IN WAKE FOREST TOWNSHIP, WAKE COUNTY, NORTH CAROLINA AND BEING MORE PARTICULARLY DESCRIBED AS:

BEGINNING AT AN IRON PIPE FOUND ALONG THE WESTERN RIGHT-OF-WAY OF THE RE-ALIGNED BURLINGTON MILL ROAD AS SHOWN ON NCDOT PLANS (TIP# U-6241), SAID POINT BEING THE TRUE POINT OF BEGINNING AND HAVING NORTH CAROLINA GRID COORDINATES (NAD 83/2011 2010.00 EPOCH) OF NORTH=787,696.43 FEET AND EAST=2,155,070.37 FEET (US SURVEY FEET); THENCE LEAVING THE WESTERN RIGHT-OF-WAY OF THE RE-ALIGNED BURLINGTON MILL ROAD NORTH 66° 49' 15" WEST, A DISTANCE OF 216.41 FEET TO A #5 REBAR SET; THENCE NORTH 1° 27" 18" WEST, A DISTANCE OF 358.94 FEET TO A RAILROAD SPIKE SET IN A ROOT OF A TREE IN THE WESTERN RIGHT-OF-WAY OF THE RE-ALIGNED BURLINGTON MILL ROAD; THENCE ALONG SAID RIGHT-OF-WAY ALONG A CIRCULAR CURVE TO THE LEFT A DISTANCE OF 504.59 FEET, HAVING A RADIUS OF 610.00 AND A CHORD OF SOUTH 25° 06' 27" EAST, A DISTANCE OF 490.33 FEET TO THE POINT AND PLACE OF BEGINNING, HAVING AN AREA OF 0.421 ACRES (18,343.1 FT2).

> SCHEDULE B - SECTION II - EXCEPTIONS CHICAGO TITLE INSURANCE COMPANY COMMITMENT NUMBER: 23-06595CH COMMITMENT EFFECTIVE DATE: MAY 29, 2023 AT 5:00 PM

ANY DEFECT, LIEN, ENCUMBRANCE, ADVERSE CLAIM, OR OTHER MATTER THAT APPEARS FOR THE FIRST TIME IN THE PUBLIC

RECORDS OR IS CREATED, ATTACHES, OR IS DISCLOSED BETWEEN THE COMMITMENT DATE AND THE DATE ON WHICH ALL OF THE SCHEDULE B, PART I - REQUIREMENTS ARE MET. NOT A SURVEY ITEM

(2) TAXES OR ASSESSMENTS FOR THE YEAR 2023, AND SUBSEQUENT YEARS, NOT YET DUE OR PAYABLE. NOT A SURVEY ITEM ANY DISCREPANCY, CONFLICT, MATTERS REGARDING ACCESS, SHORTAGE IN AREA OR BOUNDARY LINES, ENCROACHMENT, ENCUMBRANCE, VIOLATION, VARIATION, OVERLAP, SETBACK, EASEMENT OR CLAIMS OF EASEMENT, RIPARIAN RIGHT, AND

3 TITLE TO LAND WITHIN ROADS, WAYS, RAILROADS, WAIERCOURSES, DUNIAL GROUNDS, MUNICIPAL, STATER, OR AREAS OR LAND BELOW THE MEAN HIGHWATER MARK OR WITHIN THE BOUNDS OF ANY ADJOINING BODY OF WATER, OR TITLE TO LAND WITHIN ROADS, WAYS, RAILROADS, WATERCOURSES, BURIAL GROUNDS, MARSHES, DREDGED OR FILLED OTHER ADVERSE CIRCUMSTANCE AFFECTING THE TITLE THAT WOULD BE DISCLOSED BY A CURRENT INSPECTION AND ACCURATE AND COMPLETE LAND SURVEY OF THE LAND. AS SHOWN ON PLAT, IF ANY.

ANY DISCREPANCY IN THE QUANTITY OF THE AREA, SQUARE FOOTAGE, OR ACREAGE OF THE LAND OR OF ANY IMPROVEMENT TO THE LAND. NOT A SURVEY ITEM

ANY RIGHT, EASEMENT, SETBACK, INTEREST, CLAIM, ENCROACHMENT, ENCUMBRANCE, VIOLATION, VARIATIONS OR OTHER ANT NIGHT, LASEMENT, SETDACK, INTEREST, CLAIM, ENCROACTIMENT, ENCOMPLANCE, VIOLATION, VARIATIONS OR OTHER ADVERSE CIRCUMSTANCE AFFECTING THE TITLE DISCLOSED BY PLAT(S) RECORDED IN BOOK OF MAPS 1996, PAGE 1582; AND BOOK OF MAPS <u>N/A</u>, PAGE <u>N/A</u>. (EXCEPTION TO BE COMPLETED UPON SATISFACTION OF SCHEDULE B, PART I, ITEM 14.) PARCEL SIZE HAS CHANGED DUE TO NCDOT PLANS TIP# U-6241. SHOWN ON PLAT.

6 ELECTRIC LINE RIGHT-OF-WAY EASEMENT TO WAKE ELECTRIC MEMBERSHIP CORPORATION RECORDED IN BOOK 3868, PAGE 917. BLANKET EASEMENT. UNABLE TO PLOT OR DETERMINE IF IT AFFECTS SUBJECT PARCEL.

DEED FOR HIGHWAY RIGHT OF WAY TO THE DEPARTMENT OF TRANSPORTATION RECORDED IN BOOK 18992, PAGE 416.

 (δ) SPECIAL USE PERMIT RECORDED IN BOOK 18451, PAGE 470. NOT A SURVEY ITEM.

I, KEVIN C. PIVER, PLS, CERTIF	Y THAT THIS M	AP WAS DRA	AWN UNDER N	/IY SUPERVISI	ON FROM	M AN
ACTUAL FIELD SURVEY UNDER	R MY SUPERVIS	BION; THAT	THE BOUNDA	RIES NOT SL	JRVEYED	ARE
INDICATED (BY DASHED LINES) AS DRAWN F	ROM INFORM	MATION SHO	wn on the i	FACE OF	THE
PLAT; THAT THE POSITIONA	AL ACCURACY	IS 0.05';	AND THAT	THIS MAP	MEETS	THE
REQUIREMENTS OF THE ST	ANDARDS OF	PRACTICE	FOR LAND	SURVEYING	; IN NC	ORTH
CAROLINA(21 NCAC 56.1600).					

PRELIMINARY PLAT AUGUST XX, 2023 KENNOT TYPE RECORDATION NO. DATE CONVEYANCES, OR SALES

TO FC ROLESVILLE, LLC, A DELAWARE LIMITED LIABILITY COMPANY, BUVERMO INVESTMENTS, INC., AND CHICAGO TITLE INSURANCE COMPANY:


THIS IS TO CERTIFY THAT THIS MAP OR PLAT AND THE SURVEY ON WHICH IT IS BASED WERE MADE IN ACCORDANCE WITH THE 2016 MINIMUM STANDARD DETAIL REQUIREMENTS FOR ALTA/NSPS LAND TITLE SURVEYS, JOINTLY ESTABLISHED AND ADOPTED BY ALTA AND NSPS, AND INCLUDES ITEMS 1, 2, 3, 4, 6, 8, 11(A), 13, 16, 17, \$ 20 OF TABLE A THEREOF. THE FIELD WORK WAS COMPLETED ON AUGUST 14, 2023.


DATE

PRELIMINARY PLAT AUGUST XX, 2023 KEKIOTPIE RECORDATION NO. CONVEYANCES, OR SALES

1 inch = 40 ft.

Pennoni	Firm License F-1267	PENNONI ASSOCIATES INC.5430 Wade Park Boulevard, Suite 106Raleigh, NC 27607T 919.929.1173F 919.493.6548
A PORTION OF LOT 2-3, BM 1996 PAGE 1582	TOWN OF ROLESVILLE, WAKE FOREST TOWNSHIP, WAKE COUNTY, NC	BUVERMO INVESTMENTS, INC. CURRENT OWNER WALLBROOK LANDCO LLC DEED BOOK 17801 PAGE 1550
		BY
		REVISIONS
		DATE
PROJECT DATE DRAWING SCA DRAWN BY		/ER23001 2023-08-07 I" = 40' MGR
DRAWN BY		MGR KCP

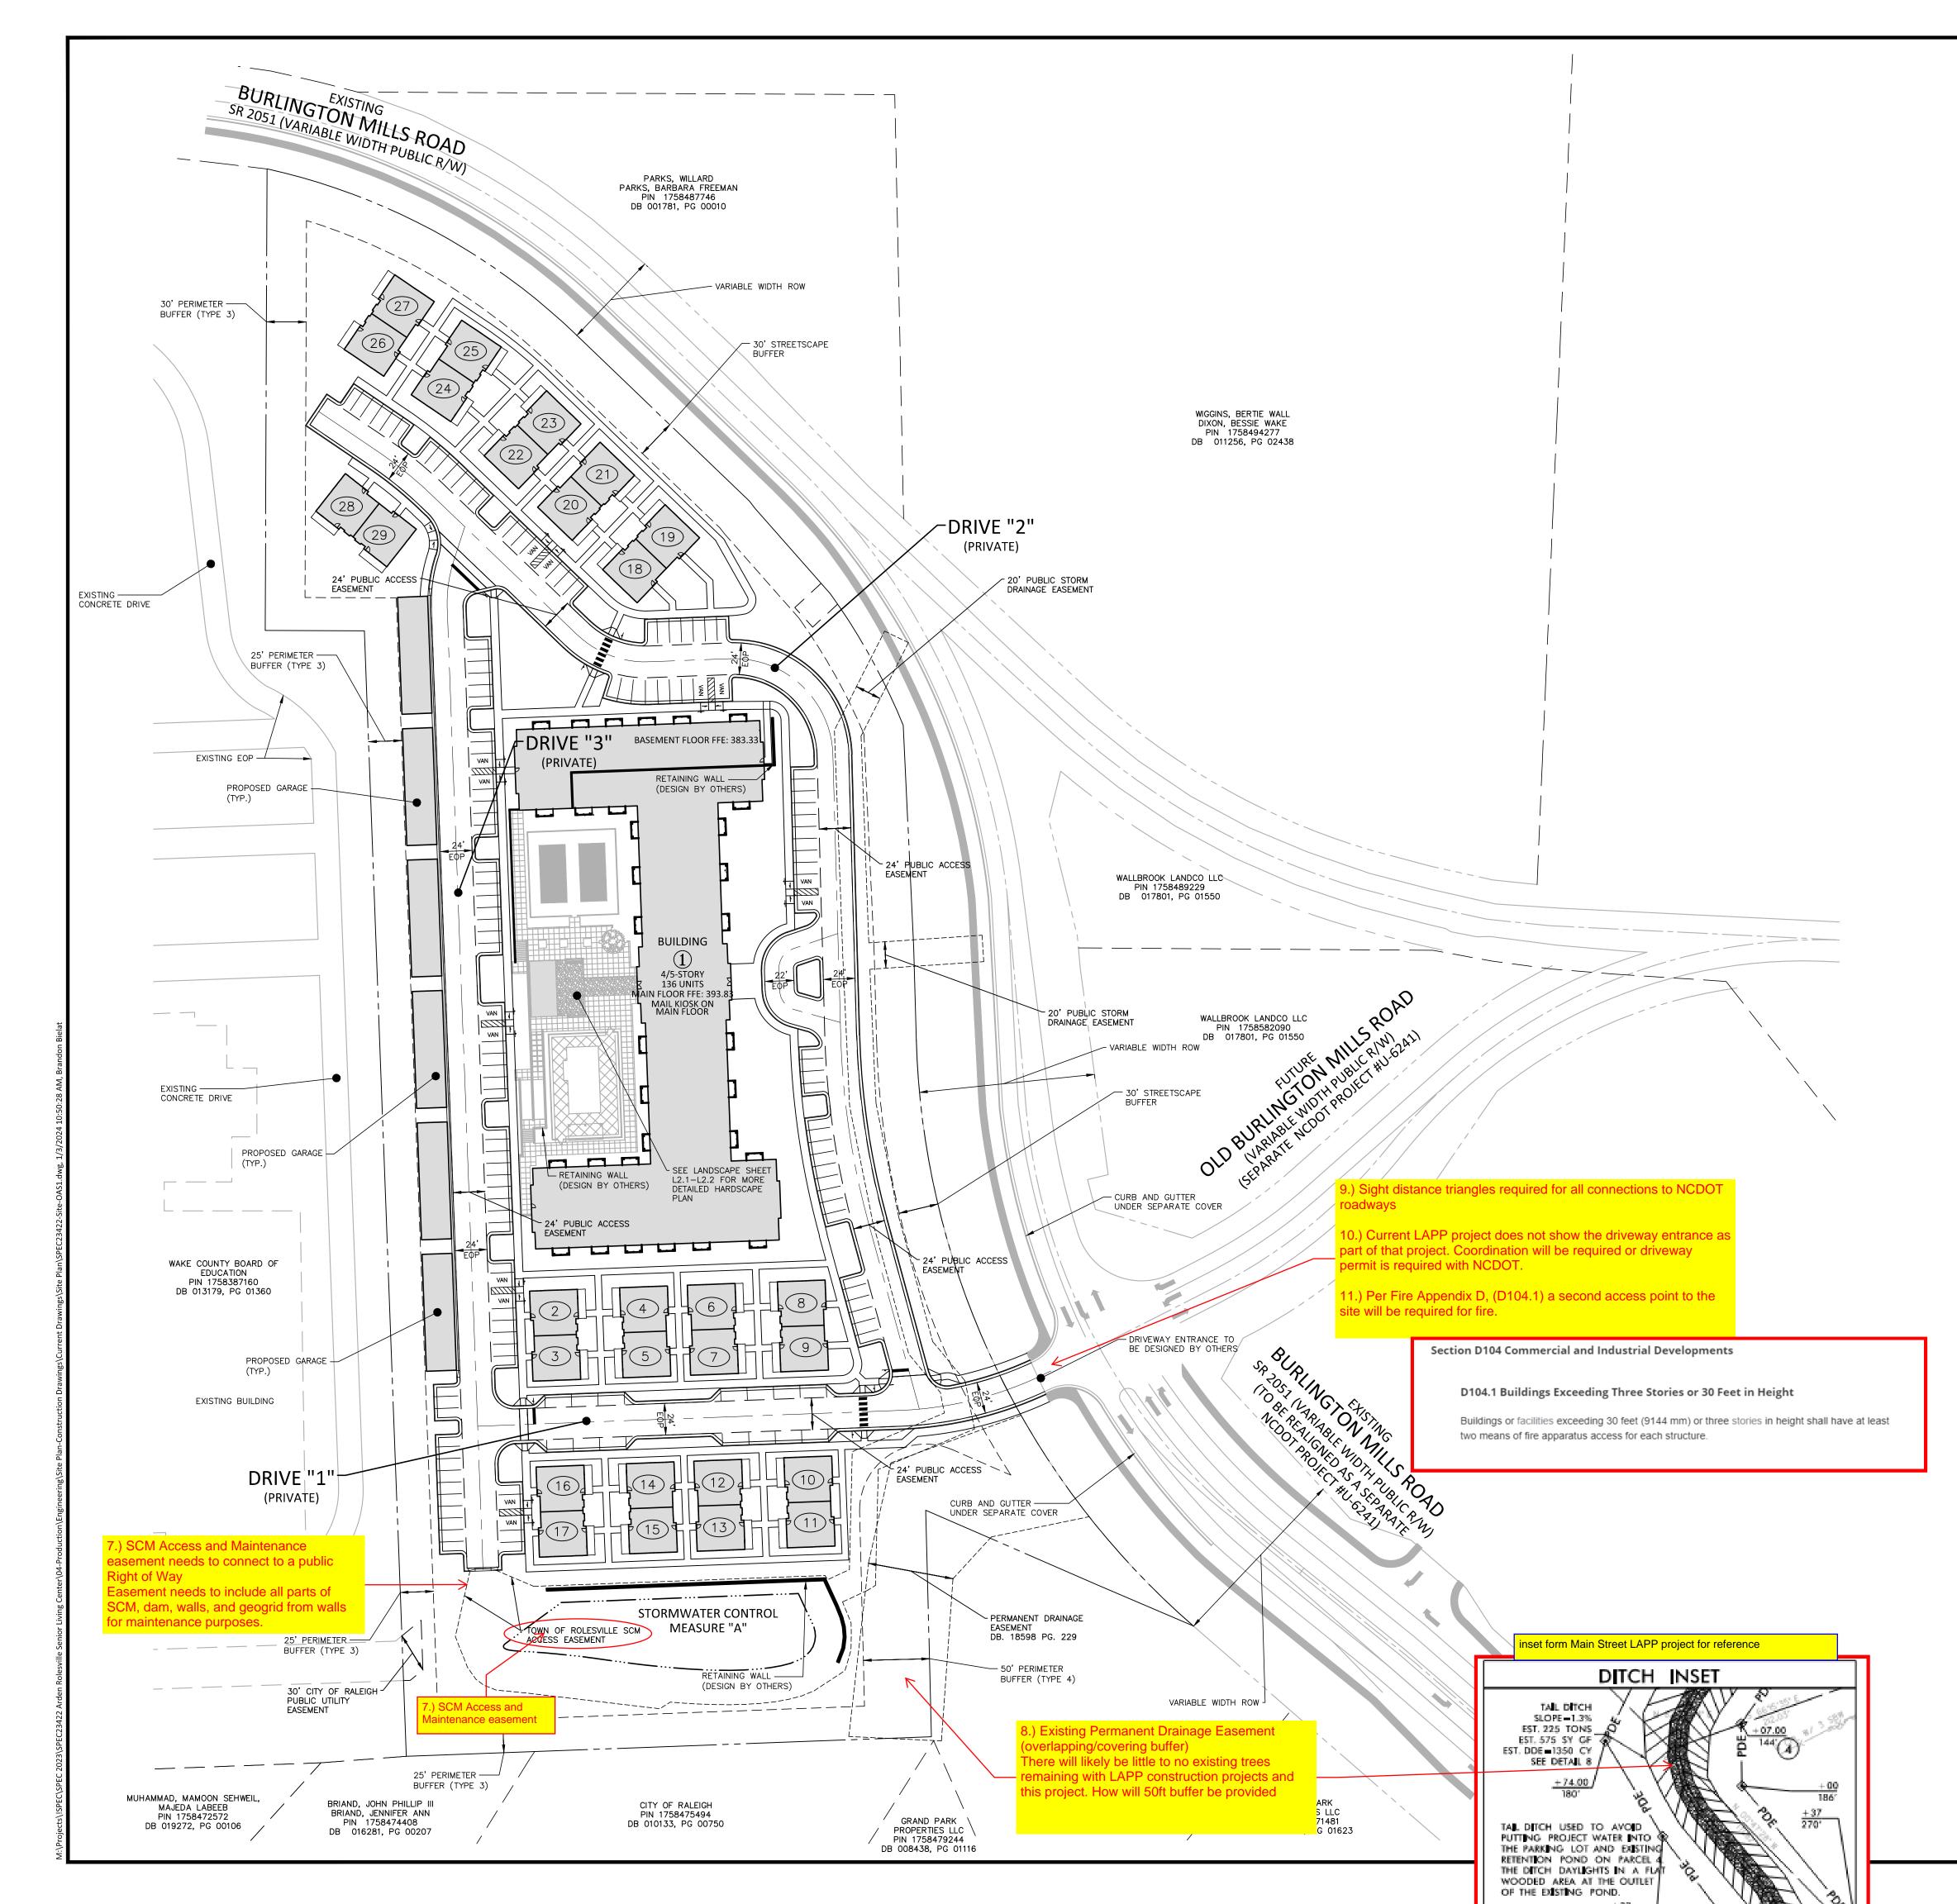

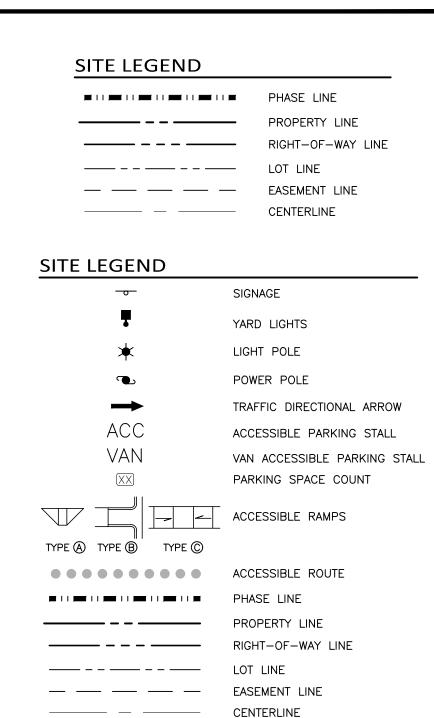

MCADAMS

The John R. McAdams Company, Inc. 621 Hillsborough Street Suite 500 Raleigh, NC 27603 phone 919. 361. 5000 fax 919. 361. 2269 license number: C-0293, C-187

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- 1. ALL CONSTRUCTION SHALL CONFORM TO THE LATEST TOWN OF ROLESVILLE AND/OR NCDOT STANDARDS AND SPECIFICATIONS AS APPLICABLE.
- 2. ALL DIMENSIONS SHOWN ON SITE PLAN ARE MEASURED TO BACK OF CURB UNLESS OTHERWISE NOTED.
- 3. CONTRACTOR SHALL MAINTAIN AN "AS-BUILT" SET OF DRAWINGS TO RECORD THE EXACT LOCATION OF ALL PIPING PRIOR TO CONCEALMENT. DRAWINGS SHALL BE GIVEN TO THE ENGINEER UPON COMPLETION OF THE PROJECT WITH A COPY OF THE TRANSMITTAL LETTER TO THE OWNER.
- EXISTING IMPROVEMENTS DAMAGED DURING CONSTRUCTION SHALL BE REPLACED/RESTORED TO THEIR ORIGINAL CONDITION AND TO THE SATISFACTION OF THE OWNER, BY THE CONTRACTOR RESPONSIBLE FOR THE DAMAGE.
- 5. THE CONTRACTOR SHALL NOTE THAT THE DRAWINGS MAY NOT SHOW EVERY OFFSET, TRANSITION, FITTING, ETC. THAT MAY BE REQUIRED. THE CONTRACTOR SHALL INSTALL SUCH STANDARD APPURTENANCES AS REQUIRED TO CLOSELY FOLLOW THE GRADES AND ALIGNMENTS DEPICTED ON THE PLANS.
- 6. CONTRACTOR SHALL NOTIFY "NC811" (811) OR (1-800-632-4949) AT LEAST 3 FULL BUSINESS DAYS PRIOR TO BEGINNING CONSTRUCTION OR EXCAVATION TO HAVE EXISTING UTILITIES LOCATED. CONTRACTOR SHALL CONTACT ANY LOCAL UTILITIES THAT PROVIDE THEIR OWN LOCATOR SERVICES INDEPENDENT OF "NC811". REPORT ANY DISCREPANCIES TO THE ENGINEER IMMEDIATELY.
- 7. CONTRACTOR IS RESPONSIBLE FOR COORDINATING CONSTRUCTION ACTIVITIES WITH THE APPROPRIATE UTILITY COMPANIES FOR ANY REQUIRED RELOCATIONS (I.E. POWER POLES, TELEPHONE PEDESTALS, WATER METERS, ETC.).
- 8. ALL DIMENSIONS AND GRADES SHOWN ON THE PLANS SHALL BE FIELD VERIFIED BY THE CONTRACTOR PRIOR TO CONSTRUCTION. CONTRACTOR SHALL NOTIFY THE ENGINEER IF ANY DISCREPANCIES EXIST PRIOR TO PROCEEDING WITH CONSTRUCTION, FOR NECESSARY PLAN OR GRADE CHANGES. NO EXTRA COMPENSATION SHALL BE PAID TO CONTRACTOR FOR ANY WORK DONE DUE TO DIMENSIONS OR GRADES SHOWN INCORRECTLY ON THESE PLANS IF SUCH NOTIFICATION HAS NOT BEEN GIVEN.
- 9. ACCESSIBLE RAMPS SHALL BE CONSTRUCTED IN ACCORDANCE WITH NCDOT DETAILS.
- 10. ALL SIDEWALKS THAT CONNECT TO THE PUBLIC RIGHT-OF-WAY MUST BE ACCESSIBLE TO PERSONS WHO ARE BLIND, HAVE LOW VISION AND PEOPLE WITH MOBILITY DISABILITIES. PEDESTRIAN EXISTING ROUTES AND ALTERNATE PEDESTRIAN ROUTES DURING CONSTRUCTION WILL BE REQUIRED TO BE COMPLIANT WITH THE PUBLIC RIGHTS OF WAY ACCESSIBILITY GUIDELINES (PROWAG), 2010 ADA STANDARDS FOR ACCESSIBLE DESIGN AND THE MANUAL ON UNIFORM TRAFFIC CONTROL DEVICES (MUTCD).
- 11. TYPICAL PAVEMENT SECTION DETAILS ARE SHOWN WITHIN THIS SET AND INTENDED TO BE A MINIMUM PAVEMENT SECTION REQUIREMENT. THE CURRENT GEOTECHNICAL REPORT SHALL OVER-RIDE ALL TYPICAL PAVEMENT SECTIONS SHOWN, IF THE GEOTECHNICAL ENGINEER DEEMS A HEAVIER SECTION IS REQUIRED.
- 12. EQUIPMENT AND PRODUCTS OTHER THAN THOSE SPECIFIED MAY BE USED PROVIDED APPROVAL HAS BEEN OBTAINED FROM THE OWNER IN WRITING PRIOR TO ORDERING OR INSTALLATION. THE CONTRACTOR SHALL WAIVE ANY CLAIM FOR ADDITIONAL COST RELATED TO SUBSTITUTION OF ALTERNATE EQUIPMENT.
- 13. ALL SIGNAGE ASSOCIATED WITH THE PUBLIC STREET SYSTEM SHALL ADHERE TO MUTCD STANDARDS AND SPECIFICATIONS.

12.) Add Demolition Plan in V2 if any is proposed.

13.) Add zoning districts so we can confirm adjacent buffer requirements.

- 14.) Add required setbacks.
- 15.) Add square footages for each building either on overall sheet or enlarged sheets.

16.) How is Trash being handled? No dumpsters are shown on proposed plan. Add or clarify how trash/recycle collection is to be handled.

17.) Provide fire truck route exhibit to verify radii for access, 26ft driveway along route to get around Building 4/5 story.

18.) Provide dumpster route and vehicle turning exhibit to verify radii for access.

19.) Will there be any delivery truck (loading and unloading areas)?



GRAPHIC SCALE

PRELIMINARY DRAWING - NOT RELEASED FOR CONSTRUCTION





REVISIONS


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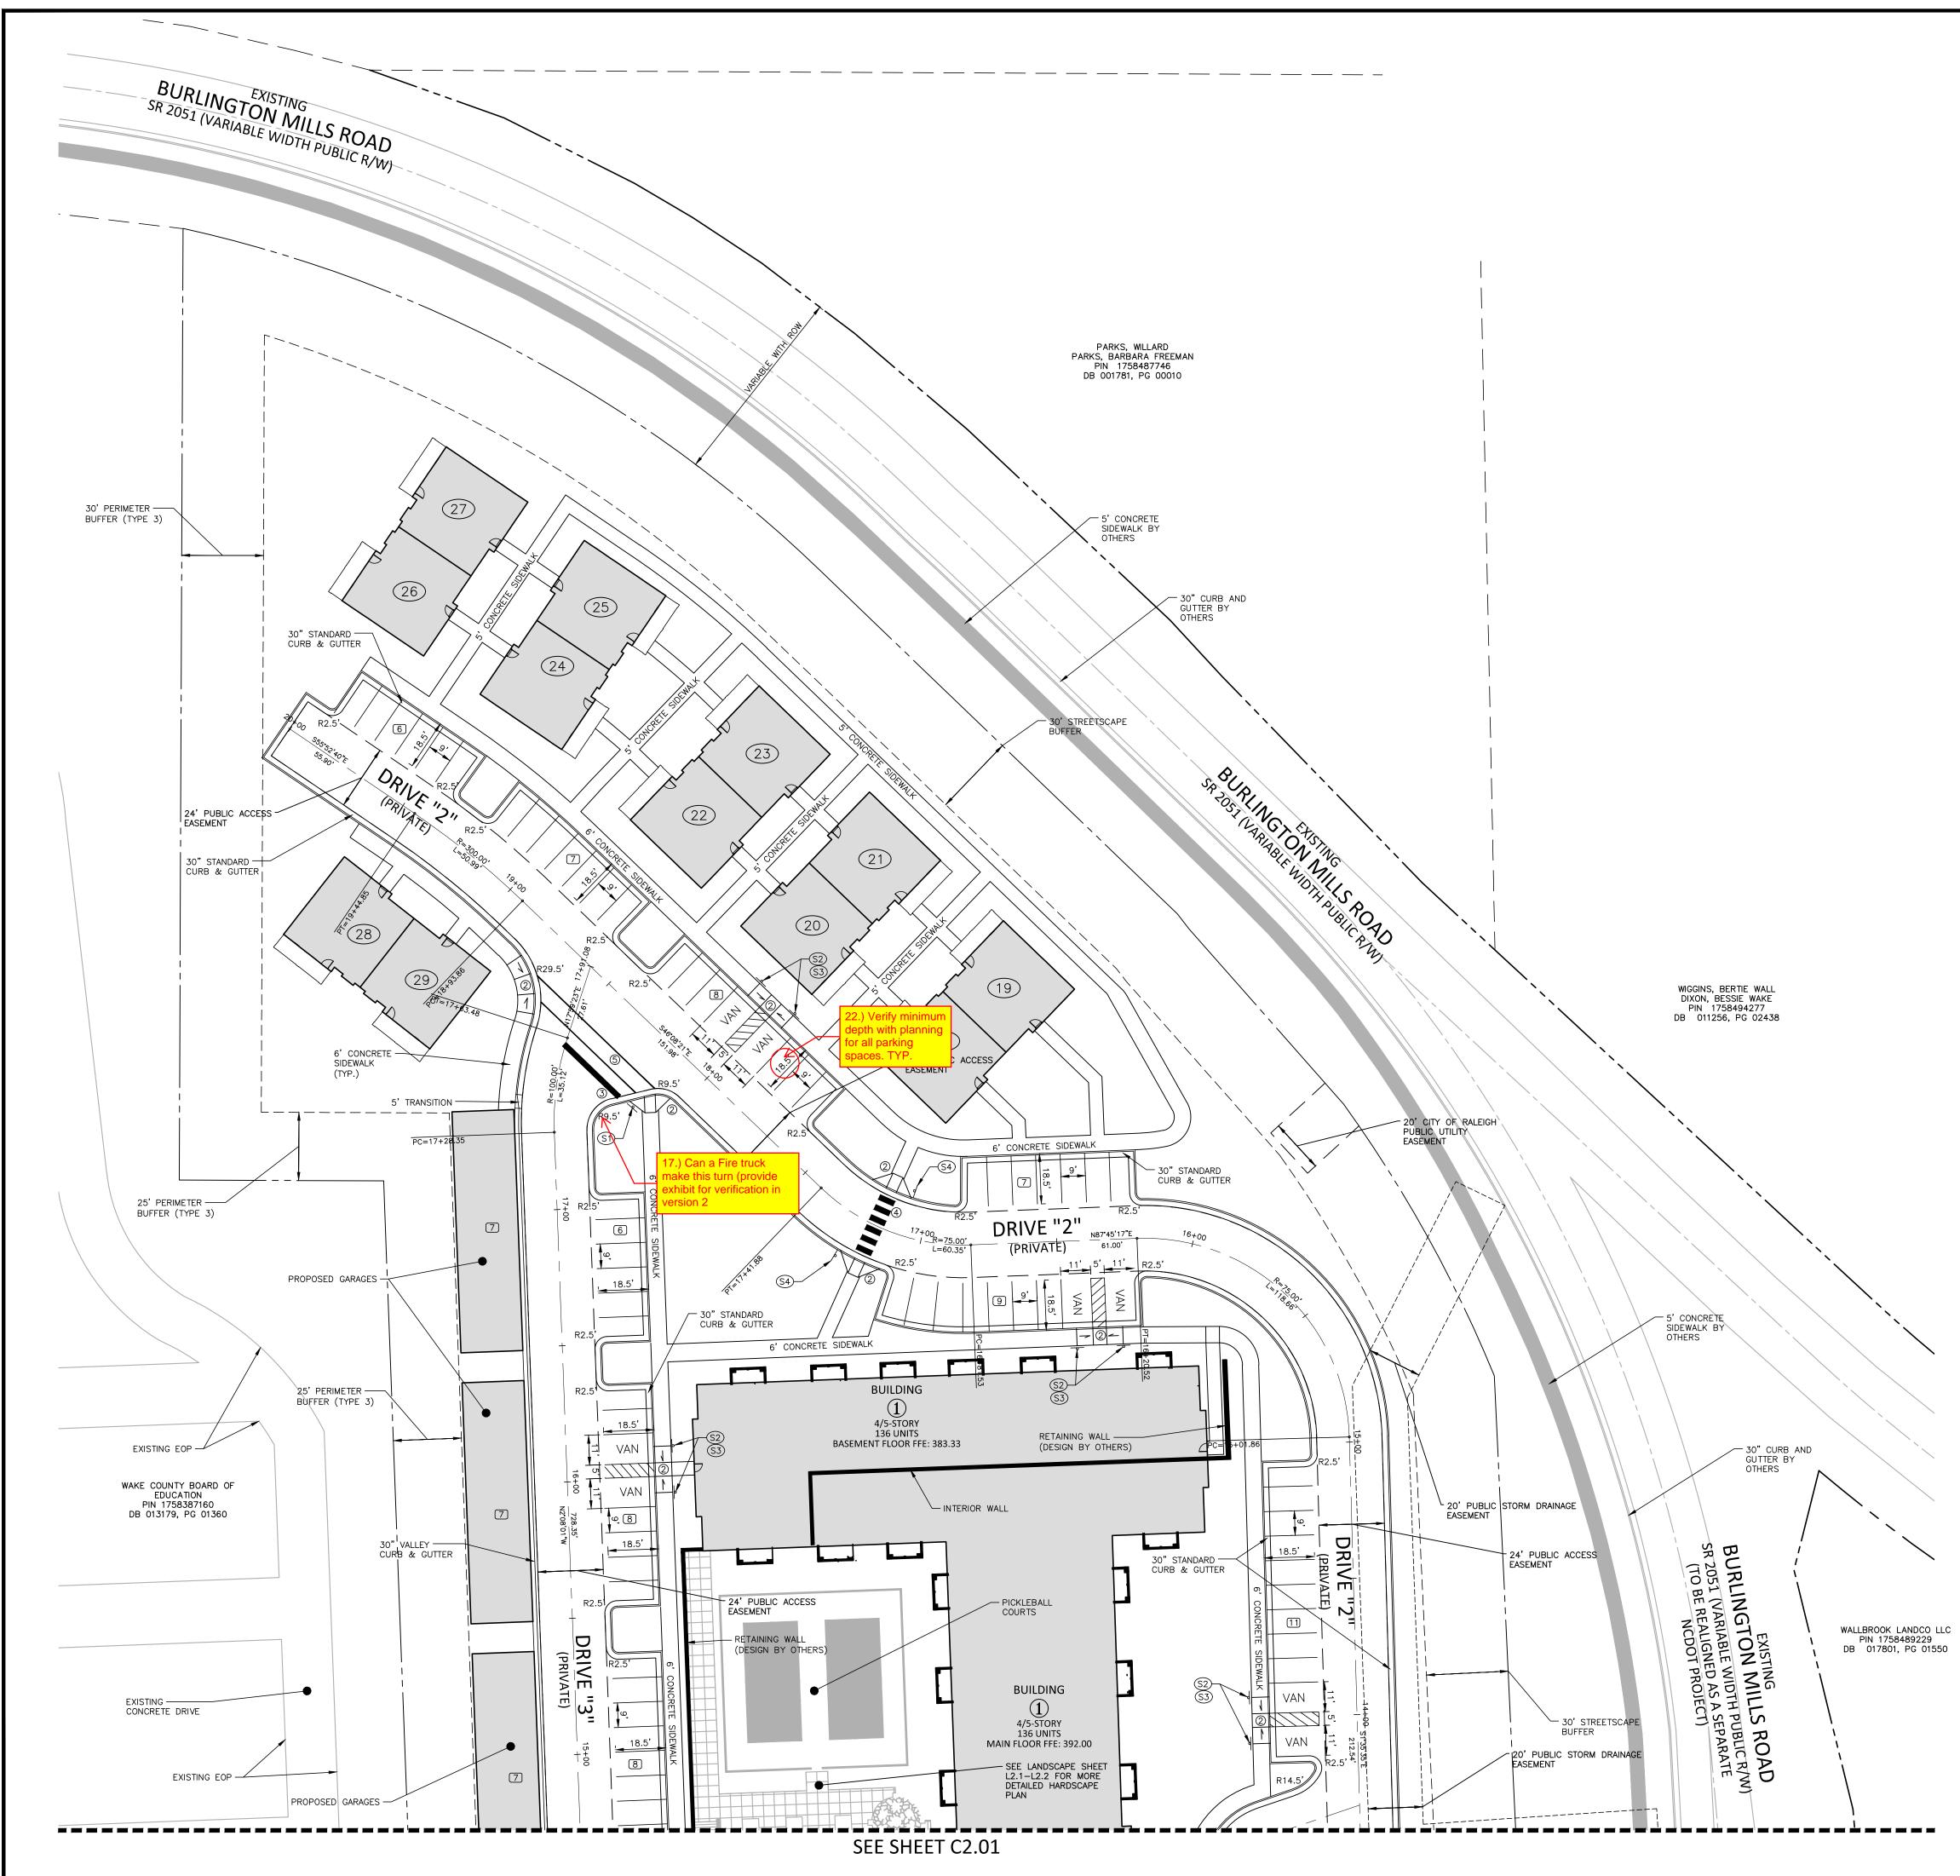
PLAN INFORMATION

PROJECT NO.	SPEC-23422
FILENAME	SPEC23422-SITE-OAS1
CHECKED BY	WTO
DRAWN BY	JMS
SCALE	1"=60'
DATE	01. 03. 2024
SHEET	








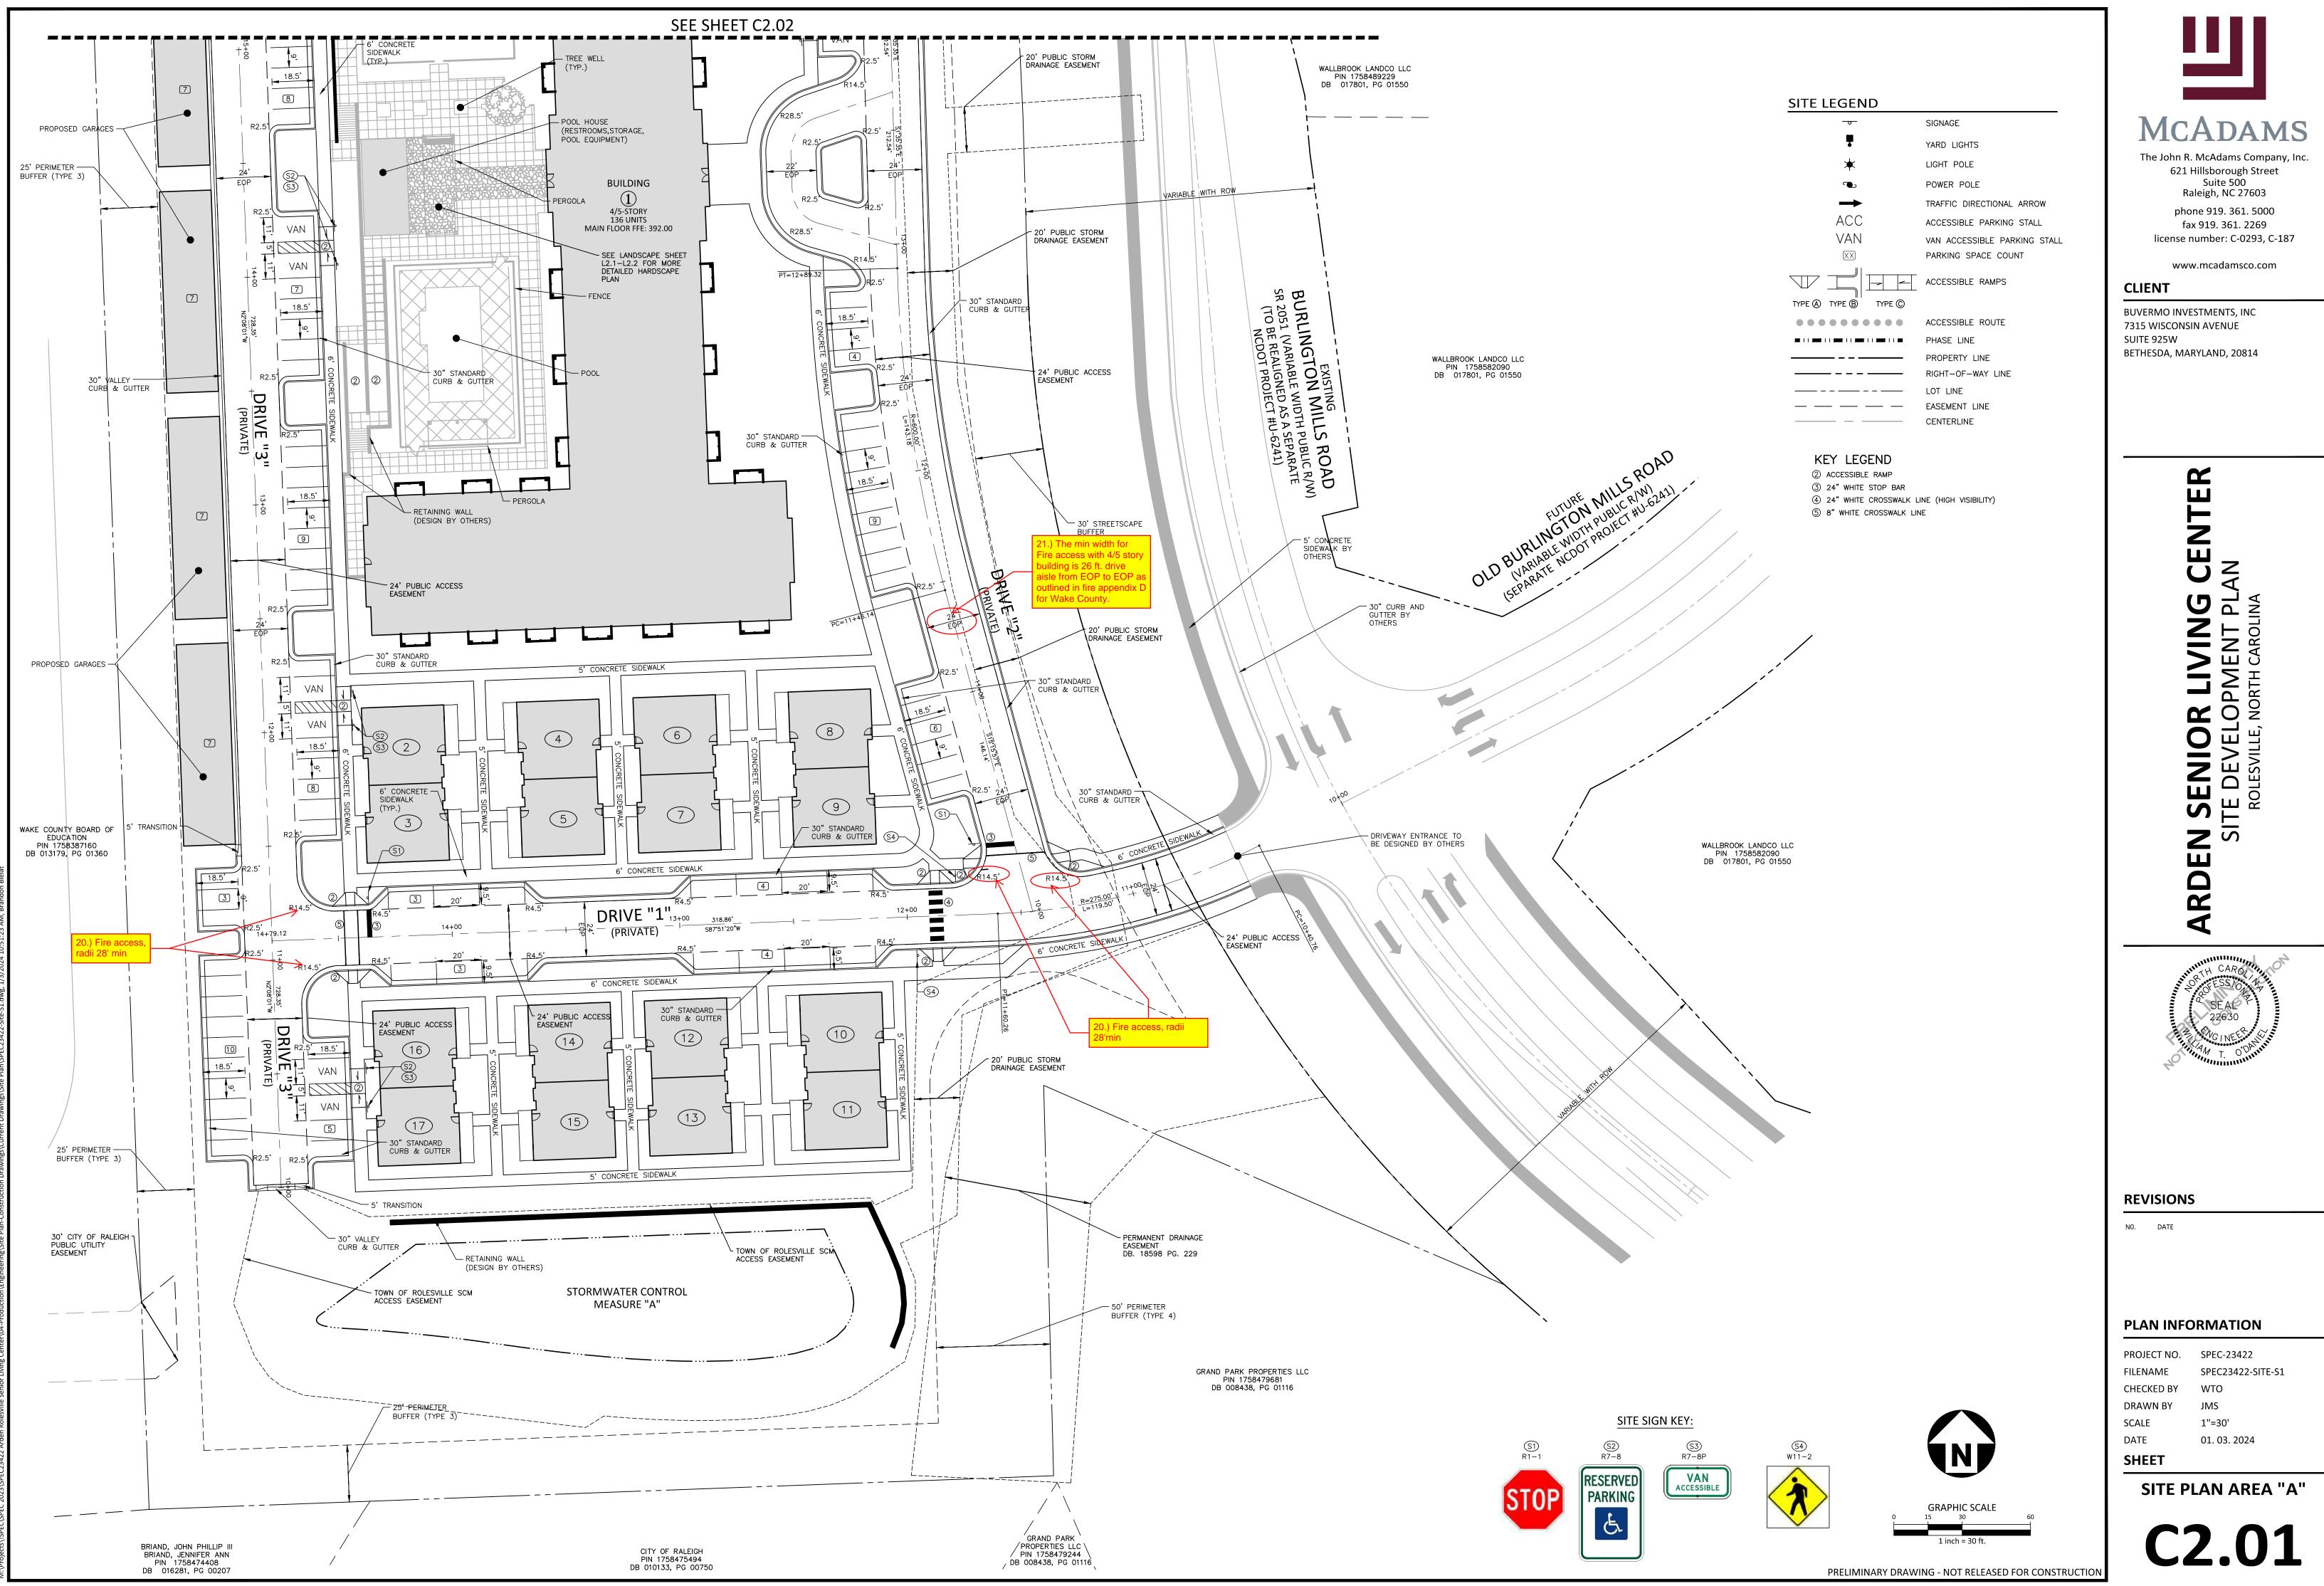

ects\!SPEC\SPEC 2023\SPEC23422 Arden Rolesville Senior Living Center\04-Production\Engineering\Site Plan-Construction Drawings\Current Drawings\Site Plan\SPEC23422-Site-S1.dwg, 1/3/2024 10:51:40 AM, Bran

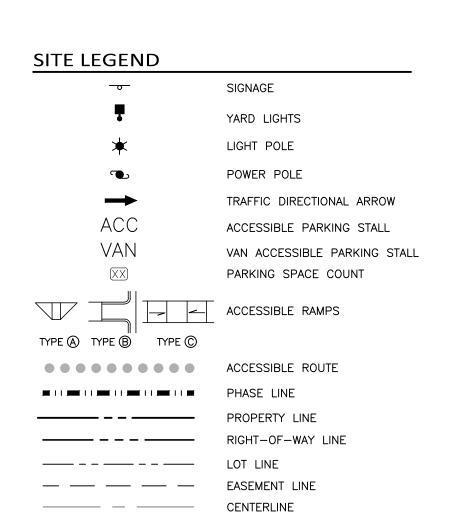

KEY LEGEND

② ACCESSIBLE RAMP③ 24" WHITE STOP BAR

4 24" WHITE CROSSWALK LINE (HIGH VISIBILITY)

(5) 8" WHITE CROSSWALK LINE





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BUVERMO INVESTMENTS, INC 7315 WISCONSIN AVENUE SUITE 925W BETHESDA, MARYLAND, 20814





REVISIONS

NO. DATE

PLAN INFORMATION


SHEET	
DATE	01. 03. 2024
SCALE	1"=30'
DRAWN BY	JMS
CHECKED BY	WTO
FILENAME	SPEC23422-SITE-S1
PROJECT NO.	SPEC-23422

SITE PLAN AREA "B"





GRAPHIC SCALE

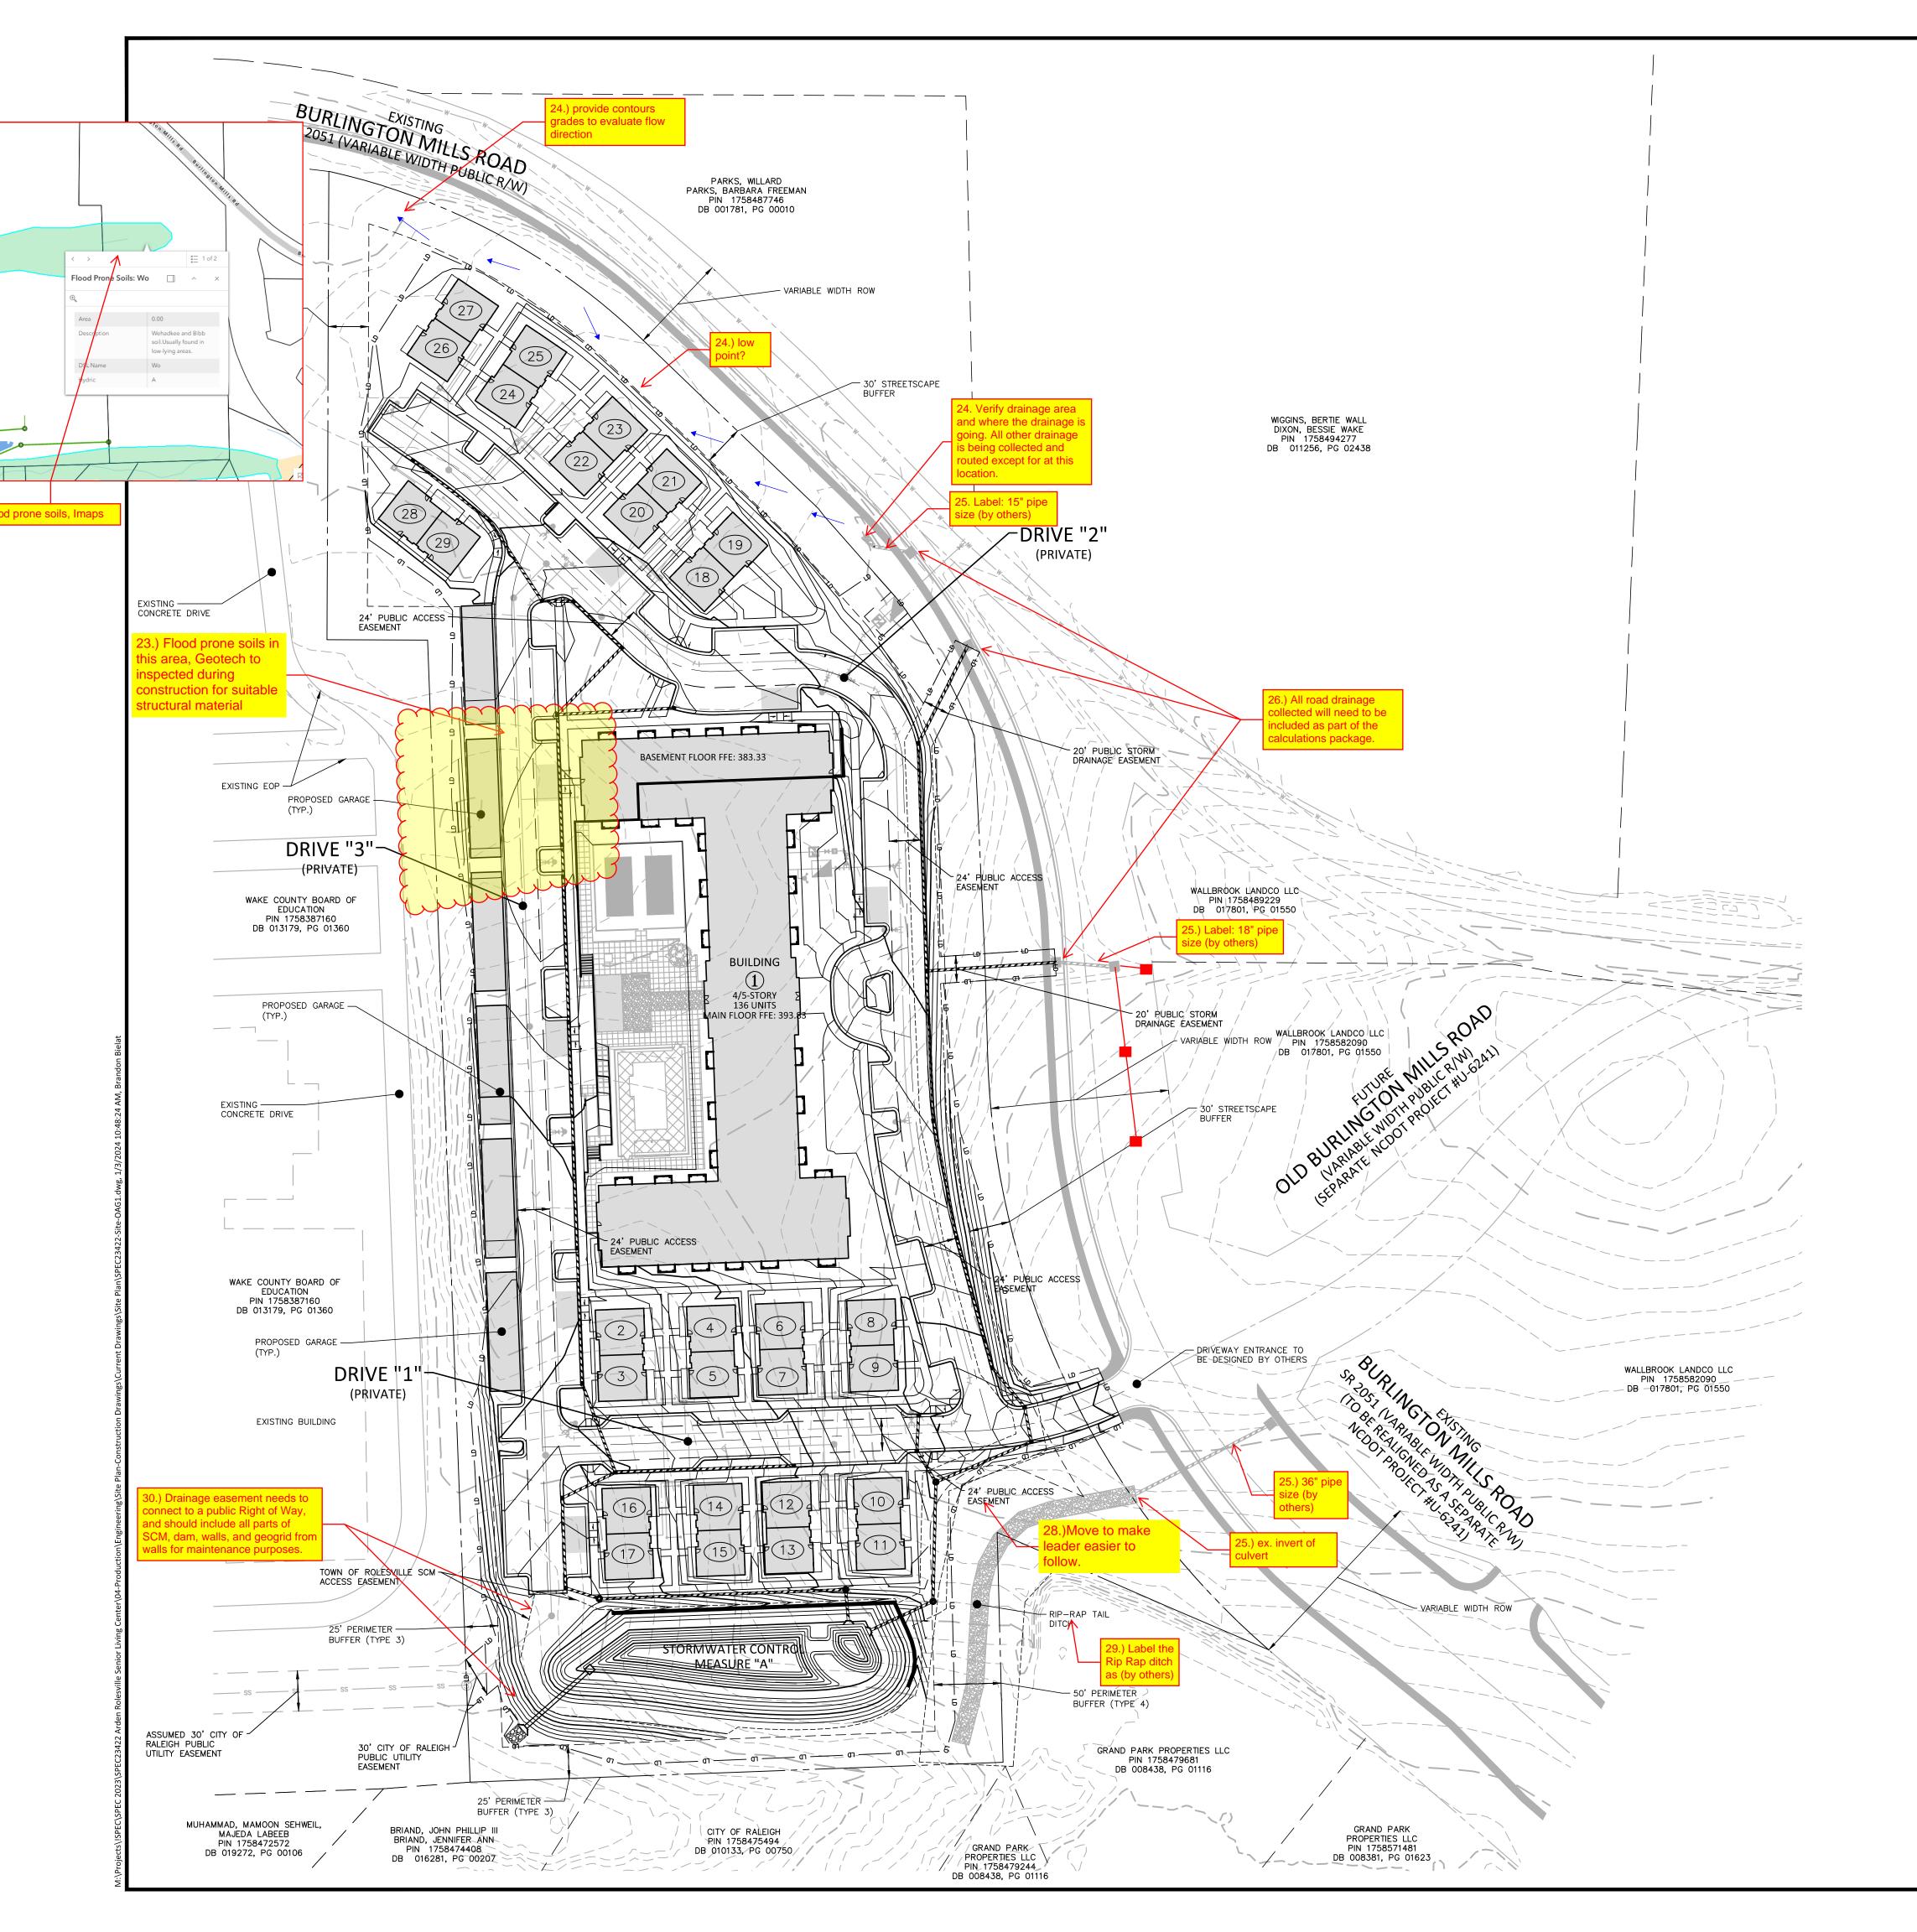

GRADING LEGEND	
	FLARED END SECTION
(ENDWALL SECTION
	CATCH BASIN
	DROP INLET
•	STORM SERVICE INLET
•	STORM SERVICE ROOF-DRAIN
0	JUNCTION BOX
-~-	DRAINAGE FLOW ARROW
\sim	LINE BREAK SYMBOL
<u>250.50</u> 250.00	TOP & BOTTOM CURB ELEVATIONS
<u>TW=223.00</u> BW=213.00	- TOP OF WALL ELEVATION - BOTTOM OF WALL ELEVATION (NOTE: BOTTOM OF WALL IS GROUND ELEVATION NOT WALL FOUNDATION)
+ 250.60	SPOT ELEVATION
,,,,,,,,,,,,,,,,,,,,,,,,,,,,,,,,,,,,,	STORM DRAINAGE
· · · · · ·	STORM SERVICE LINE
RD RD	ROOF DRAIN, 8" ADS NON—PERFORATED TUBING OR EQUAL 1.0% MIN. SLOPE 3' MIN. COVER PVC SCHEDULE 40 IN TRAFFIC AREAS
TP TP	TREE PROTECTION FENCE
LD LD	LIMITS OF DISTURBANCE
	WOODED AREA
250	MAJOR CONTOUR
252	MINOR CONTOUR
250	EXISTING MAJOR CONTOUR
252	EXISTING MINOR CONTOUR
	EASEMENT LINE
	ACCESSIBLE PARKING AREA (2% MAX. SLOPE IN ALL DIRECTIONS)

General Note: Not able to complete review with out information on storm drainage Provide table/chart or provide labels in sheet with design info.




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REVISIONS

NO. DATE


PLAN INFORMATION

SHEET	
DATE	01. 03. 2024
SCALE	1"=60'
DRAWN BY	JMS
CHECKED BY	WTO
FILENAME	SPEC23422-SITE-OAG1
PROJECT NO.	SPEC-23422



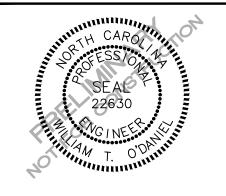

GRAPHIC SCAL

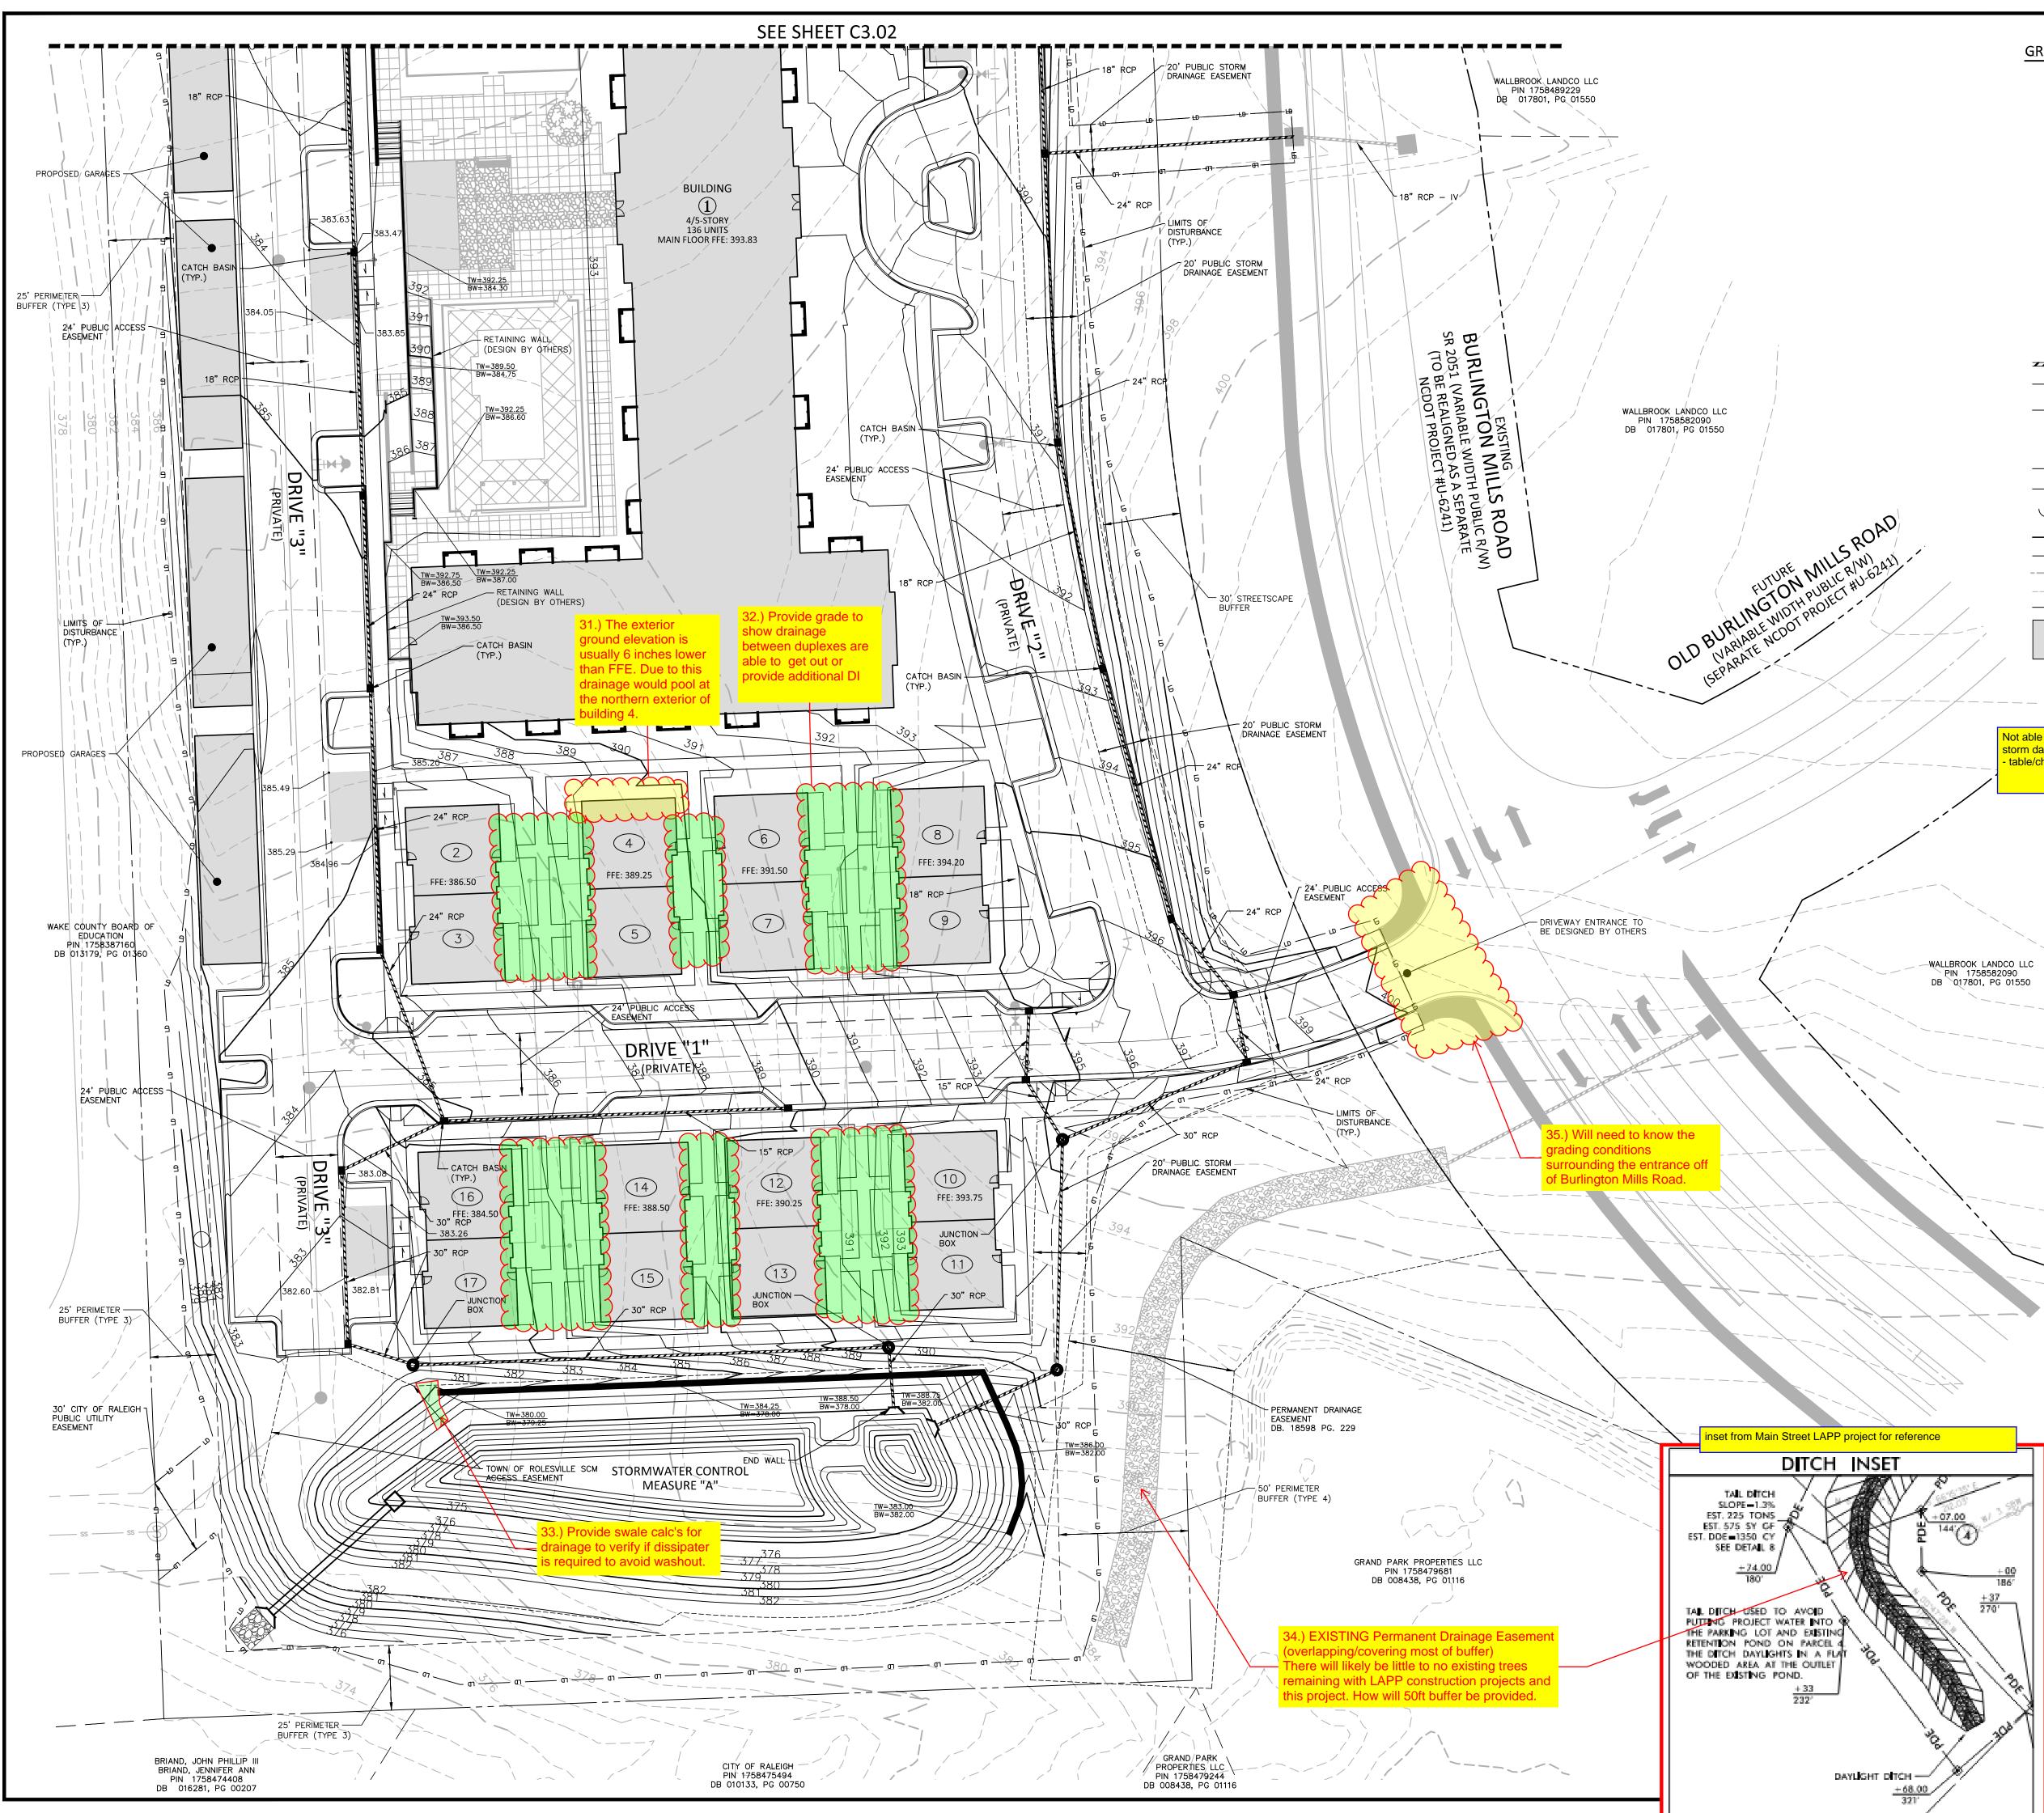

GRADING LEGEND	
	FLARED END SECTION
ſ	ENDWALL SECTION
	CATCH BASIN
	DROP INLET
•	STORM SERVICE INLET
٠	STORM SERVICE ROOF-DRAIN
0	JUNCTION BOX
~~~	DRAINAGE FLOW ARROW
$\sim$	LINE BREAK SYMBOL
<u>250.50</u> 250.00	TOP & BOTTOM CURB ELEVATIONS
TW=223.00 BW=213.00	TOP OF WALL ELEVATION BOTTOM OF WALL ELEVATION (NOTE: BOTTOM OF WALL IS GROUND ELEVATION NOT WALL FOUNDATION)
+ 250.60	SPOT ELEVATION
	STORM DRAINAGE
<u></u> <u></u>	STORM SERVICE LINE
RD RD	ROOF DRAIN, 8" ADS NON-PERFORATED TUBING OR EQUAL 1.0% MIN. SLOPE 3' MIN. COVER PVC SCHEDULE 40 IN TRAFFIC AREAS
—— TP —— TP —— TP ——	TREE PROTECTION FENCE
LD LD	LIMITS OF DISTURBANCE
	WOODED AREA
250	MAJOR CONTOUR
252	MINOR CONTOUR
250	EXISTING MAJOR CONTOUR
252	EXISTING MINOR CONTOUR
	EASEMENT LINE
	ACCESSIBLE PARKING AREA (2% MAX. SLOPE IN ALL DIRECTIONS)

Not able to complete review with out information on storm drainage storm data for reference - table/chart or provide labels in sheet with design info




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#### CLIENT

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> **CENTER** AN DNIVID Δ Ż MENT I NORTH Δ SENIOR 0 TE DEVEL ROLESVILLE, ____ S Ζ RDE 4



#### REVISIONS


NO. DATE
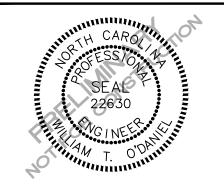
### PLAN INFORMATION

SHEET	
DATE	01. 03. 2024
SCALE	1"=30'
DRAWN BY	JMS
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FILENAME	SPEC23422-SITE-G1
PROJECT NO.	SPEC-23422

**GRADING AND STORM** DRAINAGE PLAN - AREA "A" **C3.01** 



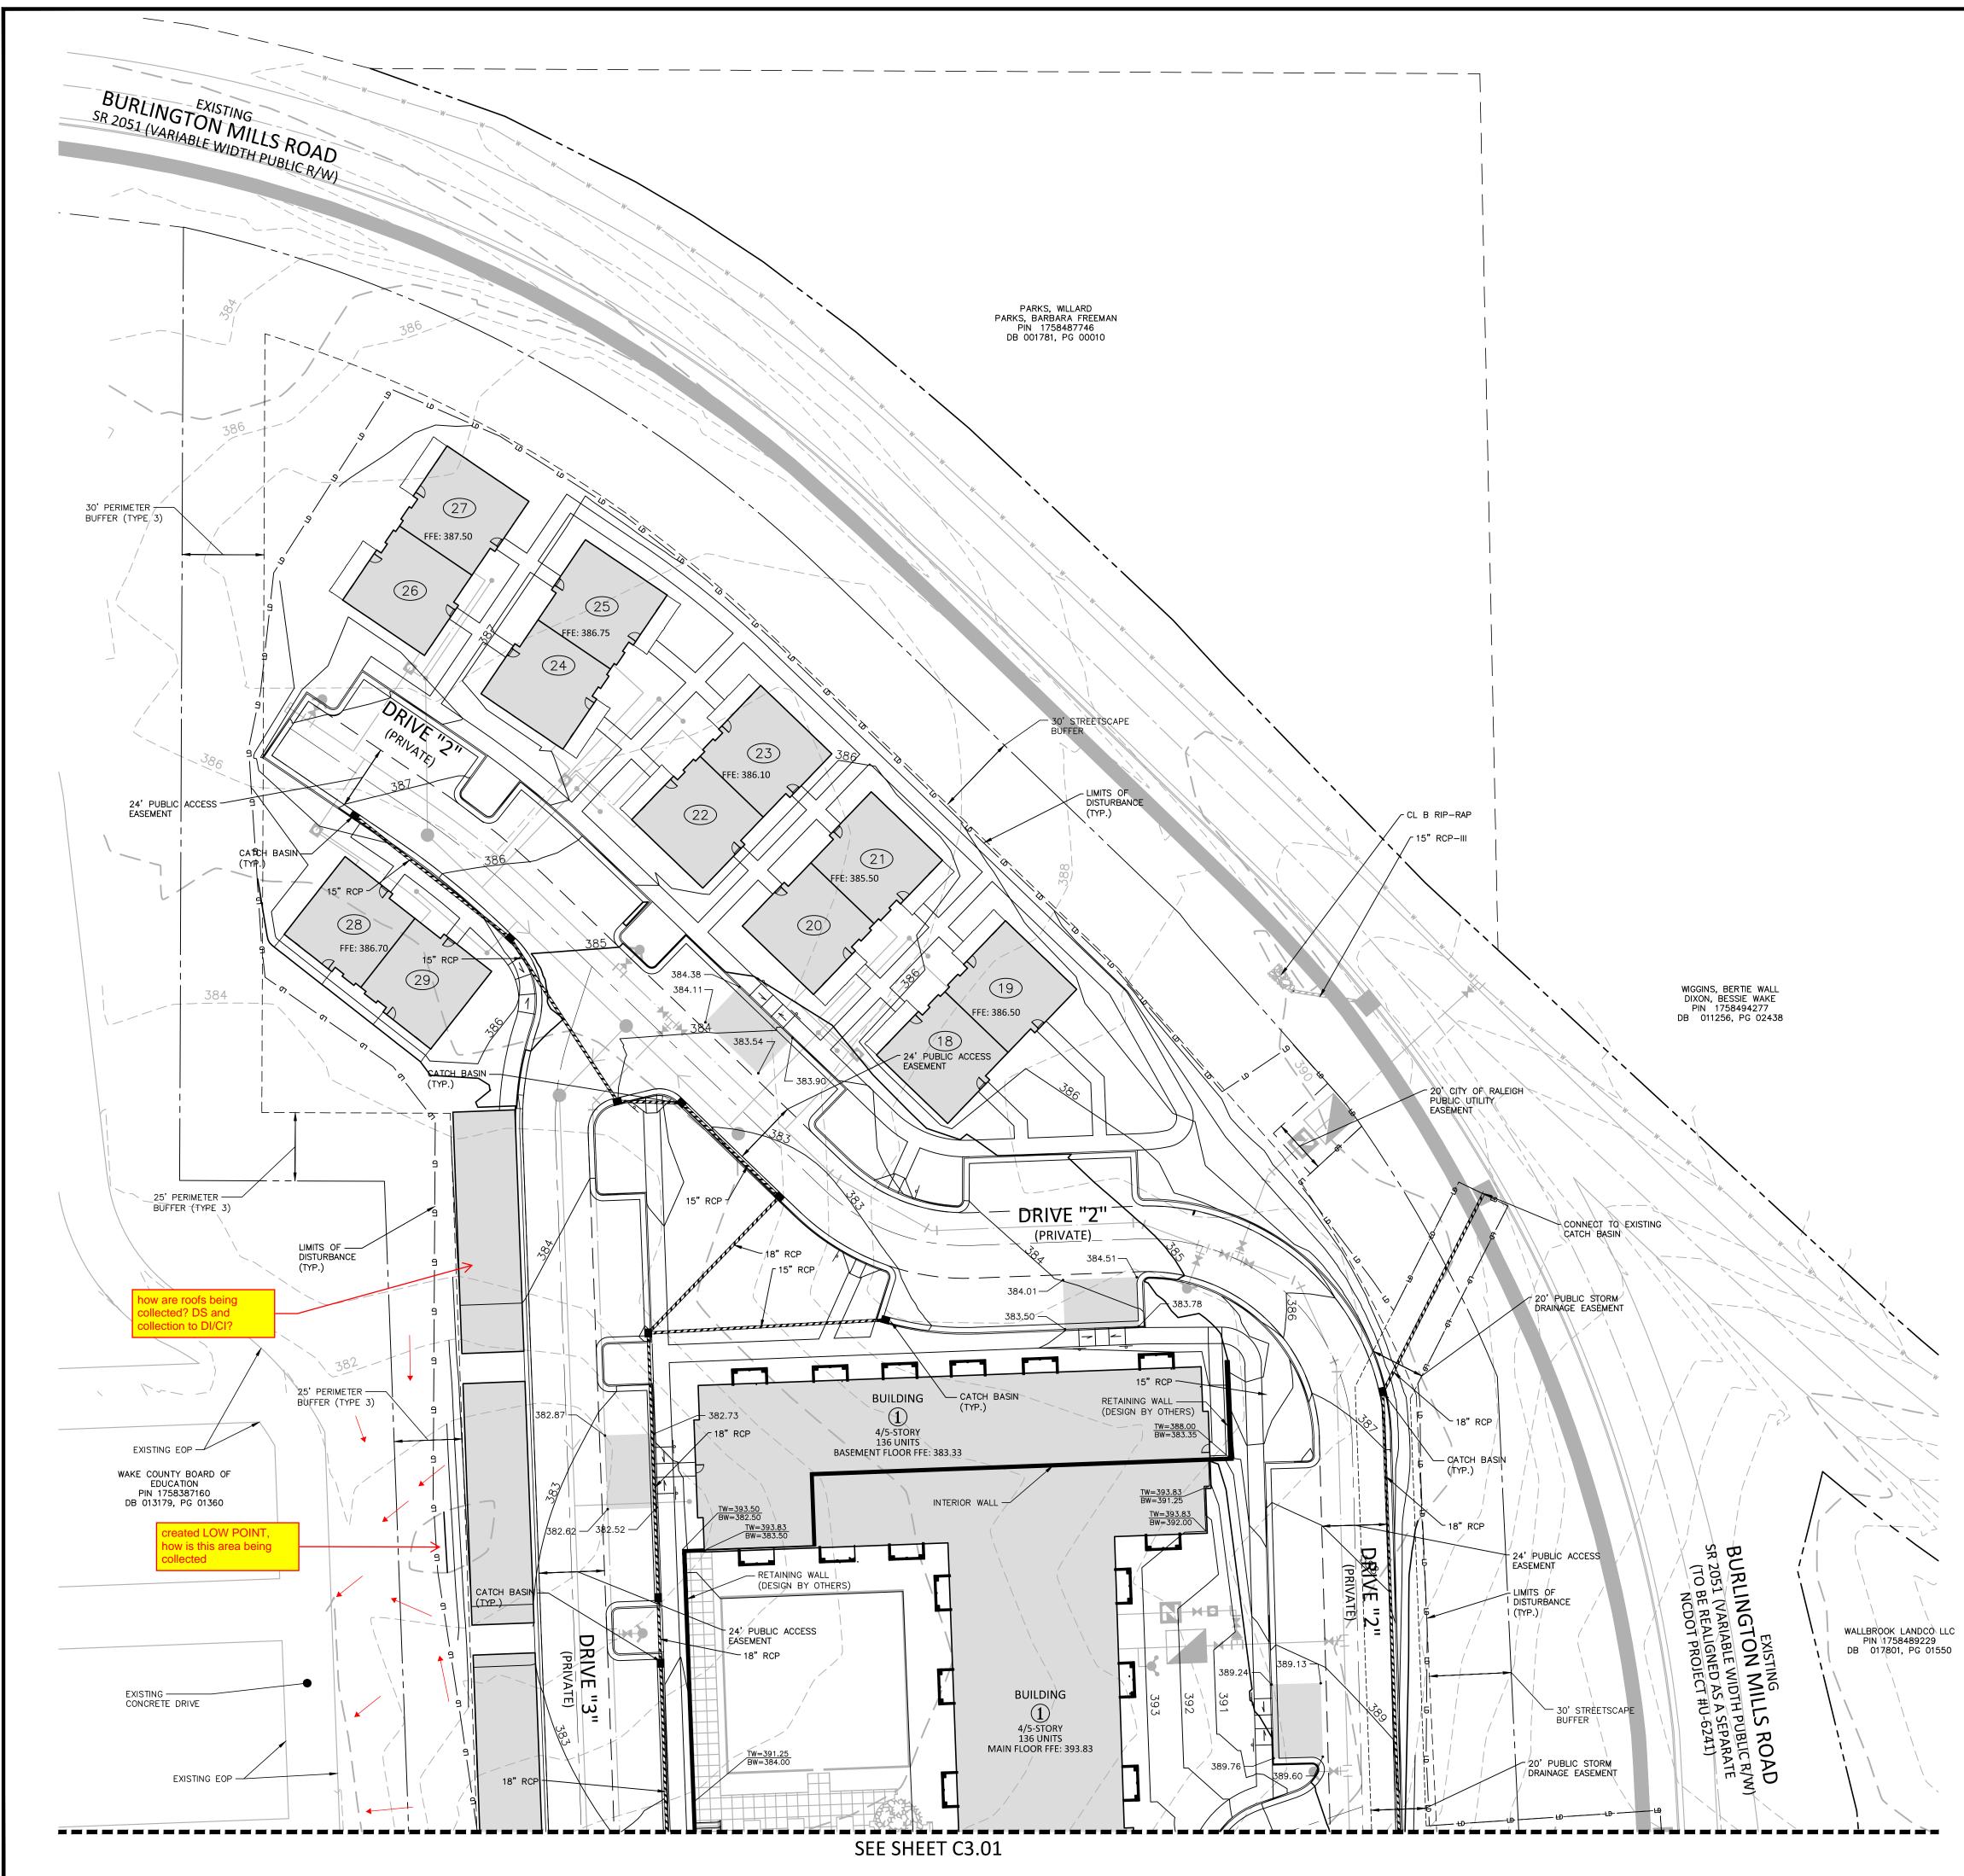

rojects\SPECSPEC 2023\SPEC23422 Arden Rolesville Senior Living Center\04-Production\Engineering\Site Plan-Construction Drawings\Current Drawings\Site Plan\SPEC23422-Site-G1.dwg, 1/3/2024 10:53:56 AM, Brandon Biel

GRADING LEGEND	
	FLARED END SECTION
(	ENDWALL SECTION
	CATCH BASIN
	DROP INLET
•	STORM SERVICE INLET
•	STORM SERVICE ROOF-DRAIN
0	JUNCTION BOX
-~-	DRAINAGE FLOW ARROW
$\sim$	LINE BREAK SYMBOL
<u>250.50</u> 250.00	TOP & BOTTOM CURB ELEVATIONS
<u>TW=223.00</u> BW=213.00	- TOP OF WALL ELEVATION - BOTTOM OF WALL ELEVATION (NOTE: BOTTOM OF WALL IS GROUND ELEVATION NOT WALL FOUNDATION)
+ 250.60	SPOT ELEVATION
	STORM DRAINAGE
······	STORM SERVICE LINE
RD RD	ROOF DRAIN, 8" ADS NON-PERFORATED TUBING OR EQUAL 1.0% MIN. SLOPE 3' MIN. COVER PVC SCHEDULE 40 IN TRAFFIC AREAS
TP TP	TREE PROTECTION FENCE
LD LD	LIMITS OF DISTURBANCE
	WOODED AREA
250	MAJOR CONTOUR
252	MINOR CONTOUR
250	EXISTING MAJOR CONTOUR
252	EXISTING MINOR CONTOUR
	EASEMENT LINE
	ACCESSIBLE PARKING AREA (2% MAX. SLOPE IN ALL DIRECTIONS)



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BUVERMO INVESTMENTS, INC 7315 WISCONSIN AVENUE SUITE 925W BETHESDA, MARYLAND, 20814





#### REVISIONS

NO. DATE


### PLAN INFORMATION

PROJECT NO.	SPEC-23422
FILENAME	SPEC23422-SITE-G1
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DRAWN BY	JMS
SCALE	1"=30'
DATE	01. 03. 2024
SHEET	





GRAPHIC SCALE

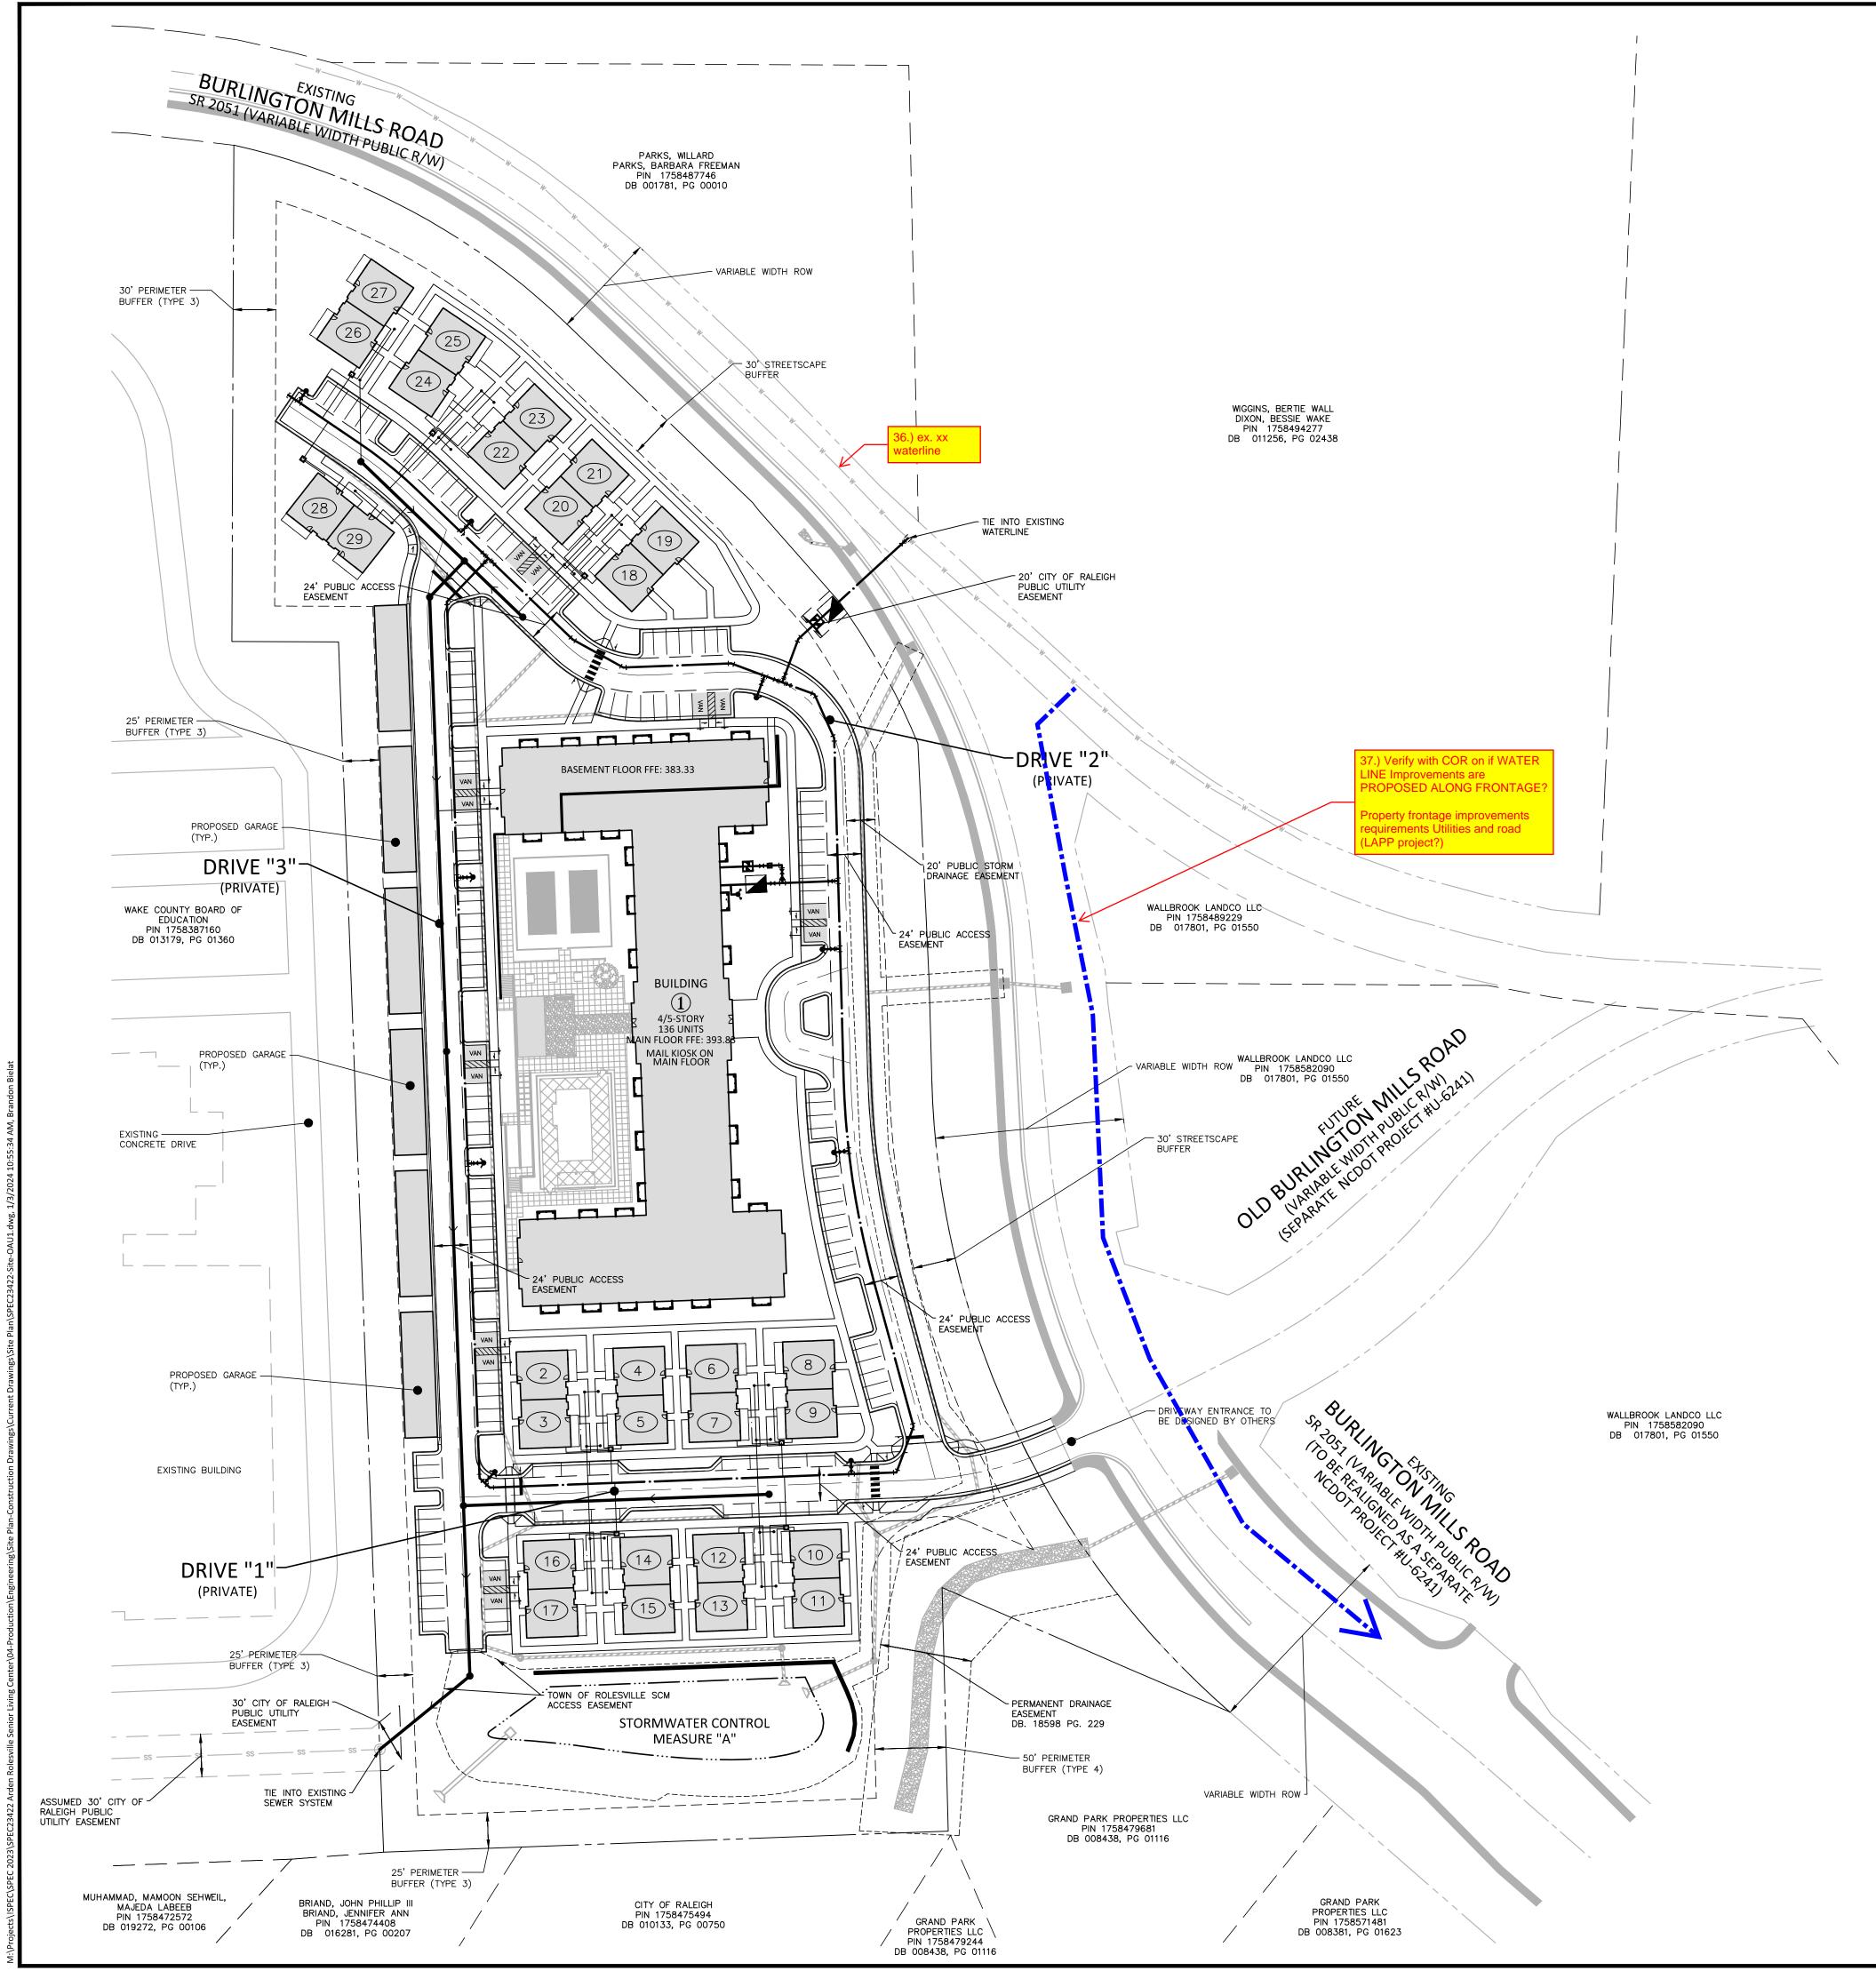

# MCADAMS


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NO. DATE

### PLAN INFORMATION

PROJECT NO.	SPEC-23422
FILENAME	SPEC23422-SITE-OAU1
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SCALE	1"=60'
DATE	01. 03. 2024
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**OVERALL UTILITY PLAN** 



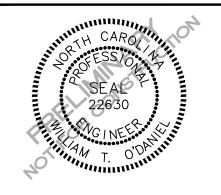

**RAPHIC SCA** 

PRELIMINARY DRAWING - NOT RELEASED FOR CONSTRUCTION

- WATER SERVICE LINE
- ------ OU------ OVERHEAD UTILITY -----T----T-----TELEPHONE

UTILITY LEGEND

 $\rightarrow \rightarrow \rightarrow$ 

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• •

GREASE TRAP SEWER FLOW DIRECTION ARROW YARD LIGHTS LIGHT POLE POWER POLE LINE BREAK SYMBOL WATERLINE SANITARY SEWER ------ SEWER SERVICE LINE ------ FM------- SEWER FORCE MAIN

FIRE HYDRANT ASSEMBLY

POST INDICATOR VALVE

BACKFLOW PREVENTER

BLOW-OFF ASSEMBLY

SEWER CLEAN-OUT

SANITARY SEWER MANHOLE

VALVE IN MANHOLE METER & VAULT

(FDC)


WATER METER WATER VALVE

REDUCER

PLUG

FIRE DEPARTMENT CONNECTION

----- EASEMENT LINE

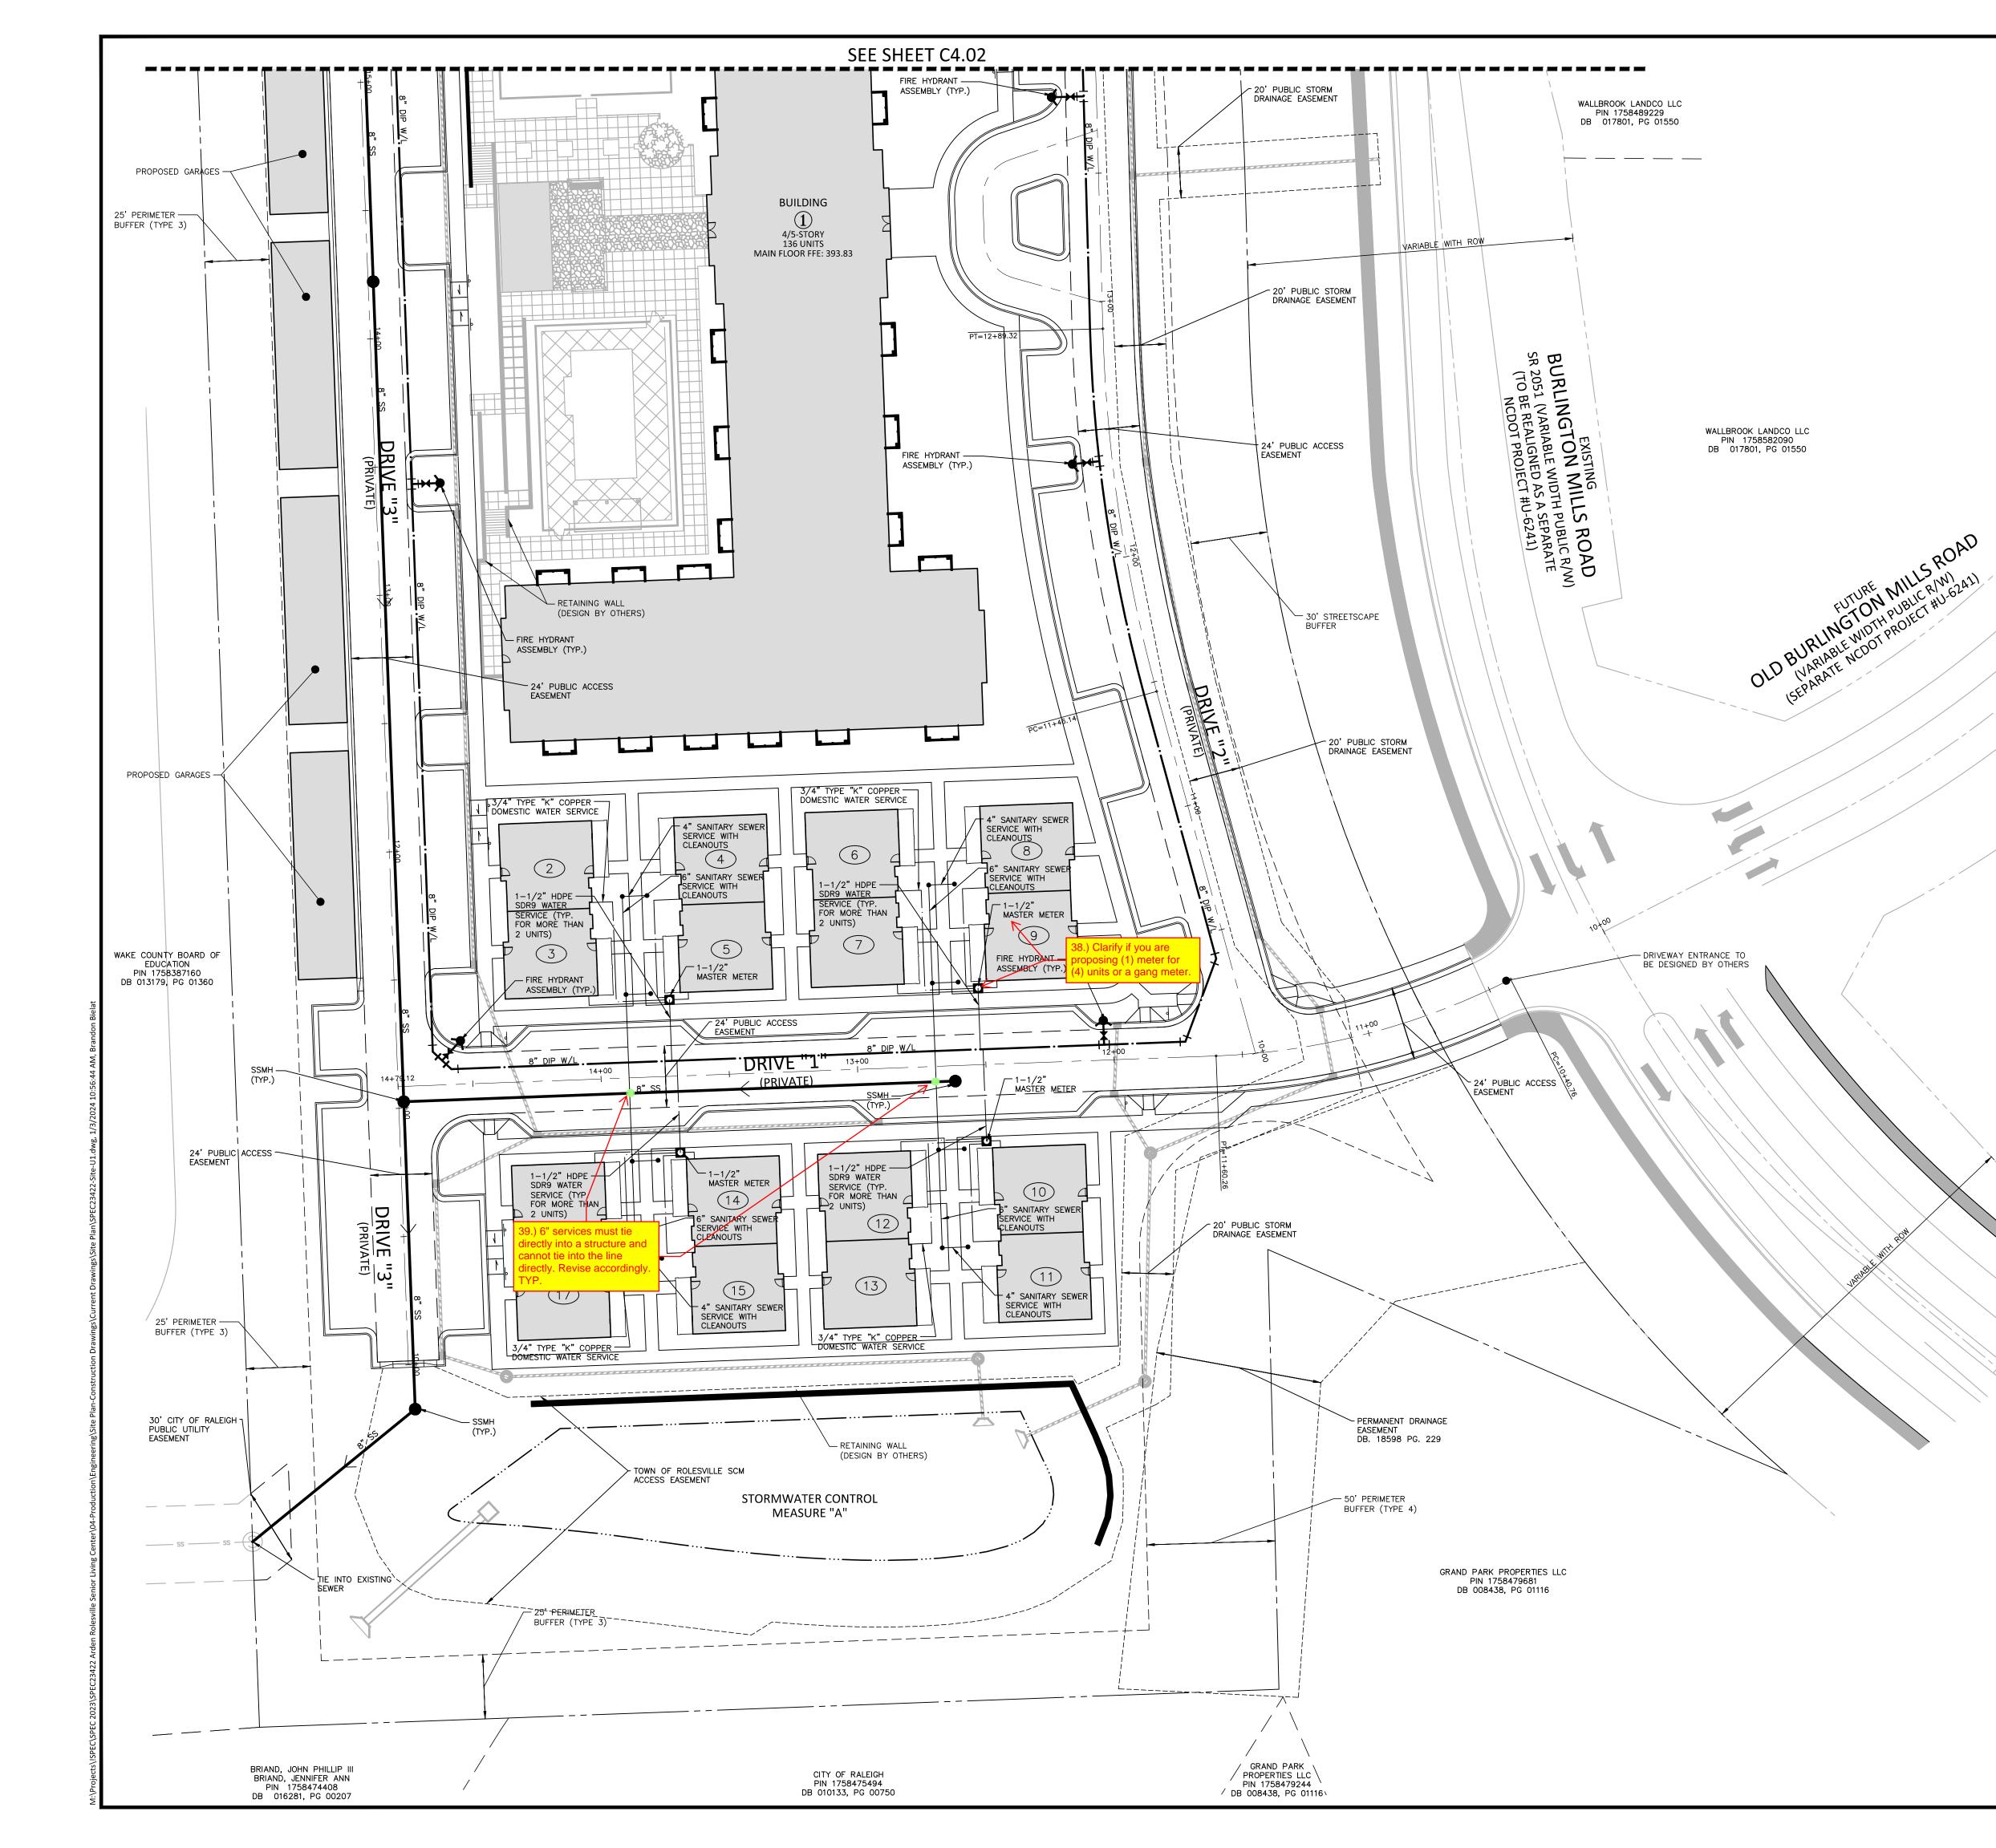

#### UTILITY LEGEND

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	UTILITY SLEEVE
	SANITARY SEWER
	SEWER SERVICE
———— FM———— FM————	SEWER FORCE
GGG	GAS LINE
OU OU	OVERHEAD UTILI
UE UE	UNDERGROUND
TTT	TELEPHONE
	EASEMENT LINE

WALLBROOK LANDCO LLC PIN 1758582090 DB 017801, PG 01550

FIRE HYDRANT ASSEMBLY FIRE DEPARTMENT CONNECTION (FDC) WATER METER WATER VALVE POST INDICATOR VALVE VALVE IN MANHOLE METER & VAULT BACKFLOW PREVENTER REDUCER PLUG BLOW-OFF ASSEMBLY SANITARY SEWER MANHOLE SEWER CLEAN-OUT GREASE TRAP SEWER FLOW DIRECTION ARROW YARD LIGHTS LIGHT POLE POWER POLE LINE BREAK SYMBOL WATERLINE WATER SERVICE LINE _____ UTILITY SLEEVE - SANITARY SEWER - SEWER FORCE MAIN — GAS LINE 



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#### REVISIONS

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PLAN INFORMATION

PROJECT NO. SPEC-23422


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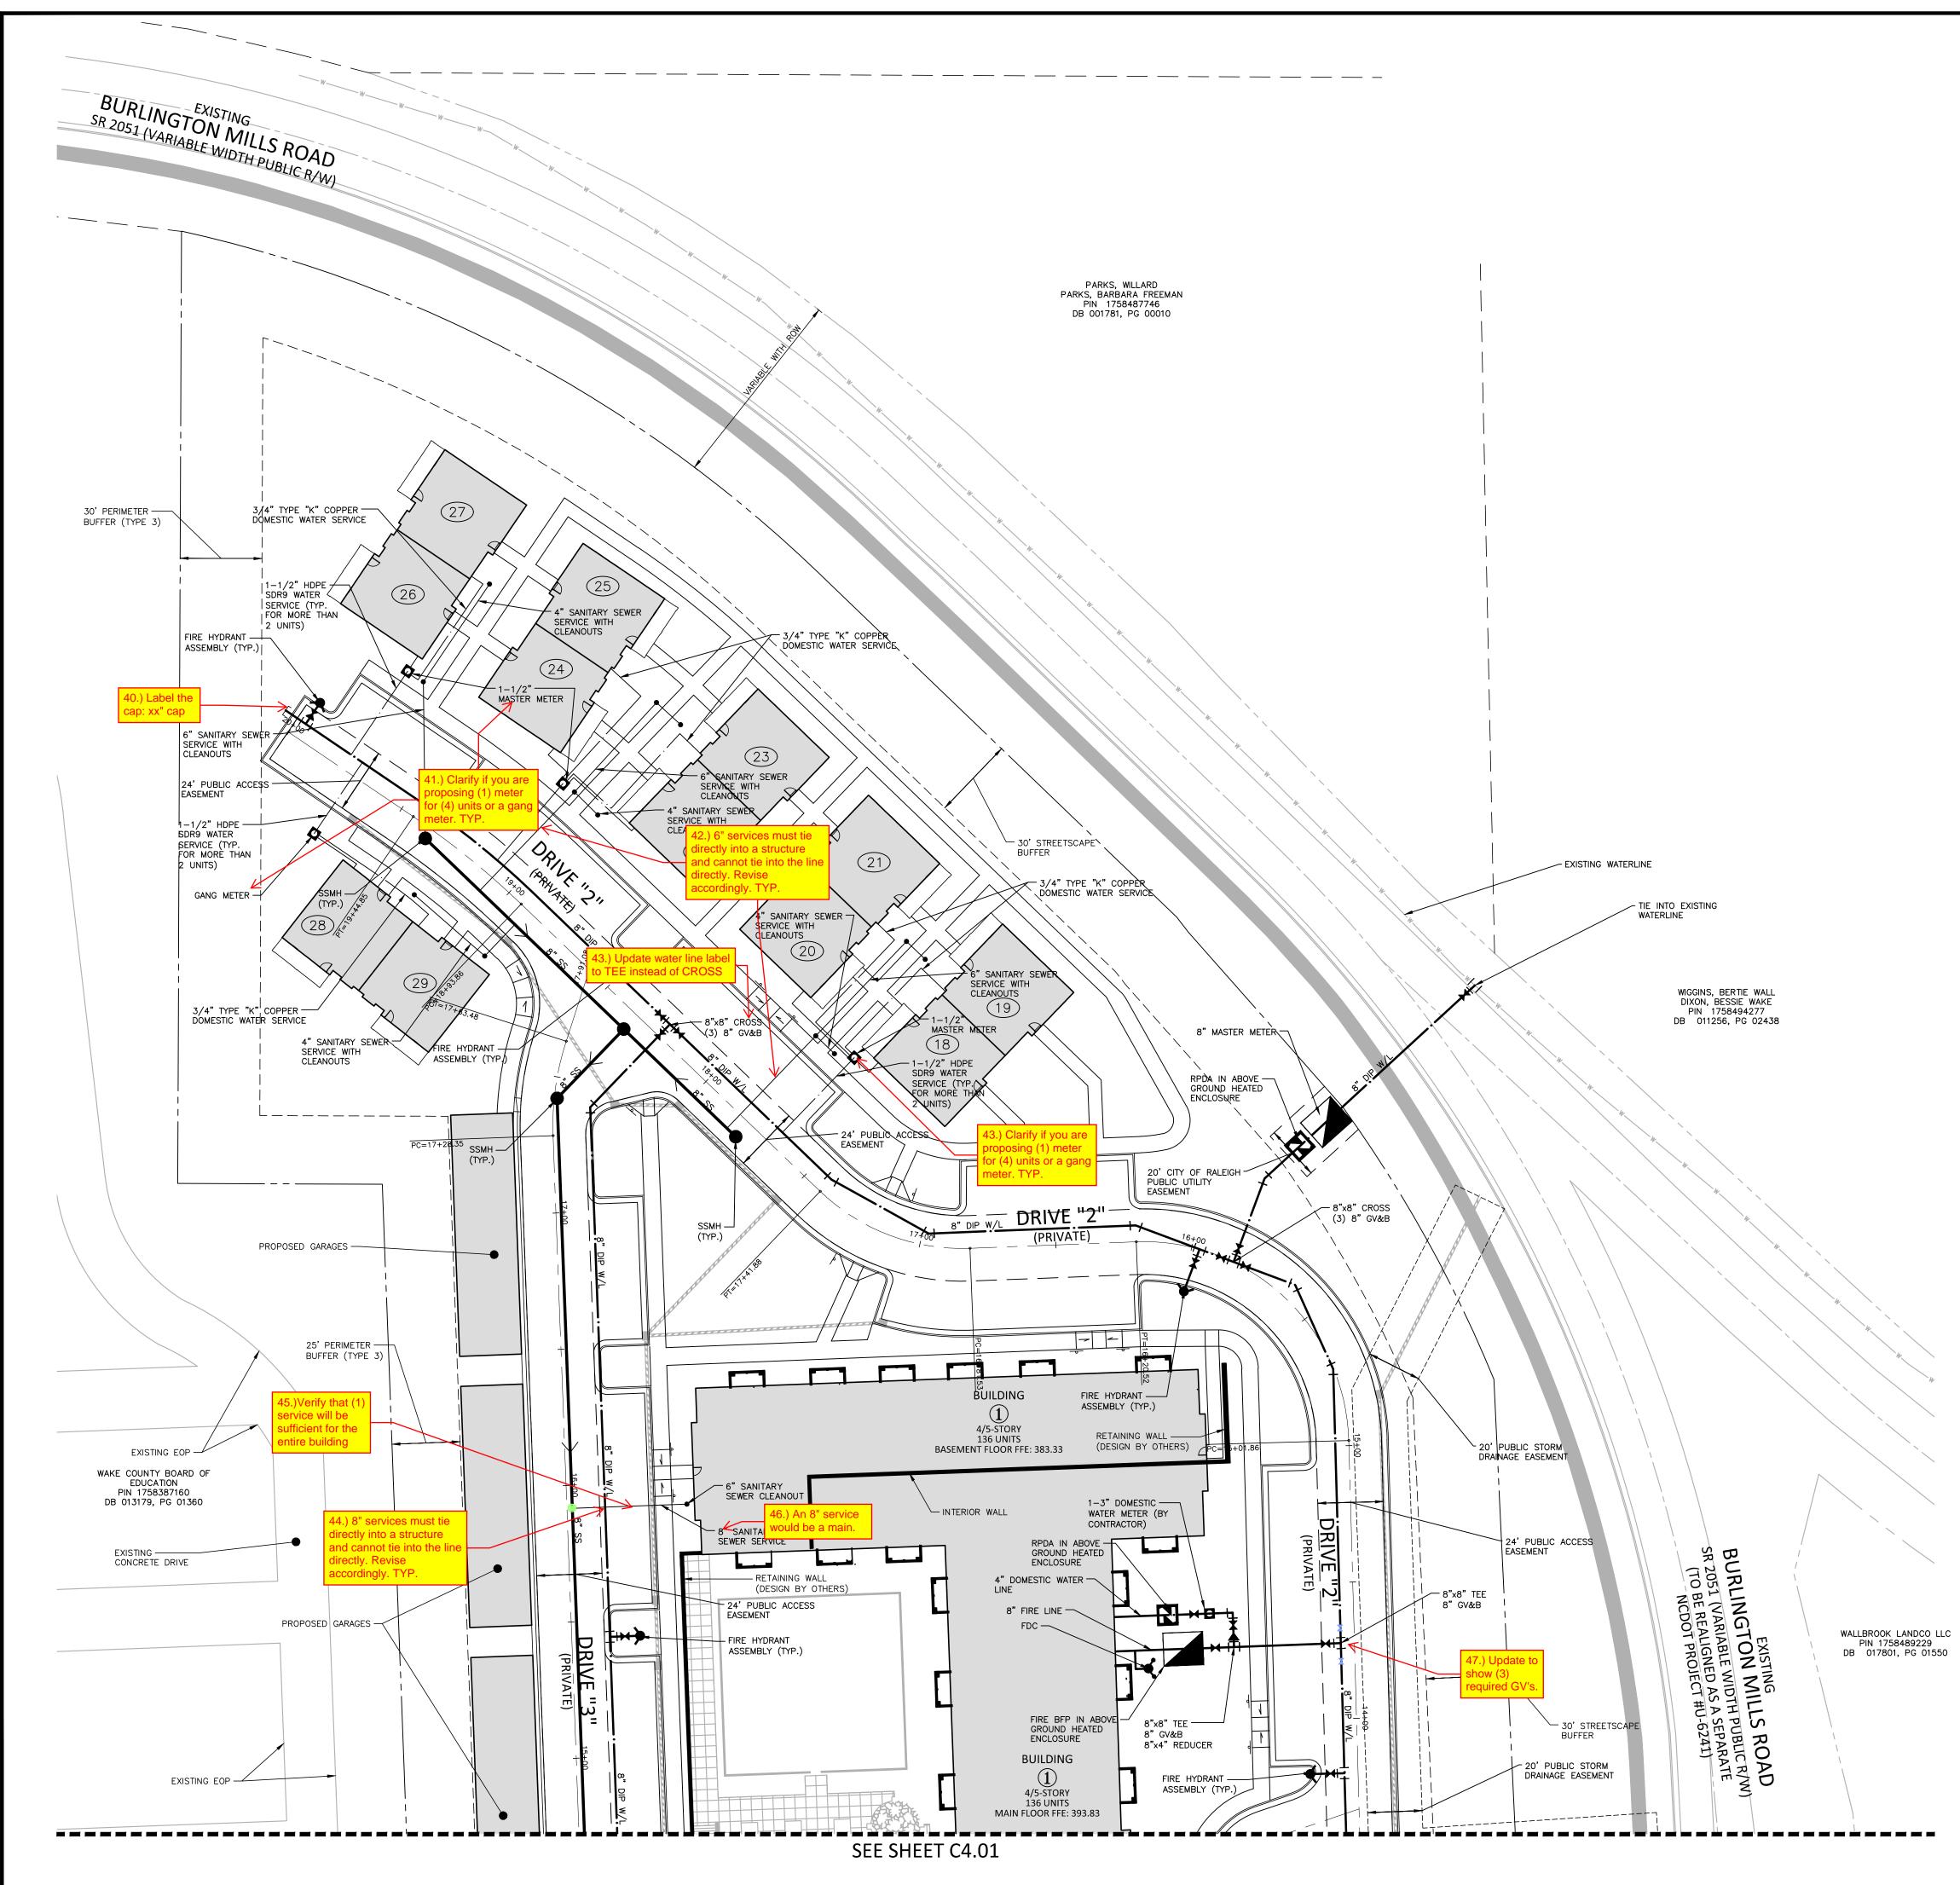
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SPEC23422-SITE-U1







#### UTILITY LEGEND
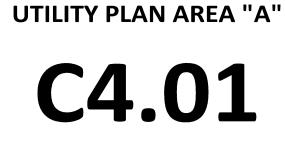
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UTILITY LEGEND	
	FIRE HYDRANT ASSEMBLY FIRE DEPARTMENT CONNECTION (FDC) WATER METER
	WATER VALVE POST INDICATOR VALVE
	VALVE IN MANHOLE METER & VAULT BACKFLOW PREVENTER
	REDUCER PLUG BLOW–OFF ASSEMBLY
•	SANITARY SEWER MANHOLE SEWER CLEAN-OUT GREASE TRAP
>	SEWER FLOW DIRECTION ARROW YARD LIGHTS
* ~ ~	LIGHT POLE POWER POLE LINE BREAK SYMBOL WATERLINE
	WATER SERVICE LINE UTILITY SLEEVE SANITARY SEWER SEWER SERVICE LINE
FM FM G G OU OU UE UE	
TTTT	TELEPHONE



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#### REVISIONS

NO. DATE


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DATE	01. 03. 2024
SCALE	1"=30'
DRAWN BY	JMS
CHECKED BY	WTO
FILENAME	SPEC23422-SITE-U1
PROJECT NO.	SPEC-23422

UTILITY PLAN AREA "B"







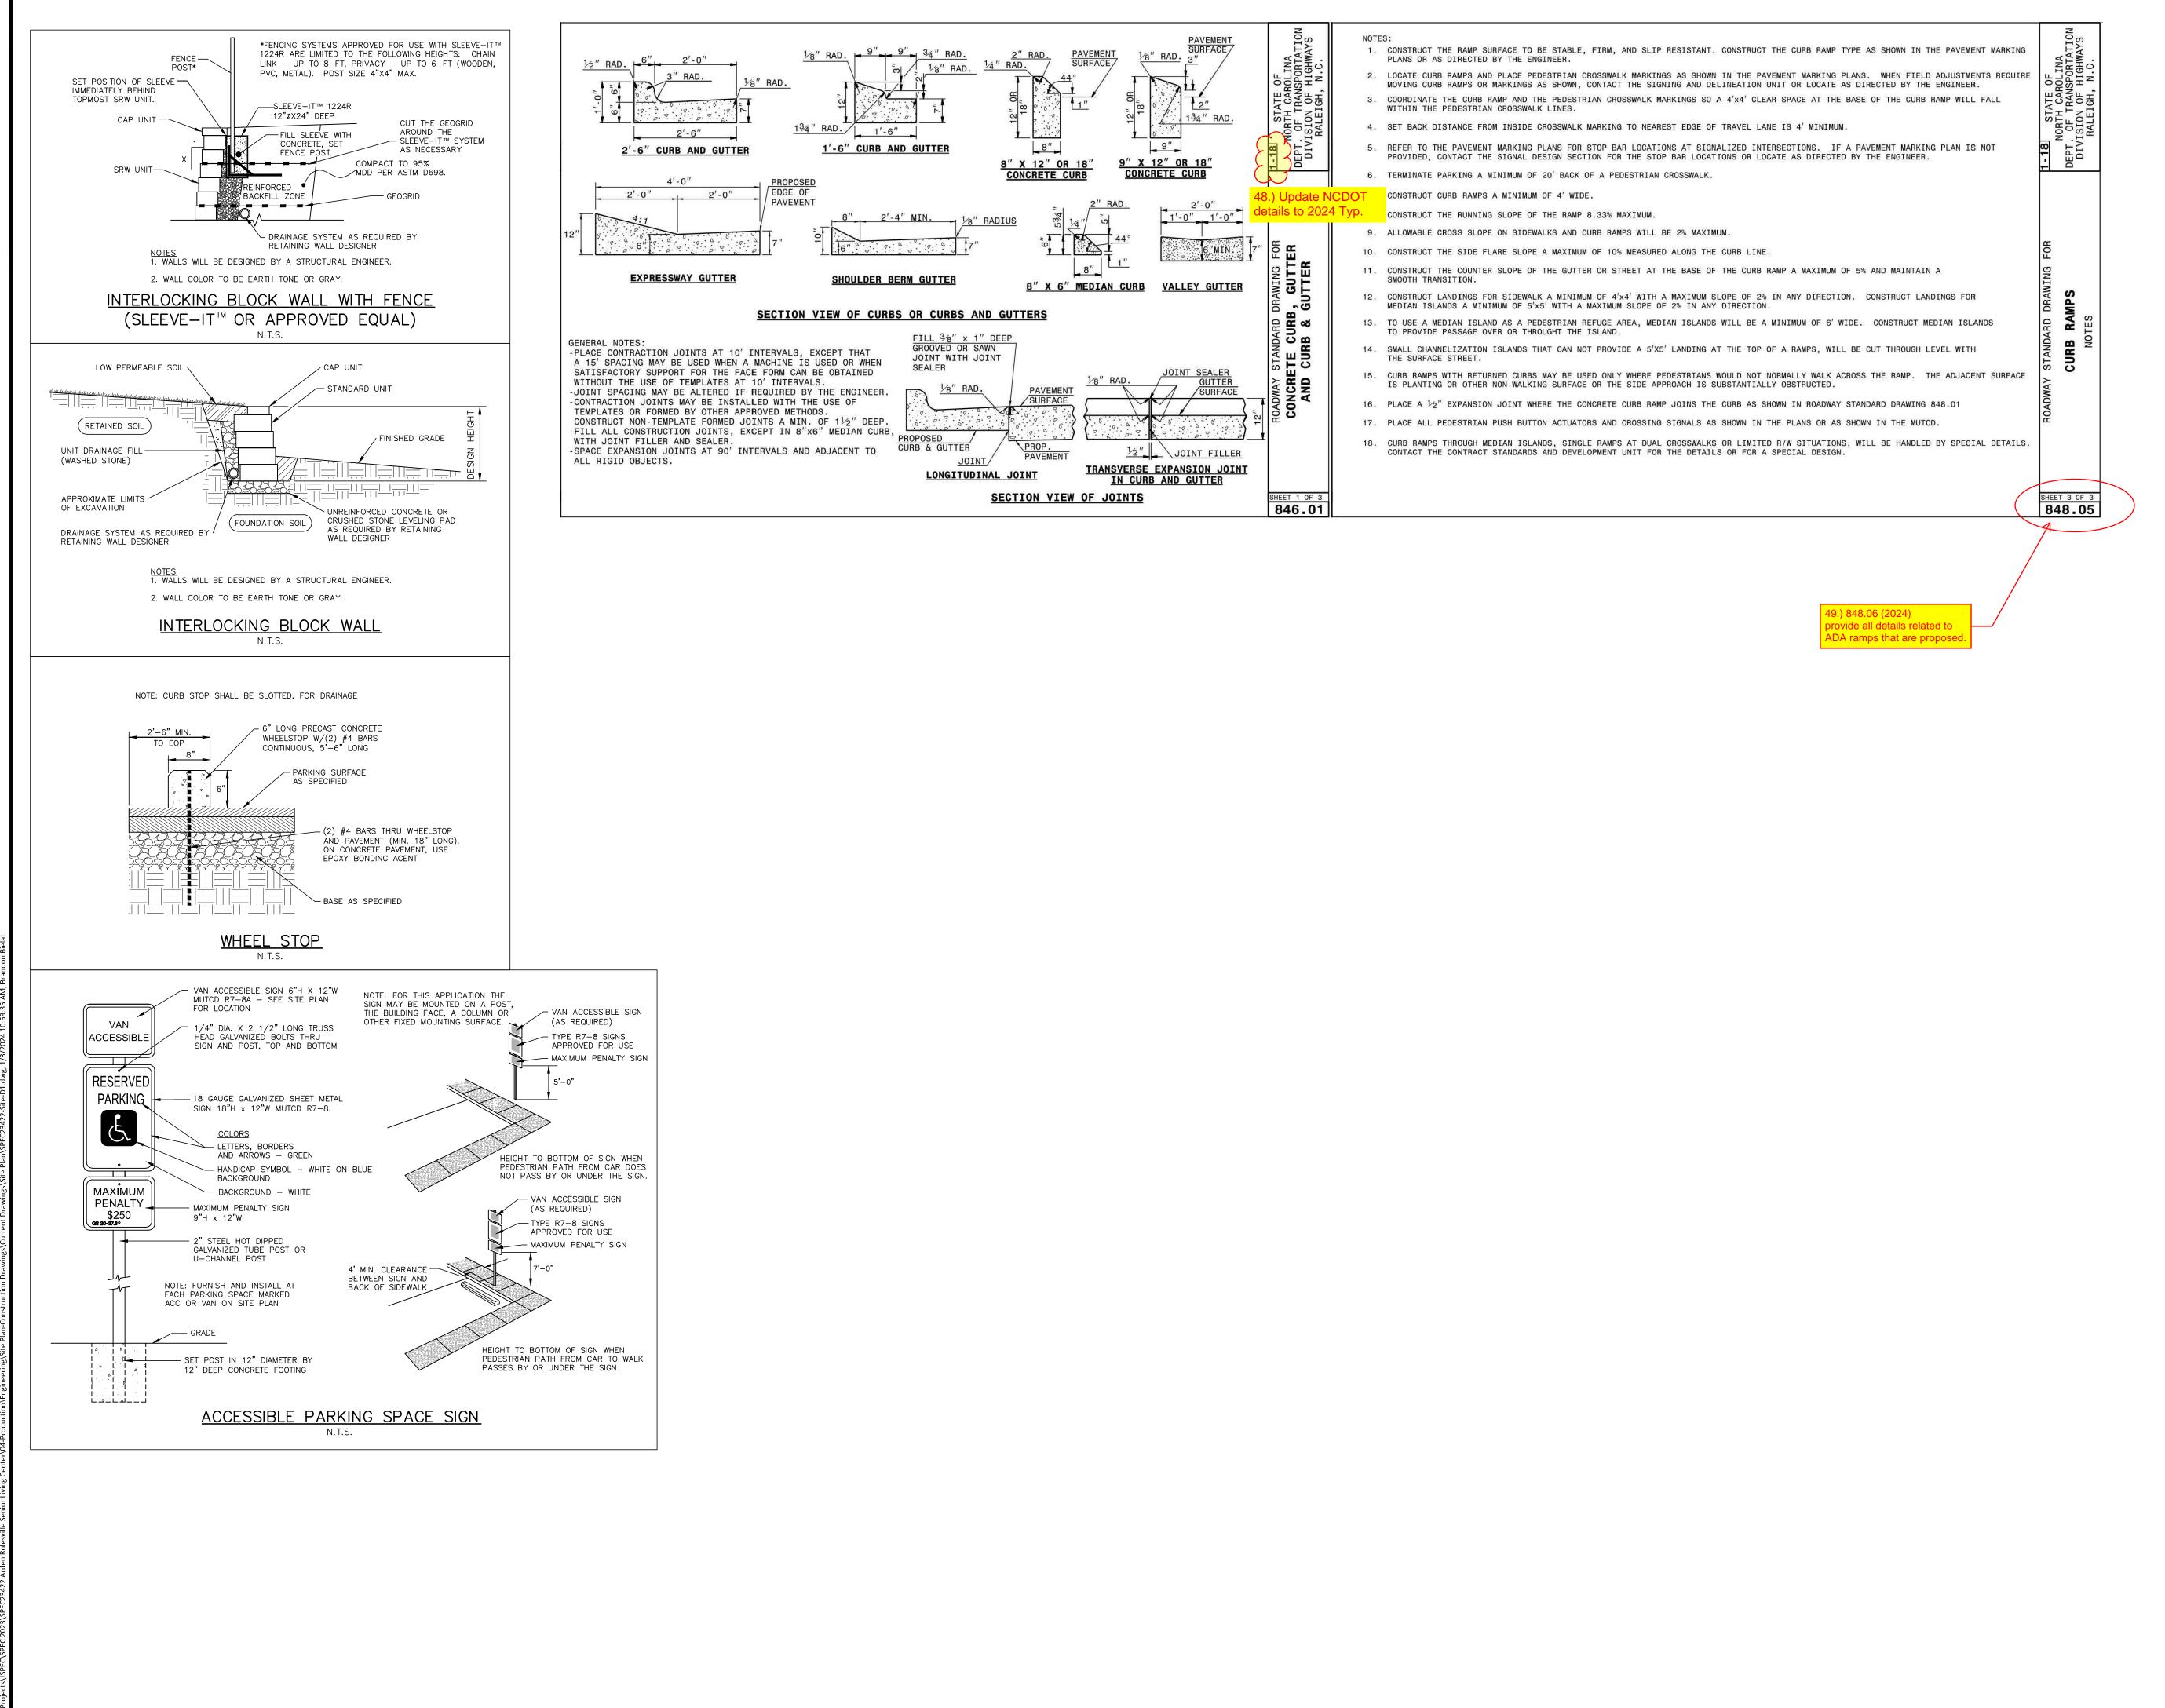


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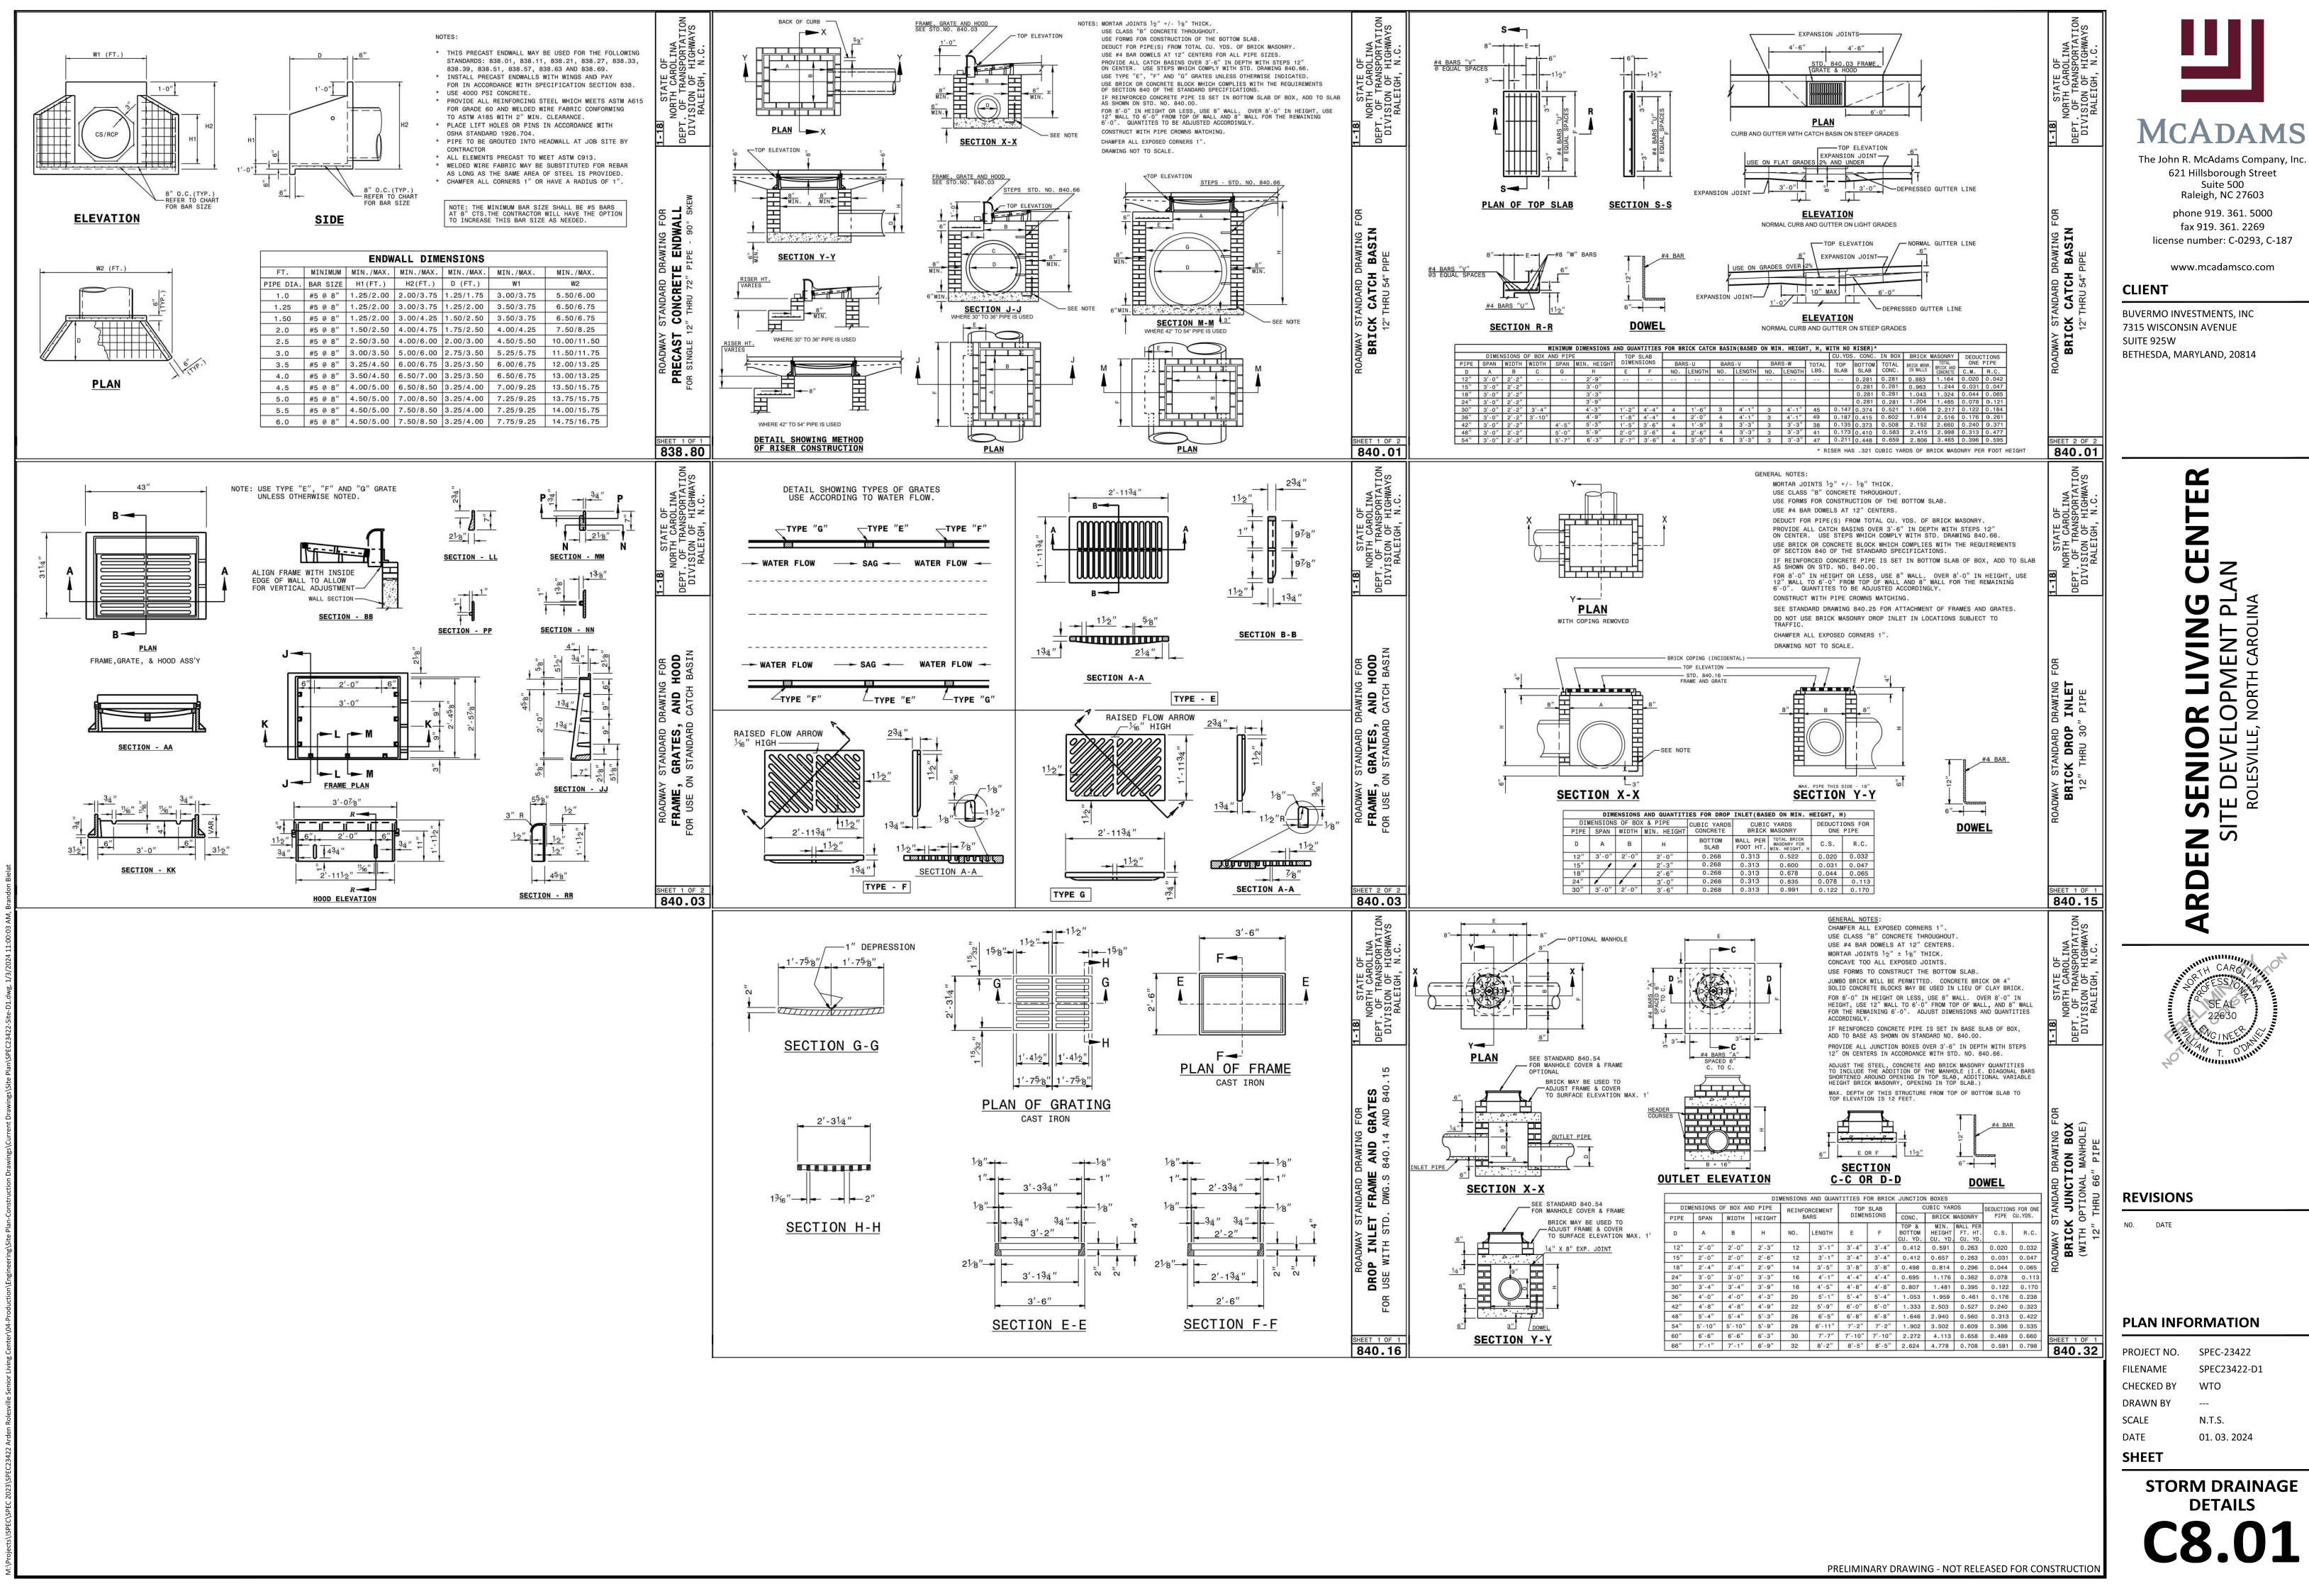
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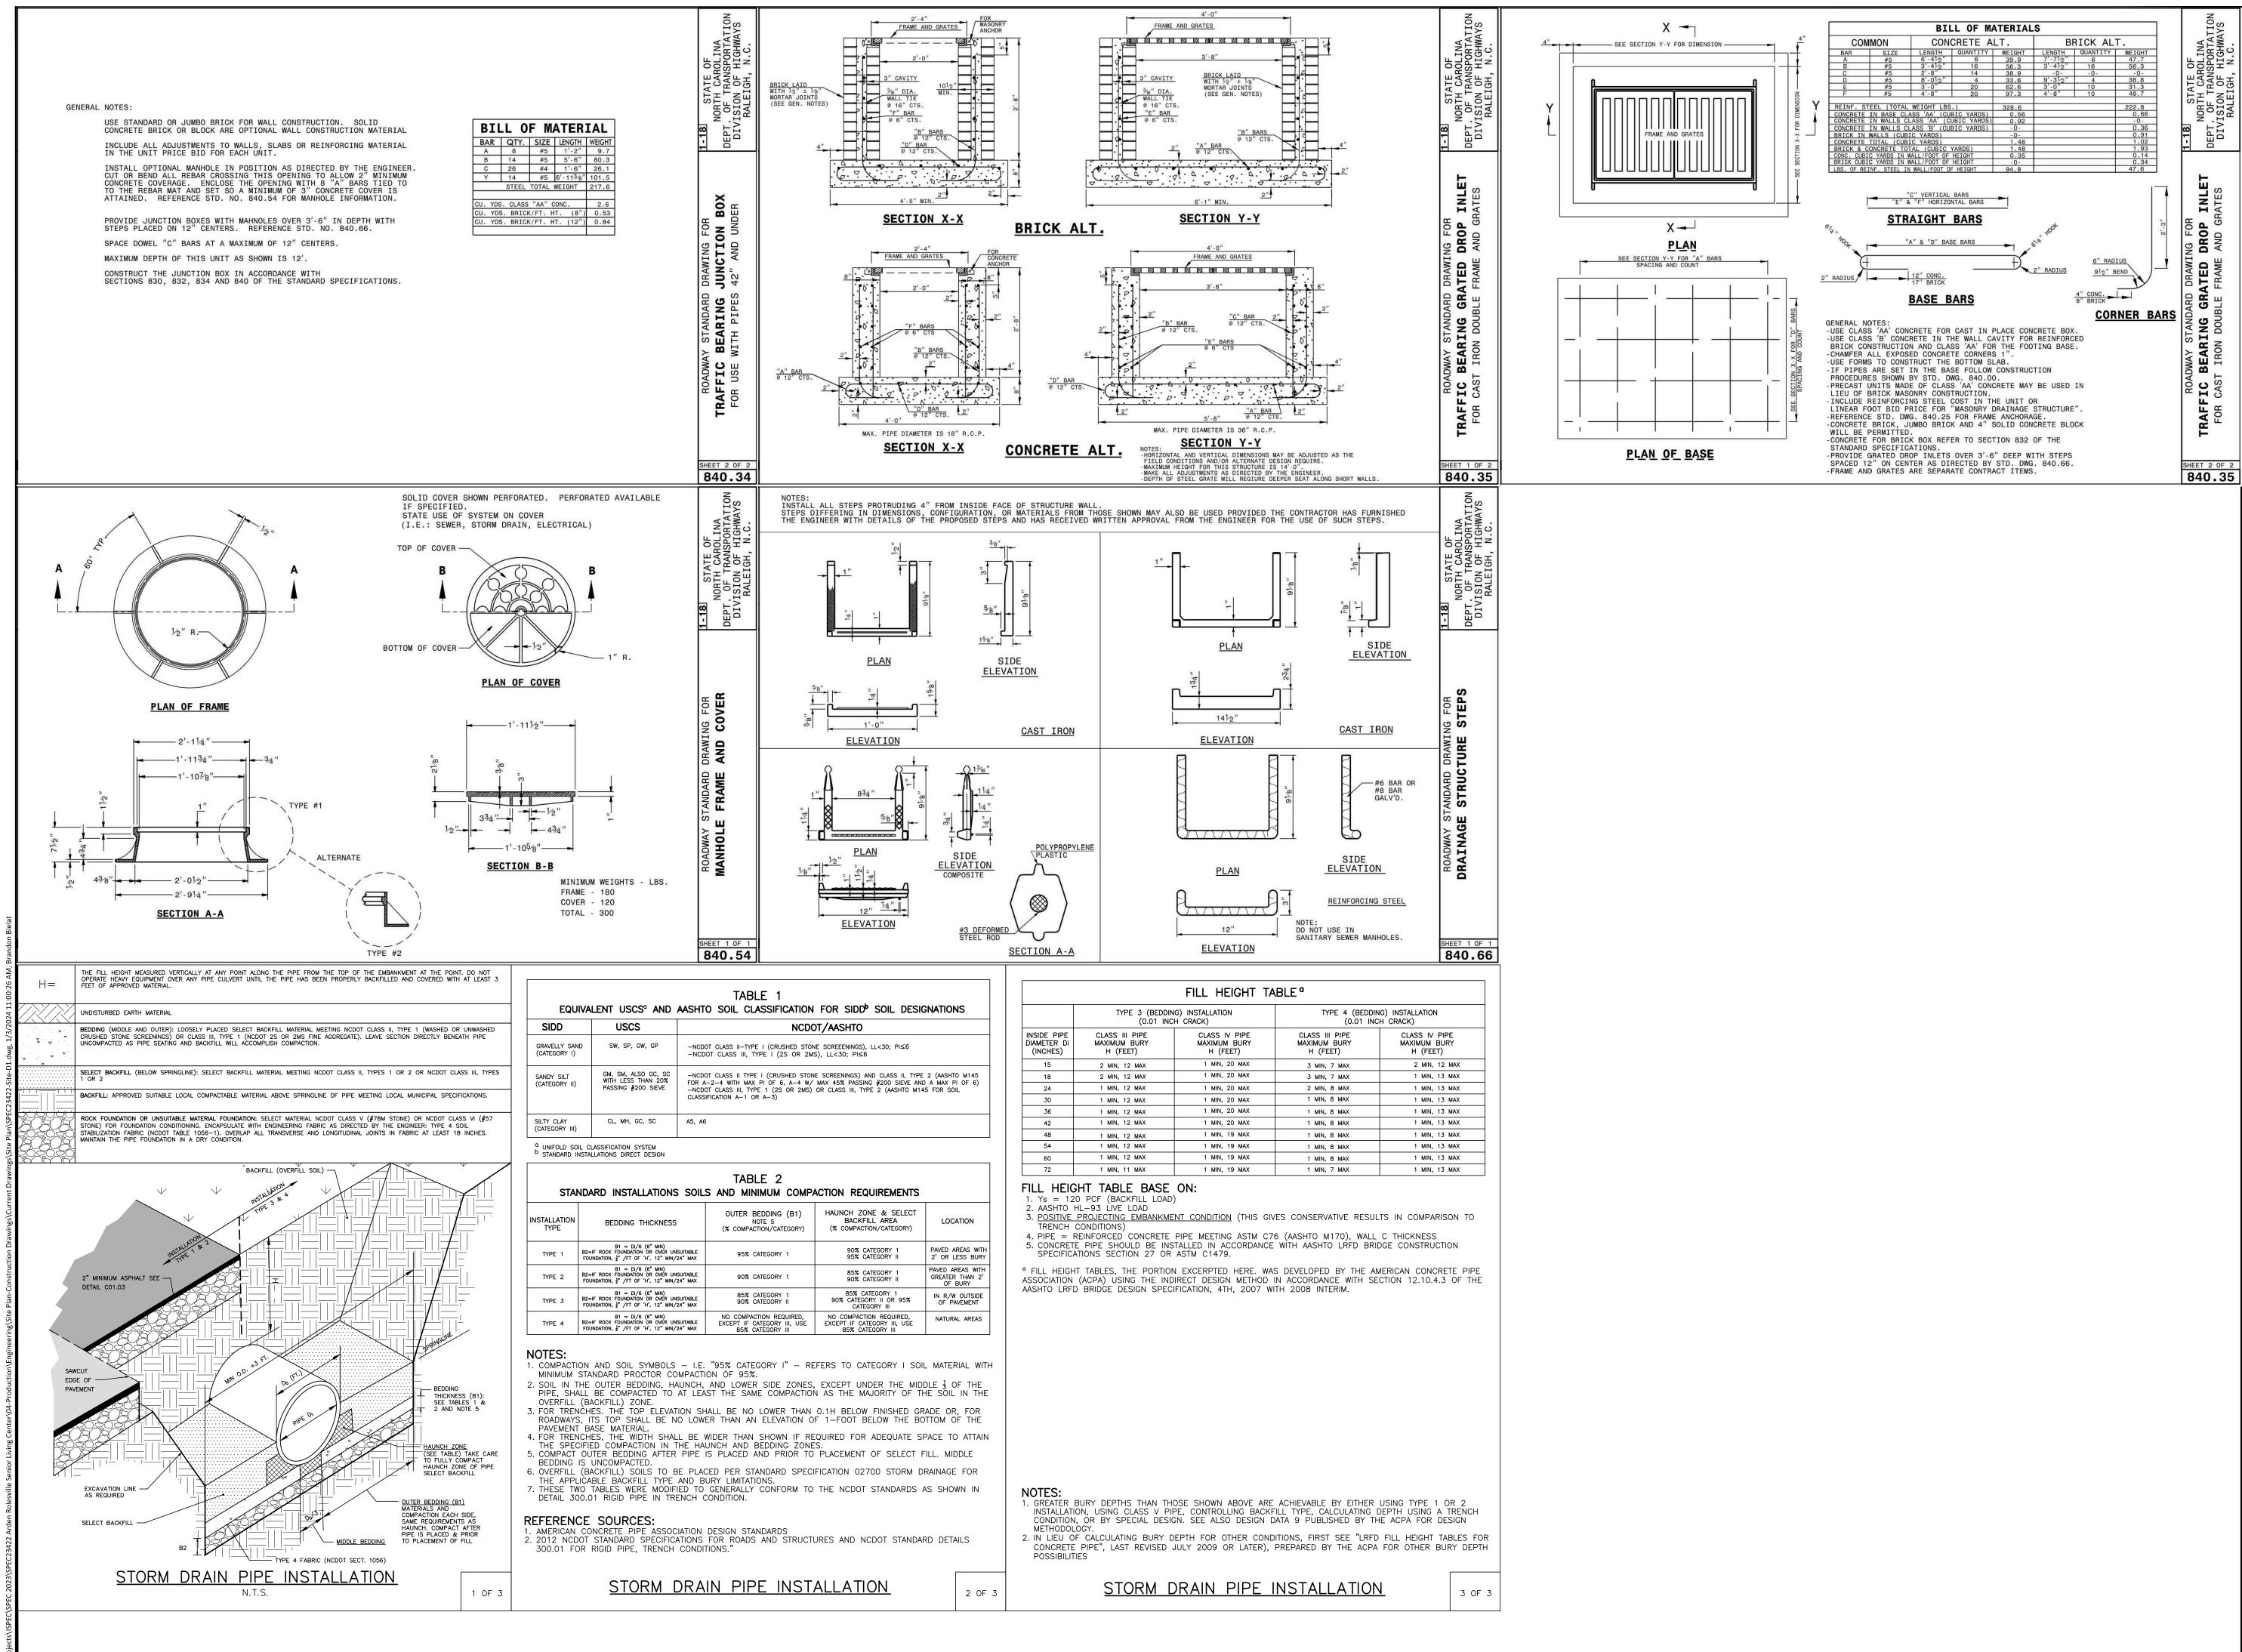
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DATE	01. 03. 2024
SCALE	N.T.S.
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FILENAME	SPEC23422-D1
PROJECT NO.	SPEC-23422

SITE DETAILS







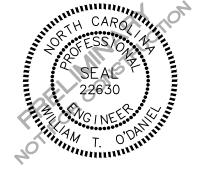


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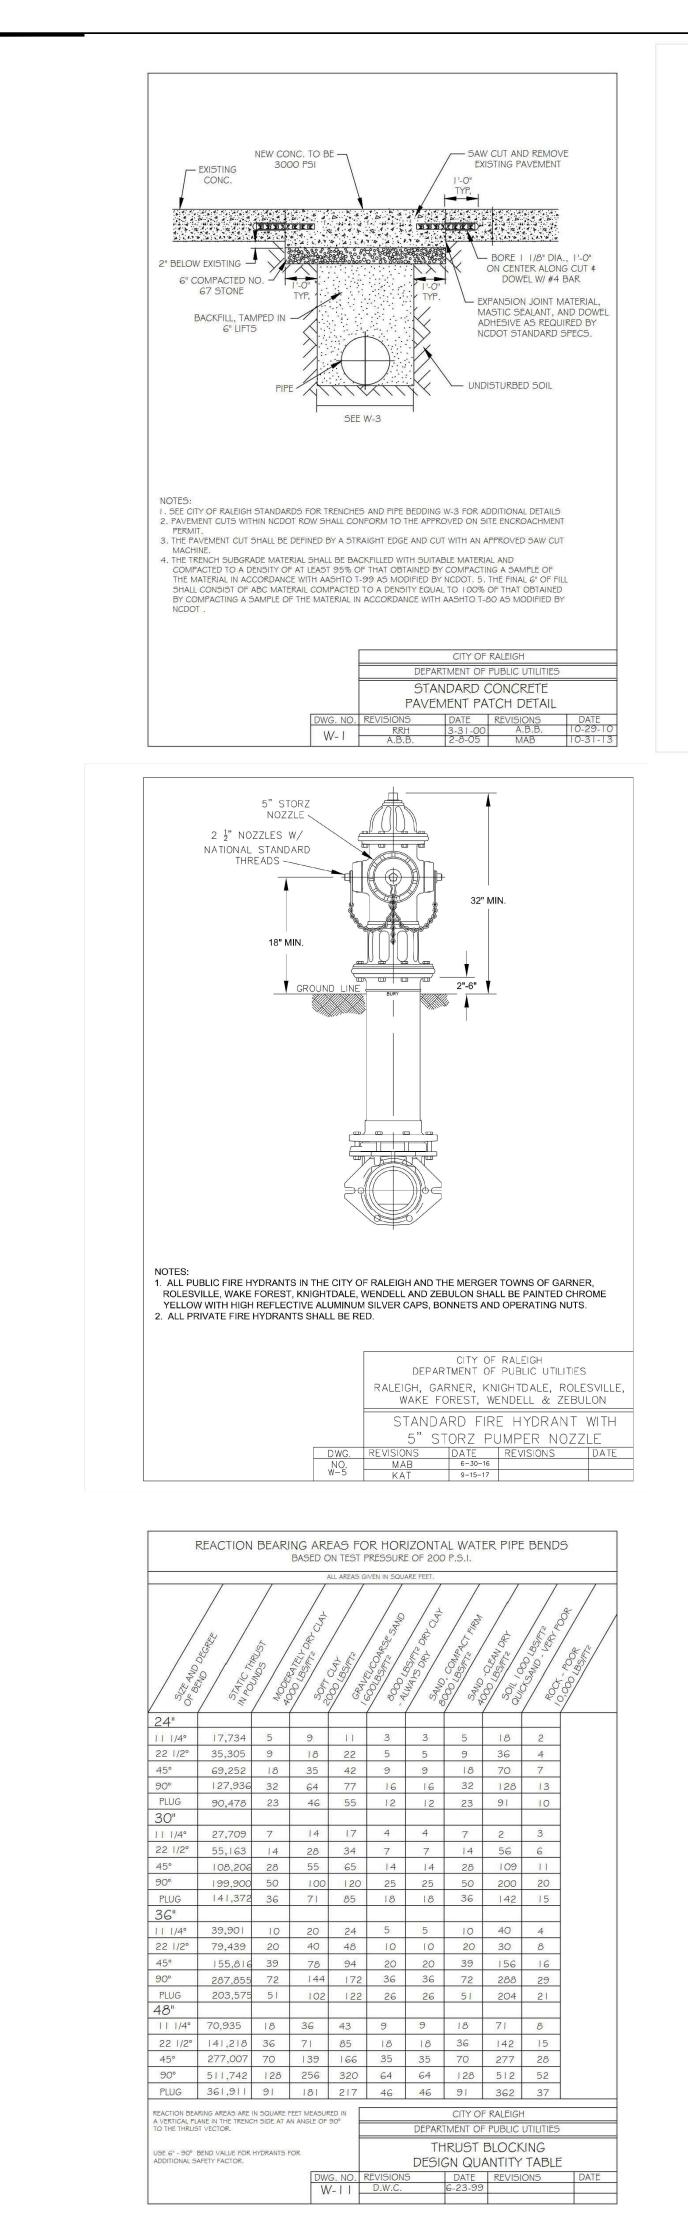
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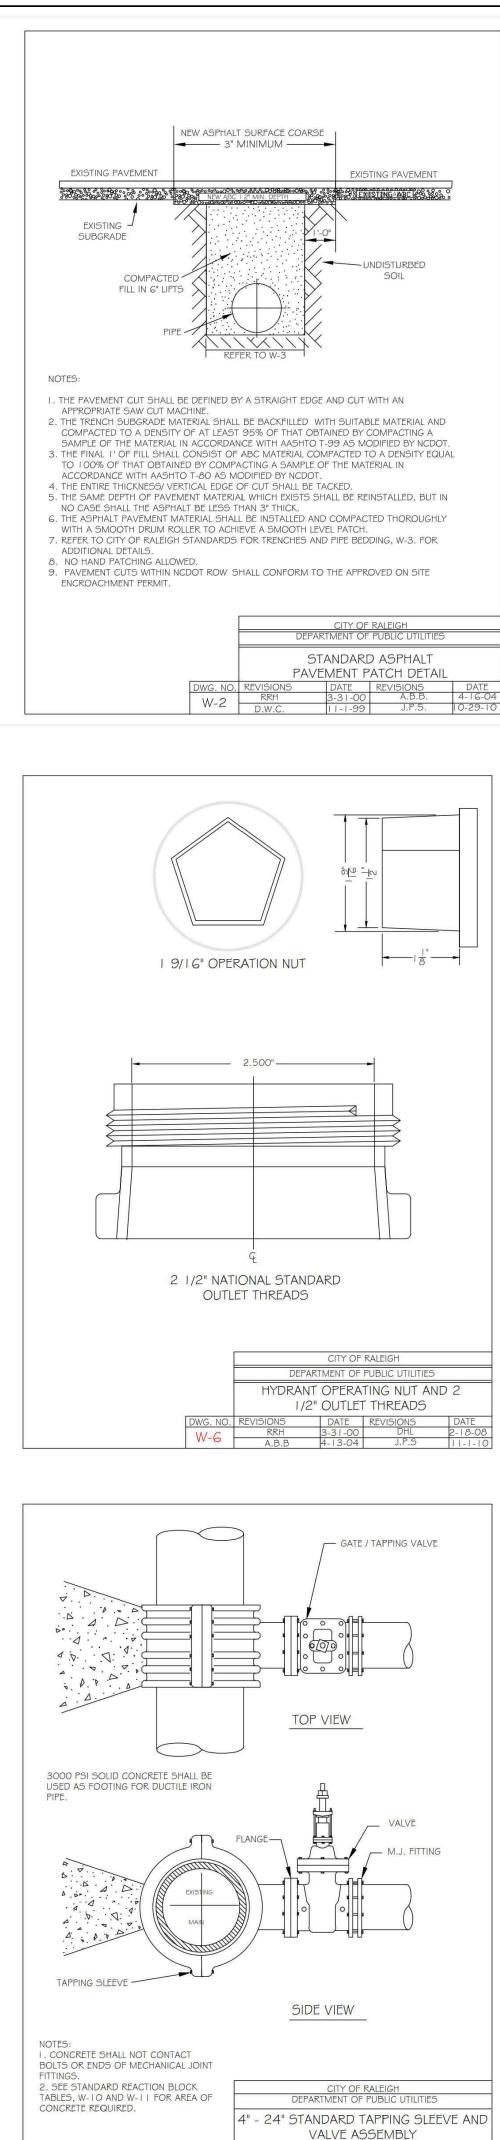
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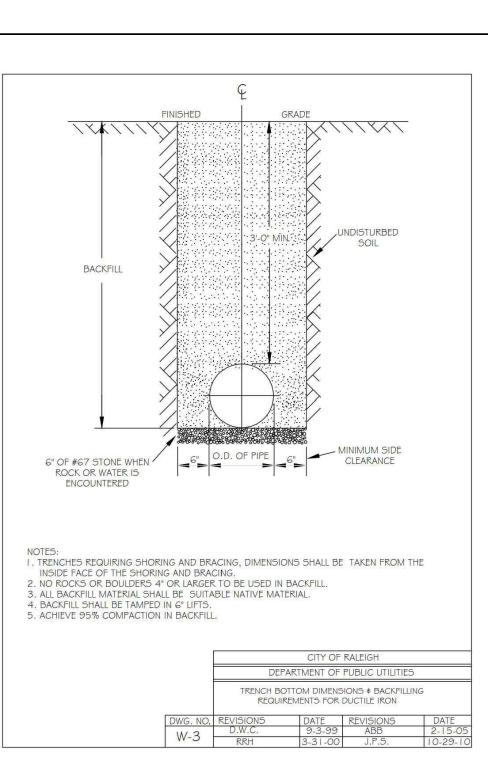









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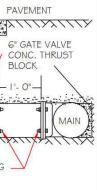
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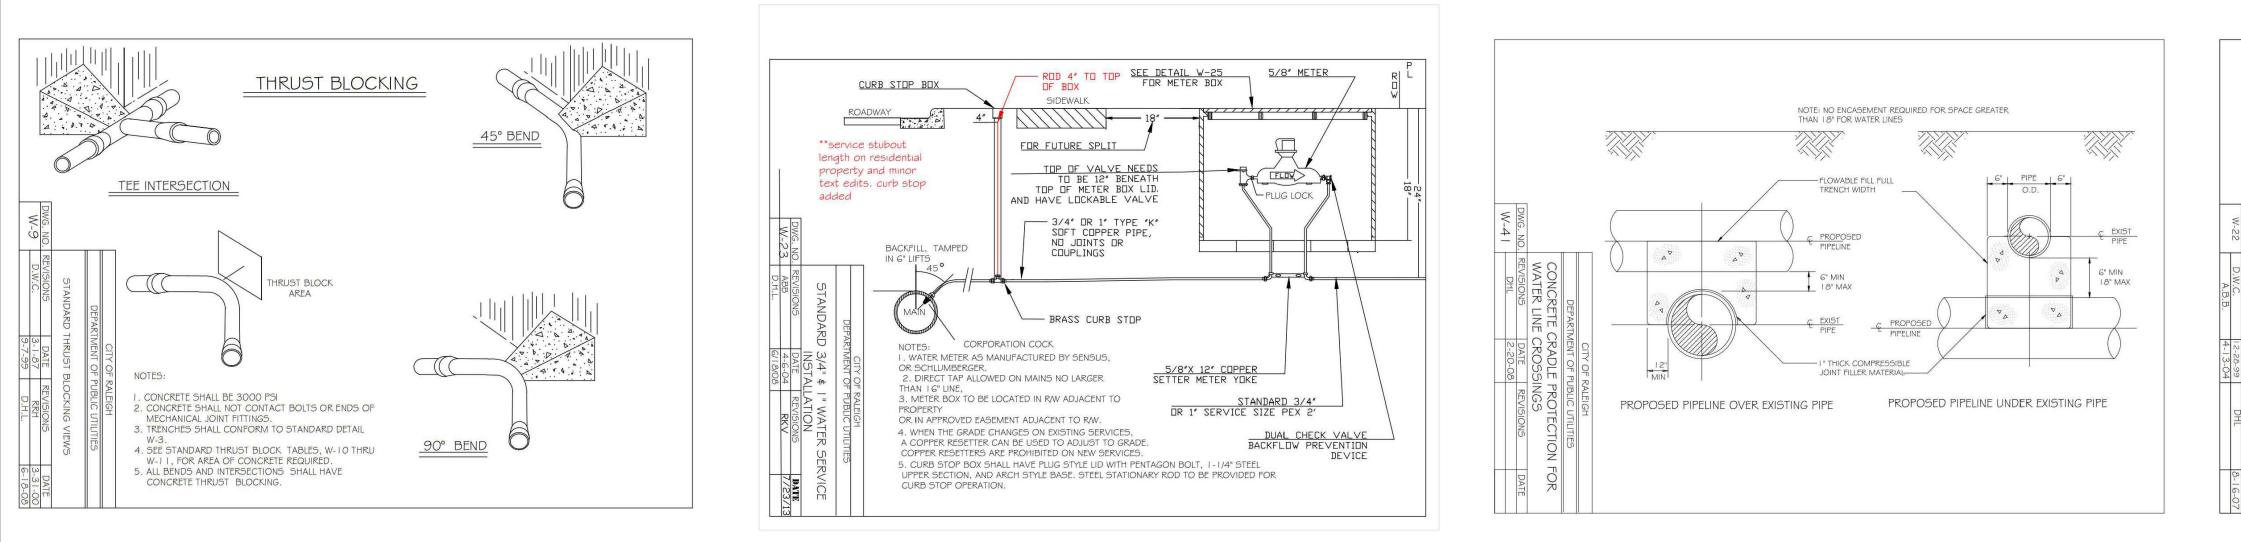
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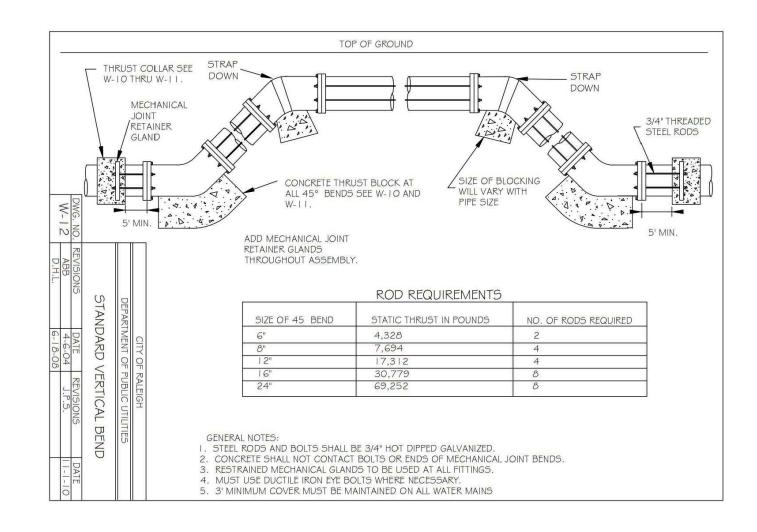
PROJECT NO.	SPEC-23422
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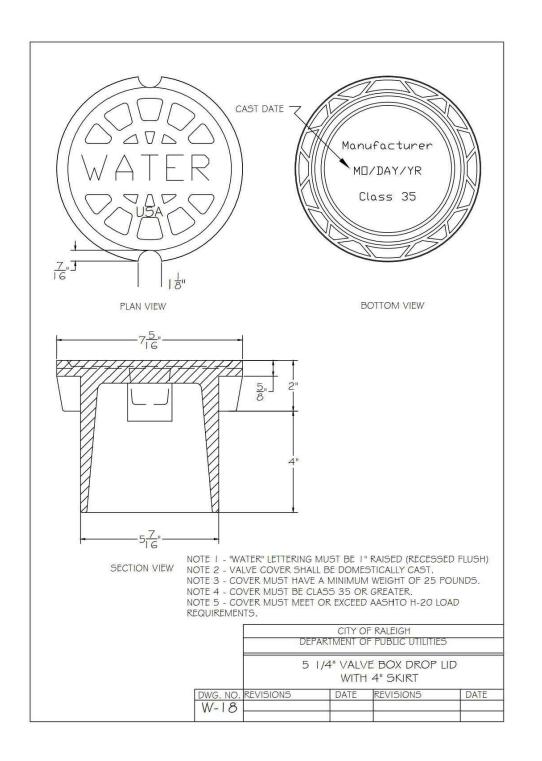
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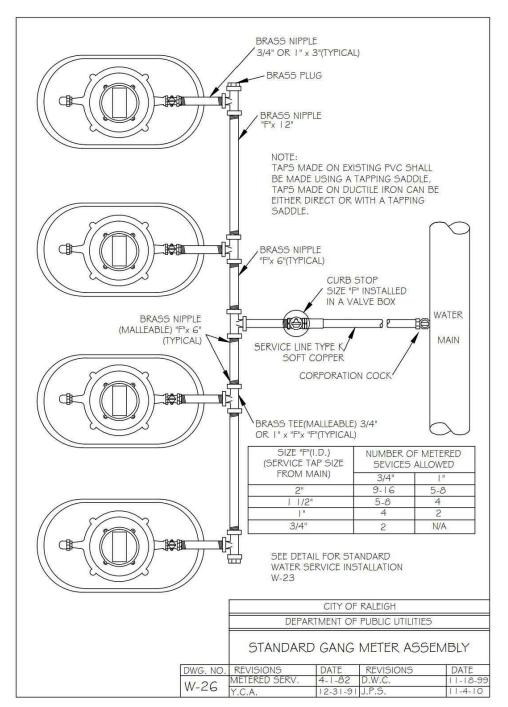


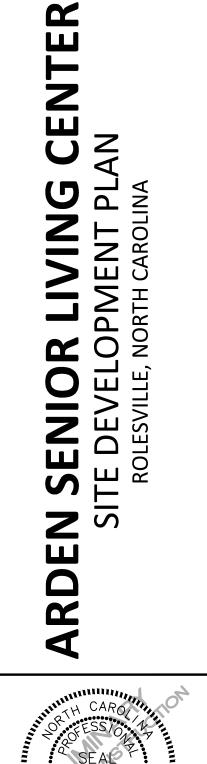





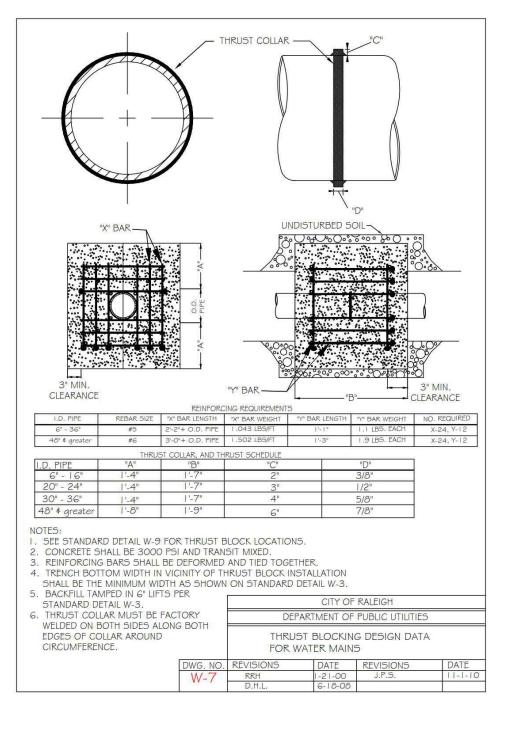

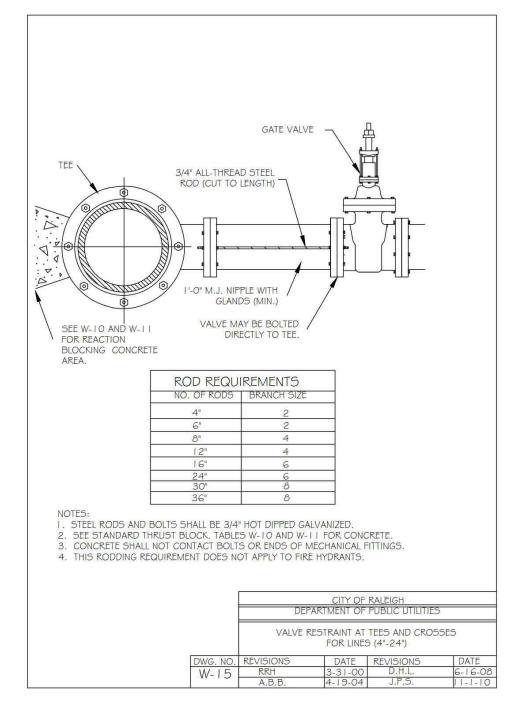

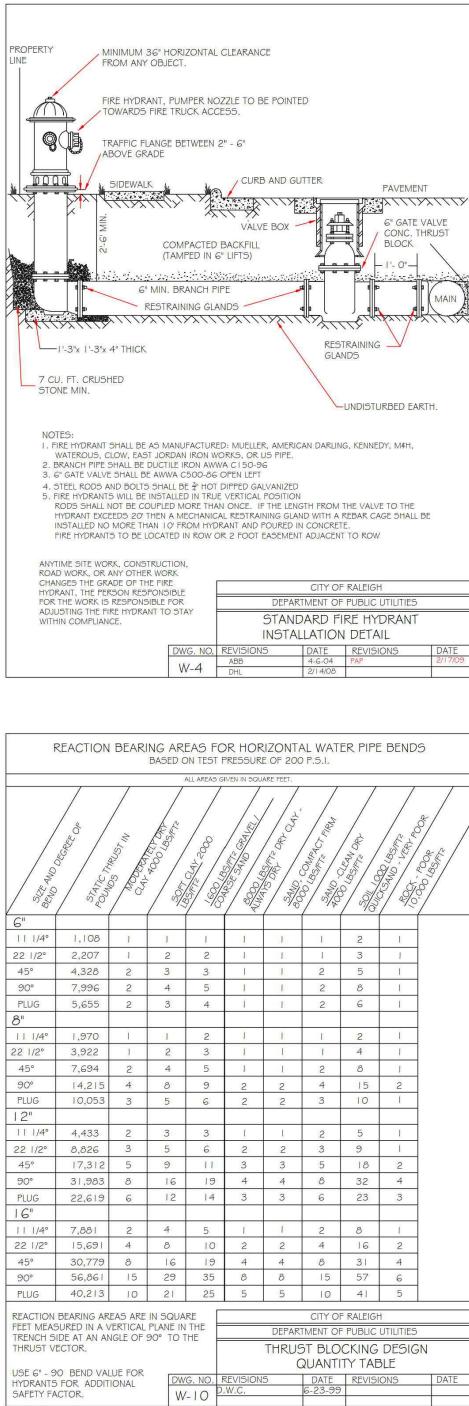

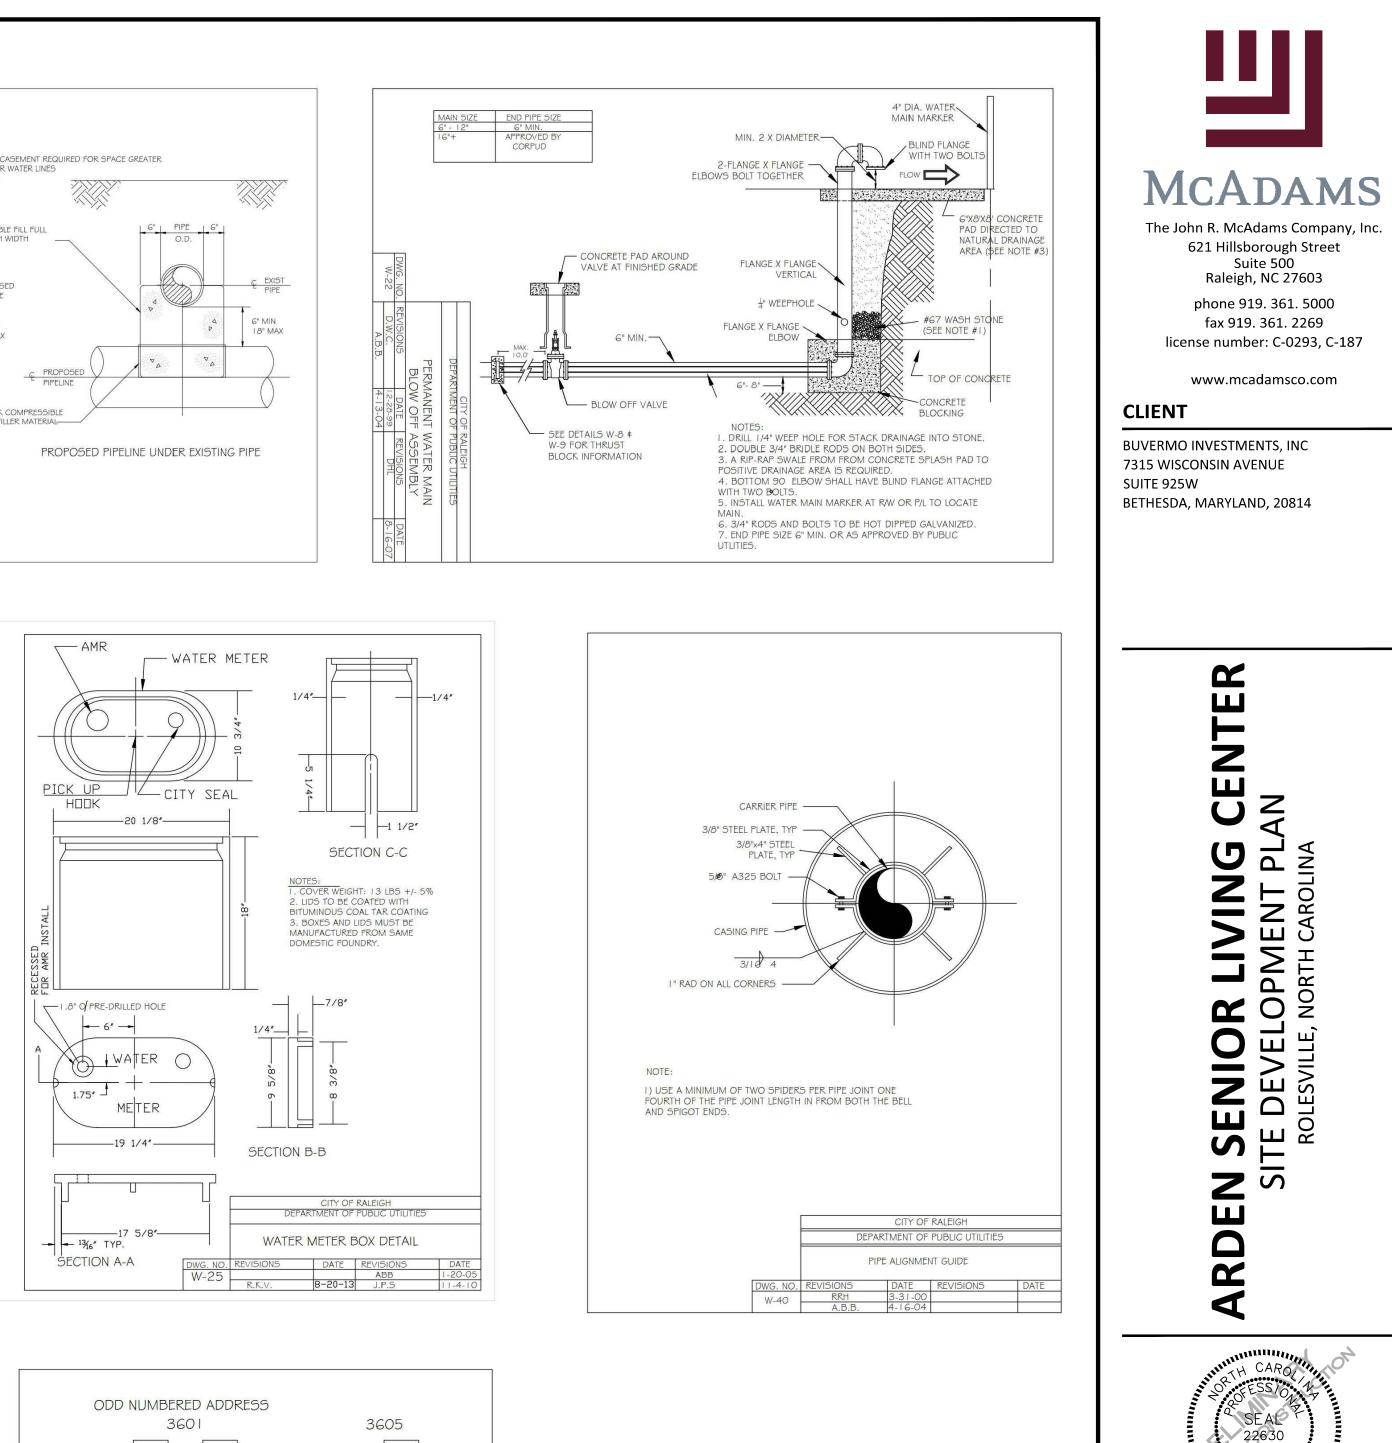

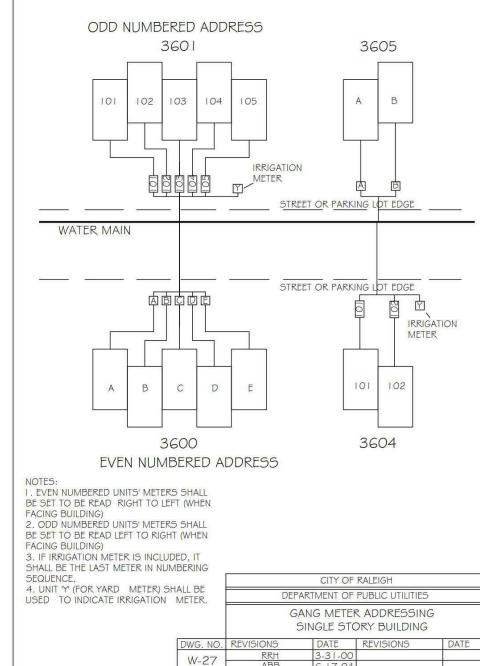

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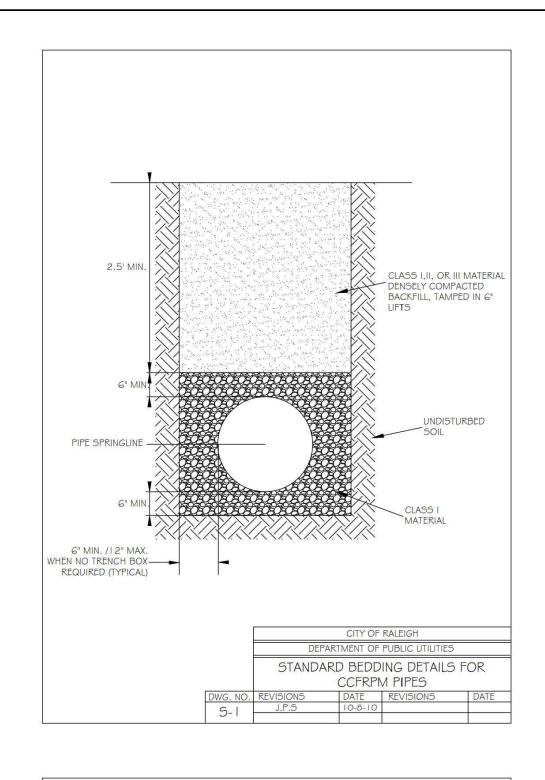
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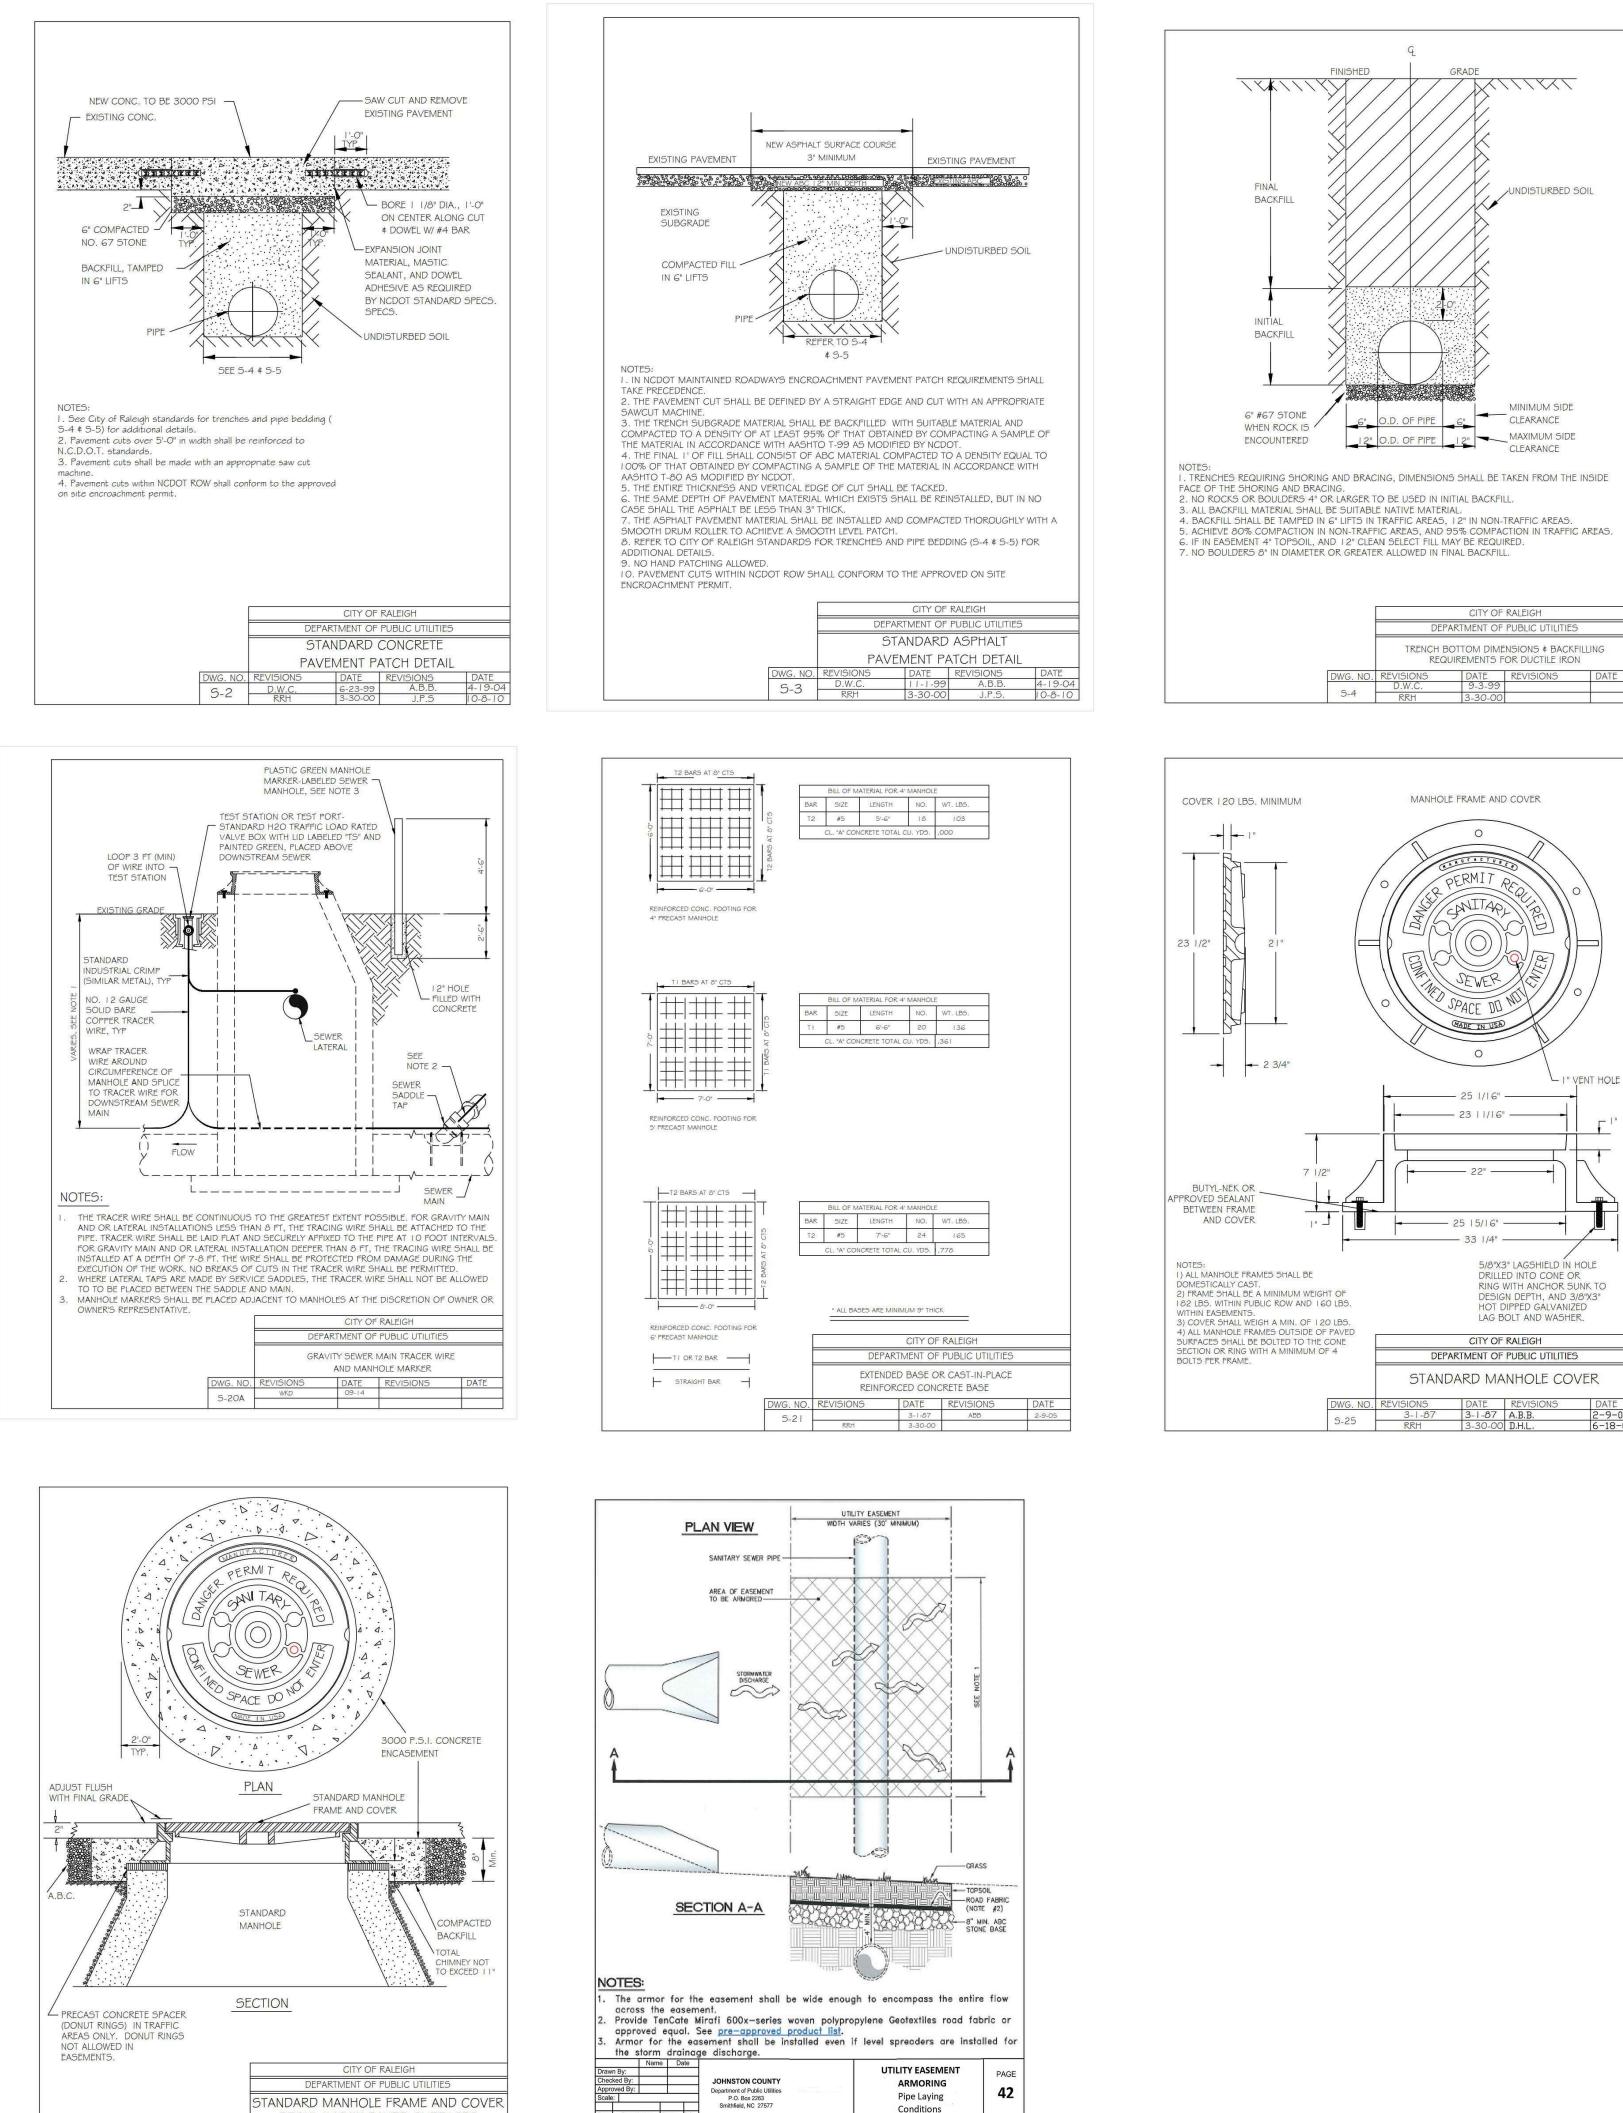
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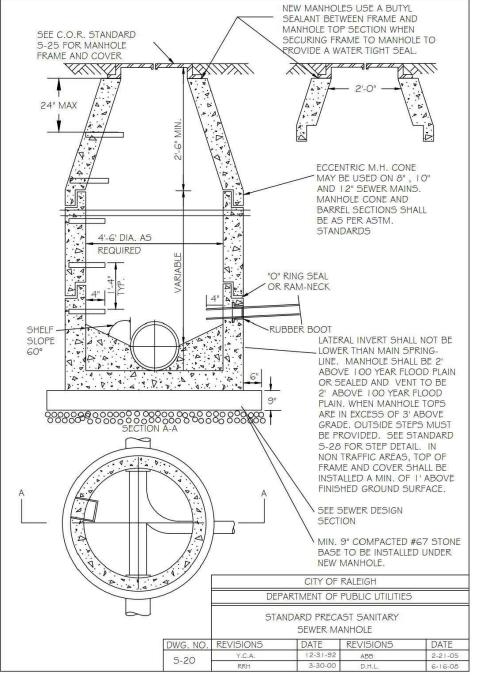
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PROJECT NO.	SPEC-23422


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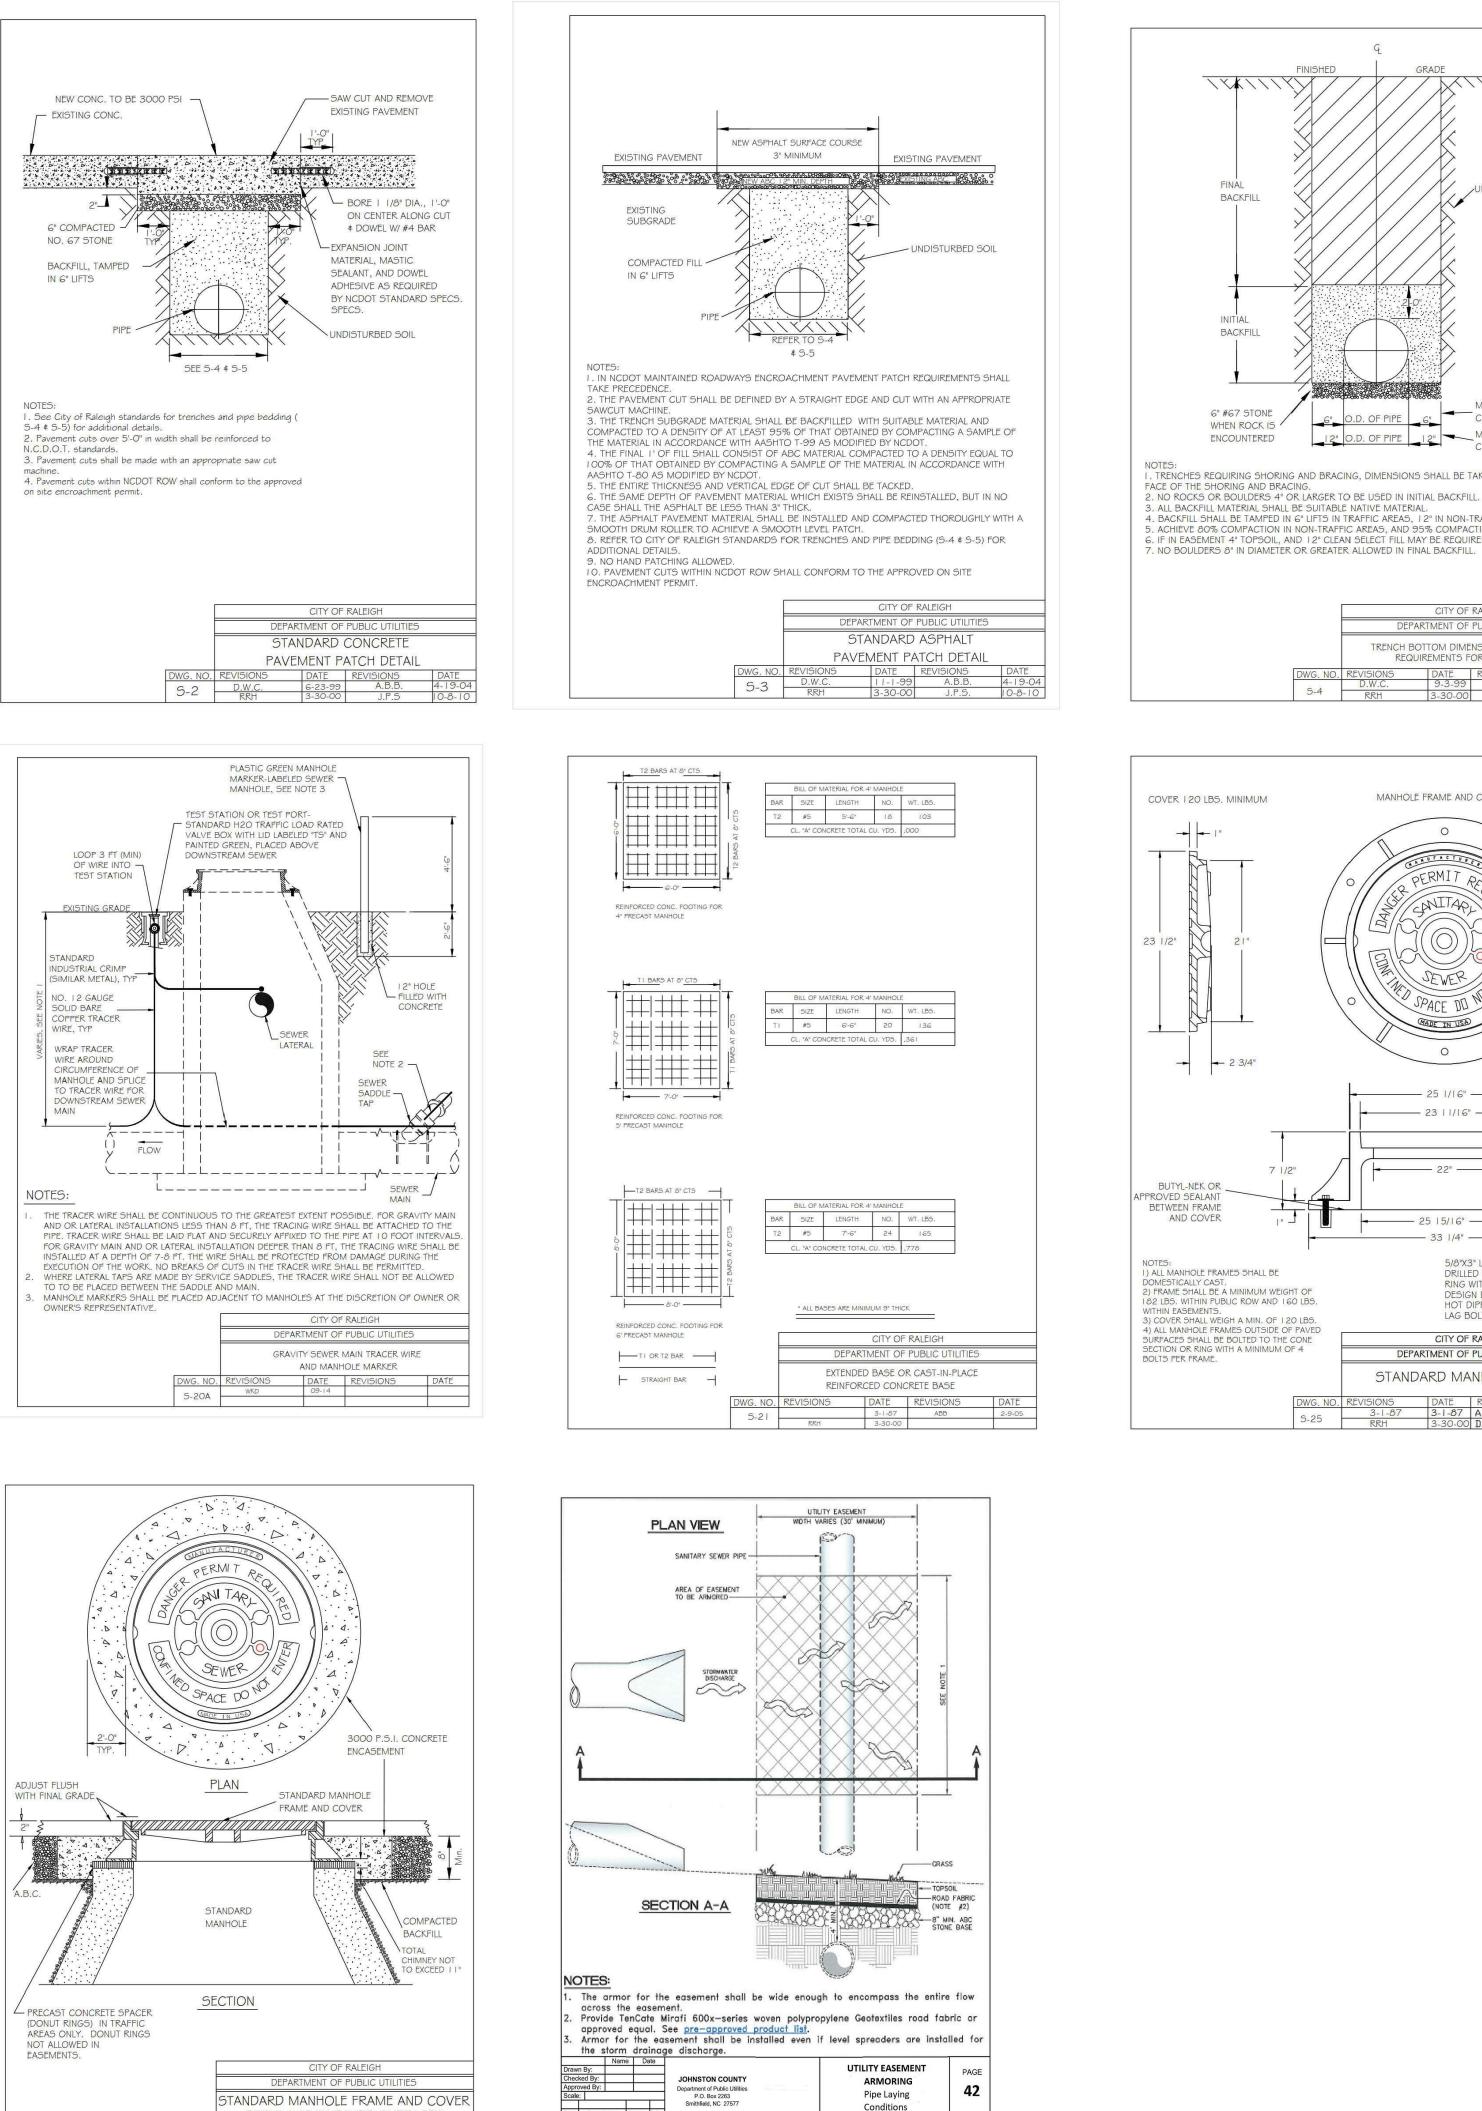













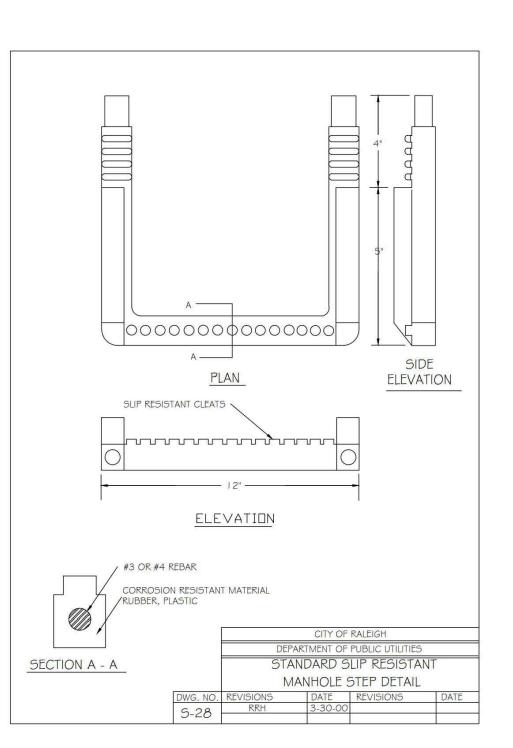

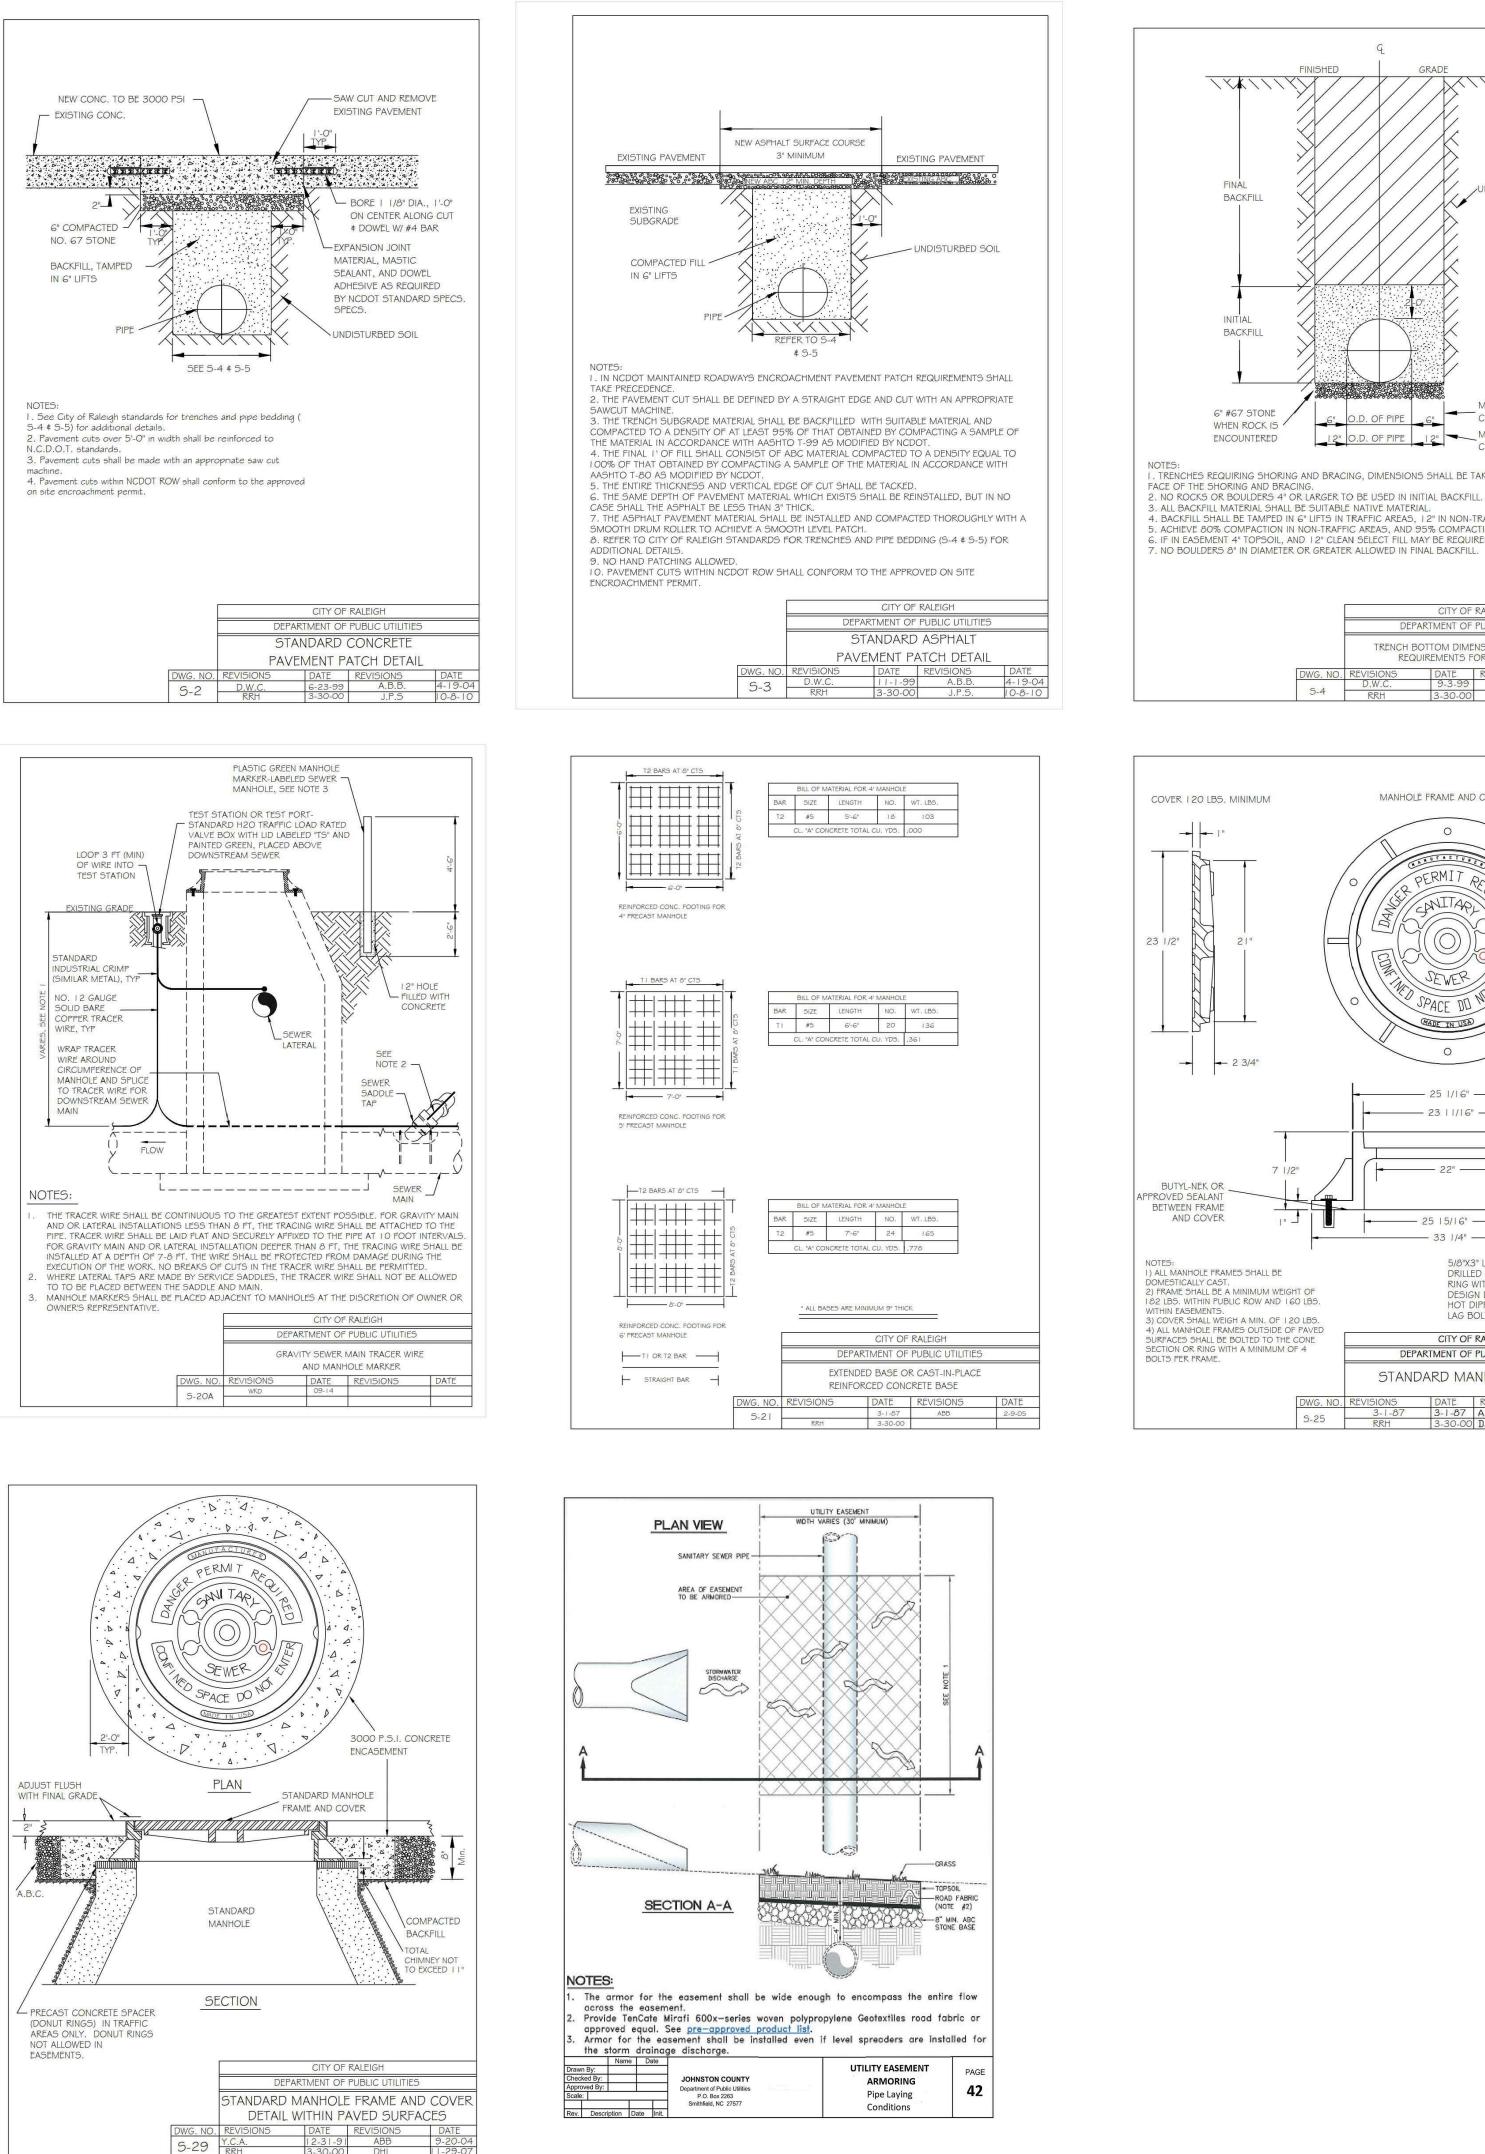

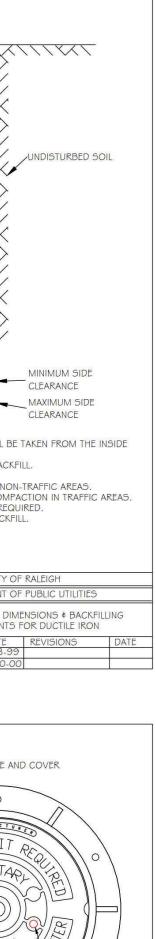

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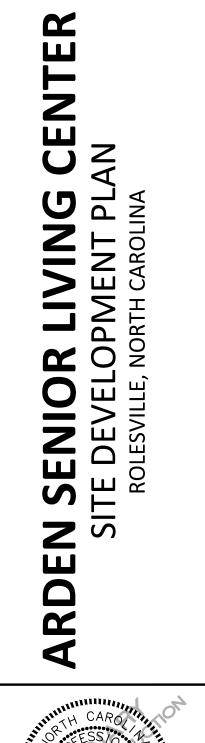
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#### CLIENT
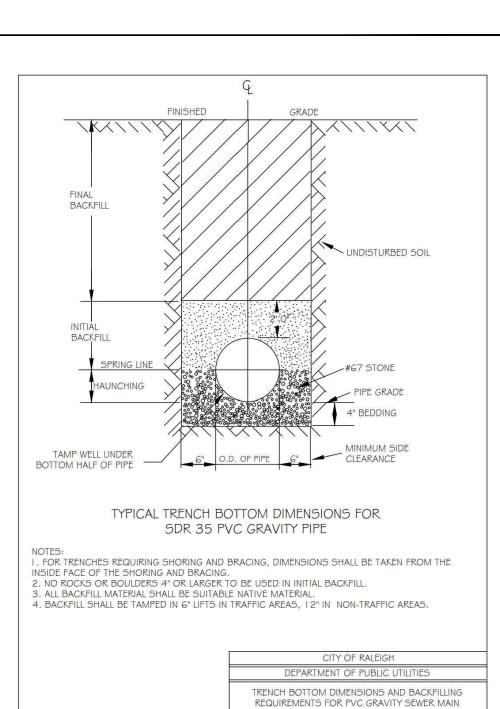
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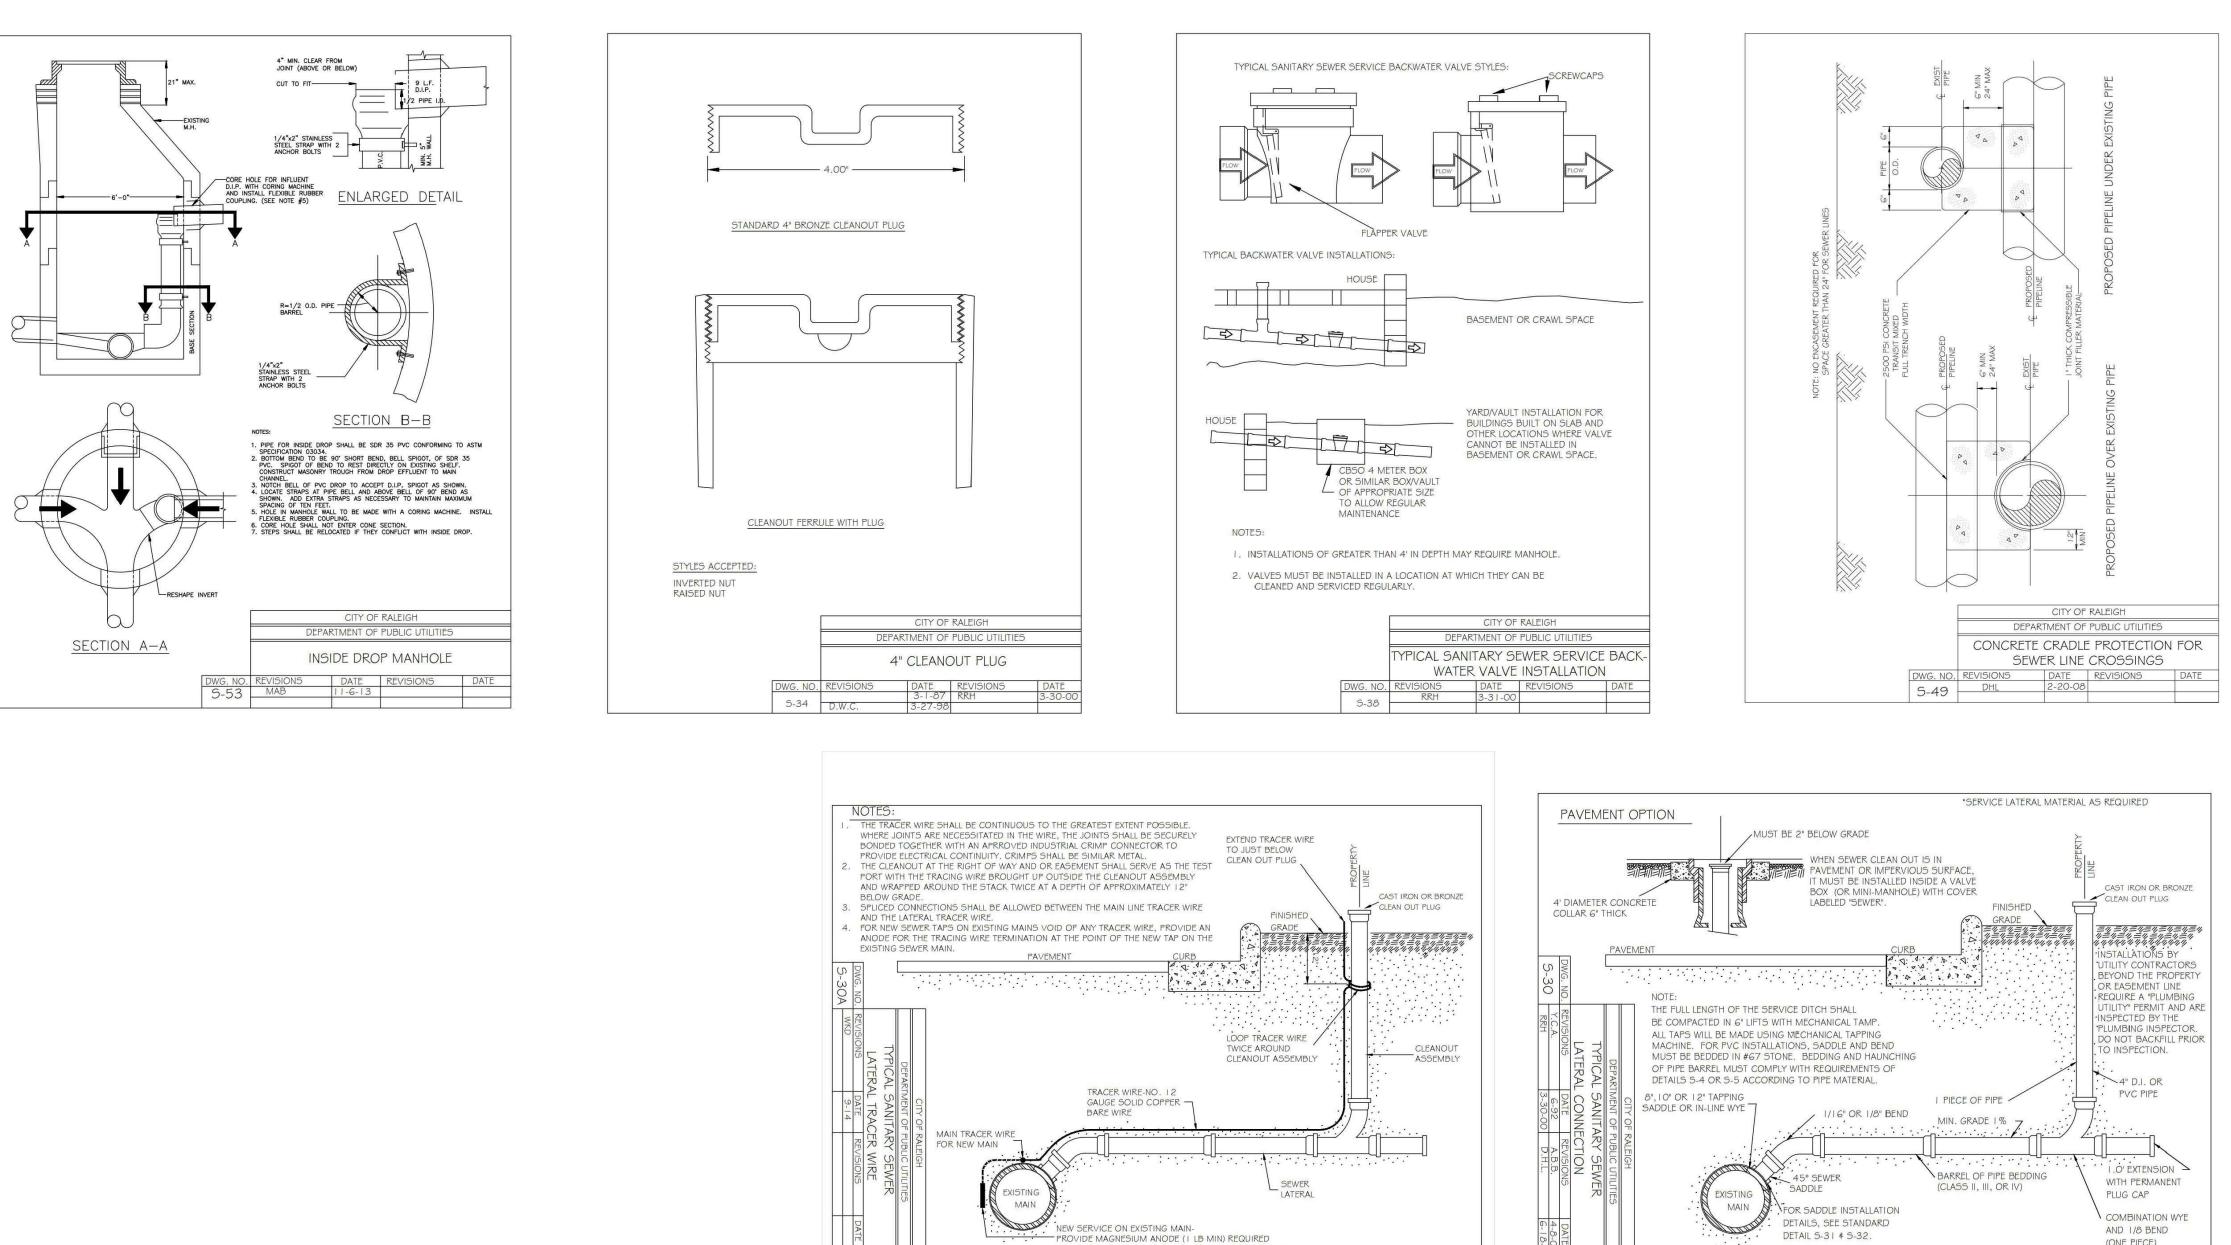
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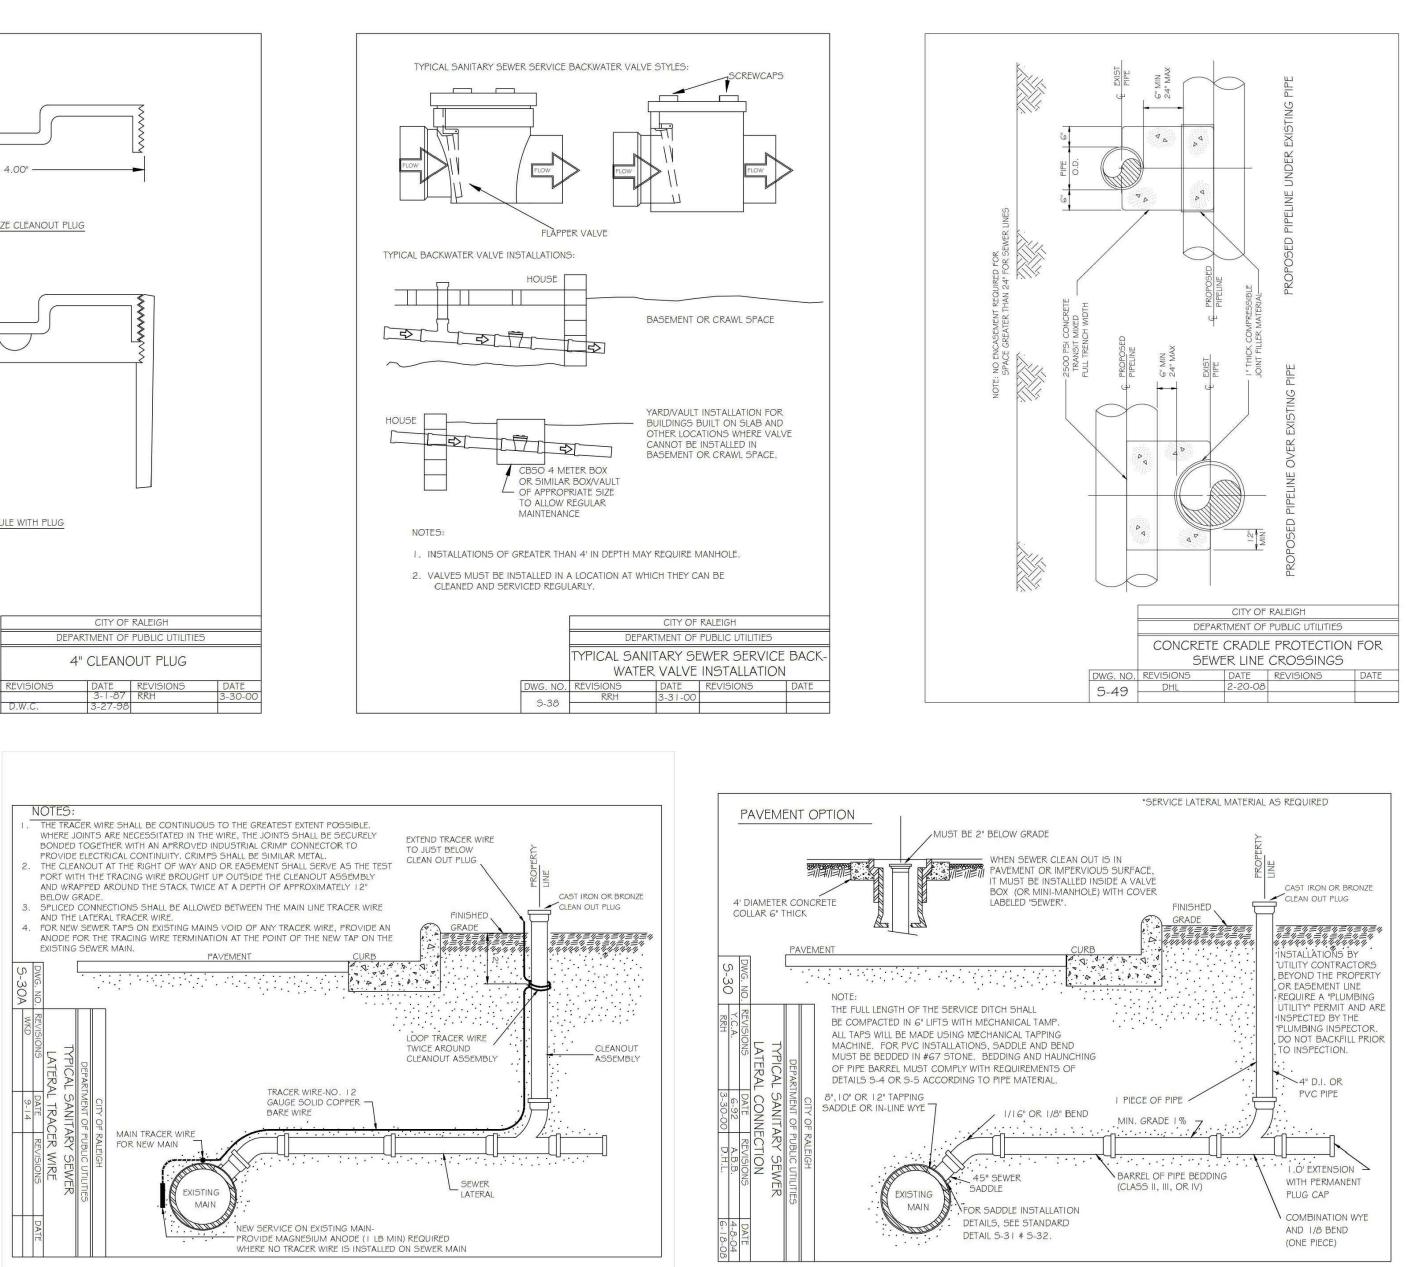
### **PLAN INFORMATION**

PROJECT NO.	SPEC-23422
FILENAME	SPEC23422-D1
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SCALE	N.T.S.
DATE	01. 03. 2024
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**SEWER DETAILS** 









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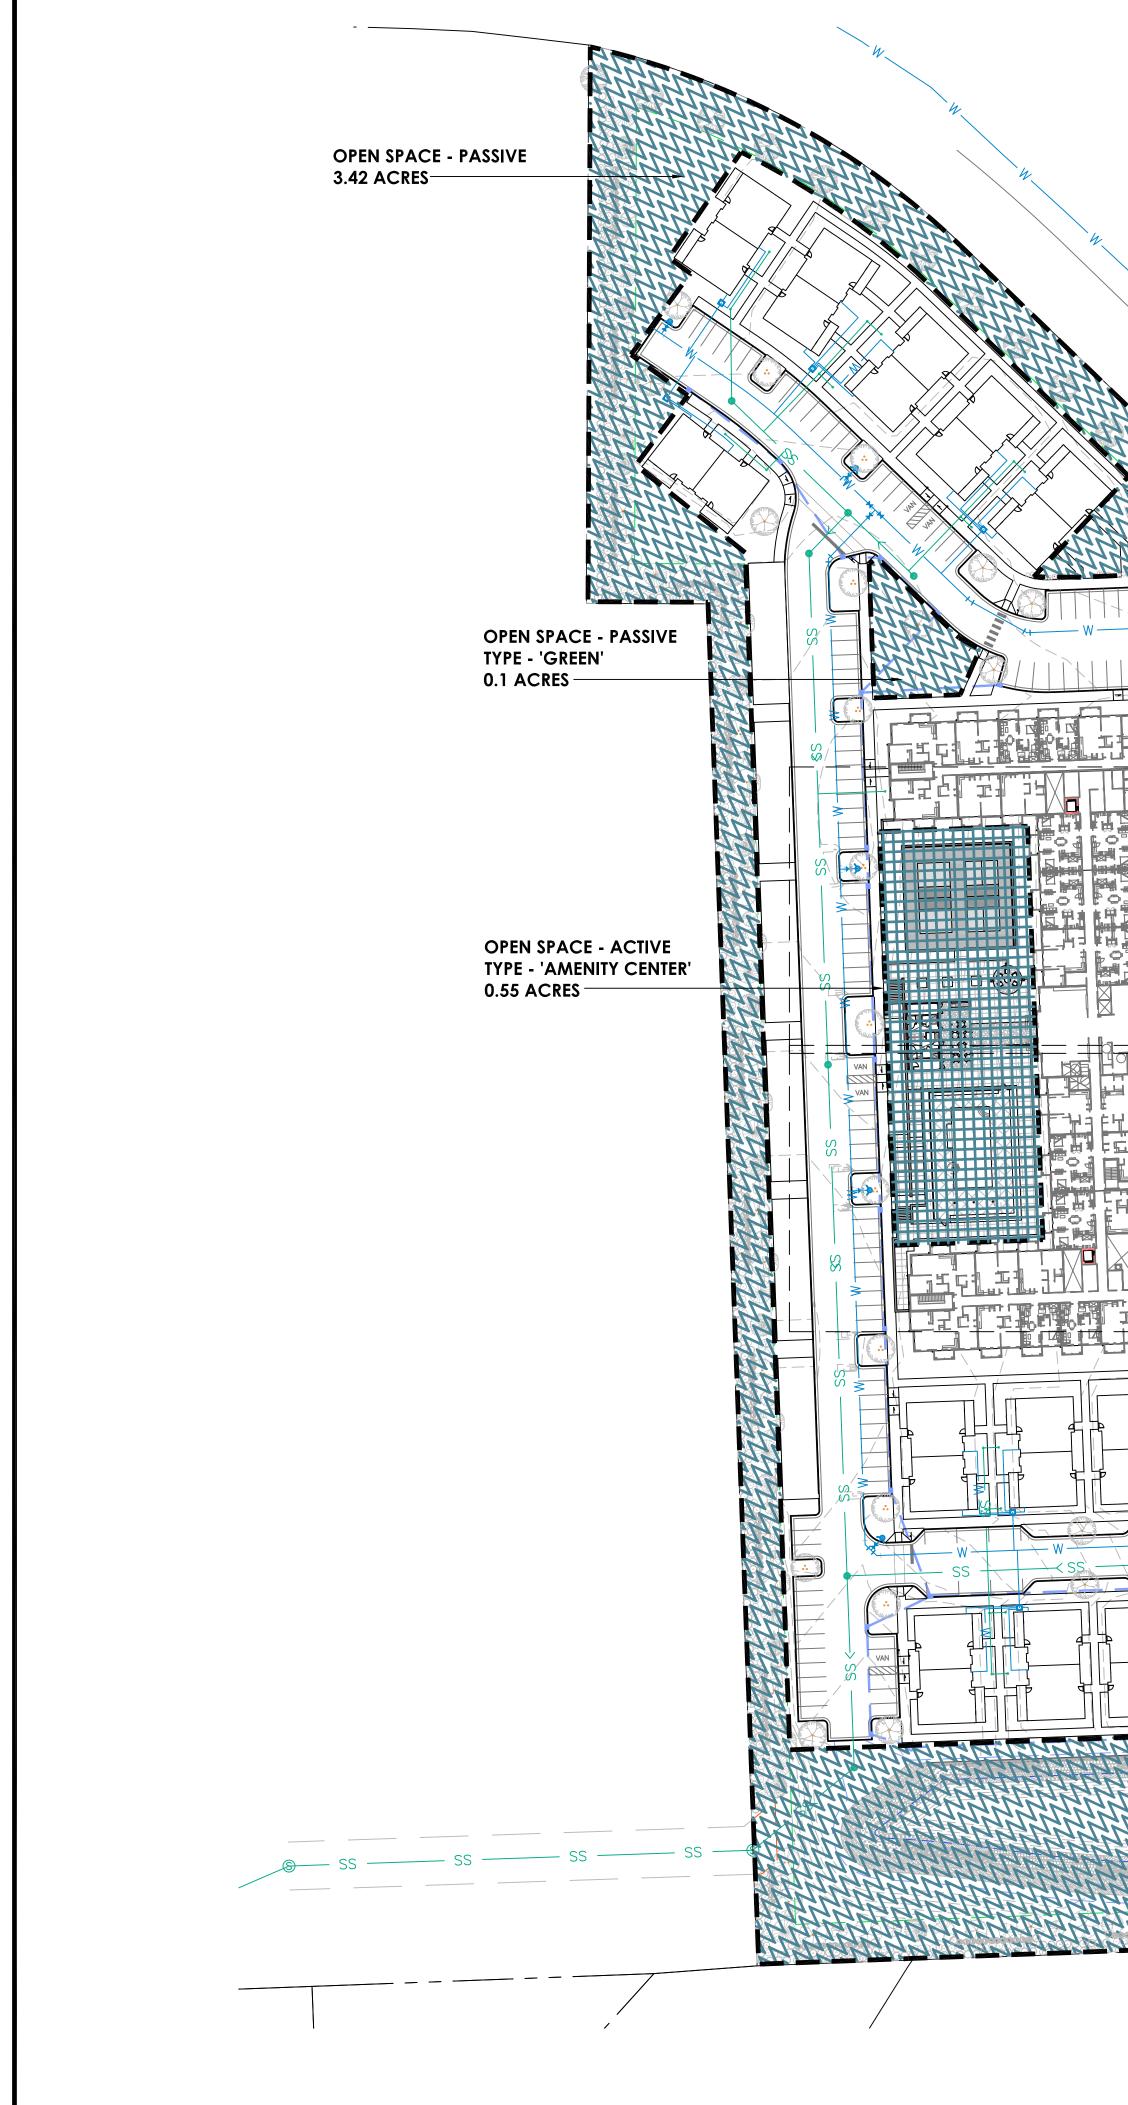
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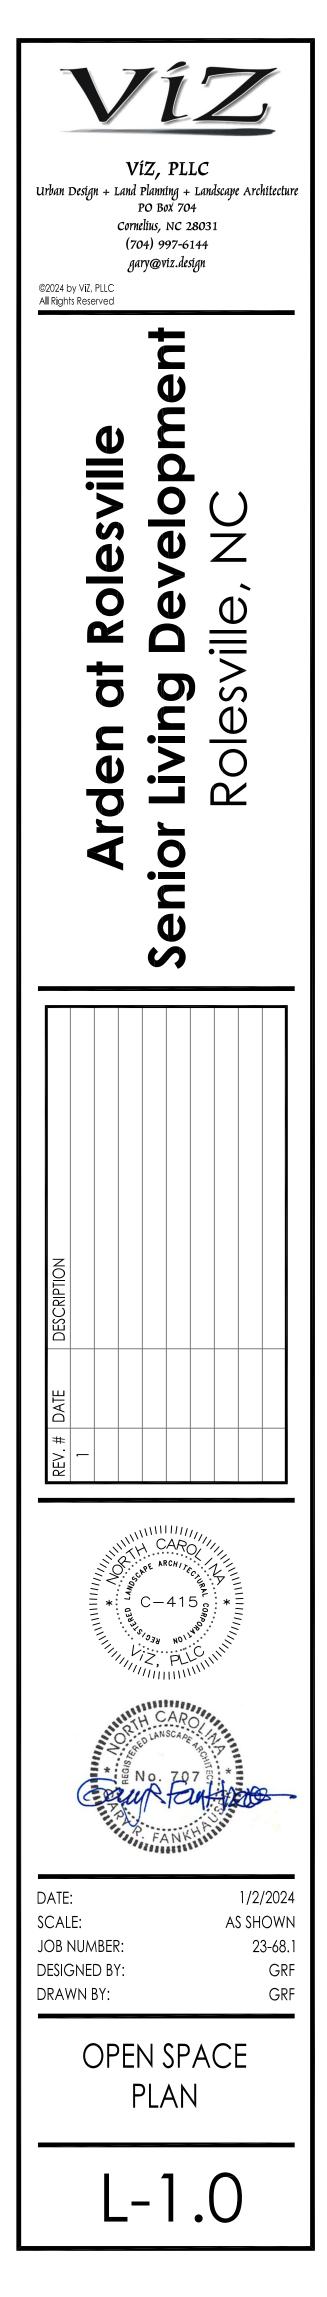
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PROJECT NO.	SPEC-23422

SEWER DETAILS






TOWN OF ROLESVILLE OPEN SPACE NOTES: 1. ALL PLANTING AND LANDSCAPE SHALL BE IN ACCORDANCE WITH ARTICLE 6.2 OF THE TOWN OF ROLESVILLE LAND DEVELOPMENT ORDINANCE. 2. SEE CIVIL ENGINEERING DRAWINGS FOR REQUIRED TREE CONSERVATION AREAS, AND BUFFER LOCATIONS/DIMENSIONS IF APPLICABLE. 3. ALL PLANT MATERIAL SHALL BE NATIVE, AND AS REQUIRED IN SECTION 6.2.4. 4. LDO SECTION 6.2.1 - OPEN SPACE: SITE ACREAGE = 10.4 ACRES @ 15% OPEN SPACE REQUIRED = 1.56 ACRES. OPEN SPACE DEVELOPMENTS REQUIRED = ONE SMALL AND ONE MEDIUM OPEN SPACE PROVIDED = 4.31 ACRES ACTIVE OPEN SPACE PASSIVE OPEN SPACE 12121212 - OPEN SPACE - PASSIVE TYPE - 'GREEN'  $\setminus$  0.1 ACRES _ _ _ - OPEN SPACE - PASSIVE TYPE - 'GREEN' 0.14 ACRES 60' 30' SCALE 1"=60'-0"







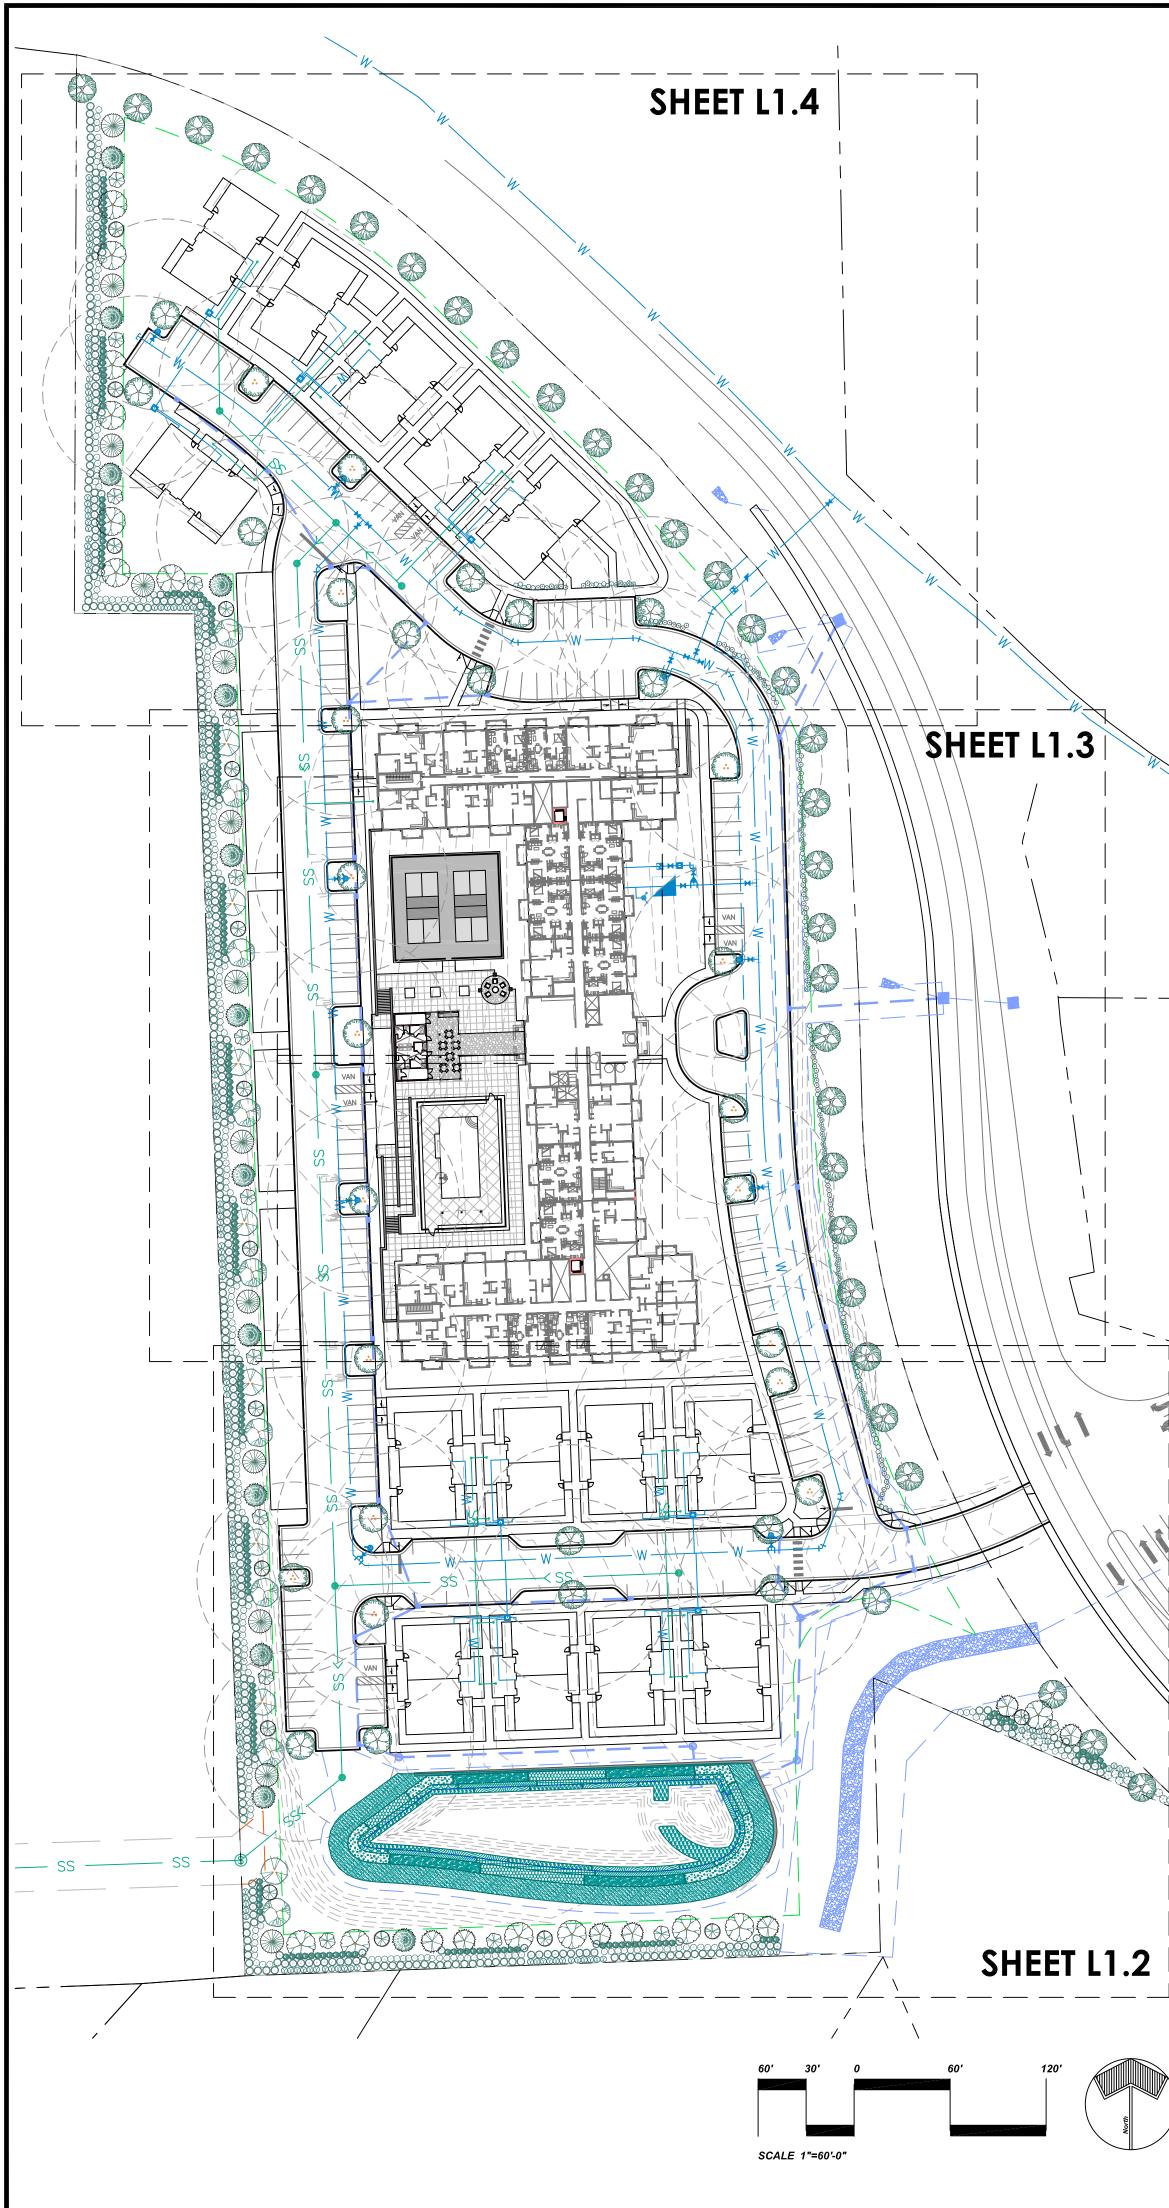


## PLANT SCHEDULE


	PLANT S	CHED	ULE				PLANT SPECIES NOTES:
	<u>SYMBOL</u> <u>TREES</u>	<u>CODE</u>	BOTANICAL NAME	COMMON NAME	<u>SIZE</u>	<u>QTY</u>	<ol> <li>AS REQUIRED ALL F ROLESVILLE LDO. PI</li> <li>ALL PLANT MATERIA THROUGHOUT NOF</li> </ol>
		Ar	Acer rubrum	Red Maple	2" Cal.	9	TOWN OF ROLESVILLE LA1. ALL PLANTING AND ROLESVILLE LAND D
		Bd	Betula nigra 'BNMTF' TM	Dura Heat River Birch	2" Cal.	8	<ol> <li>SEE CIVIL ENGINEEI LOCATIONS/DIMEN</li> <li>ALL PLANT MATERIA</li> <li>ALL IRRIGATION SH</li> </ol>
		Cf	Cercis canadensis `Forest Pansy` TM	Forest Pansy Redbud	1" Cal.	16	<ul> <li>4. ALL INNIGATION STI</li> <li>5. LDO SECTION 6.2.1 SITE ACREAGE = OPEN SPACE DEV</li> <li>6. LDO SECTION 6.2.2</li> </ul>
		Ср	Cornus florida `Cherokee Princess`	Cherokee Princess Dogwood	1" Cal.	15	<ul> <li>TYPE 3 PERIMETER</li> <li>30' STREET BUFFER</li> <li>100 SECTION 6.2.4</li> <li>ALL PARKING SPA</li> </ul>
		lc	llex opaca `Carolina #2`	Carolina #2 American Holly	2" Cal.	13	PARKING PERIMET GREATER THAN TH
	HUNING	Le	Liriodendron tulipifera 'JFS-Oz' TM	Emerald City Tulip Poplar	2" Cal.	14	NOTES: 1. SEE SHEETS L-1.2 - 2. CONTRACTOR TO QUANTITIES SHOW
		Mg	Magnolia grandiflora `Claudia Wannamaker`	Claudia W. Southern Magnolia	2" Cal.	13	LEGEND QUANTITI 3. PLANTS SHALL ON ALLOWED. 4. SEE CIVIL ENGINE
//	man and a construction	Pi	Pinus taeda	Loblolly Pine	2" Cal.	7	5. THE CONTRACTO THE LOCATION OF WHERE SHOWN A
		Ро	Platanus occidentalis	American Sycamore	2" Cal.	16	ADDITIONAL COS NO CLAIMS FOR E FROM THE PRESEN REMOVAL OR REA
		QI	Quercus lyrata	Overcup Oak	2" Cal.	18	DAMAGES TO UN CONTACTING ALL 6. ALL DISTURBED AR 7. THE LANDSCAPE (
-		Qa	Quercus rubra 'Aurea'	Aurea Red Oak	2" Cal.	32	TRANSITION BETW 8. ALL PLANTING AN STANDARDS.
	SHRUBS	Fa	Fothergilla gardenii `Mt. Airy`	Mt. Airy Dwarf Witchalder	3 gal.	192	
	E Constant	Hb	Hydrangea quercifolia `Brenhill`	Gatsby Gal® Oakleaf Hydrangea	3 gal.	183	
		ld	Ilex glabra 'Densa'	Inkberry Holly	3 gal.	196	
 		In	Ilex vomitoria `Nana`	Dwarf Yaupon Holly	3 gal.	66	
	NNNNNNNNNNNNNNNNNNNNNNNNNNNNNNNNNNNNNN	ls	Itea virginica 'Sprich'	Little Henry® Sweetspire	3 gal.	80	
		Kr	Kalmia latifolia 'Raspberry Glow'	Raspberry Glow Mountain Laurel	-	182	
K		Lr Mc	Leucothoe fontanesiana 'Rainbow' Myrica cerifera	Rainbow Drooping Leucothoe Wax Myrtle	3 gal. 3 gal.	81	
		Rc	Rhododendron carolinianum	Carolina Rhododendron	3 gal.	201	
				-	-		

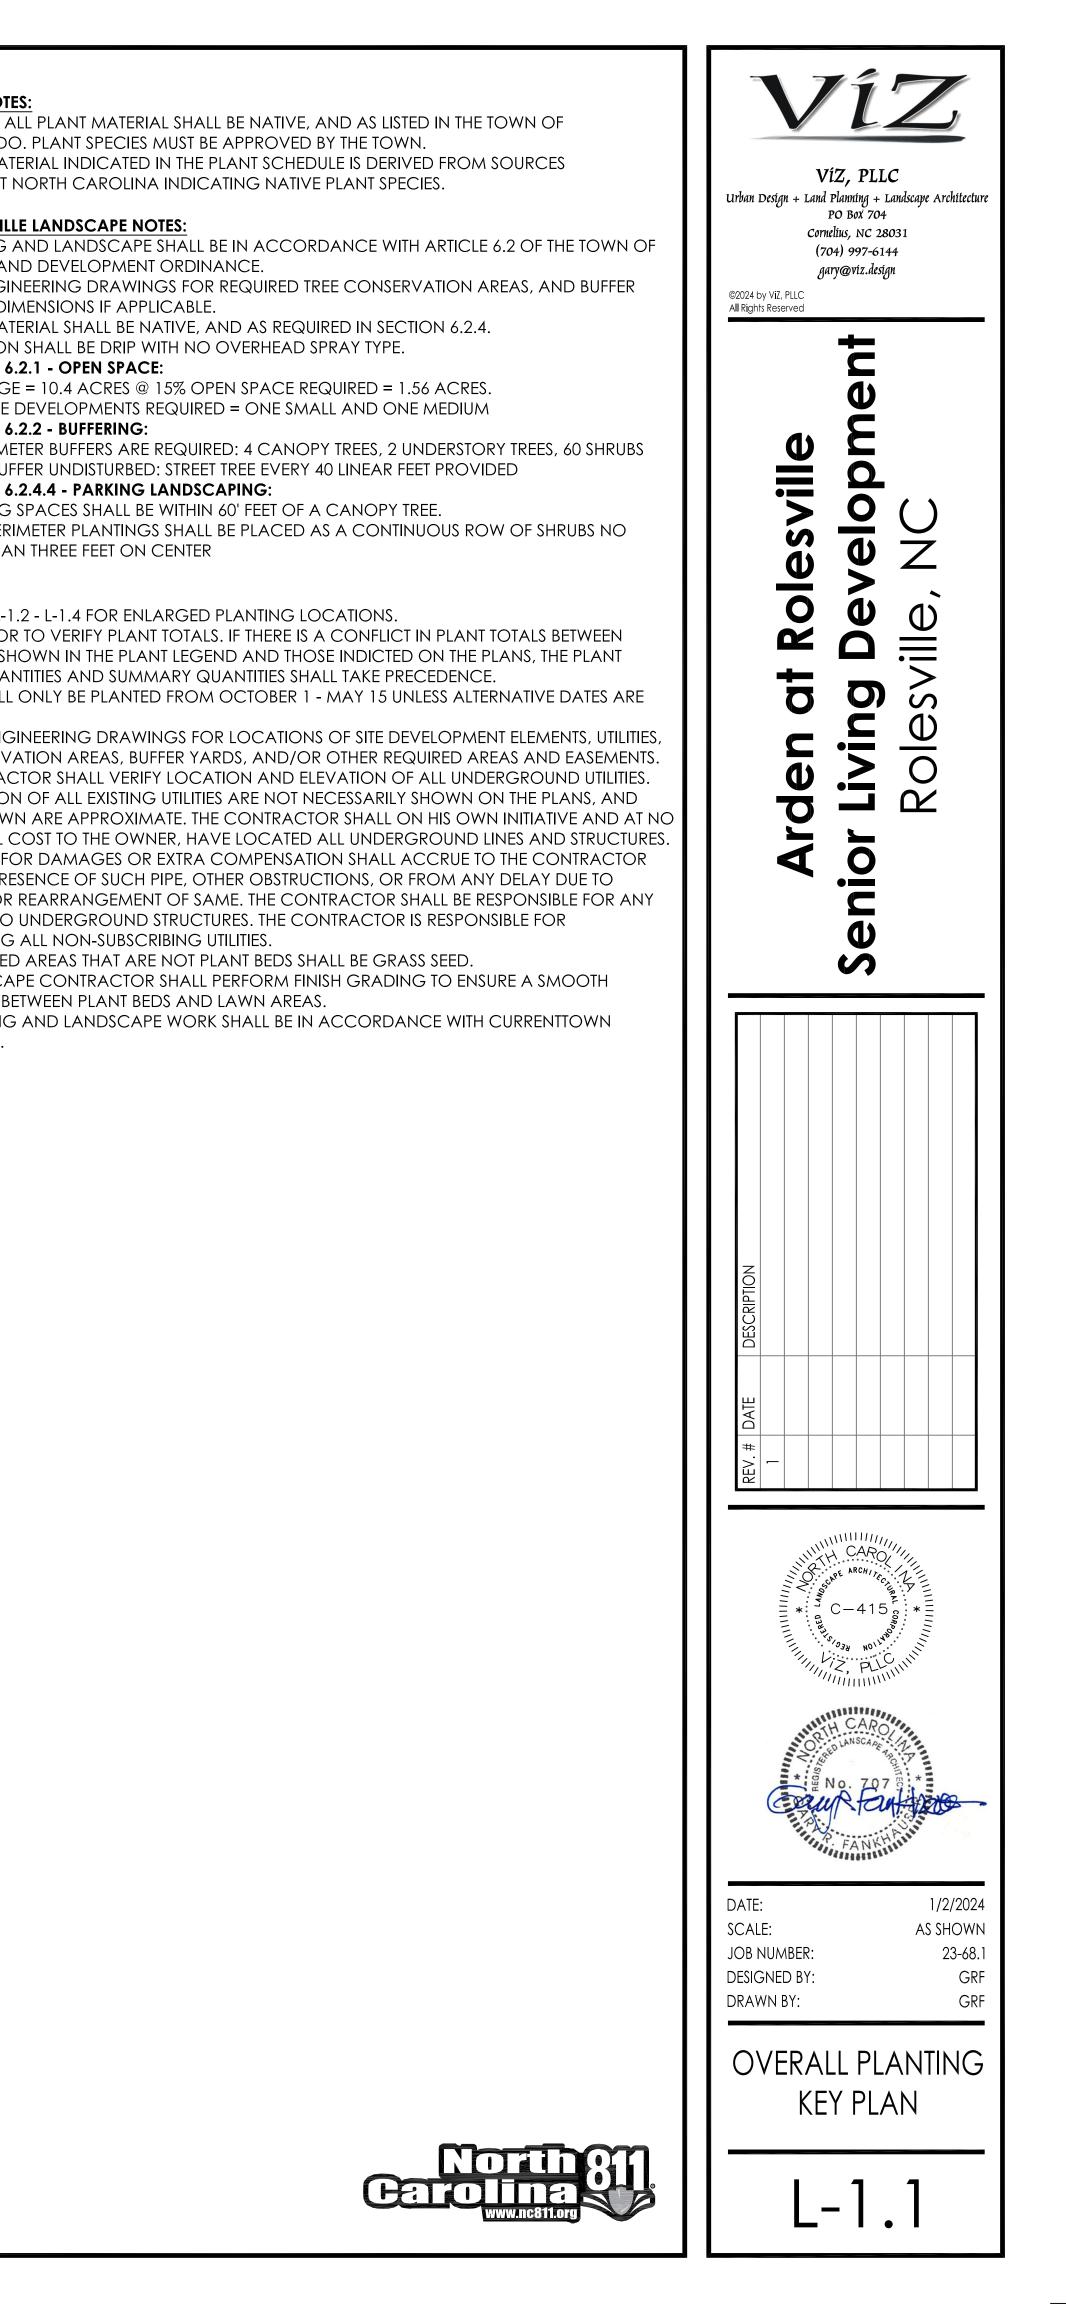

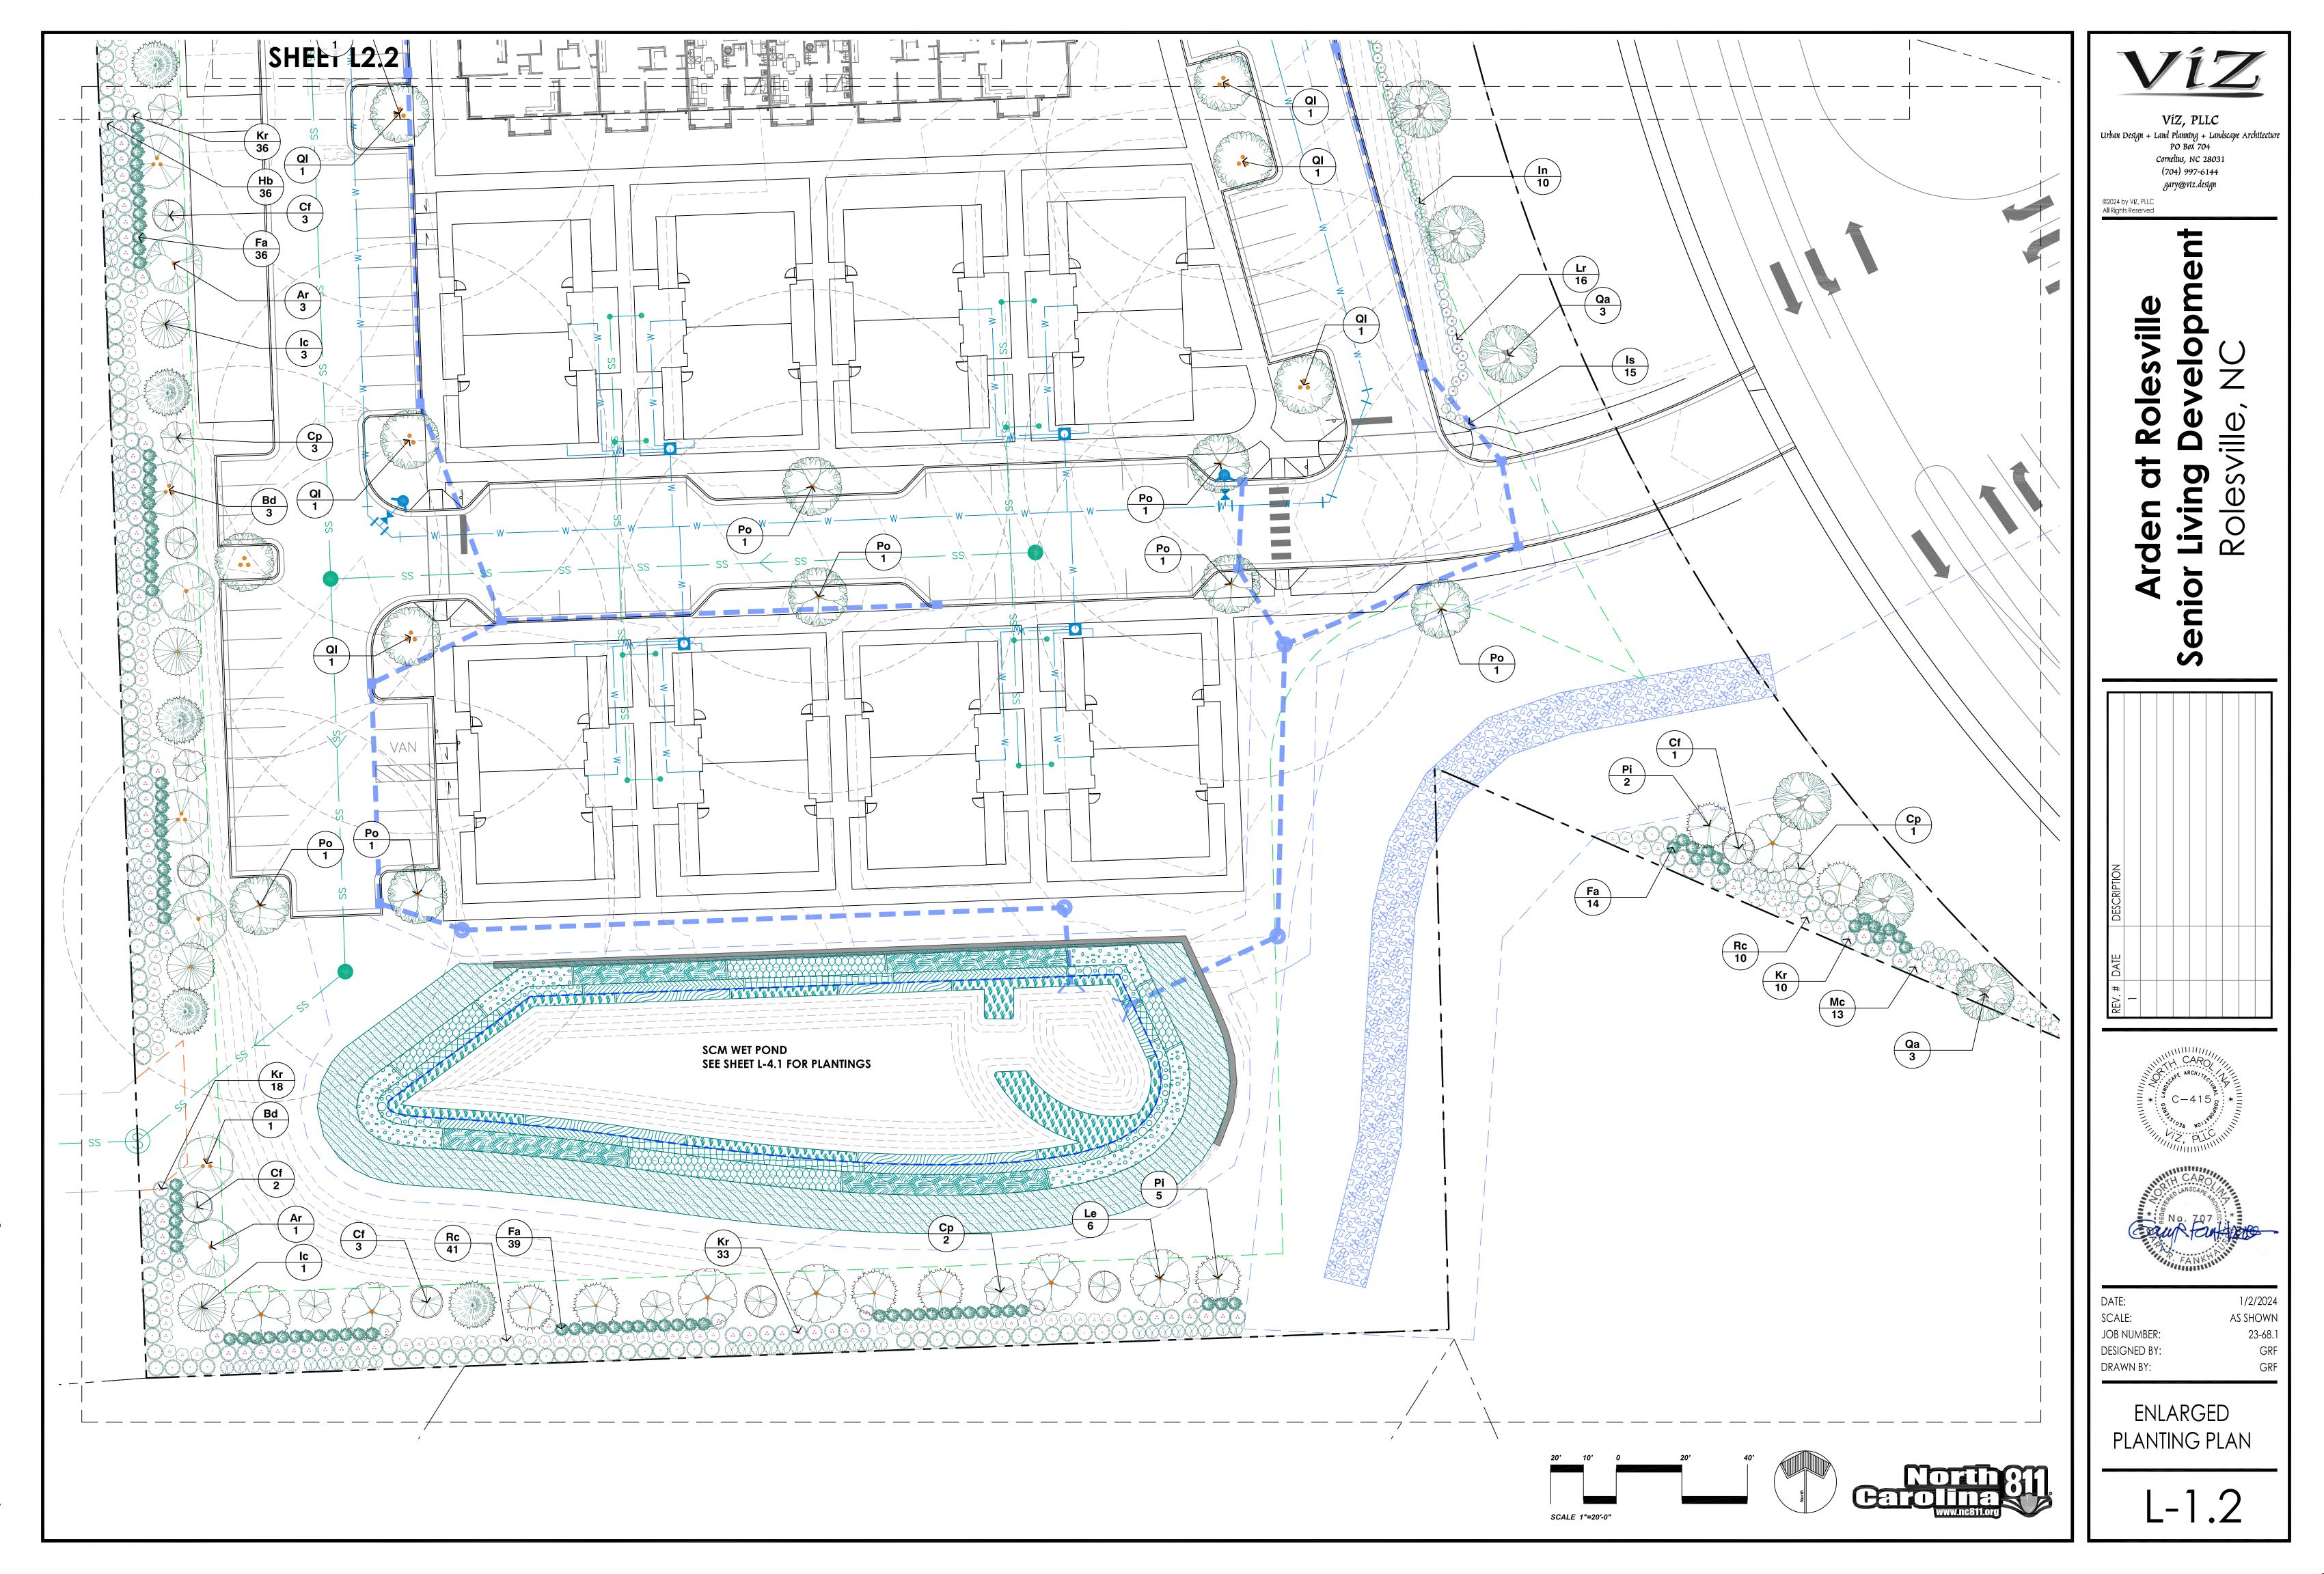

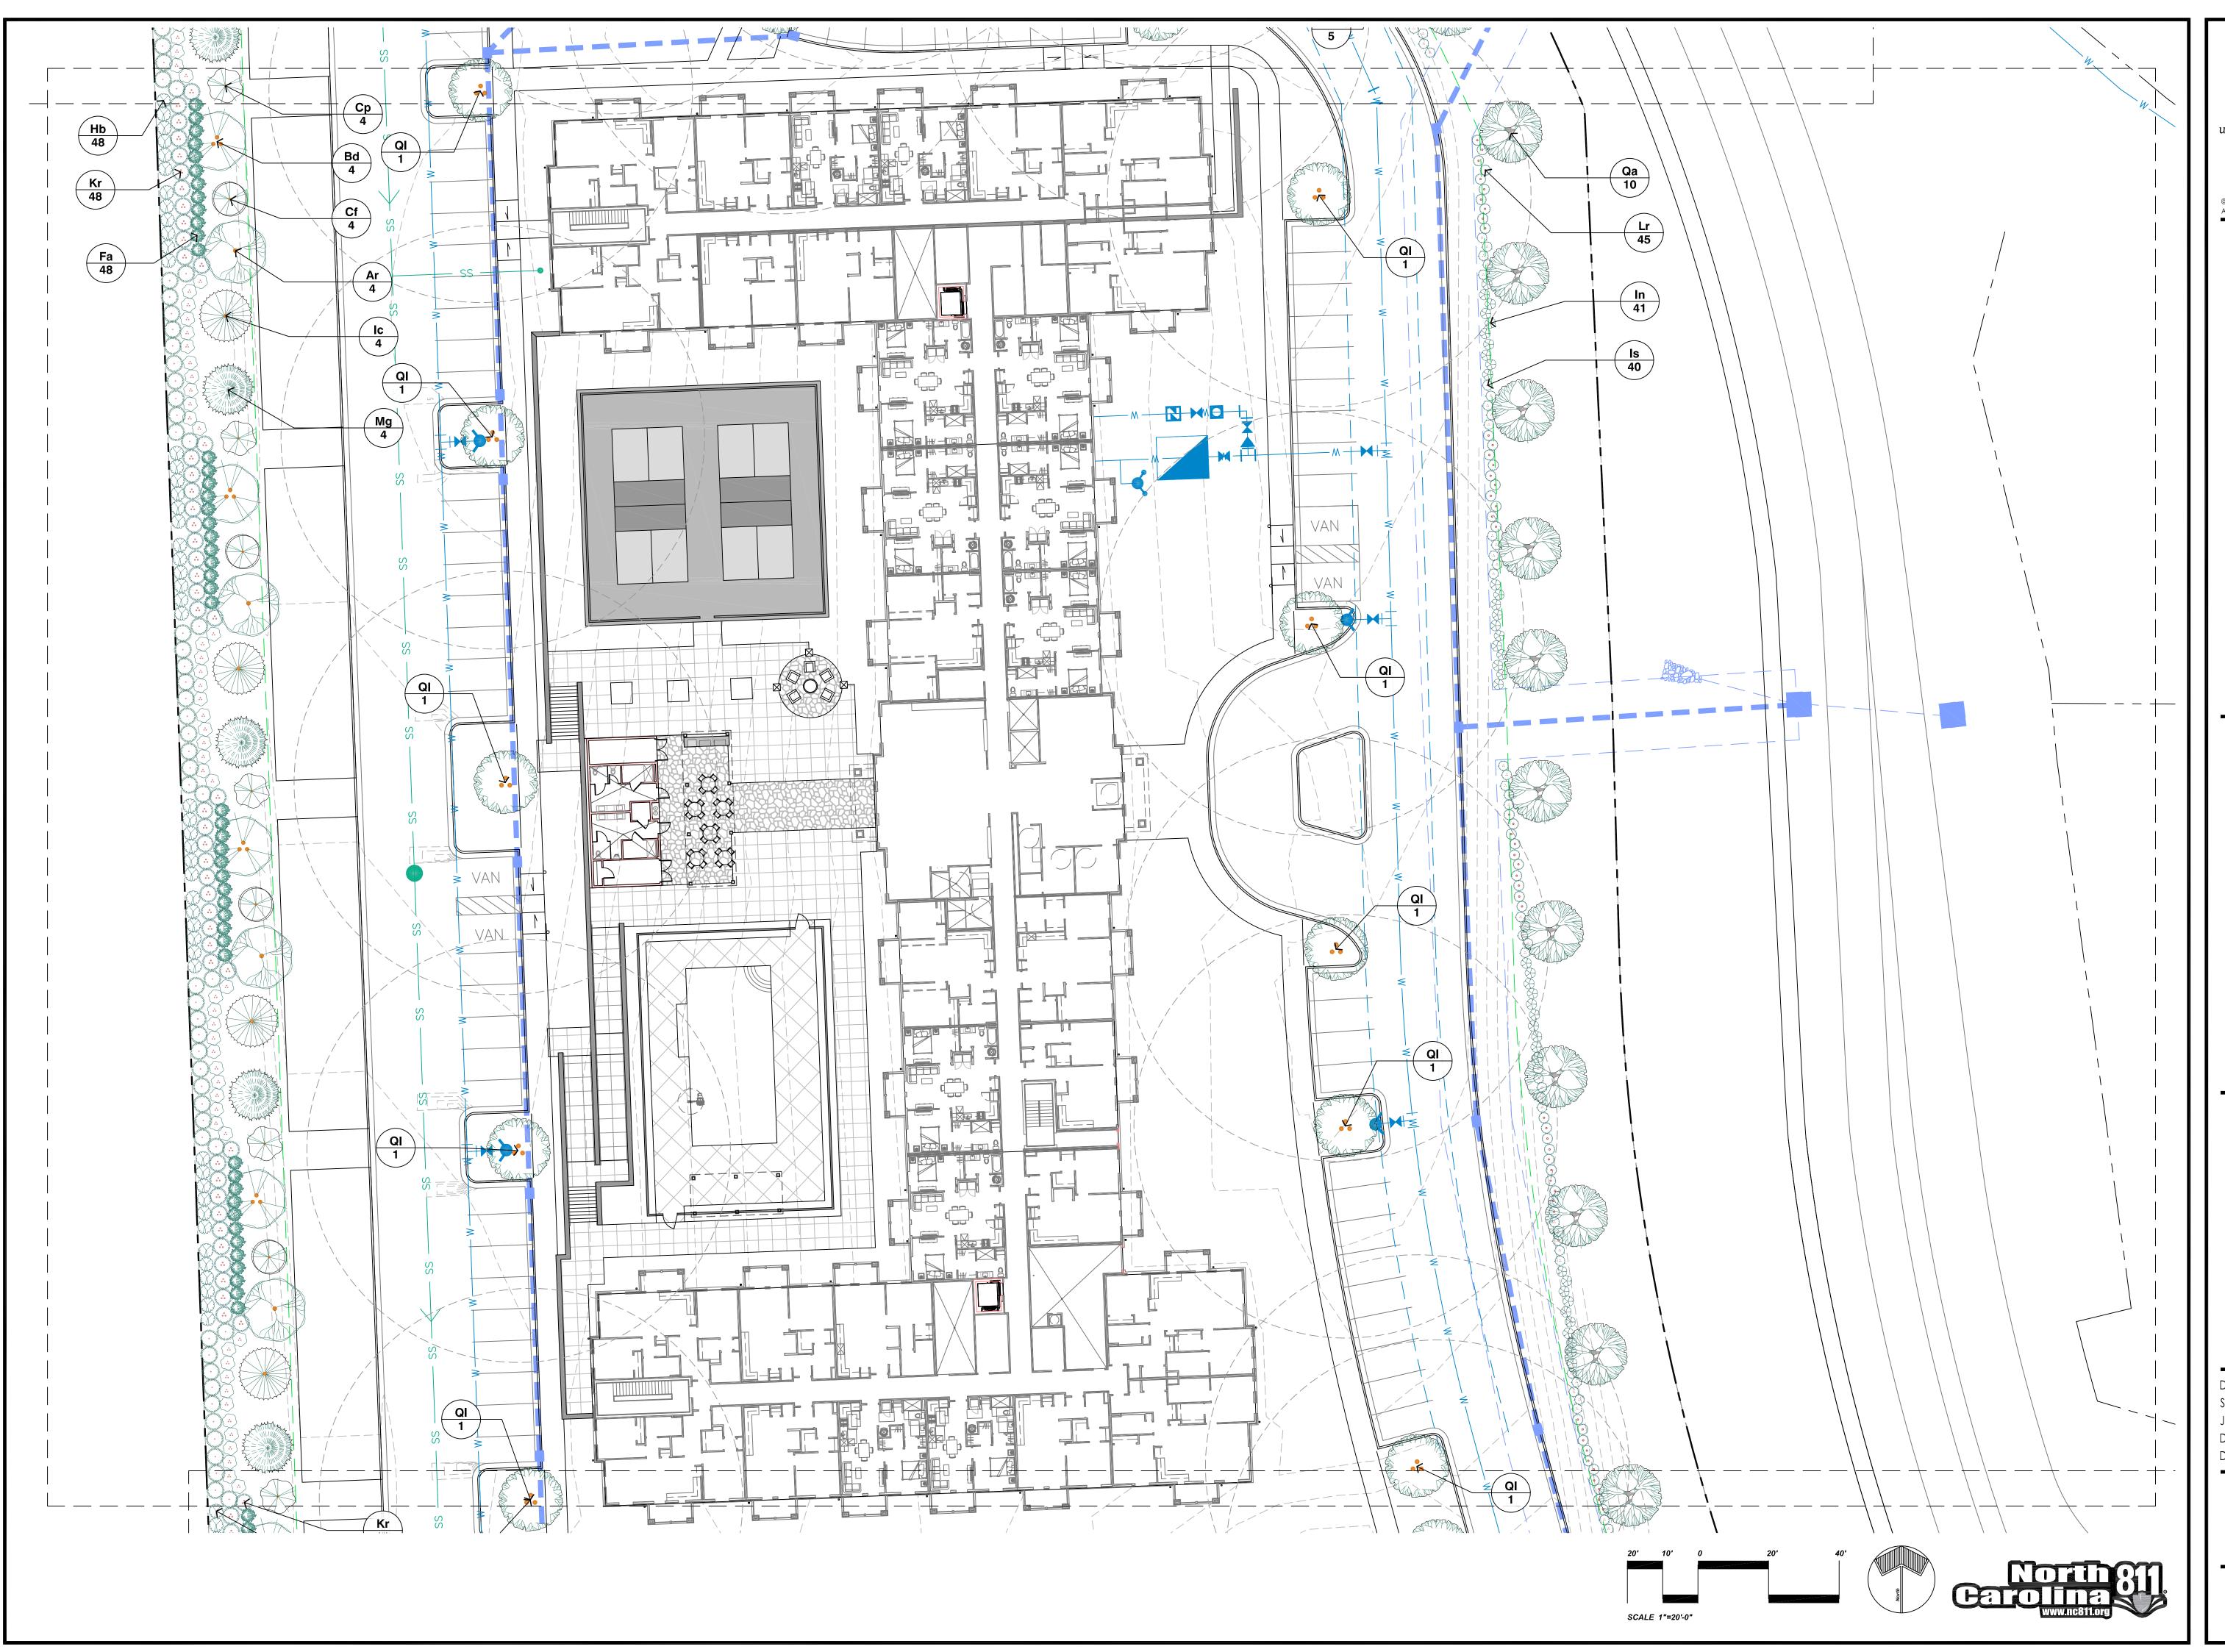

VÍZ, PLLC VÍZ, PLLC Urban Design + Land Planning + Landscape Architecture PO Box 704 Cornelius, NC 28031 (704) 997-6144 gary@viz.design ©2024 by VIZ, PLLC				
Senior Living Development Rolesville, NC				
REV. #       DATE       DESCRIPTION         1           1           DATE: 1/2/2024 SCALE: AS SHOWN JOB NUMBER: 23-68.1 DESIGNED BY: GRF				
DRAWN BY: GRF ENLARGED PLANTING PLAN L-1.3				

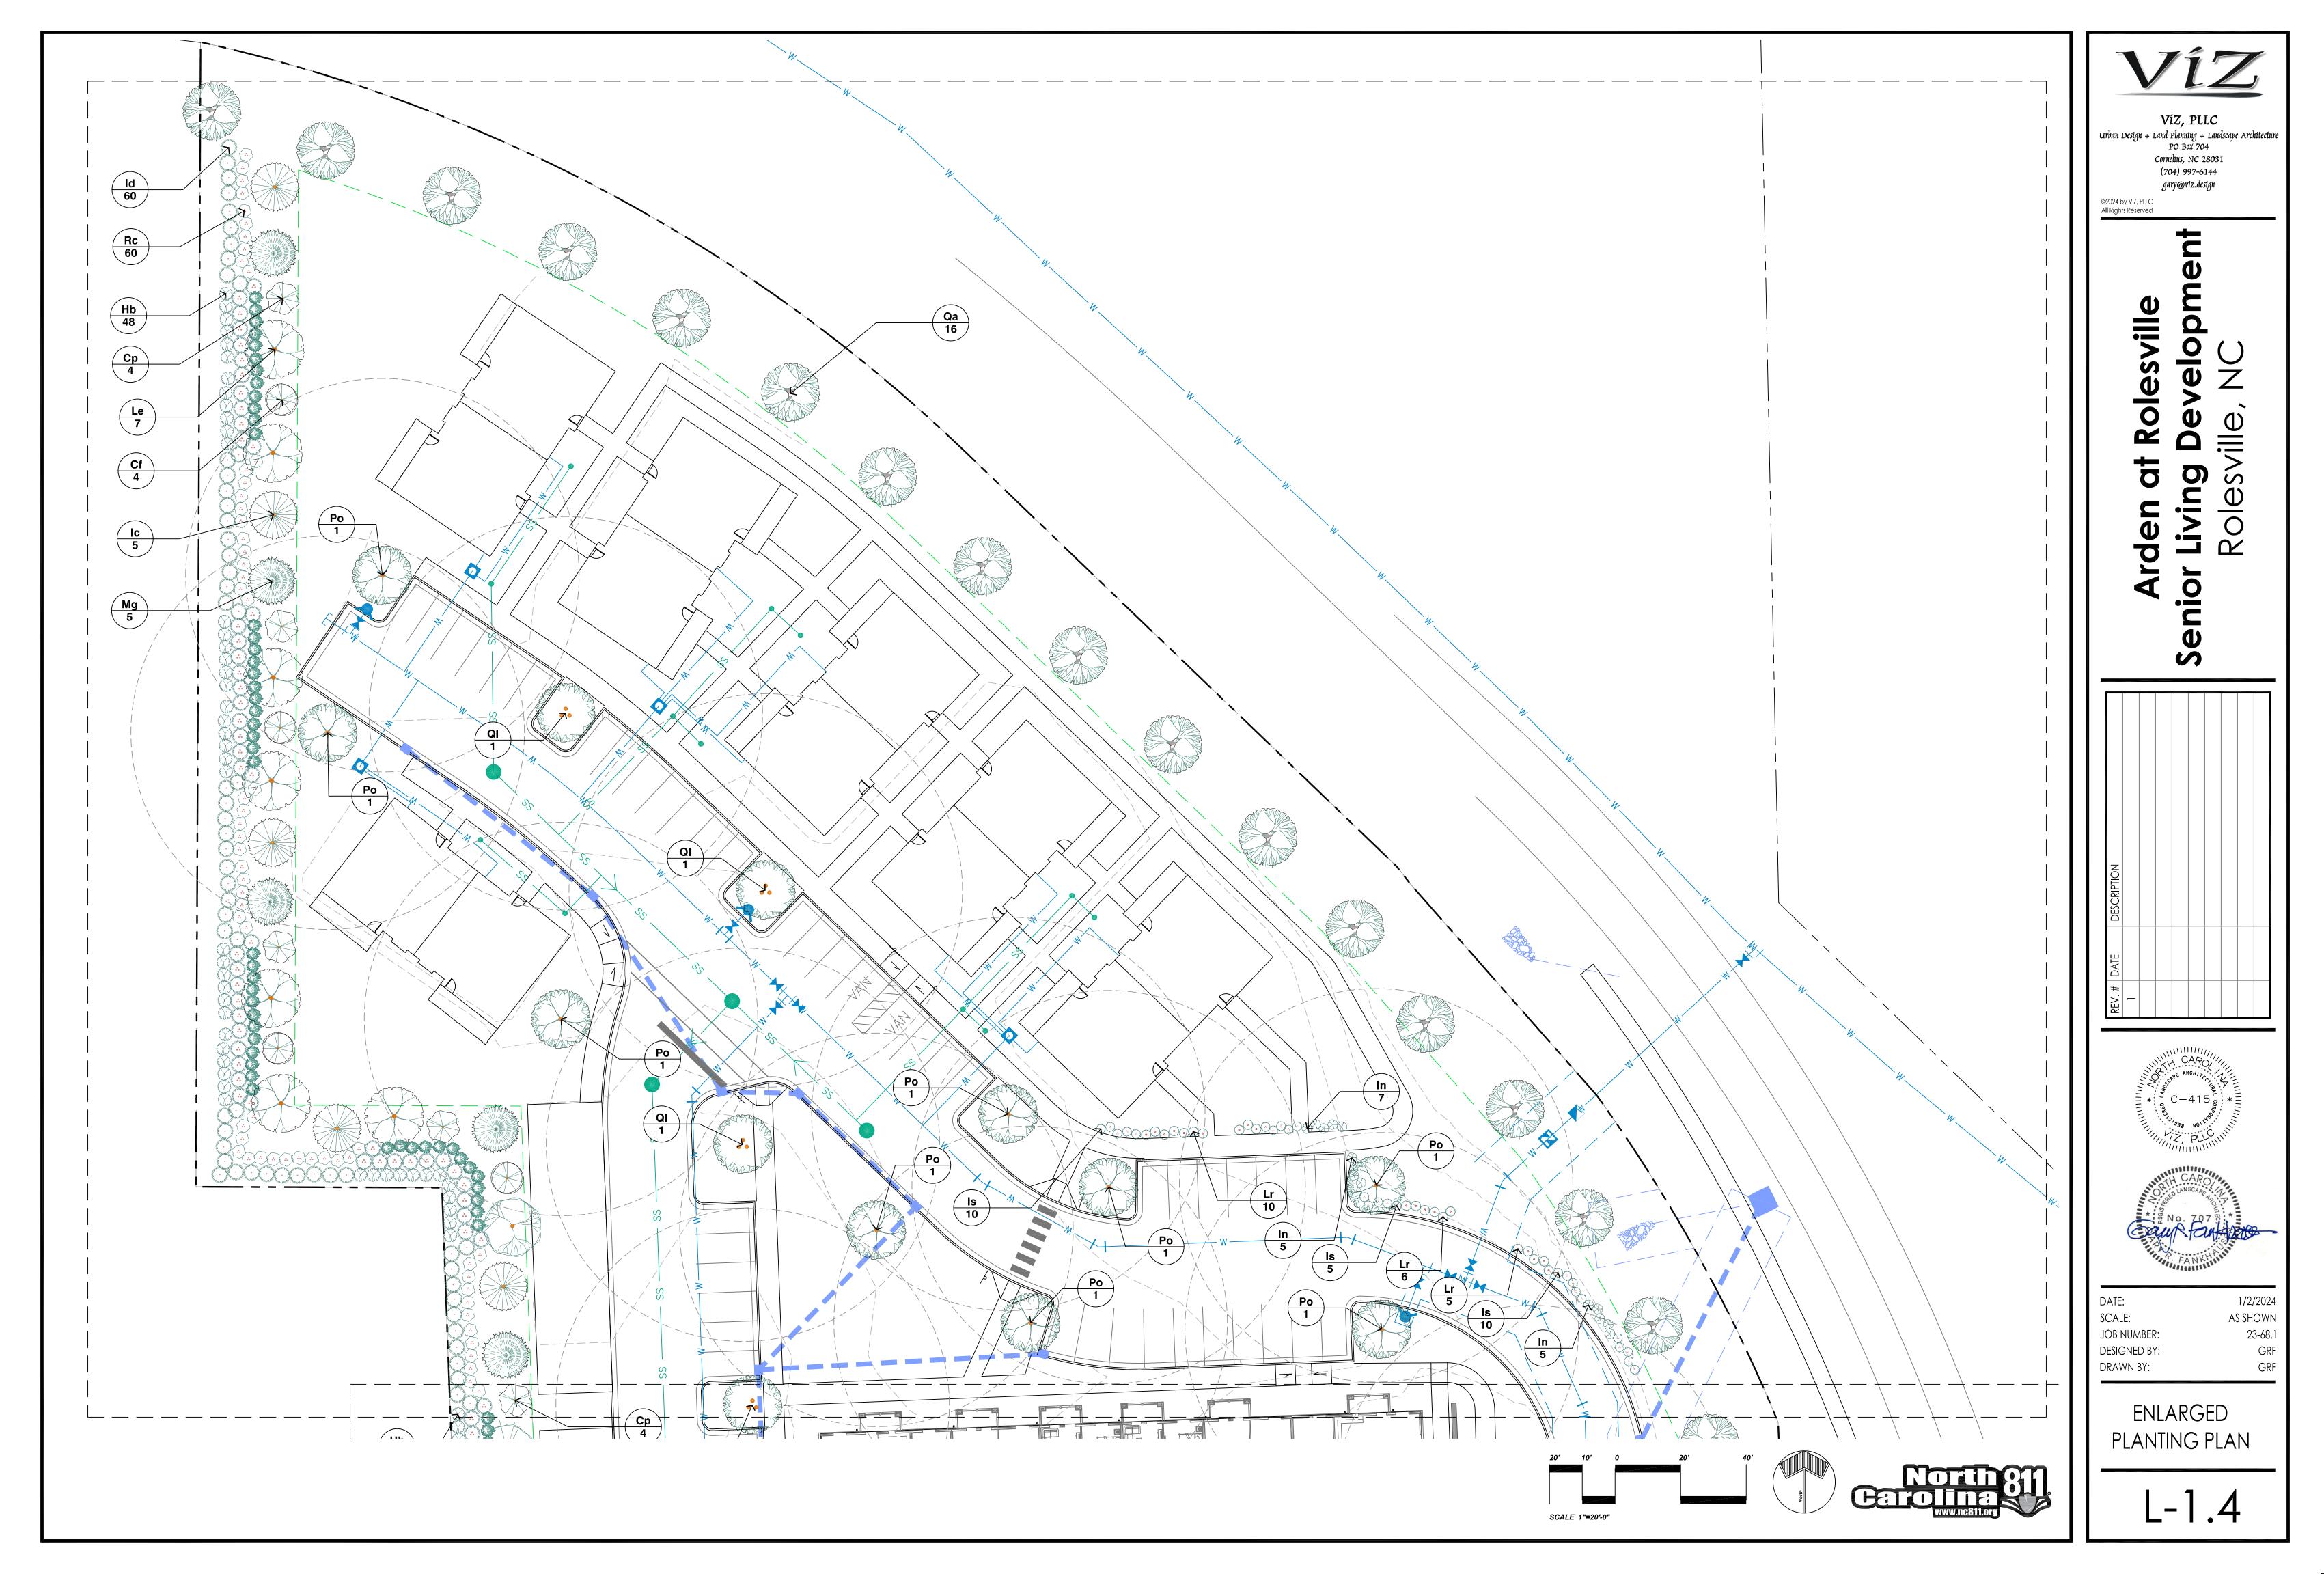



#### IRRIGATION SPECIFICATIONS

- PERFORMANCE REQUIREMENTS: IRRIGATION ZONE CONTROL SHALL BE AUTOMATIC OPERATION WITH CONTROLLER AND AUTOMATIC CONTROL VALVES.
- **DELEGATED DESIGN:** DESIGN 100 PERCENT COVERAGE IRRIGATION SYSTEM
- USING PERFORMANCE REQUIREMENTS AND DESIGN CRITERIA INDICATED. MINIMUM WORKING PRESSURES: THE FOLLOWING ARE MINIMUM PRESSURE REQUIREMENTS FOR PIPING, VALVES, AND SPECIALTIES UNLESS OTHERWISE INDICATED: IRRIGATION MAIN PIPING: 65 PSI; CIRCUIT PIPING: 40 PSI.
- 4. ACTION SUBMITTALS: A. PRODUCT DATA: FOR EACH TYPE OF PRODUCT INDICATED. INCLUDE RATED CAPACITIES, OPERATING CHARACTERISTICS AND FURNISHED SPECIALTIES AND ACCESSORIES.
- B. SUSTAINABLE DESIGN SUBMITTALS: WATER CONSERVING AND LOW-FLOW MEASURES
- C. WIRING DIAGRAMS: FOR POWER, SIGNAL, AND CONTROL WIRING
- D. DELEGATED-DESIGN SUBMITTAL: FOR IRRIGATION SYSTEMS INDICATED TO COMPLY WITH PERFORMANCE REQUIREMENTS AND DESIGN CRITERIA
- CLOSEOUT SUBMITTALS: OPERATION AND MAINTENANCE DATA. 5. QUALITY ASSURANCE ELECTRICAL COMPONENTS, DEVICES, AND ACCESSORIES: LISTED AND LABELED AS DEFINED IN NFPA 70, BY A QUALIFIED TESTING AGENCY, AND MARKED FOR INTENDED LOCATION AND APPLICATION.
- PIPES, TUBES, AND FITTINGS: COMPLY WITH REQUIREMENTS IN THE PIPING SCHEDULE FOR APPLICATIONS OF PIPE, TUBE, AND FITTING MATERIALS, AND FOR JOINING METHODS FOR SPECIFIC SERVICES, SERVICE LOCATIONS, AND PIPE SIZES.
- **AUTOMATIC CONTROL VALVES:**
- BRONZE, AUTOMATIC CONTROL VALVES: CAST-BRONZE BODY, NORMALLY Α. CLOSED, DIAPHRAGM TYPE WITH MANUAL-FLOW ADJUSTMENT, AND OPERATED BY 24-V AC SOLENOID.
- B. PLASTIC, AUTOMATIC CONTROL VALVES: MOLDED-PLASTIC BODY NORMALLY CLOSED, DIAPHRAGM TYPE WITH MANUAL-FLOW ADJUSTMENT, AND OPERATED BY 24-V AC SOLENOID.
- 8. SPRINKLERS:
- GENERAL REQUIREMENTS: DESIGNED FOR UNIFORM COVERAGE OVER ENTIRE SPRAY OR DRIP AREA INDICATED AT AVAILABLE WATER PRESSURE.
- **CONTROLLERS:**
- A. CONTROLLER STATIONS FOR AUTOMATIC CONTROL VALVES: EACH STATION IS VARIABLE. INCLUDE SWITCH FOR MANUAL OR AUTOMATIC OPERATION OF EACH STATION.
- EXTERIOR CONTROL ENCLOSURES: NEMA 250, TYPE 4, WEATHERPROOF, WITH LOCKING COVER AND MATCHING KEYS; INCLUDE PROVISION FOR GROUNDING.
- C. INTERIOR CONTROL ENCLOSURES: NEMA 250, TYPE 12, DRIP-PROOF, WITH LOCKING COVER AND MATCHING KEYS.
- 10. CONTROL TRANSFORMER: 24-V SECONDARY, WITH PRIMARY FUSE
- 11. TIMING DEVICE: ADJUSTABLE, 24-HOUR, 14-DAY CLOCK, WITH AUTOMATIC OPERATIONS TO SKIP OPERATION ANY DAY IN TIMER PERIOD, TO OPERATE EVERY OTHER DAY, OR TO OPERATE TWO OR MORE TIMES DAILY. 12. MOISTURE SENSOR: ADJUSTABLE FROM ONE TO SEVEN DAYS, TO SHUT OFF
- WATER FLOW DURING RAIN. **13. WIRING:** UL 493, TYPE UF MULTICONDUCTOR, WITH SOLID-COPPER
- CONDUCTORS; INSULATED CABLE; SUITABLE FOR DIRECT BURIAL. 14. BOXES FOR AUTOMATIC CONTROL VALVES:
- A. PLASTIC BOXES: BOX AND COVER, WITH OPEN BOTTOM AND OPENINGS FOR PIPING: DESIGNED FOR INSTALLING FLUSH WITH GRADE.
- DRAINAGE BACKFILL: WASHED GRAVEL OR CRUSHED STONE.
- 15. EARTHWORK:
- A. INSTALL WARNING TAPE DIRECTLY ABOVE PRESSURE PIPING, 12 INCHES BELOW FINISHED GRADES, EXCEPT 6 INCHES BELOW SUBGRADE UNDER PAVEMENT AND SLABS.
- PROVIDE MINIMUM COVER OVER TOP OF UNDERGROUND PIPING ACCORDING TO LOCAL CODE AND INDUSTRY STANDARDS.

## **17. PIPING INSTALLATION:**

- A. SHOP DRAWINGS SHALL INDICATE LOCATION AND ARRANGEMENT OF PIPING SYSTEM. INSTALL PIPING AS INDICATED UNLESS DEVIATIONS ARE APPROVED TO COORDINATE WITH OTHER TRADES.
- INSTALL PIPING AT MINIMUM UNIFORM SLOPE OF 0.5 PERCENT DOWN TOWARD DRAIN INSTALL GROUPS OF PIPES PARALLEL TO EACH OTHER, SPACED TO PERMIT VALVE SERVICING. INSTALL FITTINGS FOR CHANGES IN BRANCH CONNECTIONS. LAY PIPING ON SOLID SUBBASE, UNIFORMLY SLOPED WITHOUT HUMPS OR DEPRESSIONS.
- C. INSTALL PVC PIPING IN DRY WEATHER WHEN TEMPERATURE IS ABOVE 40 DEG F. ALLOW
- ACCORDING TO PIPING MANUFACTURER'S WRITTEN INSTRUCTIONS. **19. VALVE INSTALLATION:** INSTALL UNDERGROUND VALVES IN CURB-VALVE
- CASINGS WITH TOPS FLUSH WITH GRADE. 20. SPRINKLER AND EMITTER INSTALLATION:
- A. INSTALL SPRINKLERS AND EMITTERS AFTER HYDROSTATIC TEST IS COMPLETED.
- B. INSTALL SPRINKLERS AND EMITTERS AT MANUFACTURER'S RECOMMENDED HEIGHTS.
- 21. AUTOMATIC IRRIGATION-CONTROL SYSTEM:
- A. EQUIPMENT MOUNTING: INSTALL INTERIOR CONTROLLERS AS INDICATED ON ELECTRICAL **USE SETTING DRAWINGS** AND DIRECTIONS FURNISHED WITH ITEMS TO BE ANCHOR BOLTS TO ELEVATIONS REQUIRED FOR PROPER ATTACHMENT TO SUPPORTED EQUIPMENT.
- EQUIPMENT MOUNTING: INSTALL EXTERIOR FREESTANDING CONTROLLERS ON PRECAST DEVICES. USE SETTING DRAWINGS, TEMPLATES, DIAGRAMS, INSTRUCTIONS, AND DIRECTIONS FURNISHED WITH ITEMS TO BE EMBEDDED. ANCHOR BOLTS TO ELEVATIONS REQUIRED FOR PROPER ATTACHMENT TO SUPPORTED EQUIPMENT.
- C. INSTALL CONTROL CABLE IN SAME TRENCH AS IRRIGATION PIPING AND BESIDE PIPING. RECOMMENDED BY CONTROLLER
- D. INSTALL CABLE IN SEPARATE SLEEVE UNDER PAVED AREAS.
- 22. IDENTIFICATION: IDENTIFY SYSTEM COMPONENTS. EQUIPMENT NAMEPLATES AND SIGNS: INSTALL ENGRAVED PLASTIC-LAMINATE
- EQUIPMENT NAMEPLATES AND SIGNS ON EACH AUTOMATIC CONTROLLER.
- 23. WARNING TAPES: ARRANGE FOR INSTALLATION OF CONTINUOUS UNDERGROUND, DETECTABLE WARNING TAPES OVER UNDERGROUND PIPING DURING BACKFILLING OF TRENCHES.
- 24. FIELD QUALITY CONTROL: PERFORM TESTS AND INSPECTIONS.
- A. LEAK TEST: AFTER INSTALLATION, CHARGE SYSTEM AND TEST FOR LEAKS. REPAIR LEAKS AND RETEST UNTIL NO LEAKS EXIST.
- B. OPERATIONAL TEST: AFTER ELECTRICAL CIRCUITRY HAS BEEN ENERGIZED OPERATE CONTROLLERS AND AUTOMATIC CONTROL VALVES TO CONFIRM PROPER SYSTEM OPERATION.
- C. TEST AND ADJUST CONTROLS AND SAFETIES. REPLACE DAMAGED AND MALFUNCTIONING CONTROLS AND EQUIPMENT. ANY IRRIGATION PRODUCT WILL BE CONSIDERED DEFECTIVE IF IT DOES NOT PASS TESTS AND INSPECTIONS. PREPARE TEST AND INSPECTION REPORTS
- 25. ADJUSTING: ADJUST SETTINGS OF CONTROLLERS A. ADJUST AUTOMATIC CONTROL VALVES TO PROVIDE FLOW RATE AT RATED
- OPERATING RELATION TO PLANTS AND FINISH GRADE.

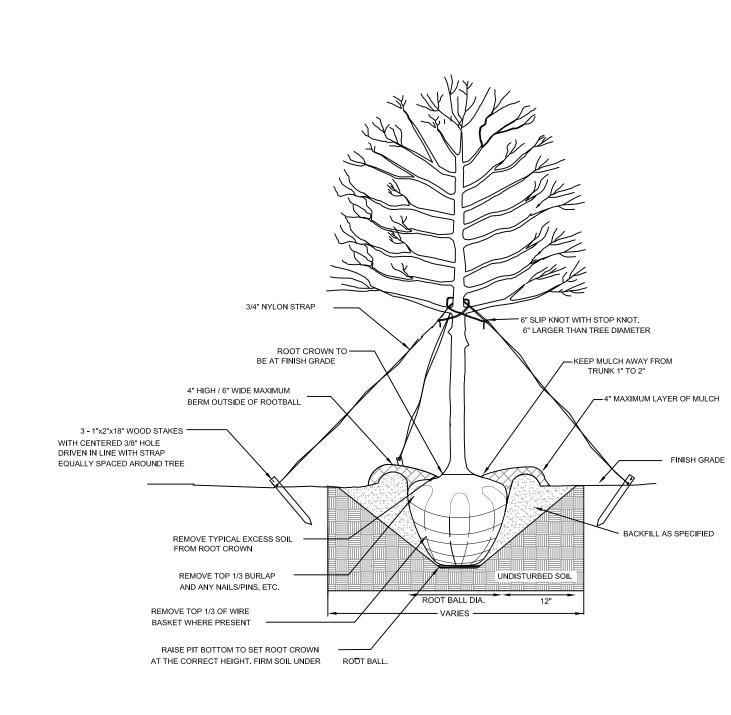

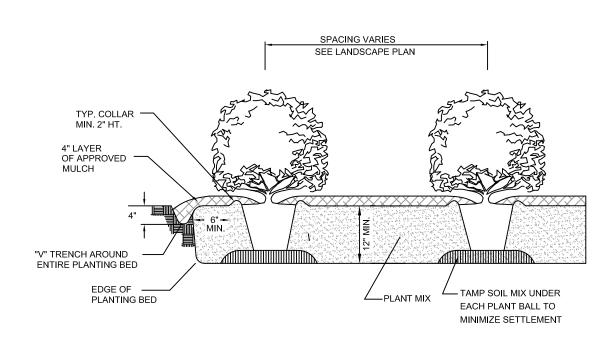

VALVES. INSTALL PIPING FREE OF SAGS AND BENDS DIRECTION AND

JOINTS TO CURE AT LEAST 24 HOURS BEFORE TESTING. **18. JOINT CONSTRUCTION:** JOIN WITH INSERT FITTINGS AND BANDS OR FASTENERS

DRAWINGS. PLACE AND SECURE ANCHORAGE DEVICES. TEMPLATES, DIAGRAMS, INSTRUCTIONS, EMBEDDED. INSTALL

CONCRETE BASES. PLACE AND SECURE ANCHORAGE INSTALL

> PROVIDE CONDUCTORS OF SIZE NOT SMALLER THAN MANUFACTURER.

PRESSURE REQUIRED FOR EACH SPRINKLER CIRCUIT.



- A. FURNISH NURSERY-GROWN PLANTS INDICATED IN PLANT LEGEND SHOWN ON DRAWINGS AND COMPLYING WITH ANSI Z60.1 - 2014, AMERICAN STANDARD FOR NURSERY STOCK
- B. ANNUALS: PROVIDE HEALTHY, DISEASE-FREE PLANTS OF SPECIES AND VARIETY SHOWN OR LISTED, WITH WELL-ESTABLISHED ROOT SYSTEMS. PROVIDE ONLY PLANTS THAT ARE ACCLIMATED TO OUTDOOR CONDITIONS BEFORE DELIVERY
- C. CONTRACTOR SHALL PROVIDE A ONE YEAR WARRANTY FROM FINAL ACCEPTANCE ON ALL PLANTS UNLESS APPROVED OTHERWISE BY THE OWNER
- 2. SOIL AMENDMENTS AS REQUIRED FROM SOILS REPORT/TESTING A. LIME: ASTM C 602, AGRICULTURAL LIMING MATERIAL CONTAINING A MINIMUM OF 80
- PERCENT CALCIUM CARBONATE EQUIVALENT. B. SULFUR: GRANULAR, BIODEGRADABLE, AND CONTAINING A MINIMUM OF 90 PERCENT
- SULFUR. C. IRON SULFATE: GRANULATED FERROUS SULFATE CONTAINING A MINIMUM OF 20 PERCENT
- IRON AND 10 PERCENT SULFUR.
- D. ALUMINUM SULFATE: COMMERCIAL GRADE, UNADULTERATED E. PERLITE: HORTICULTURAL PERLITE, SOIL AMENDMENT GRADE.
- F. AGRICULTURAL GYPSUM: MINIMUM 90 PERCENT CALCIUM SULFATE.
- G. SAND: CLEAN, WASHED, NATURAL OR MANUFACTURED, AND FREE OF TOXIC MATERIALS.
- H. COMPOST: WELL-COMPOSTED, STABLE, AND WEED-FREE ORGANIC MATTER, PH RANGE OF 5.5 TO 8; MOISTURE CONTENT 35 TO 55 PERCENT BY WEIGHT; 100 PERCENT PASSING THROUGH 3/4-INCH SIEVE
- I. SPHAGNUM PEAT: PARTIALLY DECOMPOSED SPHAGNUM PEAT MOSS, FINELY DIVIDED OR GRANULAR TEXTURE, WITH A PH RANGE OF 3.4 TO 4.8.
- J. MANURE: WELL-ROTTED, UNLEACHED, STABLE OR CATTLE MANURE CONTAINING NOT MORE THAN 25 PERCENT BY VOLUME OF STRAW, SAWDUST, OR OTHER BEDDING MATERIALS; FREE OF TOXIC SUBSTANCES, STONES, STICKS, SOIL, WEED SEED, DEBRIS, AND MATERIAL HARMFUL TO PLANT GROWTH.

3. FERTILIZERS

- A. BONEMEAL: COMMERCIAL, RAW OR STEAMED, FINELY GROUND; A MINIMUM OF 1 PERCENT NITROGEN AND 10 PERCENT PHOSPHORIC ACID.
- B. SUPERPHOSPHATE: COMMERCIAL, PHOSPHATE MIXTURE, SOLUBLE; A MINIMUM OF 20 PERCENT AVAILABLE PHOSPHORIC ACID.
- C. COMMERCIAL FERTILIZER: COMMERCIAL-GRADE COMPLETE FERTILIZER OF NEUTRAL CHARACTER, CONSISTING OF FAST- AND SLOW-RELEASE NITROGEN.
- D. SLOW-RELEASE FERTILIZER: GRANULAR OR PELLETED FERTILIZER.

### 4. PLANTING MIX

- A. PLANTING MIX: SHALL BE NATURAL, FERTILE, AGRICULTURAL TOPSOIL, CAPABLE OF SUSTAINING VIGOROUS PLANT GROWTH, WITH PH RANGE OF 5.5 TO 7. IT MAY BE DEVELOPED BY AMENDING THE EXISTING SOIL, OR REMOVING THE EXISTING SOIL AND REPLACING WITH NEW SOIL. IT SHALL BE FREE OF ROOTS, PLANTS, SOD, STONES, CLODS, CLAY LUMPS, POCKETS OF COARSE SAND, CONCRETE SLURRY, CONCRETE LAYERS OR CHUNKS, CEMENT, PLASTER BUILDING DEBRIS, AND OTHER EXTRANEOUS MATERIALS HARMFUL TO PLANT GROWTH PLANTING MIX SHALL NOT BE USED WHILE IN A FROZEN OR MUDDY CONDITION. UNLESS OTHERWISE SPECIFIED, THE PLANTING MIX SHALL CONTAIN THE FOLLOWING PERCENTAGES: MIN. 10% - MAX. 30% (RED CLAY WELL PULVERIZED); CLAY SHALL BE STERILE. CLAY:
- SILT: MIN. 30% - MAX. 50%
- COARSE SAND: MIN. 30% MAX. 45% (1.0mm TO 0.5mm DIA., AND FREE OF ROCK) ORGANIC MAT.:MIN. 5% (COMPOST/HUMUS SUCH AS SAWDUST OR LEAF MOLD THAT
- IS DECOMPOSED)
- ELEMENTS: CALCIUM 55% 80%; MAGNESIUM 10% 30%; POTASSIUM 5% 8%
- **B. CONTRACTOR TO PROVIDE SOILS TEST/ANALYSIS INDICATING ABOVE REQUIREMENTS** 5. MULCHES

A. DOUBLE HAMMERED HARDWOOD MULCH FOR ALL PLANT BEDS UNLESS OTHERWISE INDICATED.

#### 6. PLANT BED ESTABLISHMENT

- B. ADJUST SPRINKLERS AND EMITTERS SO THEY WILL BE PROPERLY LOCATED IN A. LAYOUT PLANT BEDS AS INDICATED ON THE PLANTING PLAN AND REMOVE UNNECESSARY MATERIAL TO A MINIMUM DEPTH OF 18 INCHES.
  - B. LOOSEN SUBGRADE OF PLANTING BEDS TO A MINIMUM DEPTH OF 6 INCHES. REMOVE STONES LARGER THAN 1 INCH IN ANY DIMENSION AND STICKS, ROOTS, RUBBISH, AND OTHER EXTRANEOUS MATTER AND LEGALLY DISPOSE OF THEM OFF OWNER'S PROPERTY.
  - C. SPREAD PLANTING MIX (SEE 4 ABOVE) TO A DEPTH OF 18 INCHES BUT NOT LESS THAN REQUIRED TO MEET FINISH GRADES AFTER NATURAL SETTLEMENT. DO NOT SPREAD IF PLANTING MIX OR SUBGRADE IS FROZEN, MUDDY, OR EXCESSIVELY WET.
  - D. FINISH GRADING: GRADE PLANTING BEDS TO A SMOOTH, UNIFORM SURFACE PLANE WITH LOOSE, UNIFORMLY FINE TEXTURE, ROLL AND RAKE, REMOVE RIDGES, AND FILL DEPRESSIONS TO MEET FINISH GRADES.

#### 7. EXCAVATION FOR TREES AND SHRUBS

- A. PLANTING PITS AND TRENCHES: EXCAVATE CIRCULAR PLANTING PITS WITH SIDES SLOPING INWARD AT A 45-DEGREE ANGLE. EXCAVATIONS WITH VERTICAL SIDES ARE NOT ACCEPTABLE. TRIM PERIMETER OF BOTTOM LEAVING CENTER AREA OF BOTTOM RAISED SLIGHTLY TO SUPPORT ROOT BALL AND ASSIST IN DRAINAGE AWAY FROM CENTER. DO NOT FURTHER DISTURB BASE. ENSURE THAT ROOT BALL WILL SIT ON UNDISTURBED BASE SOIL TO PREVENT SETTLING. SCARIFY SIDES OF PLANTING PIT SMEARED OR SMOOTHED DURING EXCAVATION.
- B. EXCAVATE APPROXIMATELY THREE TIMES AS WIDE AS BALL DIAMETER.
- C. DO NOT EXCAVATE DEEPER THAN DEPTH OF THE ROOT BALL, MEASURED FROM THE ROOT FLARE TO THE BOTTOM OF THE ROOT BALL.
- D. SUBSOIL AND TOPSOIL REMOVED FROM EXCAVATIONS MAY NOT BE USED SOLELY AS PLANTING MIX (SEE NOTE 4 ABOVE).



- LAYER OF SOIL

- 11. PLANT MAINTENANCE

- IF APPLICABLE.
- SUBSIDENCE.

#### PLANTING SPECIFICATIONS (CONT.)

8. TREE, SHRUB, AND VINE PLANTING A. BEFORE PLANTING, VERIFY THAT ROOT FLARE IS VISIBLE AT TOP OF ROOT BALL ACCORDING TO ANSI Z60.1.

B. REMOVE STEM GIRDLING ROOTS AND KINKED ROOTS. REMOVE INJURED ROOTS BY CUTTING CLEANLY; DO NOT BREAK.

C. SET STOCK PLUMB AND IN CENTER OF PLANTING PIT OR TRENCH WITH ROOT FLARE INCH ABOVE ADJACENT FINISH GRADES. D. USE PLANTING SOIL FOR BACKFILL

E. BALLED AND BURLAPPED: AFTER PLACING SOME BACKFILL AROUND ROOT BALL TO STABILIZE PLANT, CAREFULLY CUT AND REMOVE BURLAP, ROPE, AND WIRE BASKETS FROM TOPS OF ROOT BALLS AND FROM SIDES, BUT DO NOT REMOVE FROM UNDER ROOT BALLS. REMOVE PALLETS, IF ANY, BEFORE SETTING. DO NOT USE PLANTING STOCK IF ROOT BALL IS CRACKED OR BROKEN BEFORE OR DURING PLANTING OPERATION F. CONTAINER-GROWN: CAREFULLY REMOVE ROOT BALL FROM CONTAINER WITHOUT DAMAGING ROOT BALL OR PLANT.

G.BACKFILL AROUND ROOT BALL IN LAYERS, TAMPING TO SETTLE SOIL AND ELIMINATE VOIDS AND AIR POCKETS. WHEN PLANTING PIT IS APPROXIMATELY ONE-HALF FILLED, WATER THOROUGHLY BEFORE PLACING REMAINDER OF BACKFILL. REPEAT WATERING UNTIL NO MORE WATER IS ABSORBED.

H. CONTINUE BACKFILLING PROCESS. WATER AGAIN AFTER PLACING AND TAMPING FINAL

I. WHEN PLANTING ON SLOPES, SET THE PLANT SO THE ROOT FLARE ON THE UPHILL SIDE IS FLUSH WITH THE SURROUNDING SOIL ON THE SLOPE; THE EDGE OF THE ROOT BALL ON THE DOWNHILL SIDE WILL BE ABOVE THE SURROUNDING SOIL. APPLY ENOUGH SOIL TO COVER THE DOWNHILL SIDE OF THE ROOT BALL

J. PRUNE/REMOVE ONLY DEAD, DYING, OR BROKEN BRANCHES. DO NOT PRUNE FOR SHAPE. PRUNE TO RETAIN NATURAL CHARACTER.

K. PRUNE, THIN, AND SHAPE TREES, SHRUBS, AND VINES ACCORDING TO STANDARD PROFESSIONAL HORTICULTURAL AND ARBORICULTURAL PRACTICES FOR NEWLY PLANTED PLANTS. UNLESS OTHERWISE INDICATED BY LANDSCAPE ARCHITECT, DO NOT CUT TREE LEADERS

#### 9. GROUND COVER, PERENNIAL, AND ANNUAL PLANTING

A. SET OUT AND SPACE GROUND COVER, PERENNIALS, AND/OR ANNUALS AS INDICATED IN EVEN ROWS WITH TRIANGULAR SPACING.

B. USE PLANTING MIX FOR BACKFILL C. DIG HOLES LARGE ENOUGH TO ALLOW SPREADING OF ROOTS.

D. WORK SOIL AROUND ROOTS TO ELIMINATE AIR POCKETS AND LEAVE A SLIGHT SAUCER INDENTATION AROUND PLANTS TO HOLD WATER.

E. WATER THOROUGHLY AFTER PLANTING, TAKING CARE NOT TO COVER PLANT CROWNS WITH WET SOIL.

F. PROTECT PLANTS FROM HOT SUN AND WIND; REMOVE PROTECTION IF PLANTS SHOW EVIDENCE OF RECOVERY FROM TRANSPLANTING SHOCK.

#### 10. PLANT AND PLANT BED MULCHING

A. MULCH BACKFILLED SURFACES OF PLANTING BEDS AND OTHER AREAS INDICATED

B. TREES AND TREE-FORM SHRUBS IN TURF AREAS: APPLY ORGANIC MULCH RING OF 3-INCH AVERAGE THICKNESS, WITH MINIMUM 36-INCH RADIUS AROUND TRUNKS OR STEMS. DO NOT PLACE MULCH WITHIN 3 INCHES OF TRUNKS OR STEMS.

C. ORGANIC MULCH IN PLANT BEDS: APPLY 3-INCH AVERAGE THICKNESS OF MULCH OVER ENTIRE SURFACE OF PLANT BED, AND FINISH LEVEL WITH ADJACENT FINISH GRADES. DO NOT PLACE MULCH WITHIN 2 INCHES OF TRUNKS OR STEMS.

A. MAINTAIN PLANTINGS BY PRUNING, CULTIVATING, WATERING, WEEDING, FERTILIZING MULCHING, RESTORING PLANTING SAUCERS, RESETTING TO PROPER GRADES OR VERTICAL POSITION, AND PERFORMING OTHER OPERATIONS AS REQUIRED TO ESTABLISH HEALTHY, VIABLE PLANTINGS. SPRAY OR TREAT AS REQUIRED TO KEEP TREES AND SHRUBS FREE OF INSECTS AND DISEASE.

B. SET IRRIGATION SYSTEM FOR ZONE DURATION APPLICABLE FOR NEWLY PLANTED PLANTS


C. FILL IN AS NECESSARY SOIL SUBSIDENCE THAT MAY OCCUR BECAUSE OF SETTLING OR OTHER PROCESSES. REPLACE MULCH MATERIALS DAMAGED OR LOST IN AREAS OF


D. APPLY TREATMENTS AS REQUIRED TO KEEP PLANT MATERIALS, PLANTED AREAS, AND SOILS FREE OF PESTS AND PATHOGENS OR DISEASE. USE PRACTICES TO MINIMIZE THE USE OF PESTICIDES AND REDUCE HAZARDS.

E. APPLY PESTICIDES AND OTHER CHEMICAL PRODUCTS AND BIOLOGICAL CONTROL AGENTS IN ACCORDANCE WITH AUTHORITIES HAVING JURISDICTION AND MANUFACTURER'S WRITTEN RECOMMENDATIONS. COORDINATE APPLICATIONS WITH OWNER'S OPERATIONS AND OTHERS IN PROXIMITY TO THE WORK. NOTIFY OWNER BEFORE EACH APPLICATION IS PERFORMED.

F. PROTECT PLANTS FROM DAMAGE DUE TO LANDSCAPE OPERATIONS AND OPERATIONS OF OTHER CONTRACTORS AND TRADES. MAINTAIN PROTECTION DURING INSTALLATION AND MAINTENANCE PERIODS. TREAT, REPAIR, OR REPLACE DAMAGED PLANTINGS.



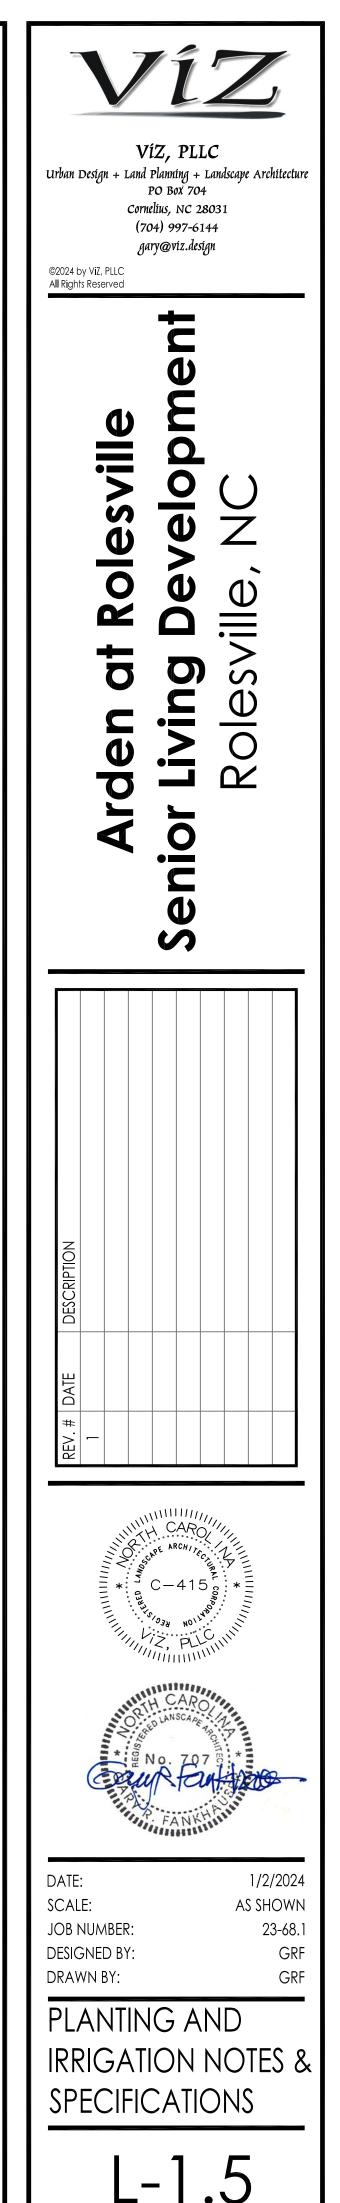

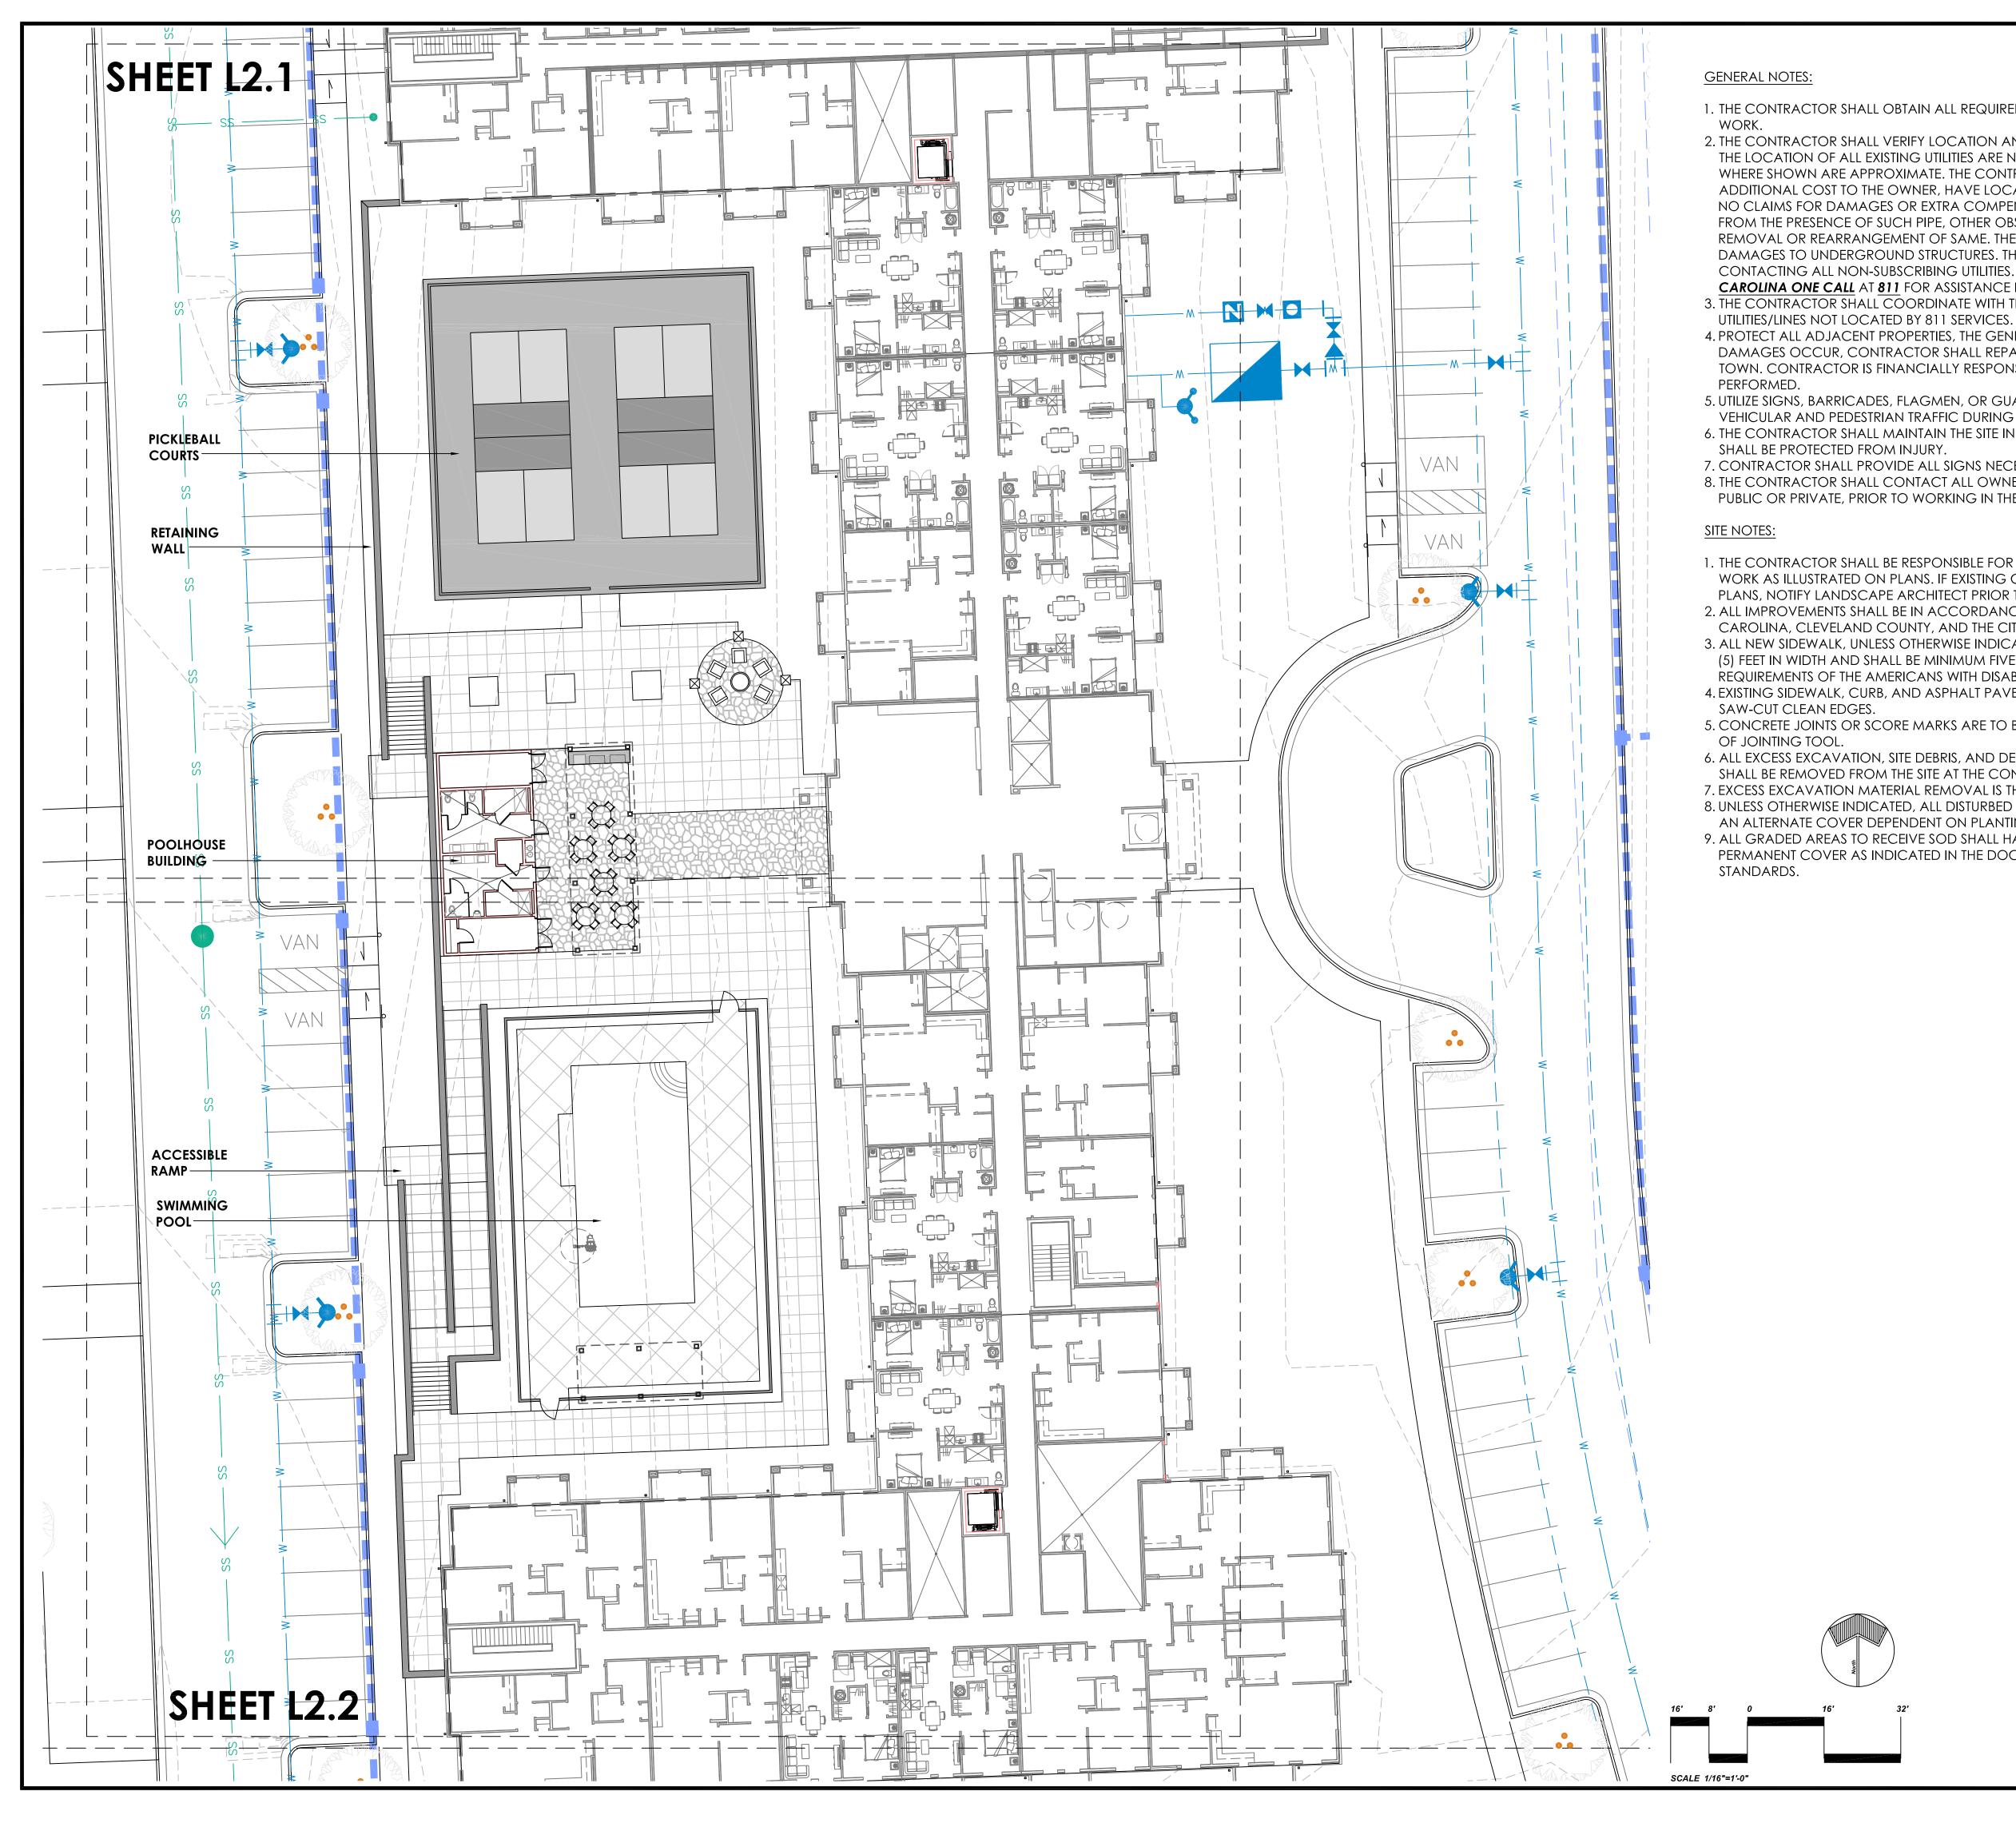

1. THE CONTRACTOR SHALL OBTAIN ALL REQUIRED PERMIT APPROVALS PRIOR TO BEGINNING

2. THE CONTRACTOR SHALL VERIFY LOCATION AND ELEVATION OF ALL UNDERGROUND UTILITIES. THE LOCATION OF ALL EXISTING UTILITIES ARE NOT NECESSARILY SHOWN ON THE PLANS, AND WHERE SHOWN ARE APPROXIMATE. THE CONTRACTOR SHALL ON HIS OWN INITIATIVE AND AT NO ADDITIONAL COST TO THE OWNER, HAVE LOCATED ALL UNDERGROUND LINES AND STRUCTURES. NO CLAIMS FOR DAMAGES OR EXTRA COMPENSATION SHALL ACCRUE TO THE CONTRACTOR FROM THE PRESENCE OF SUCH PIPE, OTHER OBSTRUCTIONS, OR FROM ANY DELAY DUE TO REMOVAL OR REARRANGEMENT OF SAME. THE CONTRACTOR SHALL BE RESPONSIBLE FOR ANY DAMAGES TO UNDERGROUND STRUCTURES. THE CONTRACTOR IS RESPONSIBLE FOR CONTACTING ALL NON-SUBSCRIBING UTILITIES. THE CONTRACTOR SHALL CONTACT **NORTH** 

**CAROLINA ONE CALL** AT **811** FOR ASSISTANCE IN LOCATING UTILITIES. 3. THE CONTRACTOR SHALL COORDINATE WITH THE TOWN OF ROLESVILLE FOR LOCATING ANY

4. PROTECT ALL ADJACENT PROPERTIES, THE GENERAL PUBLIC, AND ALL OTHER FACILITIES. SHOULD DAMAGES OCCUR, CONTRACTOR SHALL REPAIR IMMEDIATELY AS DIRECTED BY THE OWNER OR TOWN. CONTRACTOR IS FINANCIALLY RESPONSIBLE FOR ALL REPAIRS, AND REPAIRS ARE TO BE

5. UTILIZE SIGNS, BARRICADES, FLAGMEN, OR GUARDS AS REQUIRED TO ENSURE THE SAFETY OF ALL VEHICULAR AND PEDESTRIAN TRAFFIC DURING ALL CONSTRUCTION ACTIVITIES. 6. THE CONTRACTOR SHALL MAINTAIN THE SITE IN A MANNER SO THAT WORKMEN AND PUBLIC

7. CONTRACTOR SHALL PROVIDE ALL SIGNS NECESSARY FOR CONSTRUCTION OF THE PROJECT. 8. THE CONTRACTOR SHALL CONTACT ALL OWNERS OF EASEMENTS, UTILITIES AND RIGHT-OF-WAYS, PUBLIC OR PRIVATE, PRIOR TO WORKING IN THESE AREAS.

1. THE CONTRACTOR SHALL BE RESPONSIBLE FOR LINE AND GRADE, AND SURVEY STAKING OF ALL WORK AS ILLUSTRATED ON PLANS. IF EXISTING CONDITIONS DIFFER FROM THOSE ILLUSTRATED ON PLANS, NOTIFY LANDSCAPE ARCHITECT PRIOR TO CONSTRUCTION.

2. ALL IMPROVEMENTS SHALL BE IN ACCORDANCE WITH NCDOT, NCDEQ, THE STATE OF NORTH CAROLINA, CLEVELAND COUNTY, AND THE CITY OF KINGS MOUNTAIN.

3. ALL NEW SIDEWALK, UNLESS OTHERWISE INDICATED ON THE DRAWINGS, SHALL BE MINIMUM FIVE (5) FEET IN WIDTH AND SHALL BE MINIMUM FIVE (5) FEET CLEAR AT ALL POINTS AND MEET ALL REQUIREMENTS OF THE AMERICANS WITH DISABILITIES ACT (ADA).

4. EXISTING SIDEWALK, CURB, AND ASPHALT PAVEMENT TO BE REMOVED/REPLACED SHALL BE

5. CONCRETE JOINTS OR SCORE MARKS ARE TO BE SHARP AND CLEAN WITHOUT SHOWING EDGES

6. ALL EXCESS EXCAVATION, SITE DEBRIS, AND DEBRIS FROM CLEARING AND GRUBBING EXERCISES SHALL BE REMOVED FROM THE SITE AT THE CONTRACTOR'S EXPENSE.


7. EXCESS EXCAVATION MATERIAL REMOVAL IS THE CONTRACTOR'S RESPONSIBILITY.


8. UNLESS OTHERWISE INDICATED, ALL DISTURBED AREAS SHALL BE GRASSED WITH FESCUE SOD OR AN ALTERNATE COVER DEPENDENT ON PLANTING TIME OF YEAR. COORDINATE WITH THE CITY. 9. ALL GRADED AREAS TO RECEIVE SOD SHALL HAVE EXISTING SOIL AMENDED TO PROPERLY PLACE PERMANENT COVER AS INDICATED IN THE DOCUMENTS OR PER CITY OF KINGS MOUNTAIN


VíZ
<b>VÍZ, PLLC</b> Urban Design + Land Planning + Landscape Architecture PO Box 704 Cornelius, NC 28031 (704) 997-6144 gary@viz.design
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Arden at Rolesville Senior Living Developme Rolesville, NC
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FANKHANNING
DATE: 1/2/2024 SCALE: AS SHOWN JOB NUMBER: 23-68.1 DESIGNED BY: GRF DRAWN BY: GRF
OVERALL AMENITY AREA HARDSCAPE PLAN
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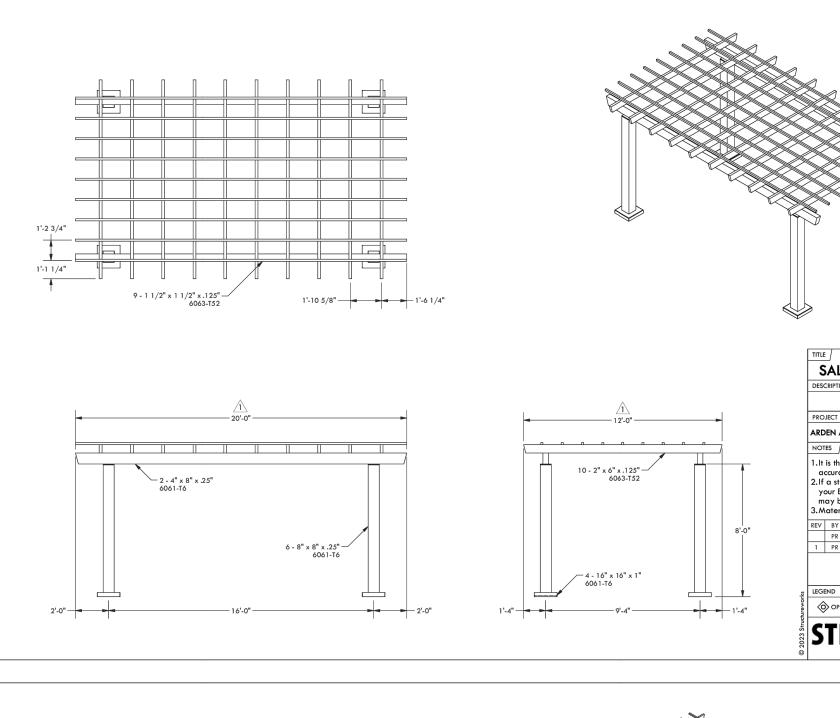





NOTES:

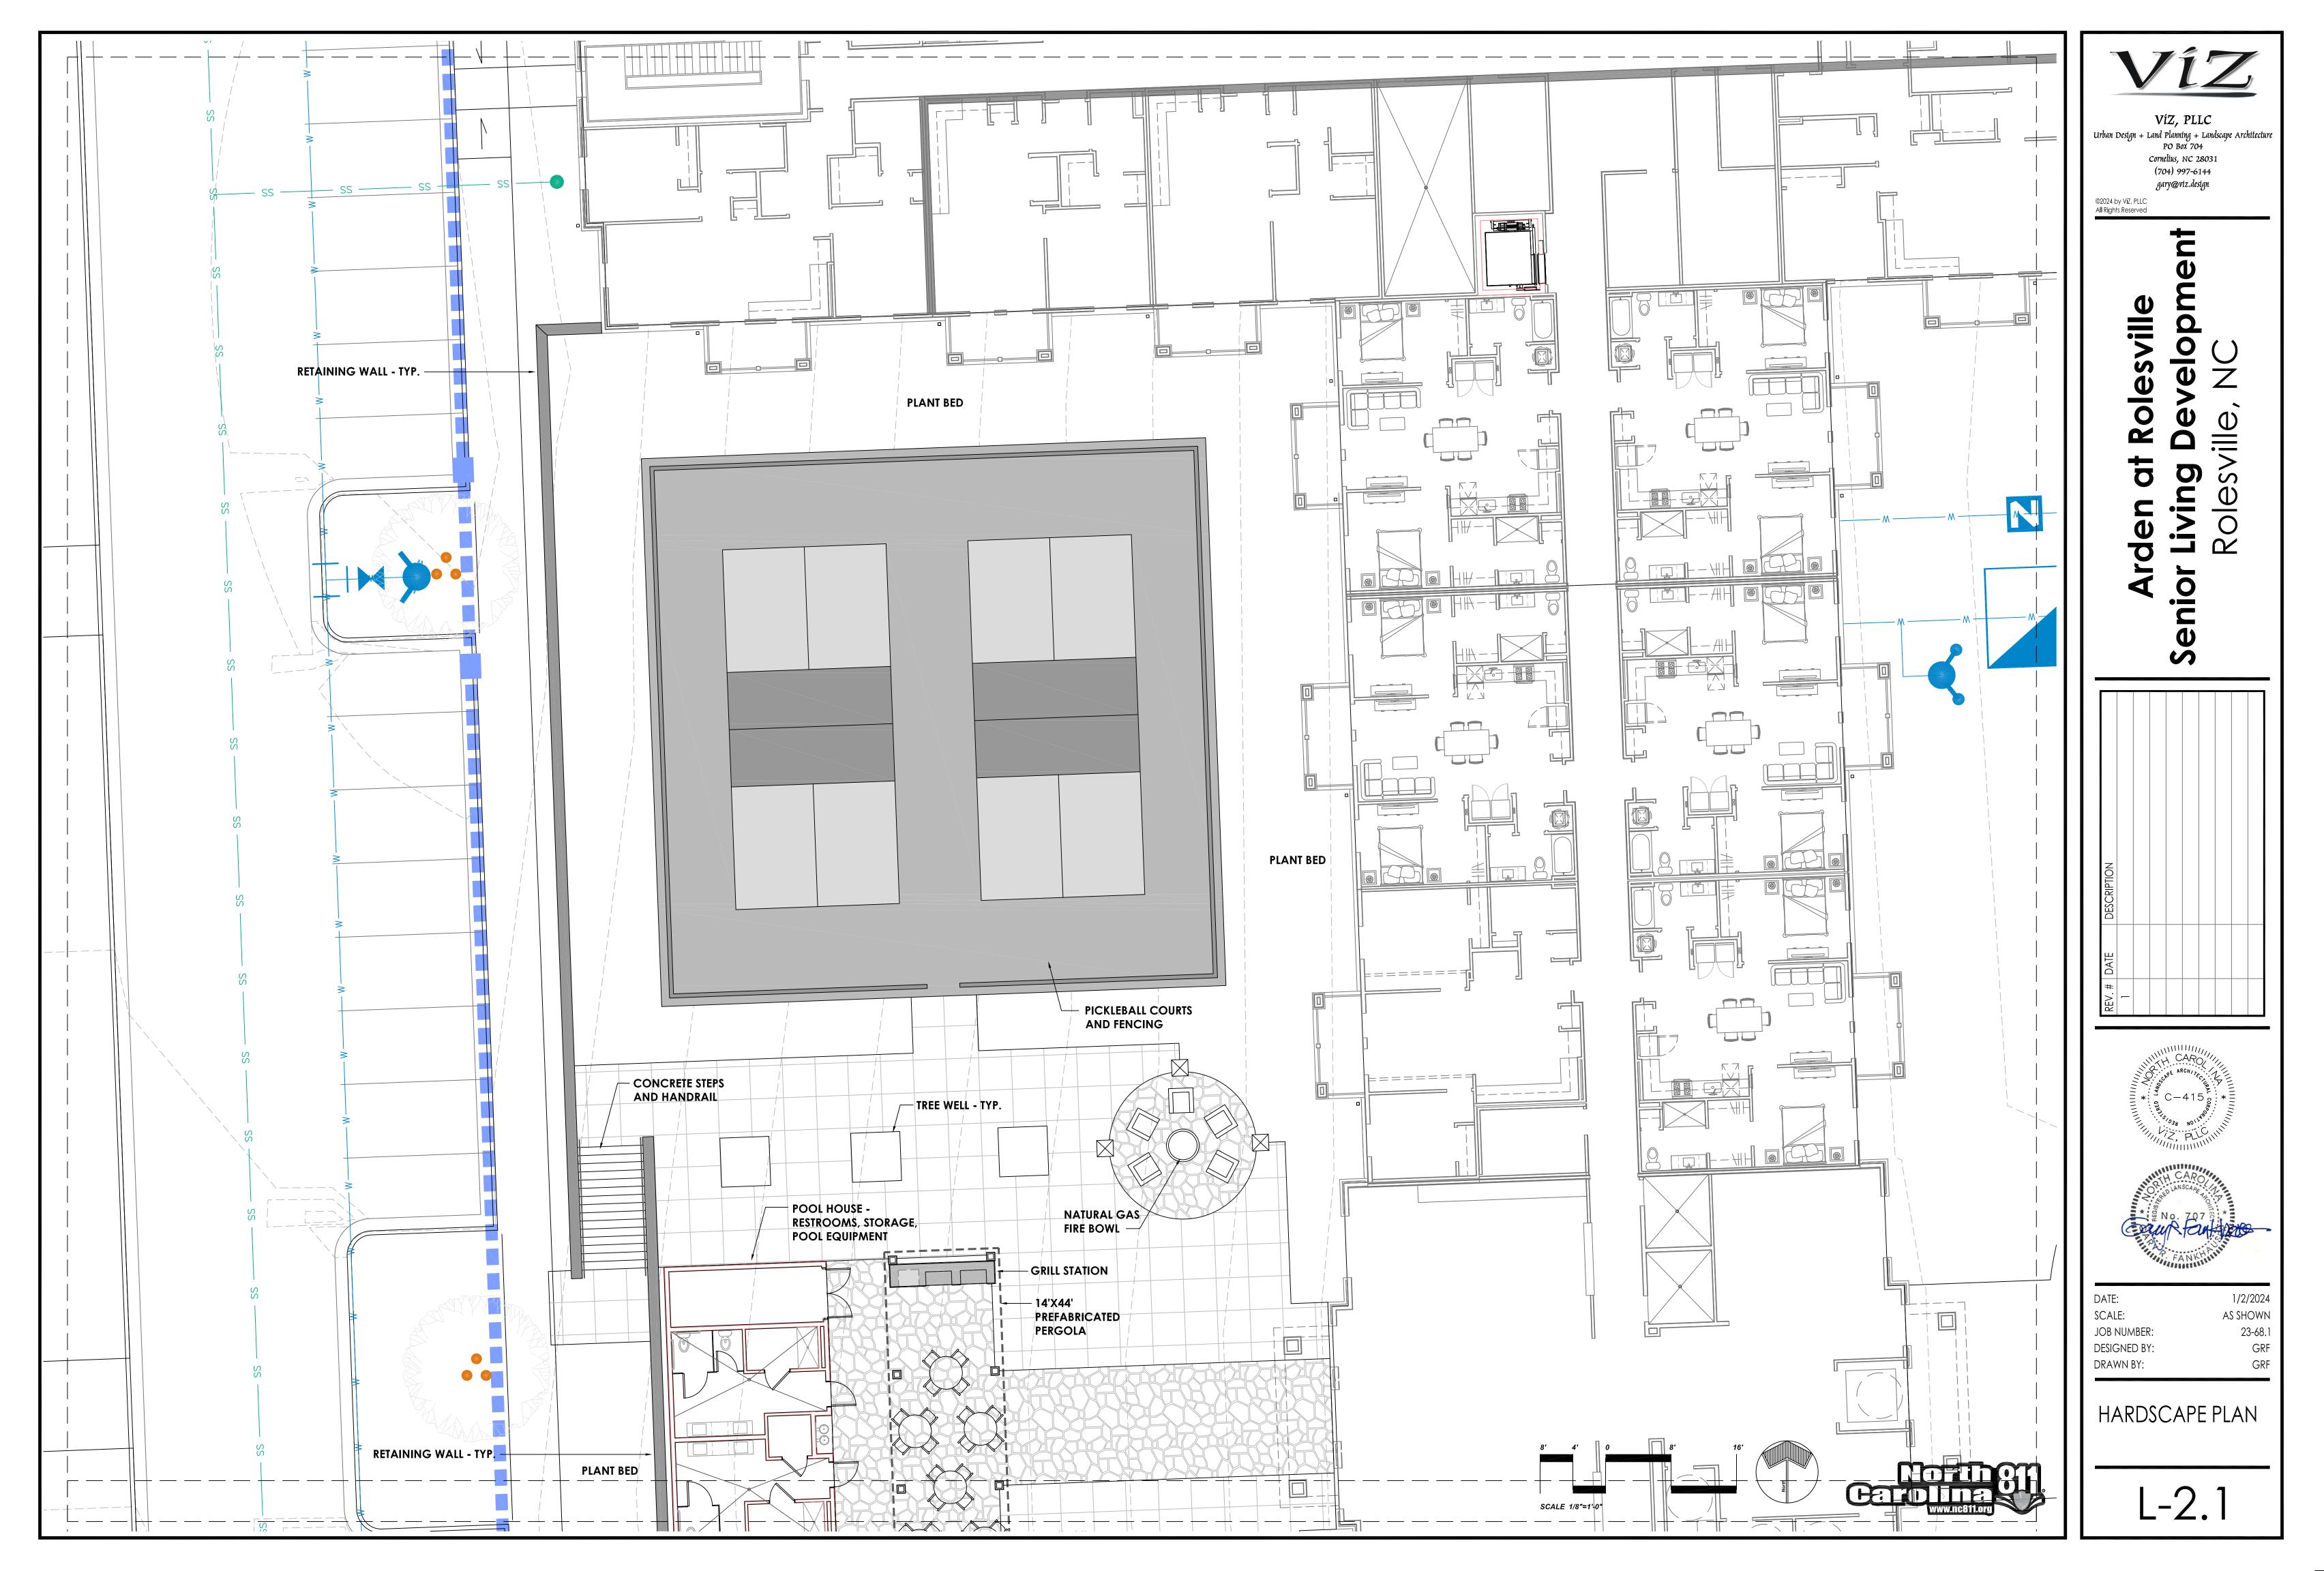- 1. CONCRETE CONTRACTOR SHALL BE EXPERIENCED IN PLACING AND FINISHING
- CONCRETE. 2. EXPANSION JOINTS SHALL BE INCORPORATED WITHIN PATTERN AS DETERMINED BY CODE
- OR STANDARD PRACTICE. 3. SCORE JOINTS AND/OR EXPANSION JOINTS SHALL BE WITH PATTERN INDICATED ON THE HARDSCAPE PLANS.
- 4. CONCRETE PAVING SHALL COMPLY WITH IBC 1104, A117.1, SECTIONS 301 AND 302.

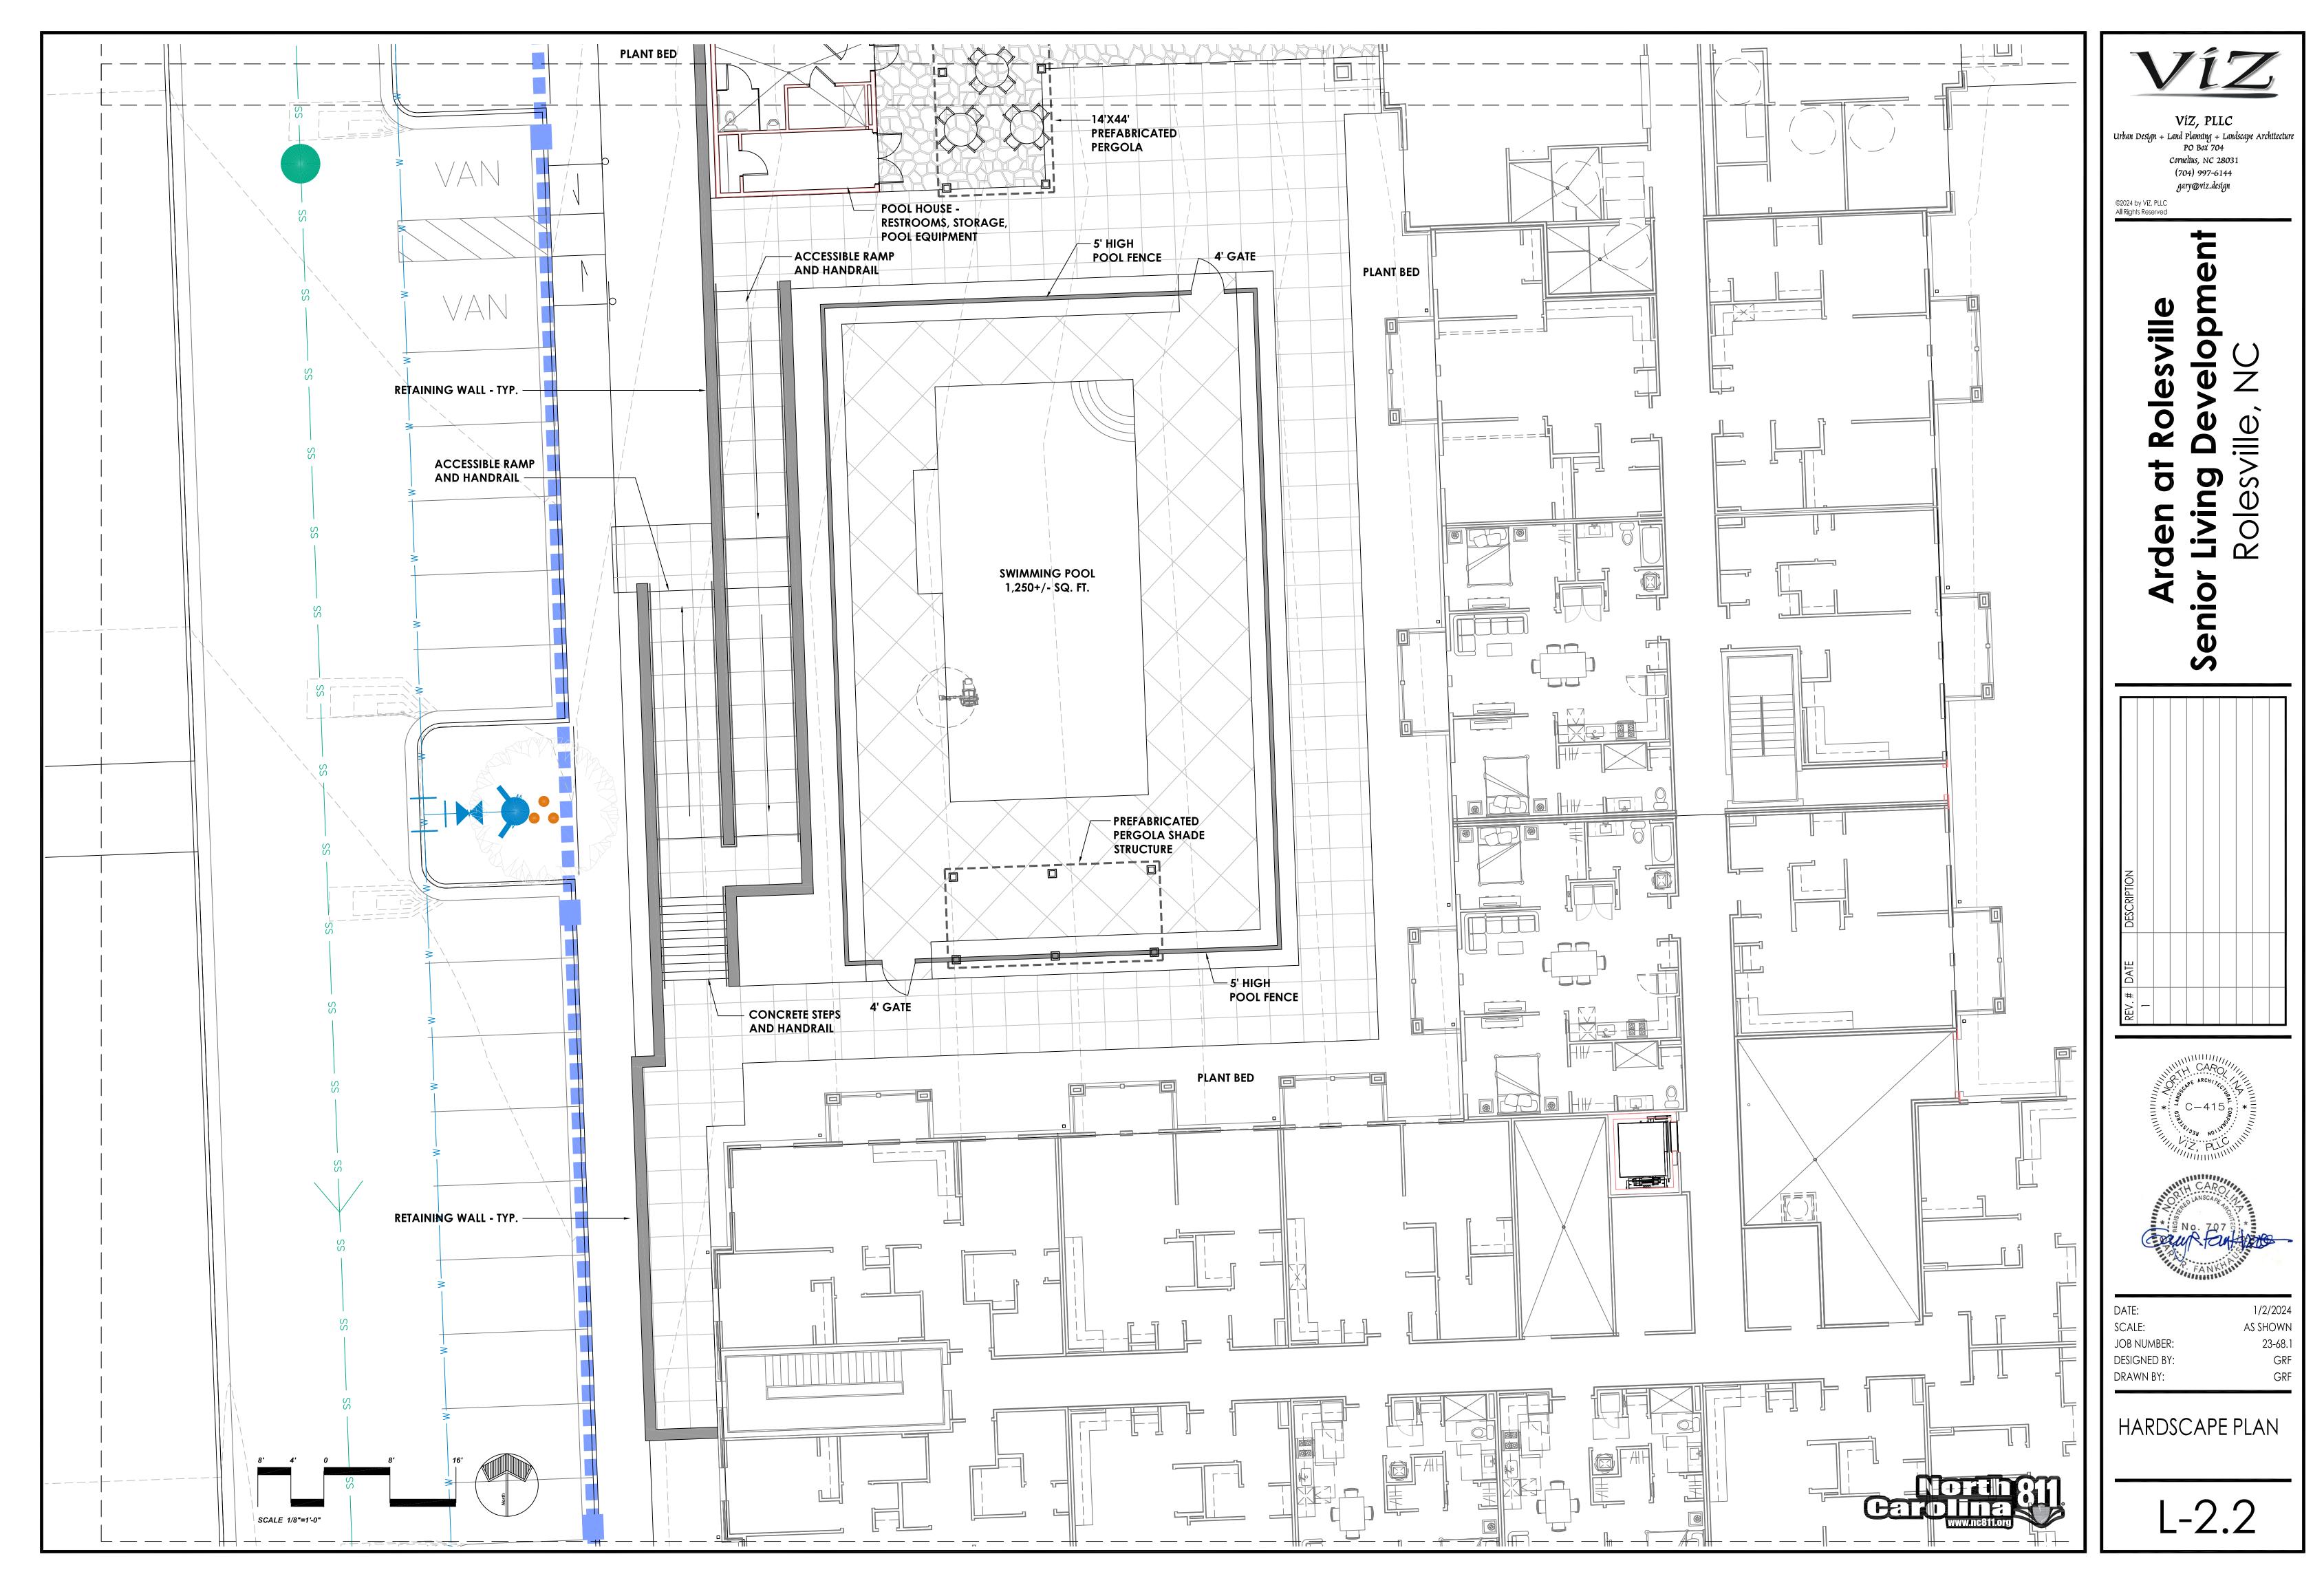SCORED AND STAMPED CONCRETE SECTION DETAIL

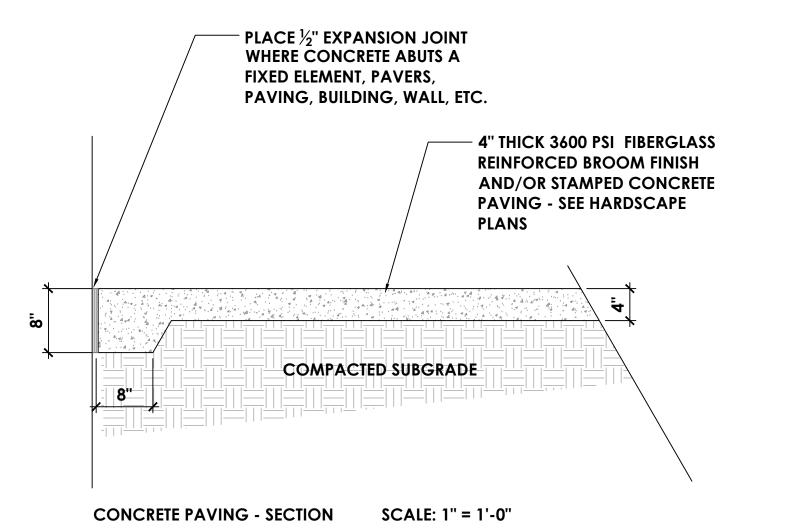

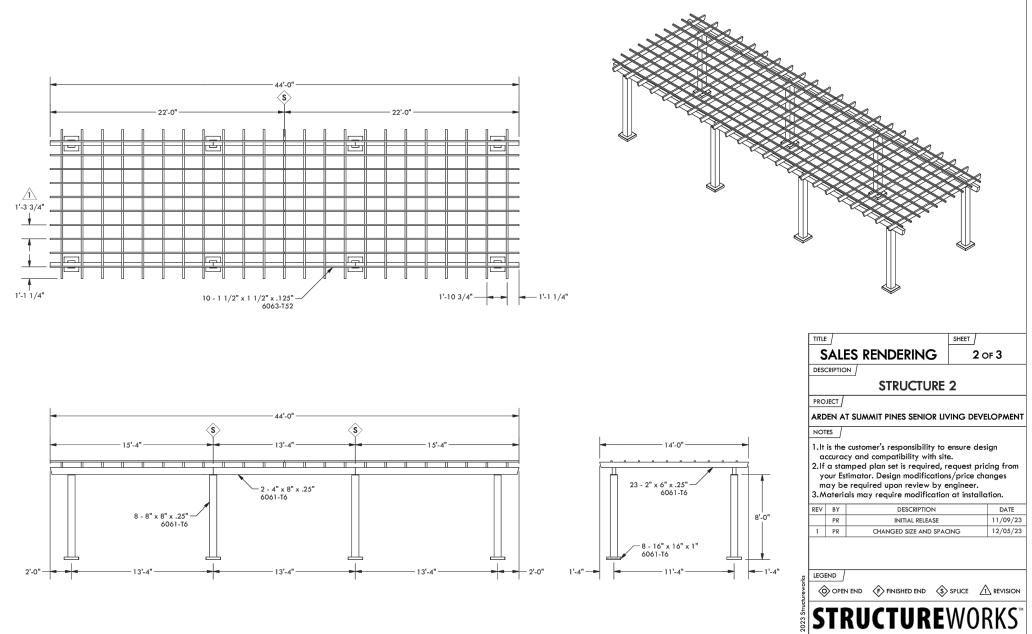

PREFABRICATED PERGOLA CUT SHEETS

LOCKABLE KEY PAD OR ⁵/₈" PICKETS @  $-1\frac{1}{2}$ " TOP RAILS **KEY-FOB ENTRY LATCH -**4" O.C.  $-2\frac{1}{2}$ " POST AND CAP - SEE HARDWARE SPECS.— POSTS TO BE EMBED MOUNT UNLESS 18" **OTHERWISE DIRECTED**  $-1\frac{1}{2}$ " BOTTOM RAIL POST FOOTINGS T.B.D. BY FENCE MANUFACTURER - 3,500 PSI CONC. POOL ENCLOSURE FENCE AND GATES SCALE: 1/2" = 1'-0" FOOTING NOTE: POOL ENCLOSURE FENCE AND ALL GATES (PEDESTRIAN AND MAINTENANCE) SHALL BE SECURED AND MEET ALL APPLICABLE CODES, INCLUDING I.B.C. 3109, SWIMMING POOL ENCLOSURES, FOR POOLS AND SPA. MAINTENANCE GATE SHALL WASHED STONE FOR CONTAIN PERMANENT LOCKING DEVICES AND HAVE A LOCKABLE, REMOVABLE, CENTER DRAINAGE POST. CONTRACTOR SHALL SUBMIT SHOP DRAWINGS FOR FENCE, GATES, HARDWARE, 10" -9 LOCKING DEVICES, ETC. FOR REVIEW/APPROVAL. **5' HIGH POOL FENCE AND GATES** ALL FENCING TO BE BLACK ALUMINUM

 48"

 464

 464

 464

 464

 476

 3"

 6" RISE

 6" RISE

 604

 603

 GATE

 HEIGHT


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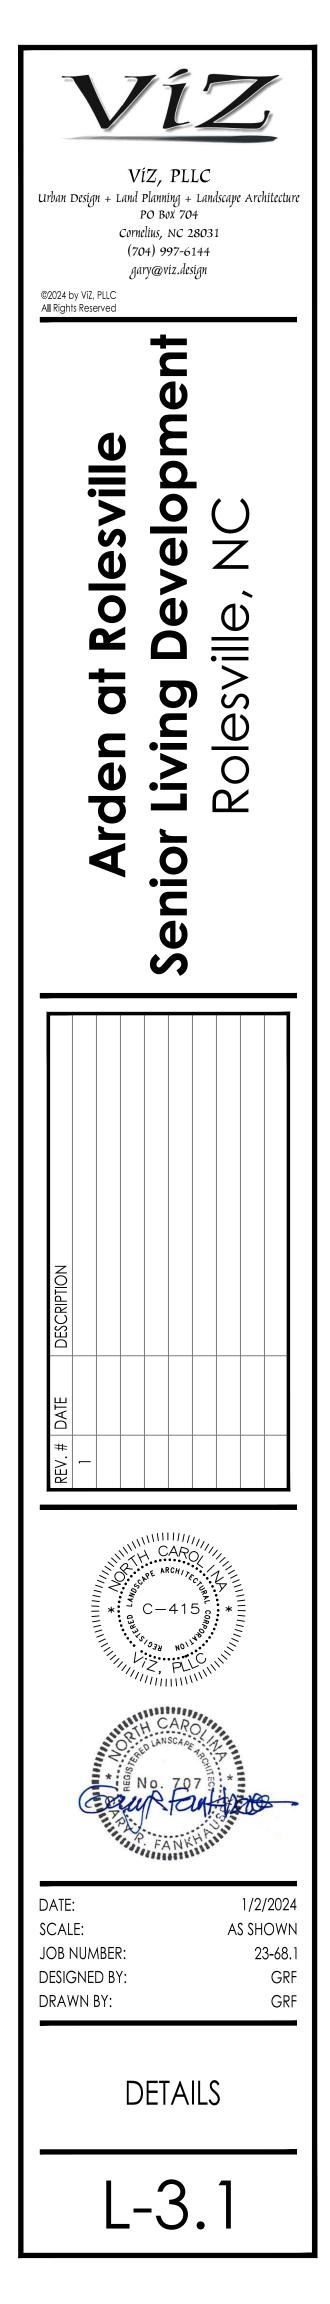
 5" SQUARE PICKET


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**DOG PARK FENCING** N.T.S. ALL FENCING TO BE BLACK ALUMINUM





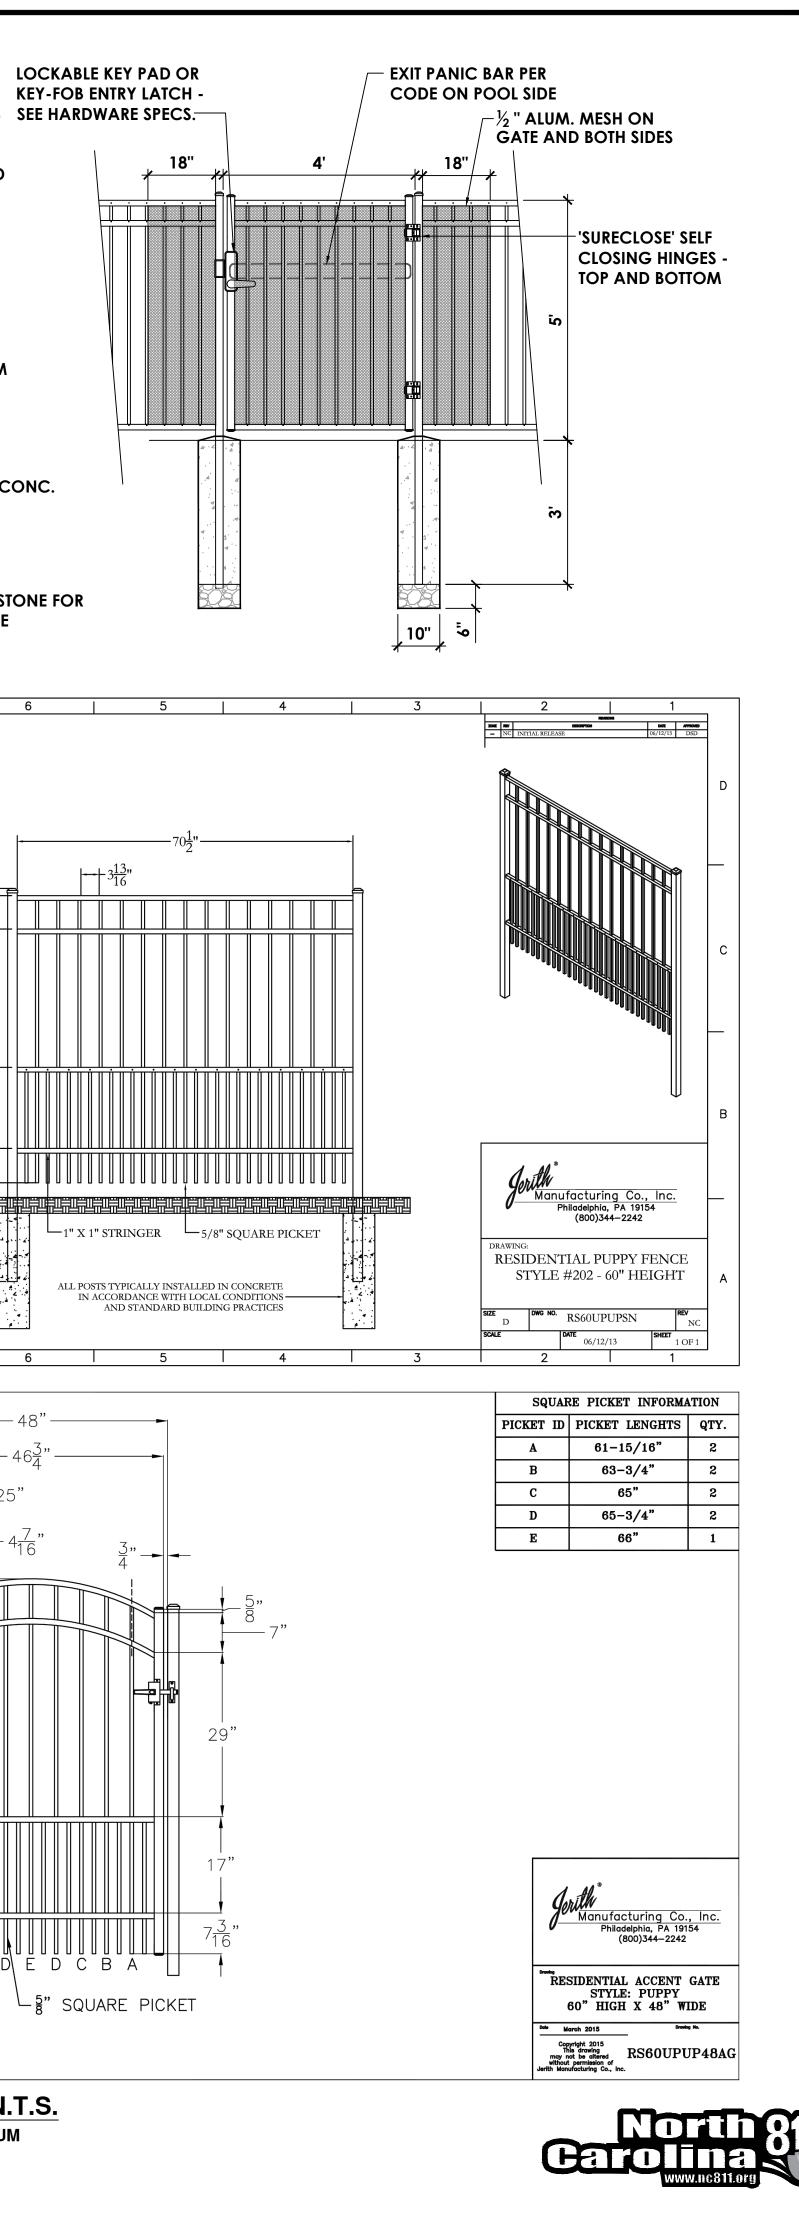

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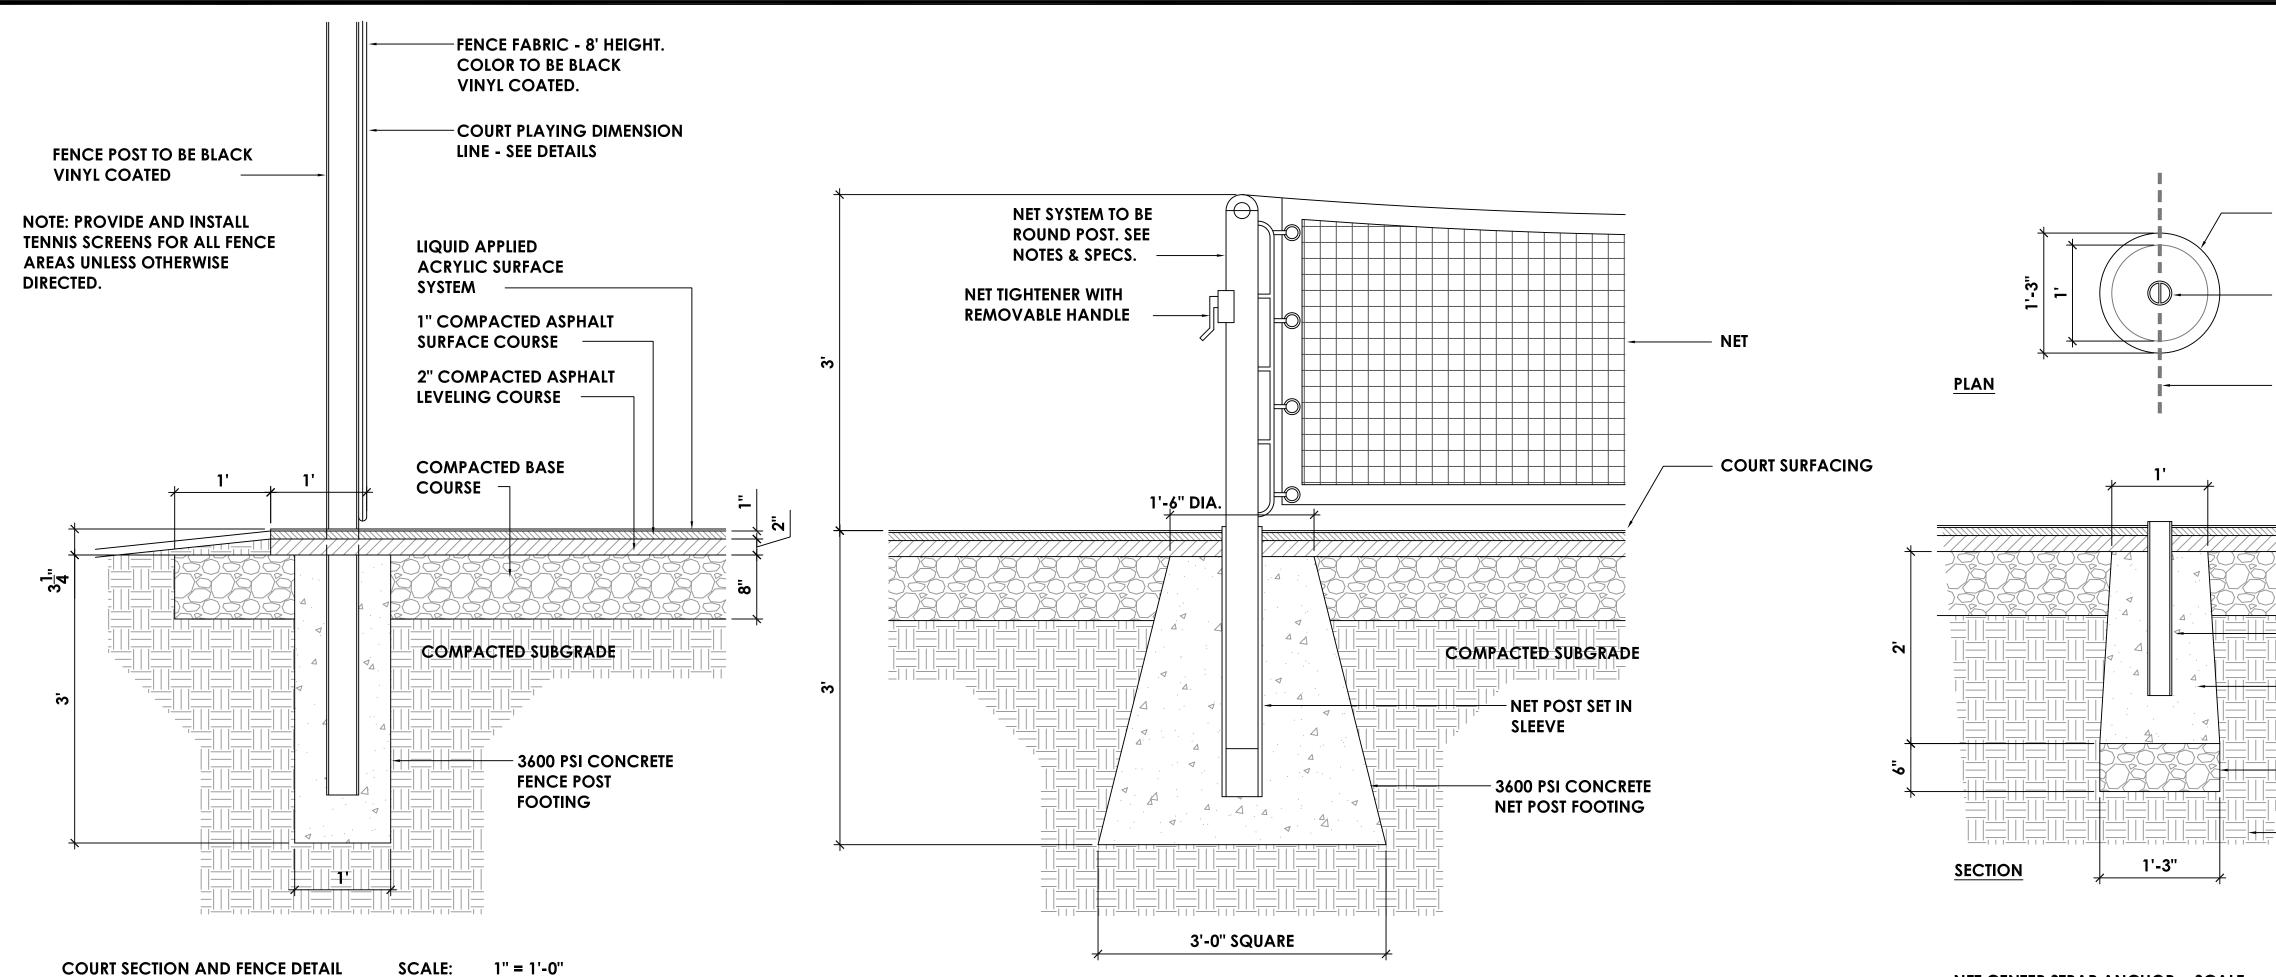
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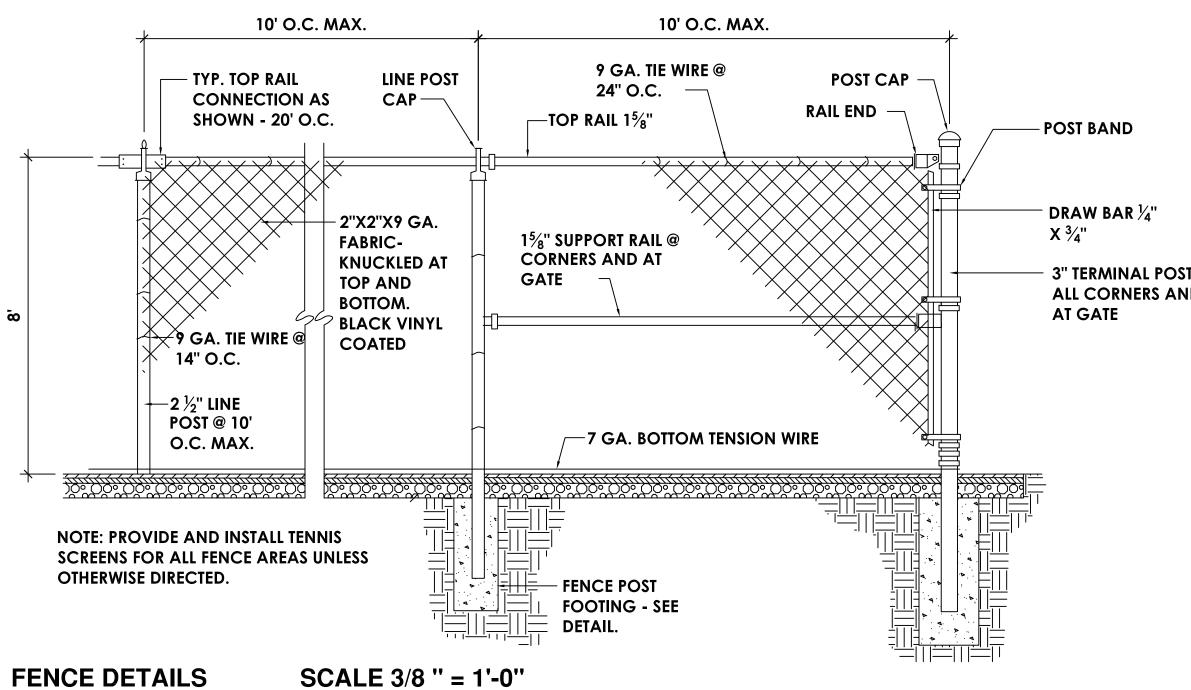
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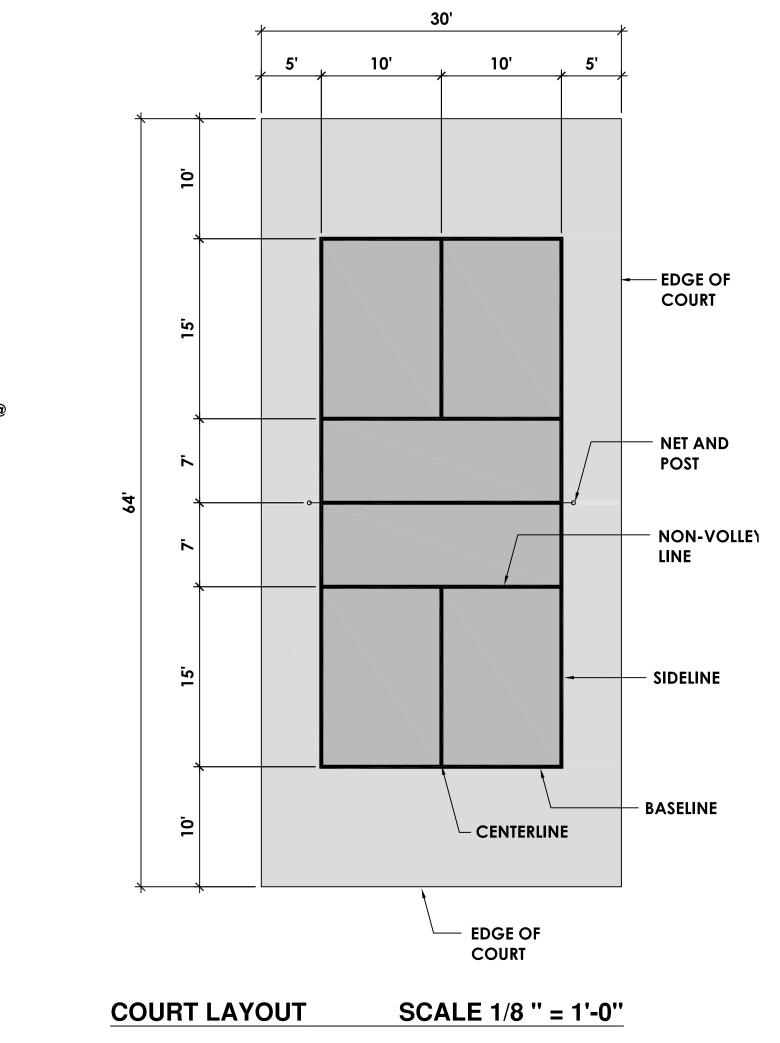

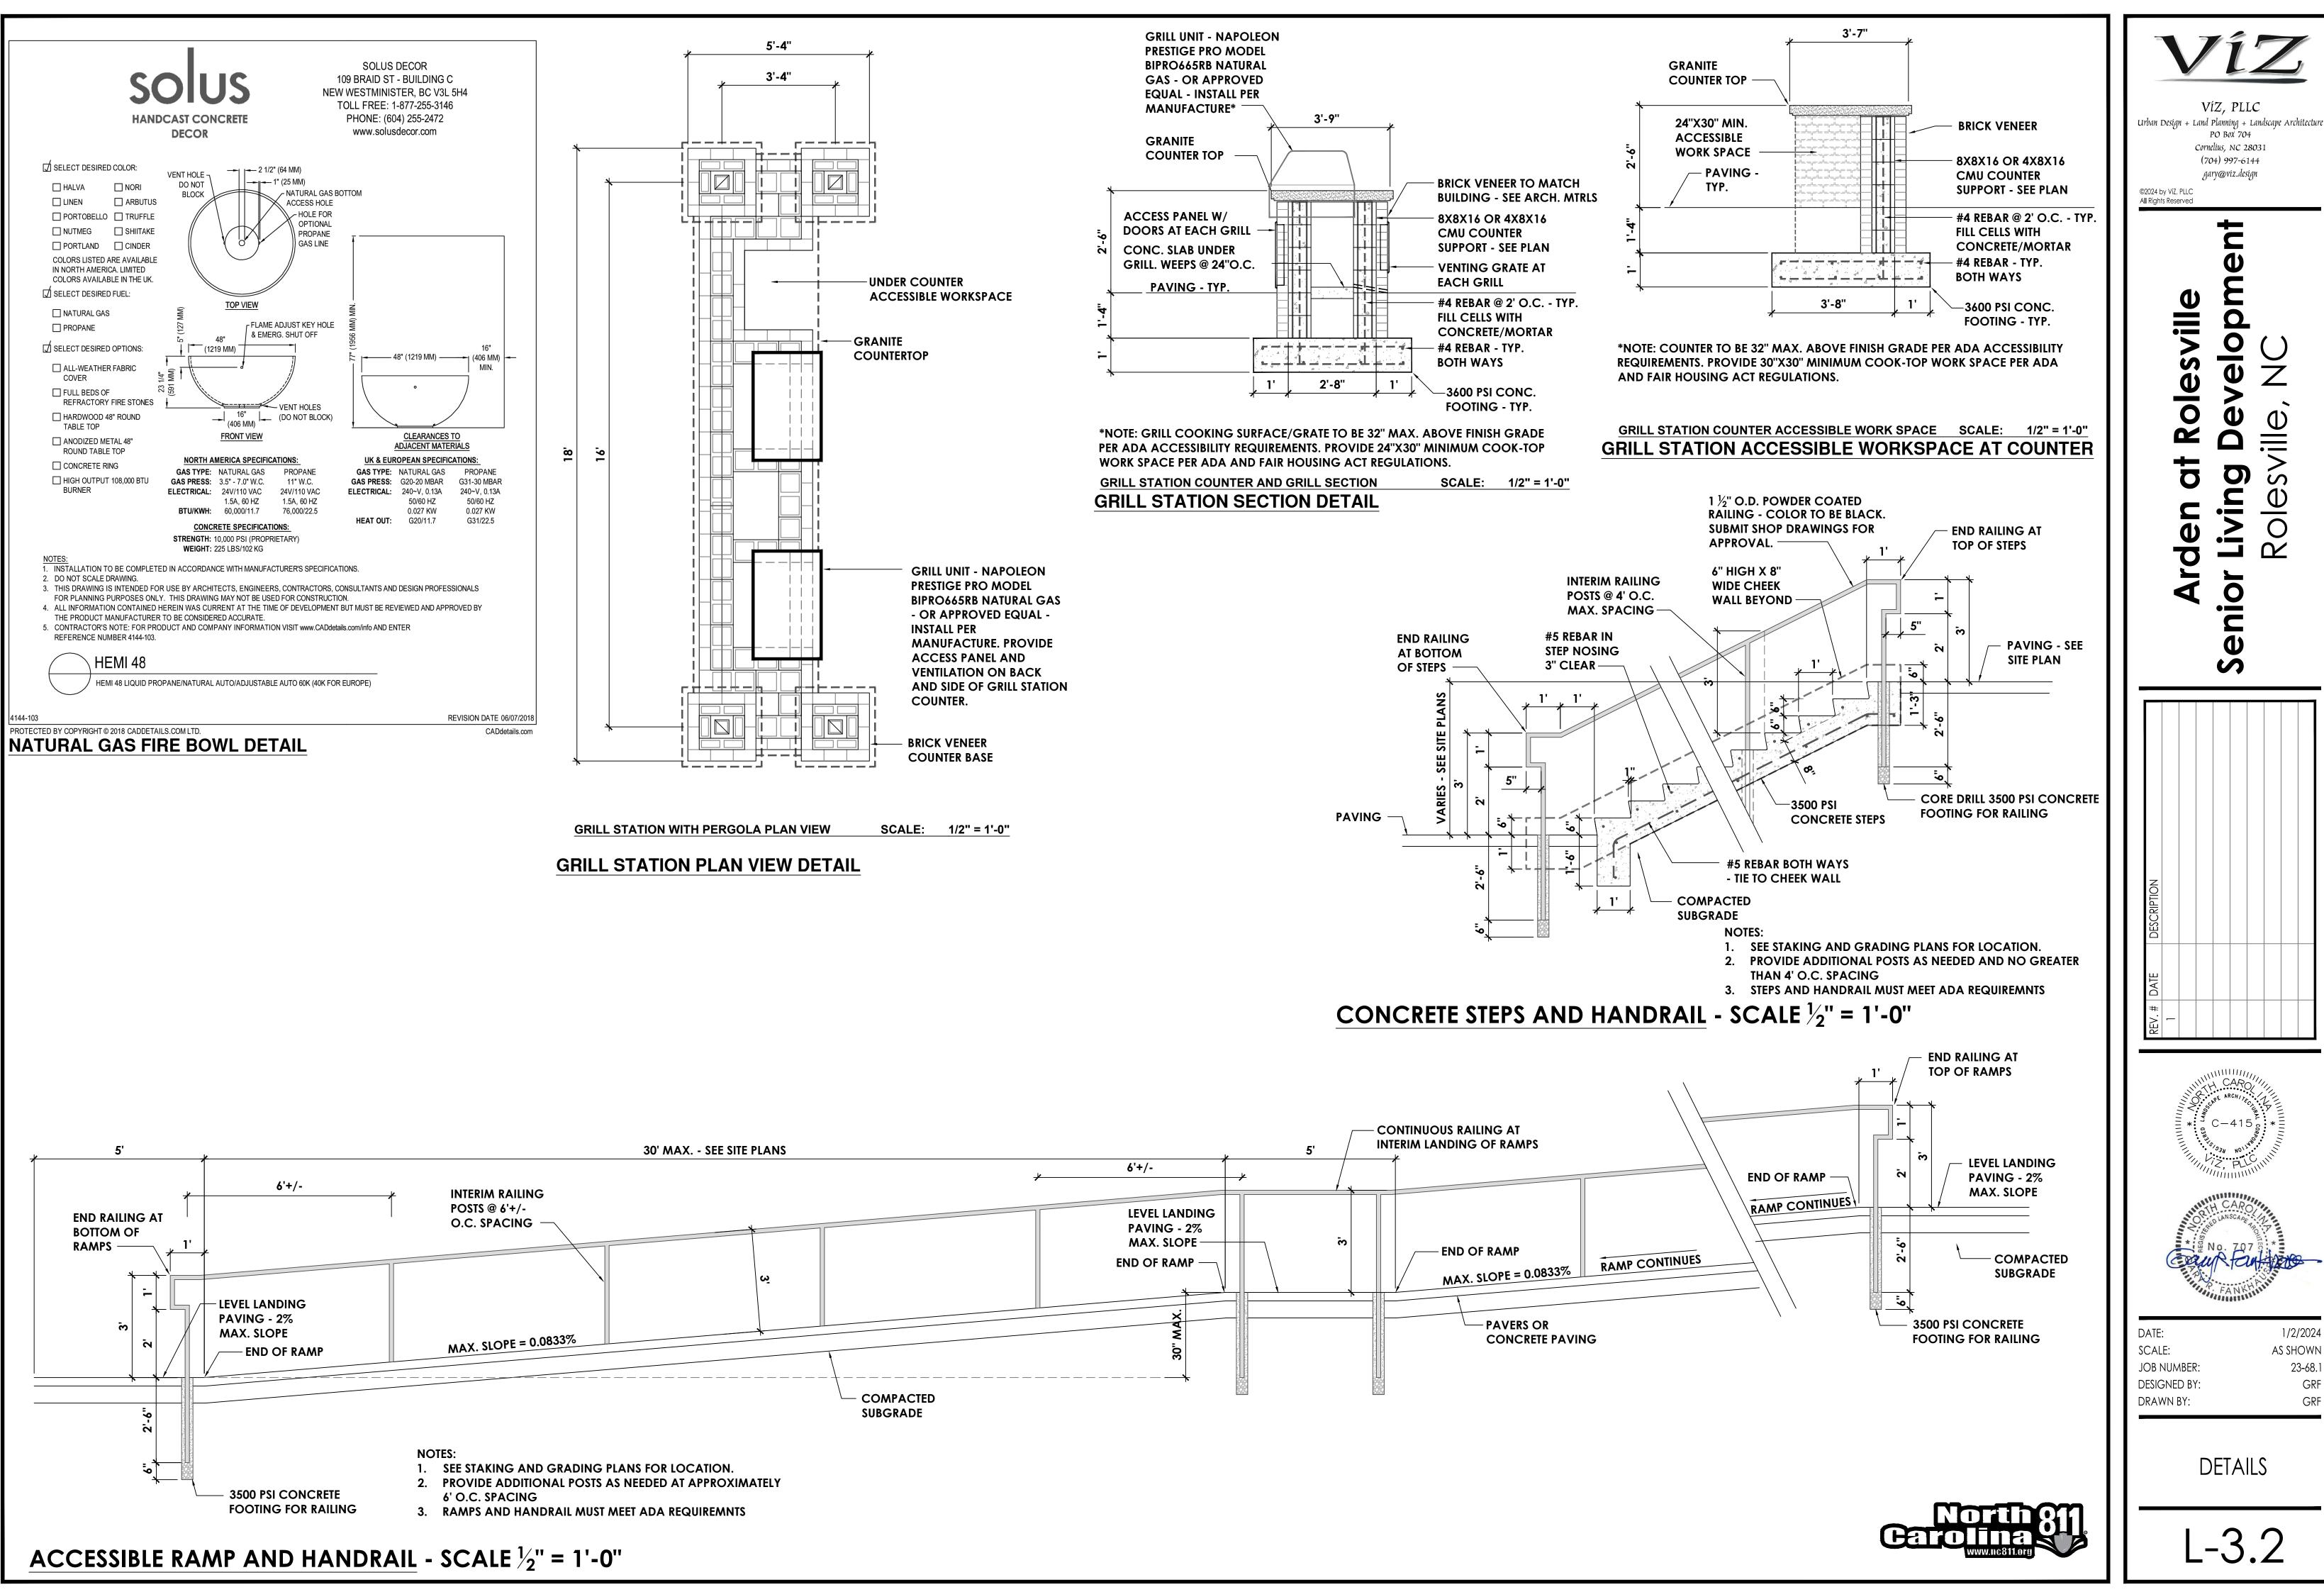
## **COURT DETAILS**




#### NET CENTER STRAP ANCHOR SCALE: 1'' = 1'-0''NOTE: CENTER STRAP ANCHOR TO BE HEAVY DUTY GALVANIZED STEEL WITH REPLACEABLE STAINLESS STEEL CENTER PIN

NET POST AND FOOTING SCALE: 1" = 1'-0"



- 3" TERMINAL POST @ ALL CORNERS AND

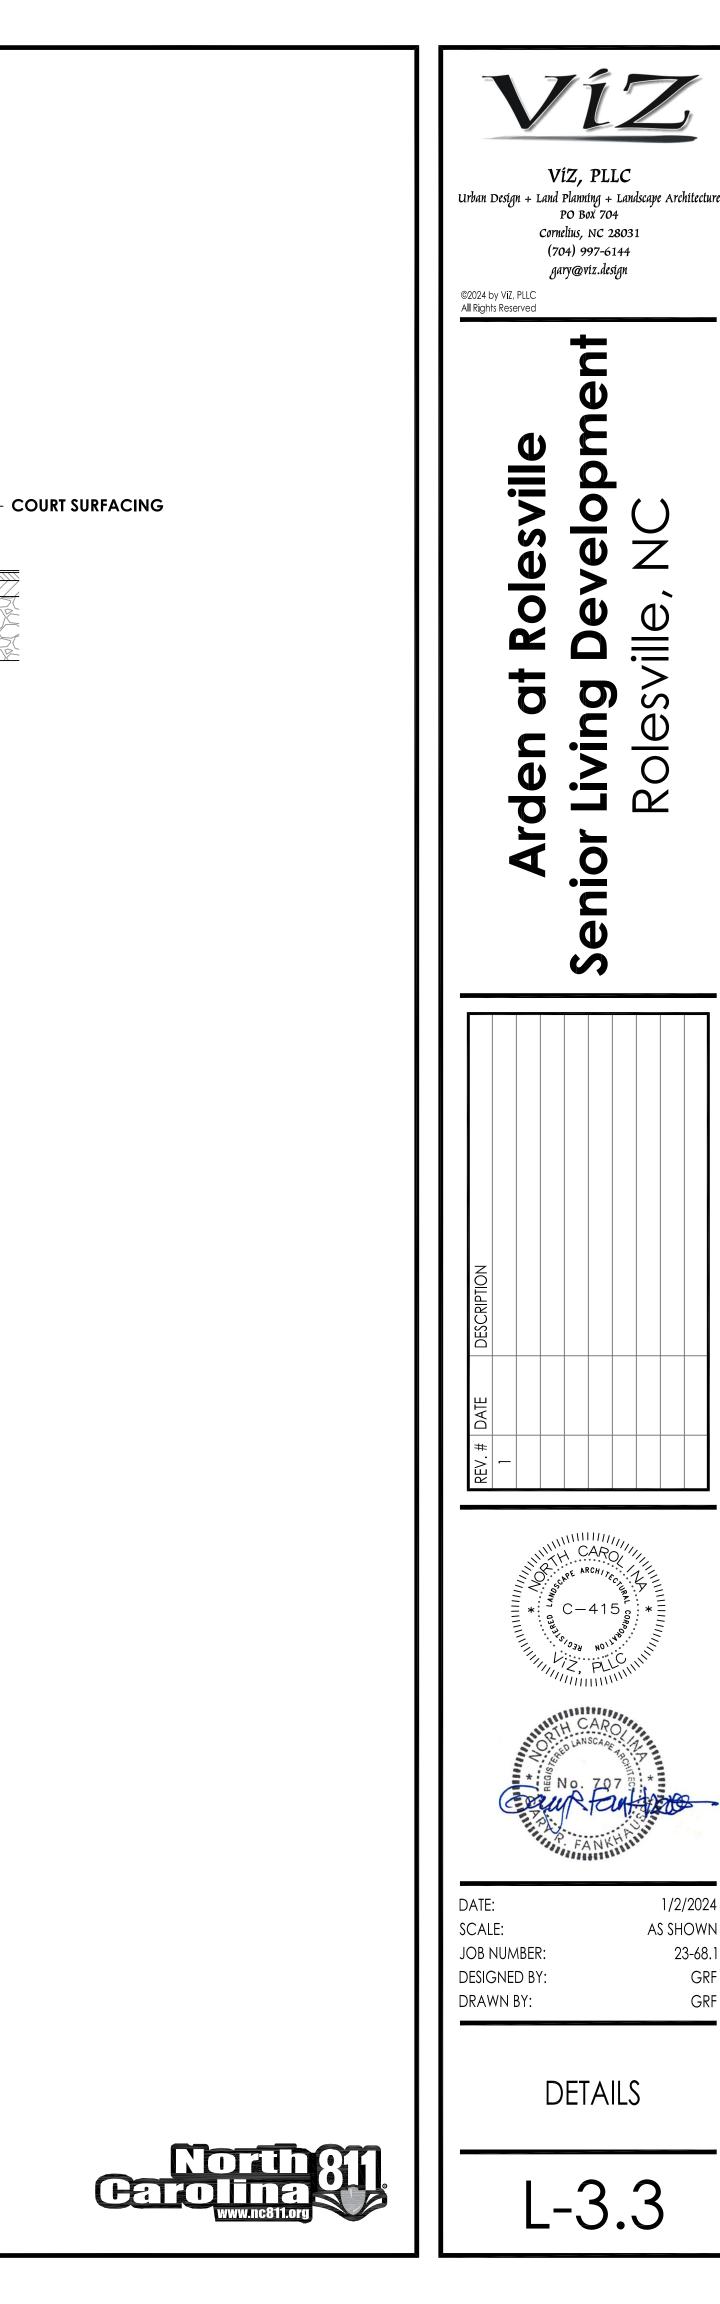

- CENTER STRAP

- 3600 PSI CONCRETE

NET POST FOOTING -

COMPACTED CRUSHED

**COMPACTED SUBGRADE** 

STONE BASE COURSE

CONE/BELL SHAPE

ANCHOR


- CONCRETE FOOTING (BELOW

CENTER STRAP ANCHOR ALIGN

COURT SURFACING)

PIN WITH TENNIS NET

NET LINE

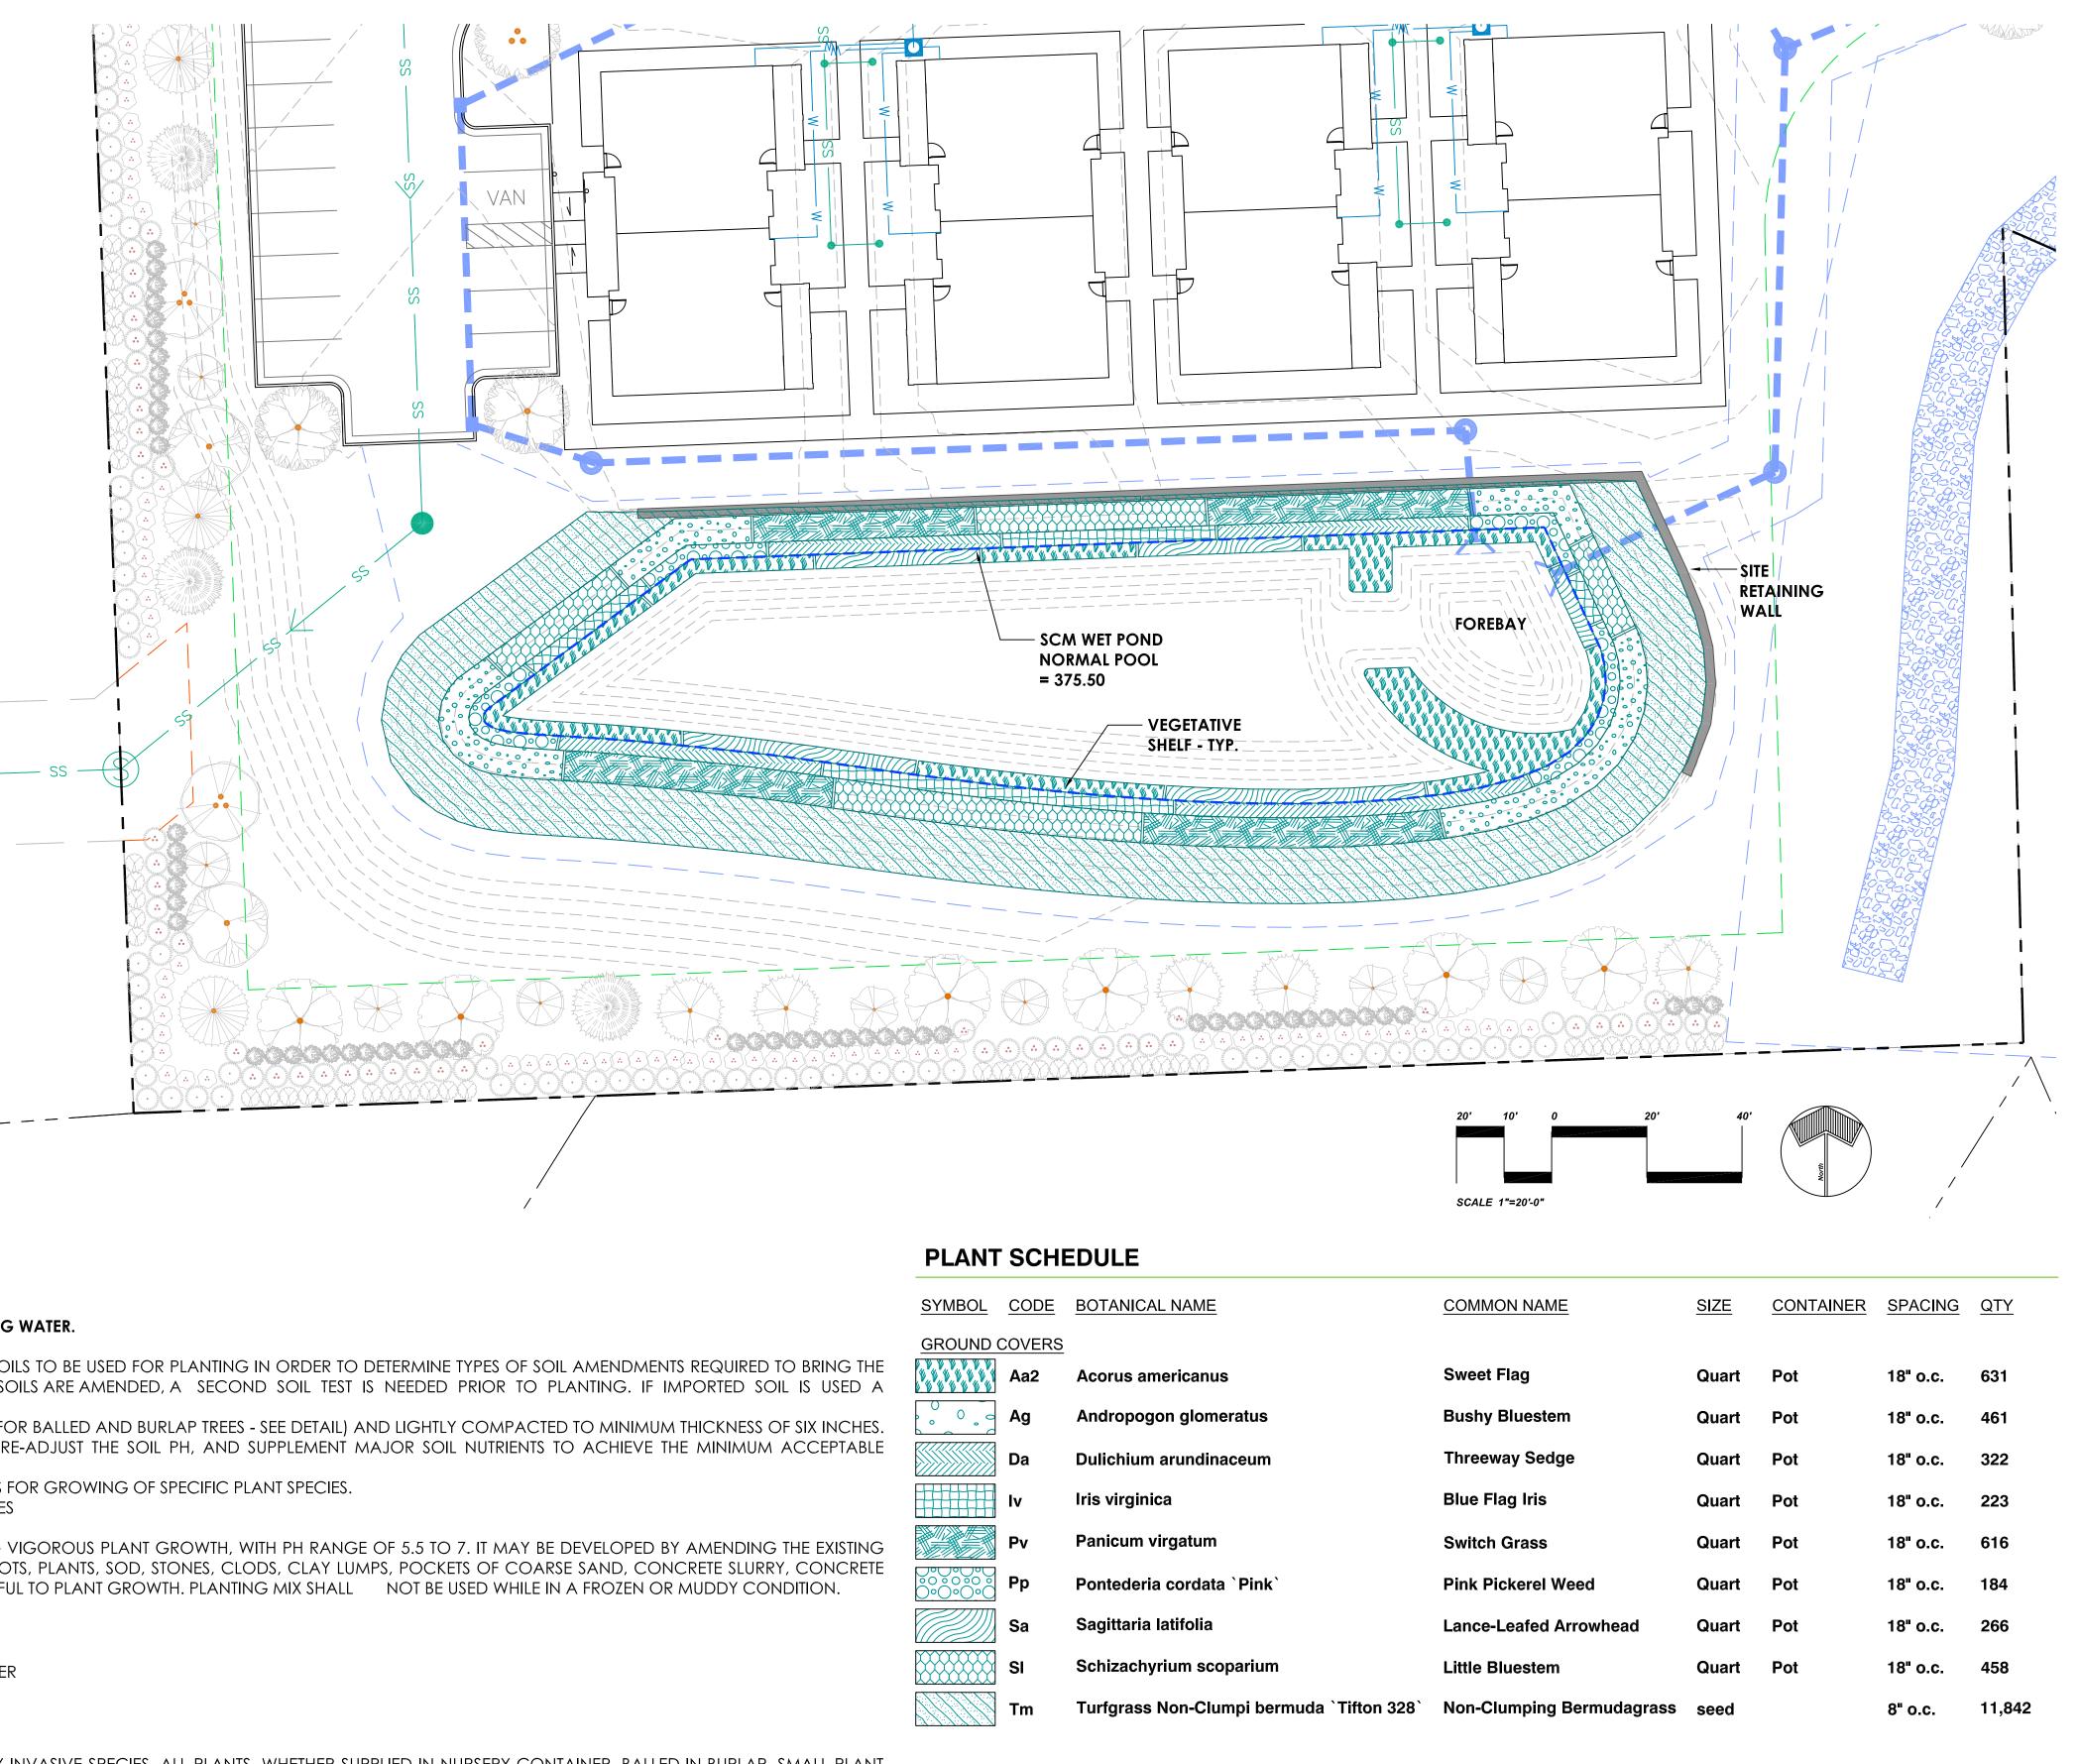

#### WET POND BMP PLANTING NOTES

#### 1. ALL PLANTING SHALL BE IN ACCORDANCE WITH THE NCDEQ STORMWATER BMP MANUAL.

- 2. NO PLANTING SHALL OCCUR UNTIL SOIL PREPARATION HAS OCCURRED.
- 3. TREES, SHRUBS, AND WOODY VEGETATION ARE NOT ALLOWED ON ANY EMBANKMENT IMPOUNDING WATER.
- 4. SOIL PREPARATION:
- SOIL TESTING: CONTRACTOR SHALL PROVIDE SOIL TESTING FOR EXISTING SOILS AND PREPARED SOILS TO BE USED FOR PLANTING IN ORDER TO DETERMINE TYPES OF SOIL AMENDMENTS REQUIRED TO BRING THE SOIL WITHIN THE CORRECT RANGES FOR OPTIMUM PLANT GROWTH. SOIL TESTING IS REQUIRED. IF SOILS ARE AMENDED, A SECOND SOIL TEST IS NEEDED PRIOR TO PLANTING. IF IMPORTED SOIL IS USED A MANUFACTURER CERTIFICATION IS REQUIRED.
- SOIL AMENDMENT: TOPSOIL SHALL BE SPREAD TO A DEPTH OF EIGHT TO TWELVE INCHES (DEEPER FOR BALLED AND BURLAP TREES SEE DETAIL) AND LIGHTLY COMPACTED TO MINIMUM THICKNESS OF SIX INCHES. IF TOPSOIL HAS BEEN STOCKPILED FOR A LONG PERIOD OF TIME, IT MAY BE NECESSARY TO RE-ADJUST THE SOIL PH, AND SUPPLEMENT MAJOR SOIL NUTRIENTS TO ACHIEVE THE MINIMUM ACCEPTABLE STANDARDS.
- SOIL AMENDMENTS AS REQUIRED FROM SOILS REPORT/TESTING AND AS ACCEPTABLE STANDARDS FOR GROWING OF SPECIFIC PLANT SPECIES.
- FERTILIZERS: ONLY AS GROWERS INDUSTRY RECOMMENDATIONS BASED ON SPECIFIC PLANT SPECIES
- PLANTING MIX:

PLANTING MIX: SHALL BE NATURAL, FERTILE, AGRICULTURAL TOPSOIL, CAPABLE OF SUSTAINING VIGOROUS PLANT GROWTH, WITH PH RANGE OF 5.5 TO 7. IT MAY BE DEVELOPED BY AMENDING THE EXISTING SOIL, OR REMOVING THE EXISTING SOIL AND REPLACING WITH NEW SOIL. IT SHALL BE FREE OF ROOTS, PLANTS, SOD, STONES, CLODS, CLAY LUMPS, POCKETS OF COARSE SAND, CONCRETE SLURRY, CONCRETE LAYERS OR CHUNKS, CEMENT, PLASTER, BUILDING DEBRIS, AND OTHER EXTRANEOUS MATERIALS HARMFUL TO PLANT GROWTH. PLANTING MIX SHALL NOT BE USED WHILE IN A FROZEN OR MUDDY CONDITION. 5. PLANTING SEASONS

FOR PLANTING SEASONS, CONFORM TO THE FOLLOWING GENERAL GUIDELINES:

SEEDING GRASSES AND MEADOWS: FALL SEASON

INSTALLING PLUGS AND QUART POTS - WET POND PLANTS (HERBACEOUS EMERGENTS): SPRING, SUMMER

INSTALLING CONTAINER GROWN PLANTS: DORMANT SEASON

INSTALLING BALLED-IN-BURLAP PLANTS DORMANT SEASON

#### 6. NEW PLANT PROCUREMENT :

ALL PLANTS SHOULD BE WELL GROWN AND HEALTHY, AND FREE FROM DISEASE AND INFESTATION BY INVASIVE SPECIES. ALL PLANTS, WHETHER SUPPLIED IN NURSERY CONTAINER, BALLED-IN-BURLAP, SMALL PLANT CONTAINER OR PLUG, SHALL CONFORM TO THE SPECIFICATIONS IN THE AMERICAN STANDARDS FOR NURSERY STOCK, ANSI Z60.1 - 2014, OR LATEST EDITION. 7. PLANTING PROCEDURES

CONFORM TO ALL APPLICABLE SPECIFICATIONS FOR PLANTINGS OF TREES AND SHRUBS, AS DETAILED IN THE NCDEQ STORMWATER BMP MANUAL. LAY OUT ALL PLANTS AS INDICATED ON THE PLANTING PLAN AND ACCORDING TO SPECIES MIXES, AND AT SPECIFIED SPACING AND DENSITIES.

#### 8. WATERING

THE CONTRACTOR IS RESPONSIBLE FOR WATERING ALL PLANTS AT A RATE OF A MINIMUM OF ONE INCH OF WATER PER WEEK OR GREATER AS NEEDED AND DETERMINED BY STANDARD HORTICULTURAL PRACTICES. THE CONTRACTOR SHALL BE RESPONSIBLE FOR WATERING UNTIL FINAL ACCEPTANCE BY THE OWNER. ALL WATER SHALL BE POTABLE AND FROM SOURCES GUARANTEED SAFE FROM IMPURITIES AND SALINITIES. TEMPORARY IRRIGATION: PER THE DIRECTION AND OWNER APPROVAL, THE CONTRACTOR MAY INSTALL A TEMPORARY AUTOMATIC IRRIGATION SYSTEM TO SUSTAIN PLANT MOISTURE. 9. HERBIVORE CONTROL

THE CONTRACTOR SHALL BE RESPONSIBLE FOR ENSURING PROTECTION OF PLANT MATERIAL BY LOCAL WILDLIFE (GEESE, MUSKRATS, BEAVERS, DEER, ETC.) UNTIL FINAL ACCEPTANCE BY THE OWNER. RECOMMENDED CONTROL MEASURES ARE LISTED IN THE BMP MANUAL. THE OWNER MAY ELECT TO KEEP HERBIVORE CONTROL MEASURES IN PLACE AFTER PROJECT FINAL ACCEPTANCE.

YMBOL	CODE	BOTANICAL NAME					
ROUND COVERS							
	Aa2	Acorus americanus					
	Ag	Andropogon glomeratus					
	Da	Dulichium arundinaceum					
	lv	Iris virginica					
	Pv	Panicum virgatum					
$\mathbb{O}^{\mathbb{O}} \mathbb{O}^{\mathbb{O}} \mathbb{O}^{\mathbb{O}}$	Рр	Pontederia cordata `Pink`					
	Sa	Sagittaria latifolia					
	SI	Schizachyrium scoparium					
	Tm	Turfgrass Non-Clumpi bermuda `					

