PRESTLEIGH AT JONES DAIRY


V1 - SDP-24-02

VICINITY MAP

SCALE: 1" = 200'

SITE DEVELOPMENT PLAN AMENITY CENTER

Add Site address, Book and Page of the recorded final plat, and existing lot number / Open space area as designated on the final plat.

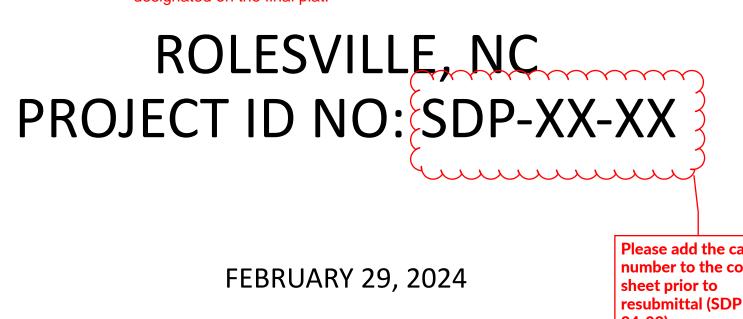

OWNER/DEVELOPER

PRESERVE AT JONES DAIRY, LLC 10534 ARNOLD PALMER DRIVE RALEIGH, NC 27617 919-491-0761

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•	PROPOSE	D SITE	DATA - AMENITY CENTER)		
•	BUILDING AREA		788 SF	1 イ		
	NUMBER OF STORIE	S	1 STORY	Ι イ		
	IMPERVIOUS AREA		9,376 SF	ΙΖ		
•	PROPOSED USE		AMENITY CENTER (POOL HOUSE AND POOL)] <i>)</i>		
W	سس	ىب		رر		
	SITE DATA - SUBDIVISION					
	ZONING		R & PUD			
	EXISTING SITE AREA		88.59 ACRES (3,859,005 SF)			
	R/W DEDICATION		0.78 ACRES (34,140 SF) JONES DAIRY ROAD			
	OTHER DEDICATIONS		0.15 ACRES (6,824 SF) AVERETTE ROAD SIDEWALK			
	PROPOSED NET SITE AREA		87.66 ACRES (3,818,041 SF)			
	PROPOSED USE		SINGLE FAMILY AND TOWNHOME UNITS			
	SINGLE FAMILY UNITS		260 UNITS			
	TOWNHOME UNITS		179 UNITS			
	TOTALS UNITS		439 UNITS			
	SINGLE FAMILY AREA	A (GROSS)	68.52 ACRES (2,984,678 SF)			
	TOWNHOME AREA (GROSS)	20.07 ACRES (874,327 SF)			
	DENSITY					
	SINGLE FAMILY	260 UNIT	S/68.52 ACRES = 3.79 UNITS/ACRE			
	TOWNHOME	179 UNIT	S/20.07 ACRES = 8.92 UNITS/ACRE			
	CENTRAL	439 UNIT	S/88.59 ACRES = 4.96 UNITS/ACRE			

Please provide the lot information, including lot size, setbacks, total acreage to be disturbed in accordance with 3.1.2.1 of the UDO.

	SHEET INDEX	
SHEET NO.	SHEET NAME	MOST CURRENT REVISION DATE
C1.0	EXISTING CONDITIONS PLAN	2/29/2024
C2.0	SITE PLAN	2/29/2024
C3.0	UTILITY PLAN	2/29/2024
C4.0	GRADING PLAN	2/29/2024
D1.0	SITE DETAILS	2/29/2024

PRESERVE AT JONES DAIRY - CENTRAL

PARCEL PINS:
• 1759992822

18509067871769094682

STORMWATER MANAGEMENT NOTE

- STORMWATER MANAGEMENT CALCULATIONS PREVIOUSLY PROVIDED AS PART OF PRESERVE AT JONES DAIRY CENTRAL SURDIVISION PLANS
- THE PROJECT IS NOT LOCATED IN A WATERSUPPLY WATERSHED PROTECTION OVERLAY DISTRICT.
 THE PROJECT DOES NOT CONTAIN SPECIAL FLOOD HAZARD AREAS.



CITY OF RALEIGH - PLANS AUTHORIZED FOR CONSTRUCTION

ELECTRONIC APPROVAL: THIS APPROVAL IS BEING ISSUED ELECTRONICALLY. THIS APPROVAL IS VALID ONLY
UPON THE SIGNATURE OF A CITY OF RALEIGH REVIEW OFFICER BELOW. THE CITY WILL RETAIN A COPY OF
THE APPROVED PLANS. ANY WORK AUTHORIZED BY THIS APPROVAL MUST PROCEED IN ACCORDANCE WITH
THE PLANS KEPT ON FILE WITH THE CITY. THIS ELECTRONIC APPROVAL MAY NOT BE EDITED ONCE ISSUED.
ANY MODIFICATION TO THIS APPROVAL ONCE ISSUED WILL INVALIDATE THIS APPROVAL.

RALEIGH WATER REVIEW OFFICER

CITY OF RALEIGH DEVELOPMENT APPROVAL _


TOWN OF ROLESVILLE
PROJECT IDENTIFICATION #
SDP-XX-XX

ALL CONSTRUCTION SHALL BE IN ACCORDANCE WITH TOWN OF ROLESVILLE STANDARDS AND SPECIFICATIONS



PO Box 810 Rolesville, NC 27571 919-435-6395 NCBELS License P-0751

PRELIMINARY DRAWING - NOT RELEASED FOR CONSTRUCTION

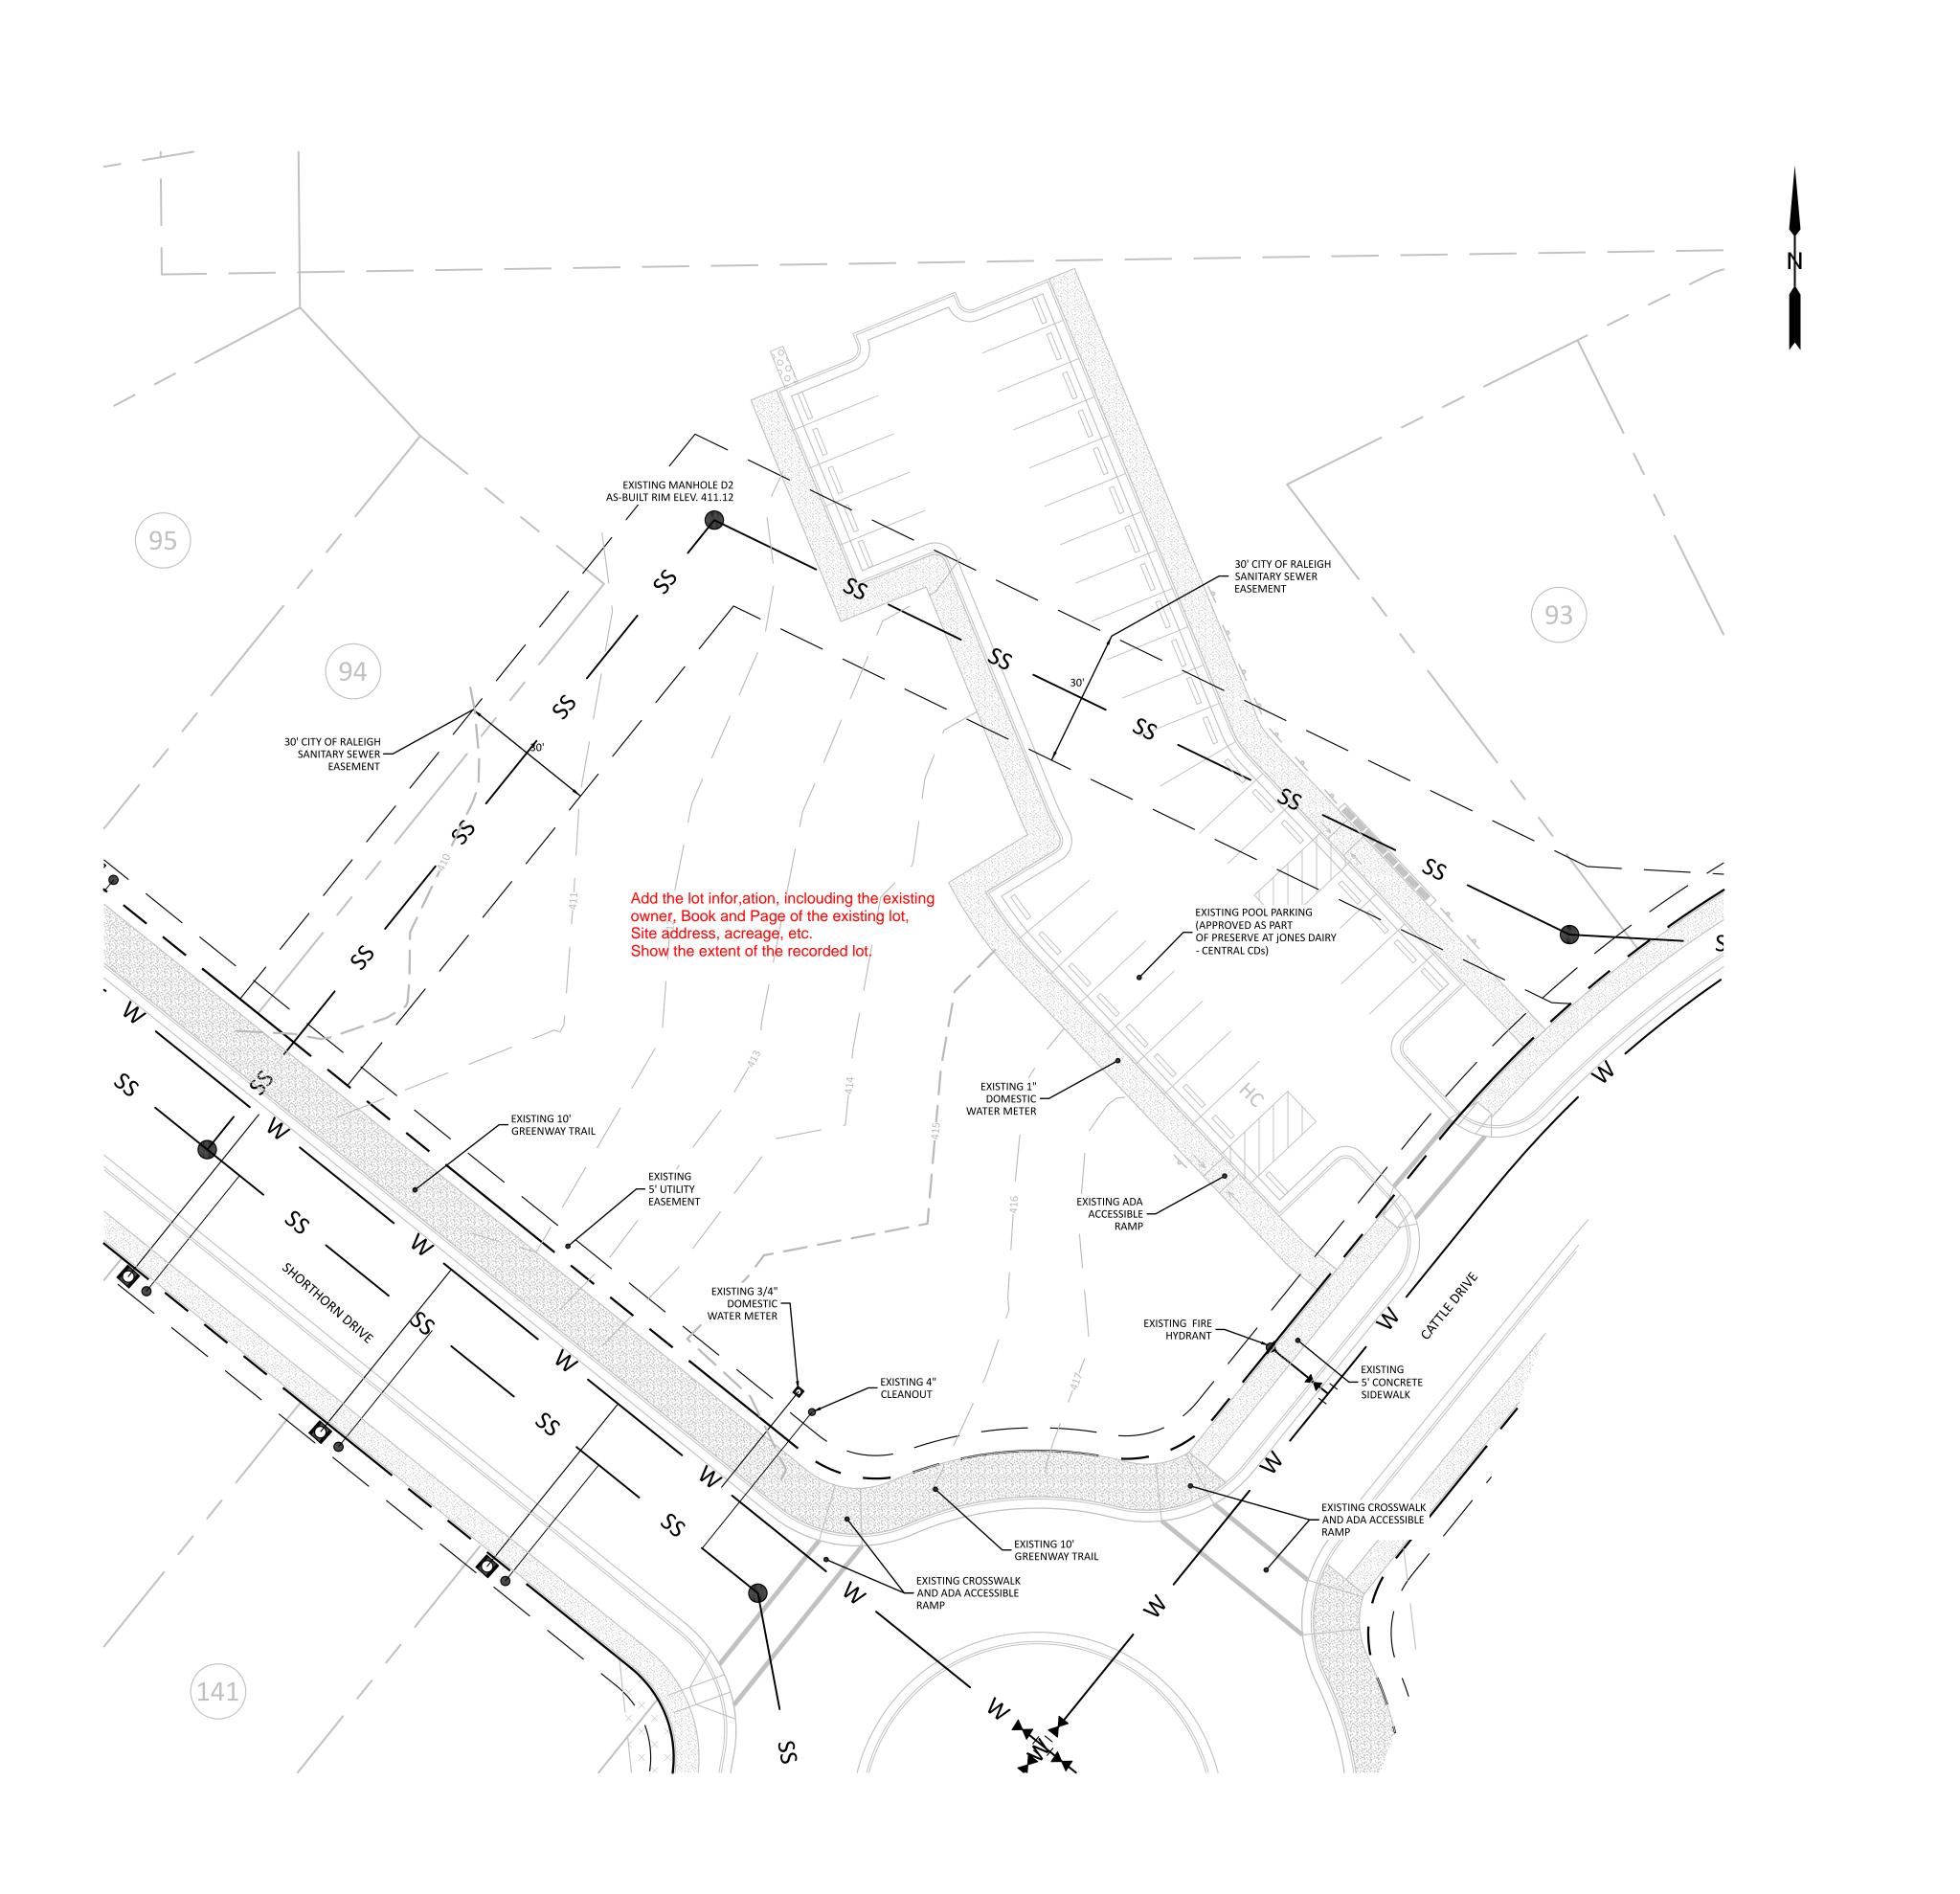

EXISTING (CONDITIONS SOURCES
EXISTING CONDITION	SOURCE
PROPERTY BOUNDARY	CAD FILE FROM CAWTHORNE MOSS AND PANCIERA
EXISTING TOPOGRAPHY	CAD FILE FROM CAWTHORNE MOSS AND PANCIERA
WETLANDS AND STREAM CHANNELS	N/A
FLOODPLAIN	SITE NOT WITHIN A FLOOD PLAIN PER FEMA MAPS 3720185000J AND 3720186000J
EXISTING SANITARY SEWER AT OUTFALL	CAD FILE FROM CAWTHORNE MOSS AND PANCIERA

EXISTING CONDITIONS NOTES

- EXISTING CONDITIONS TAKEN FROM PRESERVE AT JONES DAIRY CENTRAL CONSTRUCTION DRAWINGS PREPARED BY THE NAU COMPANY.
 TOPOGRAPHY FOR SITE TAKEN FROM ELECTRONIC CAD FILE PROVIDED BY: CAWTHORNE, MOSS & PANCIERA, PC. (CMA).

- (CMP).

 3. OFFSITE TOPOGRAPHIC INFORMATION TAKEN FROM WAKE COUNTY GIS.

 4. THE SURVEYOR DID NOT EXAMINE OR CONSIDER SUBSURFACE OR ENVIRONMENTAL CONDITIONS FOR THIS SURVEY. ALL BUILDINGS, SURFACE AND SUBSURFACE IMPROVEMENTS ON AND ADJACENT TO THE SITE ARE NOT NECESSABILY SHOWN THE SITE ARE NOT NECESSARILY SHOWN.
- 5. THE LOCATION OF UNDERGROUND UTILITIES AS SHOWN ARE BASED ON VISIBLE EVIDENCE AND DRAWINGS PROVIDED TO THE SURVEYOR. THE LOCATION OF UNDERGROUND UTILITIES AND STRUCTURES MAY VARY FROM THE LOCATIONS SHOWN AND ADDITIONAL BURIED
- UTILITIES MAY EXIST.

 6. SURVEY PERFORMED WITHOUT BENEFIT OF TITLE
 EXAMINATION BY A LICENSED ATTORNEY. THE PROPERTY IS SUBJECT TO ALL EASEMENTS AND RESTRICTIONS OF RECORD. NO TITLE EXAMINATION HAS BEEN PERFORMED BY THE SURVEYOR OR THE NAU COMPANY, PLLC.
- 7. TOPOGRAPHIC CONTOURS ARE SHOWN AT 2' INTERVALS FROM APPROVED CONSTRUCTION DRAWINGS. CONTRACTOR SHALL FIELD VERIFY ALL GRADES PRIOR TO ANY CONSTRICTION AND REPORT ANY DISCREPANCIES TO THE ENGINEER IMMEDIATELY.

EXISTING CONDITIONS LEGEND

EX. WATER PIPE

EXISTING CONDITIONS LI	EGEND
EXISTING PROPERTY BOUNDARY	
EXISTING RIGHT-OF-WAY	
EXISTING PROPERTY LINE	
EXISTING EASEMENT	
EXISTING SETBACK	
EXISTING PROPERTY BUFFER	
EXISTING ROAD CENTERLINE	
EXISTING CURB & GUTTER (ROAD)	
EXISTING CURB & GUTTER (PARKING)	
EXISTING SIDEWALK	
EXISTING SIDEWALK EXISTING MAJOR (5') CONTOUR	
EXISTING MAJOR (5') CONTOUR	
EXISTING MAJOR (5') CONTOUR EXISTING MINOR (1') CONTOUR	
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EXISTING MAJOR (5') CONTOUR EXISTING MINOR (1') CONTOUR EXISTING GIS MAJOR (5') CONTOUR EXISTING GIS MINOR (1') CONTOUR EX. STORM SEWER PIPE EX. STORM SEWER STRUCTURES	

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SCALE: 1"=20' PRELIMINARY DRAWING - NOT RELEASED FOR CONSTRUCTION

PRESTLEIGH AT JONES DAI AMENITY CENTER **EXISTING CONDITIONS PLAI** PROJECT NO:

DESIGN BY:

DRAWN BY:

SCALE:

JJB

RSF

1"=20'

2024-02-29


C1.0

The Nau Company
Consulting Civil Engineers

Property boundaries shall be identified

Site Lighting and street light locations shall be clearly indicated (Lighting plan should be

Landscaping Plan should be provided to include street trees, revised parking area and amenity center landscaping as well as any required buffers.

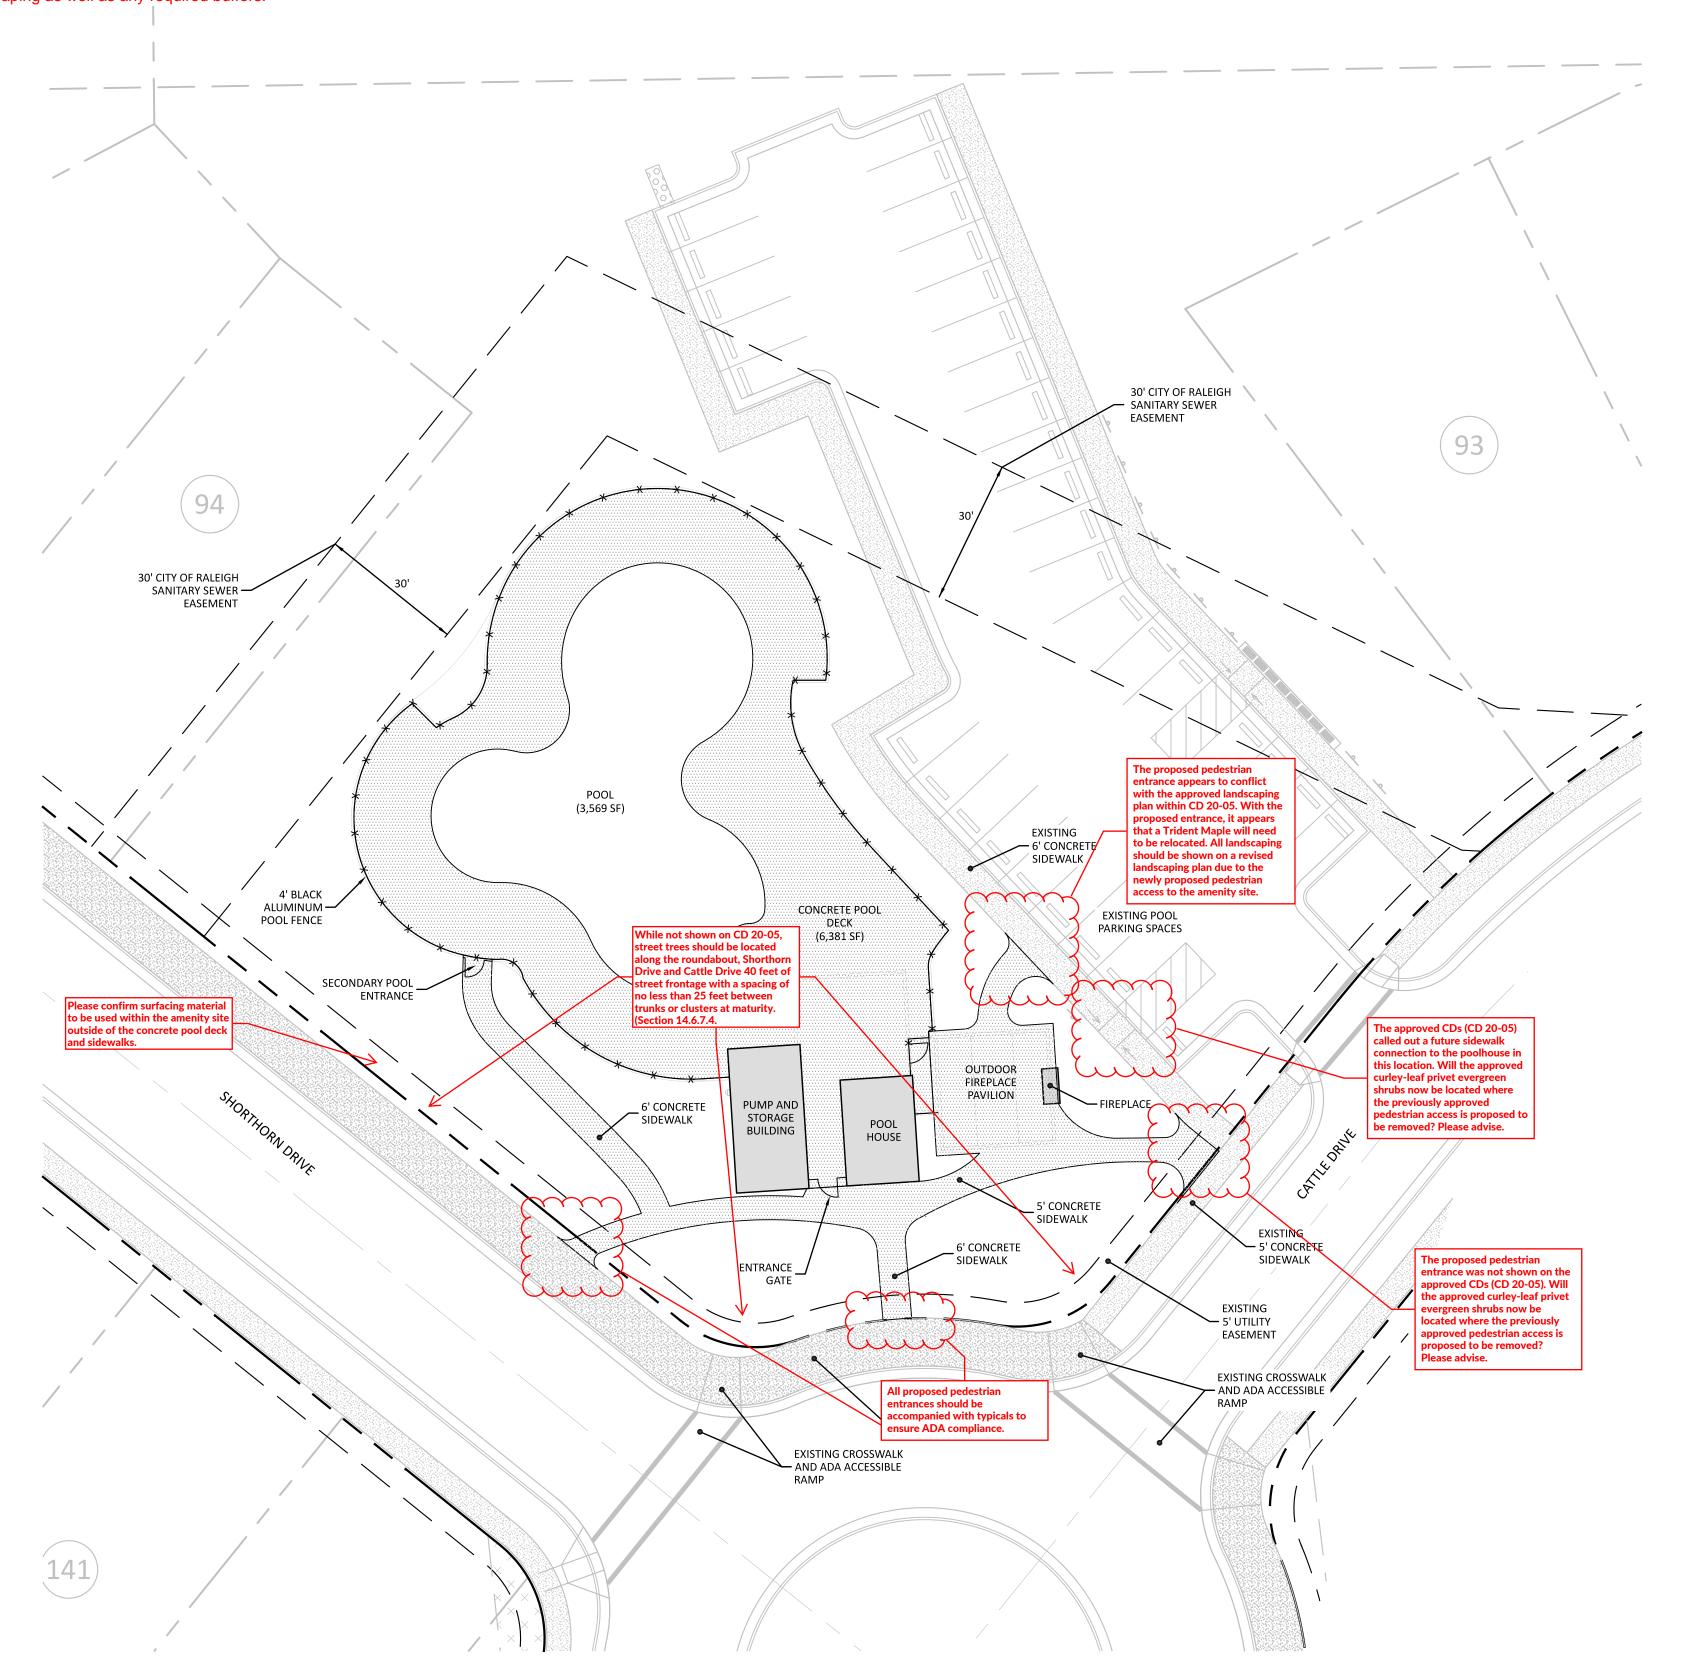



GENERAL NOTES

- 1. THE DEVELOPER, CONTRACTOR, SUBCONTRACTORS AND SURVEYOR SHALL CONFIRM THAT THE MOST CURRENT SET OF PLANS AND/OR PLAN SHEET(S) ARE BEING USED FOR CONSTRUCTION AND SHALL KEEP A COPY OF SAID PLANS ON-SITE OR OTHERWISE AVAILABLE FOR REVIEW BY THE OWNER. THE
- OWNER'S REPRESENTATIVE(S) AND THE PERMITTING AUTHORITIES. 2. PRIOR TO CONSTRUCTION, THE CONTRACTOR SHALL SCHEDULE A PRECONSTRUCTION CONFERENCE WITH REPRESENTATIVES OF THE
- PERMITTING AUTHORITIES AND A REPRESENTATIVE OF THE OWNER. 3. THE CONTRACTOR SHALL CONFIRM THAT ALL REQUIRED PERMITS AND APPROVALS HAVE BEEN OBTAINED FOR THE PROPOSED CONSTRUCTION. BEGINNING ANY ASPECT OF CONSTRUCTION OR FABRICATING ANY ITEM PRIOR TO RECIEVING ALL PLANS AND APPROPRIATE DOCUMENTATION OF APPROVAL SHALL CAUSE THE CONTRACTOR TO ASSUME FULL REPONSIBILITY FOR ANY SUBSEQUENT MODIFICATIONS TO THEIR WORK.
- 4. THE CONTRACTOR SHALL CONFIRM THAT ALL CONSTRUCTION AND CONSTRUCTION MATERIALS ARE IN ACCORDANCE WITH THE PERMITS ISSUED AND THE LATEST APPLICABLE FEDERAL, STATE, COUNTY, AND LOCAL CODES. IN THE EVENT OF CONFLICT BETWEEN ANY OF THESE STANDARDS, SPECIFICATIONS, OR PLANS, THE MOST STRINGENT SHALL GOVERN.
- 5. THE CONTRACTOR SHALL DETERMINE AND BE RESPONSIBLE FOR THE MEANS AND METHODS NECESSARY FOR THE CONSTRUCTION OF THE PROJECT AS SHOWN ON THESE PLANS.
- 6. THE CONTRACTOR IS RESPONSIBLE FOR COORDINATING WITH THE APPROPRIATE PERMITTING AUTHORITY TO PROVIDE THE REQUIRED COORDINATION, DOCUMENTATION AND INSPECTIONS FOR THE RELOCATION OF, OR CONNECTION TO ANY EXISTING UTILITIES.
- 7. THE CONTRACTOR IS RESPONSIBLE FOR COORDINATING INSPECTIONS REQUIRED TO PREPARE AS-BUILT CERTIFICATIONS.
- 8. THE DEVELOPER IS RESPONSIBLE FOR OBTAINING ANY OFFSITE EASEMENTS. 9. PRIOR TO CONSTRUCTION THE CONTRACTOR SHALL VERIFY THAT ALL NECESSARY RIGHT OF WAY, EASEMENTS AND ENCROACHMENT AGREEMENTS HAVE BEEN OBTAINED.
- 10. THE CONTRACTOR SHALL CONFIRM THE LOCATION AND ELEVATION OF ALL EXISTING UTILITIES (INCLUDING STORM STRUCTURES) WITHIN THE LIMITS OF CONSTRUCTION PRIOR TO BEGINNING CONSTRUCTION AND NOTIFY THE OWNER OR ENGINEER OF ANY DISCREPANCIES. BEGINNING CONSTRUCTION PRIOR TO LOCATING UTILITIES WITHIN THE LIMITS OF CONSTRUCTION AND NOTIFYING THE OWNER OR ENGINEER OF ANY DISCREPANCIES SHALL CAUSE THE CONTRACTOR TO ASSUME FULL RESPONSIBILITY FOR ANY SUBSEQUENT MODIFICATIONS TO THEIR WORK.
- 11. DEPARTURES FROM THE APPROVED CONSTRUCTION DRAWINGS, MUNICIPAL SPECIFICATIONS OR ISSUED PERMITS THAT ARE DEEMED NECESSARY SHALL COORDINATED WITH THE APPROPRIATE PERMITTING AUTHORITY. CHANGES MADE WITHOUT THE APPROPRIATE APPROVAL SHALL CAUSE THE CONTRACTOR TO ASSUME RESPONSIBILITY FOR ANY SUBSEQUENT MODIFICATIONS TO THEIR WORK.
- 12. THE STAKING SURVEYOR AND/OR THEIR SUBCONTRACTOR SHALL INDEPENDENTLY VERIFY THE HORIZONTAL AND VERTICAL DATUM FOR THIS PROJECT PRIOR TO CONSTRUCTION.
- 13. RETAINING WALLS SHALL BE DESIGNED BY OTHERS.
- 14. THE CONTRACTOR SHALL NOTE THAT THE PLANS DO NOT SHOW EVERY OFFSET,
- TRANSITION, FITTING ETC. THAT MAY BE REQUIRED FOR CONSTRUCTION. 15. ALL GRADING, DIMENSIONS, SLOPES TO BUILDING ACCESS/EGRESS POINTS, HANDICAP RAMPS/PARKING SPACES, STRIPING AND PAVEMENT MARKINGS SHALL CONFORM TO ADA REQUIREMENTS AND THE NORTH CAROLINA STATE BUILDING CODE. THE CONTRACTOR IS RESPONSIBLE FOR VERIFYING ADA
- CONFORMANCE PRIOR TO ANY CONSTRUCTION. 16. ALL DIMENSIONS ARE TO FACE-OF-CURB UNLESS OTHERWISE NOTED. 17. THE CONTRACTOR SHALL REFER TO THE ARCHITECTURAL DRAWINGS FOR
- ANY/ALL BUILDING DIMENSIONS AND CONFIRM THAT ANY/ALL BUILDING ALIGNMENTS CONFORM TO THE APPROVED CIVIL PLANS PRIOR TO ANY CONSTRUCTION. REPORT ANY DISCREPANCIES TO THE ENGINEER
- 18. CONTRACTOR SHALL CONFIRM ALL COMPACTION REQUIREMENTS WITH THE GEOTECHNICAL ENGINEER.

POOL HOUSE/POOL DECK NOTES:

- 1. VERIFY POOL HOUSE, PUMP/STORAGE BUILDING, AND OUTDOOR PAVILION DIMENSIONS, SPECIFICATIONS AND ORIENTATION WITH ARCHITECTURAL PLANS.
- 2. COORDINATE POOL, CONCRETE POOL DECK AND FIREPLACE SPECIFICATIONS WITH ARCHITECTURAL PLANS.
- 3. CONSTRUCT ALL CONCRETE SIDEWALKS PER TOWN OF ROLESVILLE STANDARDS AND SPECIFICATIONS.

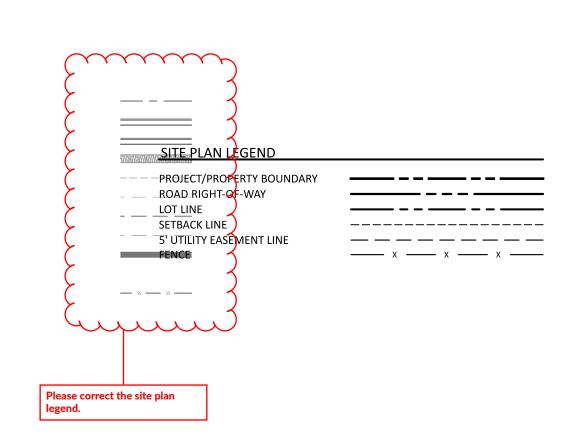

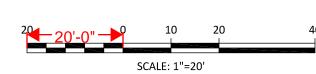

PRELIMINARY DRAWING - NOT RELEASED FOR CONSTRUCTION

JJB DRAWN BY: RSF SCALE: 1"=20'

SITE

PROJECT NO:

Nau Iting Civ

PRESTLEIGH AT JONES AMENITY CENTE

DESIGN BY:

2024-02-29

C2.0



CITY OF RALEIGH STANDARD UTILITY NOTES:

1. ALL MATERIALS & CONSTRUCTION METHODS SHALL BE IN ACCORDANCE WITH CITY OF RALEIGH DESIGN STANDARDS, DETAILS & SPECIFICATIONS (REFERENCE: CORPUD HANDBOOK, CURRENT EDITION) 2. UTILITY SEPARATION REQUIREMENTS:

A) A DISTANCE OF 100' SHALL BE MAINTAINED BETWEEN SANITARY SEWER & ANY PRIVATE OR PUBLIC WATER SUPPLY SOURCE SUCH AS AN IMPOUNDED RESERVOIR USED AS A SOURCE OF DRINKING WATER. IF ADEQUATE LATERAL SEPARATION CANNOT BE ACHIEVED, FERROUS SANITARY SEWER PIPE SHALL BE

SPECIFIED & INSTALLED TO WATERLINE SPECIFICATIONS. HOWEVER, THE MINIMUM SEPARATION SHALL NOT BE LESS THAN 25' FROM A PRIVATE WELL OR 50' FROM A PUBLIC WELL B) WHEN INSTALLING WATER &/OR SEWER MAINS, THE HORIZONTAL SEPARATION BETWEEN UTILITIES SHALL BE 10'. IF THIS SEPARATION CANNOT BE MAINTAINED DUE TO EXISTING CONDITIONS, THE VARIATION ALLOWED IS THE WATER MAIN IN A SEPARATE TRENCH WITH THE ELEVATION OF THE WATER MAIN AT LEAST 18" ABOVE THE TOP OF THE SEWER & MUST BE APPROVED BY THE PUBLIC UTILITIES DIRECTOR. ALL

C) WHERE IT IS IMPOSSIBLE TO OBTAIN PROPER SEPARATION, OR ANYTIME A SANITARY SEWER PASSES OVER A WATERMAIN, DIP MATERIALS OR STEEL ENCASEMENT EXTENDED 10' ON EACH SIDE OF CROSSING MUST BE SPECIFIED & INSTALLED TO WATERLINE SPECIFICATIONS

D) 5.0' MINIMUM HORIZONTAL SEPARATION IS REQUIRED BETWEEN ALL SANITARY SEWER & STORM SEWER

FACILITIES, UNLESS DIP MATERIAL IS SPECIFIED FOR SANITARY SEWER E) MAINTAIN 18" MIN. VERTICAL SEPARATION AT ALL WATERMAIN & RCP STORM DRAIN CROSSINGS; MAINTAIN 24" MIN. VERTICAL SEPARATION AT ALL SANITARY SEWER & RCP STORM DRAIN CROSSINGS. WHERE ADEQUATE SEPARATIONS CANNOT BE ACHIEVED, SPECIFY DIP MATERIALS & A CONCRETE CRADLE HAVING 6" MIN. CLEARANCE (PER CORPUD DETAILS W-41 & S-49)

DISTANCES ARE MEASURED FROM OUTSIDE DIAMETER TO OUTSIDE DIAMETER

F) ALL OTHER UNDERGROUND UTILITIES SHALL CROSS WATER & SEWER FACILITIES WITH 18" MIN. VERTICAL SEPARATION REQUIRED

3. ANY NECESSARY FIELD REVISIONS ARE SUBJECT TO REVIEW & APPROVAL OF AN AMENDED PLAN &/OR PROFILE BY THE CITY OF RALEIGH PUBLIC UTILITIES DEPARTMENT PRIOR TO CONSTRUCTION
4. CONTRACTOR SHALL MAINTAIN CONTINUOUS WATER & SEWER SERVICE TO EXISTING RESIDENCES &

BUSINESSES THROUGHOUT CONSTRUCTION OF PROJECT. ANY NECESSARY SERVICE INTERRUPTIONS SHALL BE PRECEDED BY A 24 HOUR ADVANCE NOTICE TO THE CITY OF RALEIGH PUBLIC UTILITIES DEPARTMENT 5. 3.0' MINIMUM COVER IS REQUIRED ON ALL WATER MAINS & SEWER FORCEMAINS. 4.0' MINIMUM COVER IS REQUIRED ON ALL REUSE MAINS

6. IT IS THE DEVELOPER'S RESPONSIBILITY TO ABANDON OR REMOVE EXISTING WATER & SEWER SERVICES NOT BEING USED IN REDEVELOPMENT OF A SITE UNLESS OTHERWISE DIRECTED BY THE CITY OF RALEIGH PUBLIC

UTILITIES DEPARTMENT. THIS INCLUDES ABANDONING TAP AT MAIN & REMOVAL OF SERVICE FROM ROW OR EASEMENT PER CORPUD HANDBOOK PROCEDURE

7. INSTALL ¾" COPPER* WATER SERVICES WITH METERS LOCATED AT ROW OR WITHIN A 2'X2' WATERLINE EASEMENT IMMEDIATELY ADJACENT. NOTE: IT IS THE APPLICANT'S RESPONSIBILITY TO PROPERLY SIZE THE WATER SERVICE FOR EACH CONNECTION TO PROVIDE ADEQUATE FLOW & PRESSURE

8. INSTALL 4" PVC* SEWER SERVICES @ 1.0% MINIMUM GRADE WITH CLEANOUTS LOCATED AT ROW OR EASEMENT LINE & SPACED EVERY 75 LINEAR FEET MAXIMUM

9. PRESSURE REDUCING VALVES ARE REQUIRED ON ALL WATER SERVICES EXCEEDING 80 PSI; BACKWATER VALVES ARE REQUIRED ON ALL SANITARY SEWER SERVICES HAVING BUILDING DRAINS LOWER THAN 1.0'
ABOVE THE NEXT UPSTREAM MANHOLE

10. ALL ENVIRONMENTAL PERMITS APPLICABLE TO THE PROJECT MUST BE OBTAINED FROM NCDWQ, USACE &/OR FEMA FOR ANY RIPARIAN BUFFER, WETLAND &/OR FLOODPLAIN IMPACTS (RESPECTIVELY) PRIOR TO CONSTRUCTION.
11. CROSS-CONNECTION CONTROL PROTECTION DEVICES ARE REQUIRED BASED ON DEGREE OF HEALTH HAZARD

INVOLVED AS LISTED IN APPENDIX-B OF THE RULES GOVERNING PUBLIC WATER SYSTEMS IN NORTH CAROLINA. THESE GUIDELINES ARE THE MINIMUM REQUIREMENTS. THE DEVICES SHALL MEET AMERICAN SOCIETY OF SANITARY ENGINEERING (ASSE) STANDARDS OR BE ON THE UNIVERSITY OF SOUTHERN CALIFORNIA APPROVAL LIST. THE DEVICES SHALL BE INSTALLED AND TESTED (BOTH INITIAL AND PERIODIC TESTING THEREAFTER) IN ACCORDANCE WITH THE MANUFACTURER'S RECOMMENDATIONS OR THE LOCAL CROSS-CONNECTION CONTROL PROGRAM, WHICHEVER IS MORE STRINGENT. CONTACT JOANIE HARTLEY AT (919) 996-5923 OR JOANIE.HARTLEY@RALEIGHNC.GOV FOR MORE INFORMATION

UTILITY PLAN LEGEND

SANITARY SEWER PIPE SANITARY SEWER MANHOLE SANITARY SEWER CLEANOUT WATER PIPE WATER METER WATER HYDRANT

> SWIMMING POOL DISCHARGE TO THE SANITARY SEWER SYSTEM SHALL BE EQUIPPED WITH A PUMP OR FLOW RESTRICTOR SO THAT THE DISCHARGE RATE DOES NOT EXCEED 50 GPM.

CITY OF RALEIGH - PLANS AUTHORIZED FOR CONSTRUCTION ELECTRONIC APPROVAL: THIS APPROVAL IS BEING ISSUED ELECTRONICALLY. THIS APPROVAL IS VALID ONLY UPON THE SIGNATURE OF A CITY OF RALEIGH REVIEW OFFICER BELOW. THE CITY WILL RETAIN A COPY OF THE APPROVED PLANS. ANY WORK AUTHORIZED BY THIS APPROVAL MUST PROCEED IN ACCORDANCE WITH THE PLANS KEPT ON FILE WITH THE CITY. THIS ELECTRONIC APPROVAL MAY NOT BE EDITED ONCE ISSUED.

ANY MODIFICATION TO THIS APPROVAL ONCE ISSUED WILL INVALIDATE THIS APPROVAL. CITY OF RALEIGH DEVELOPMENT APPROVAL

RALEIGH WATER REVIEW OFFICER

SCALE: 1"=20' PRELIMINARY DRAWING - NOT RELEASED FOR CONSTRUCTION

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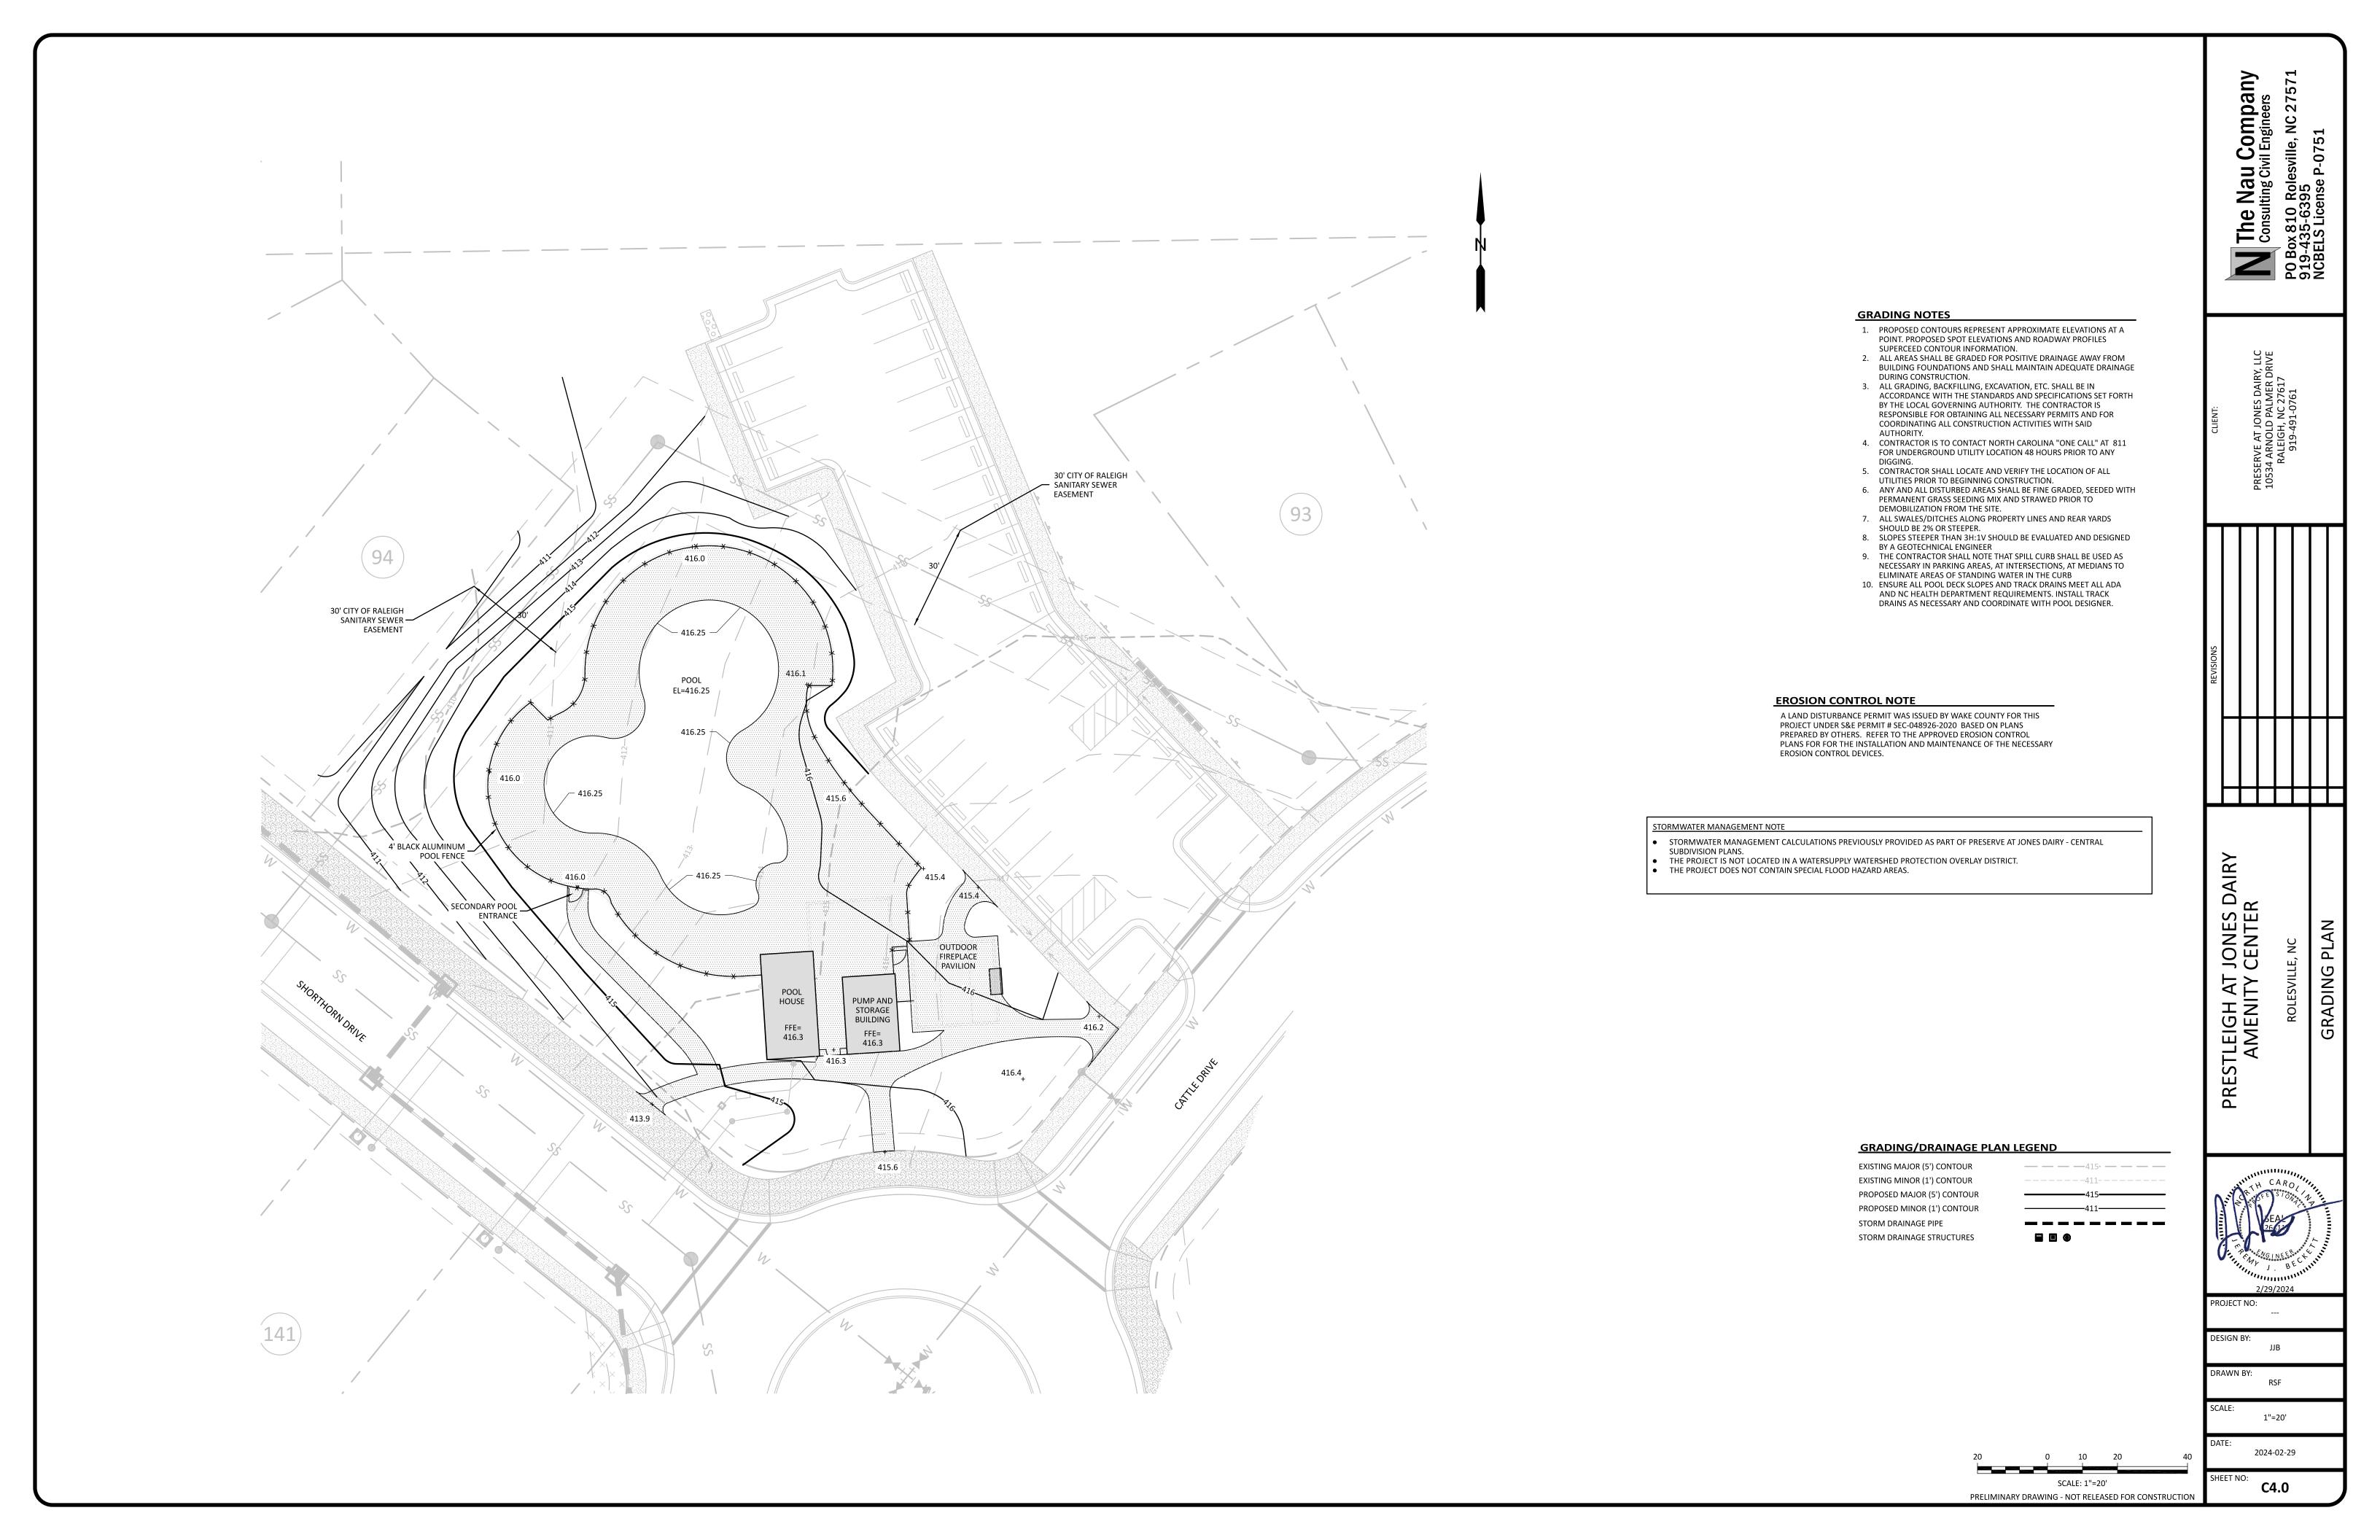
PRESTLEIGH AT JONES AMENITY CENTEI PLAN


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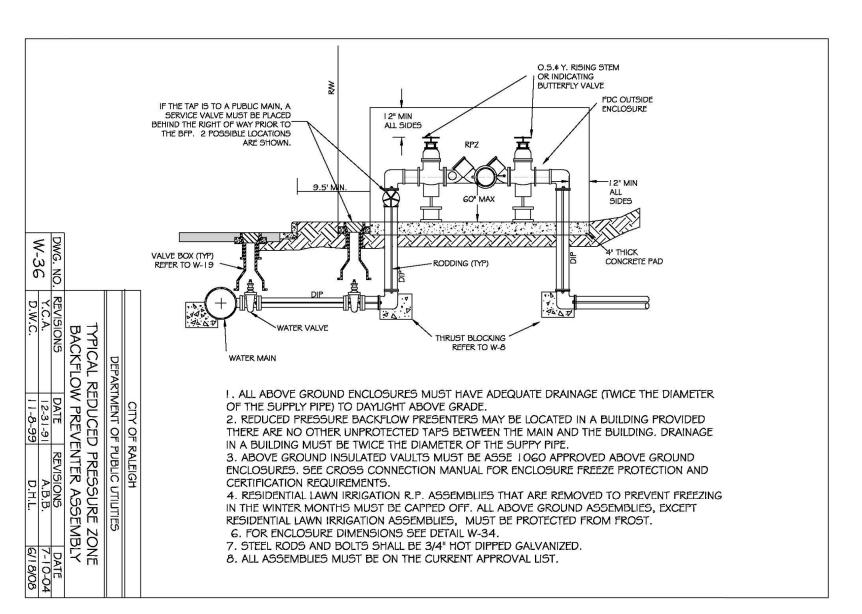
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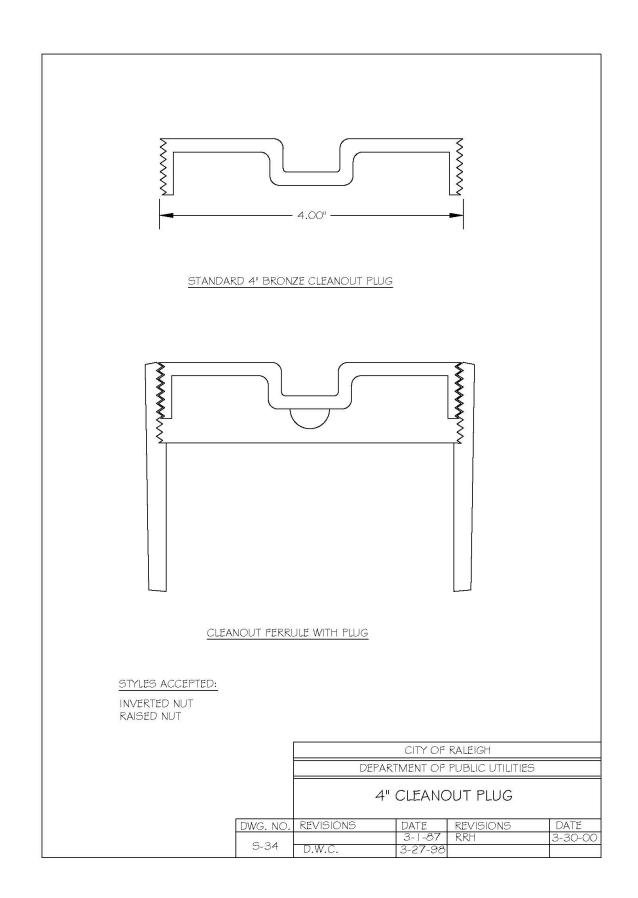
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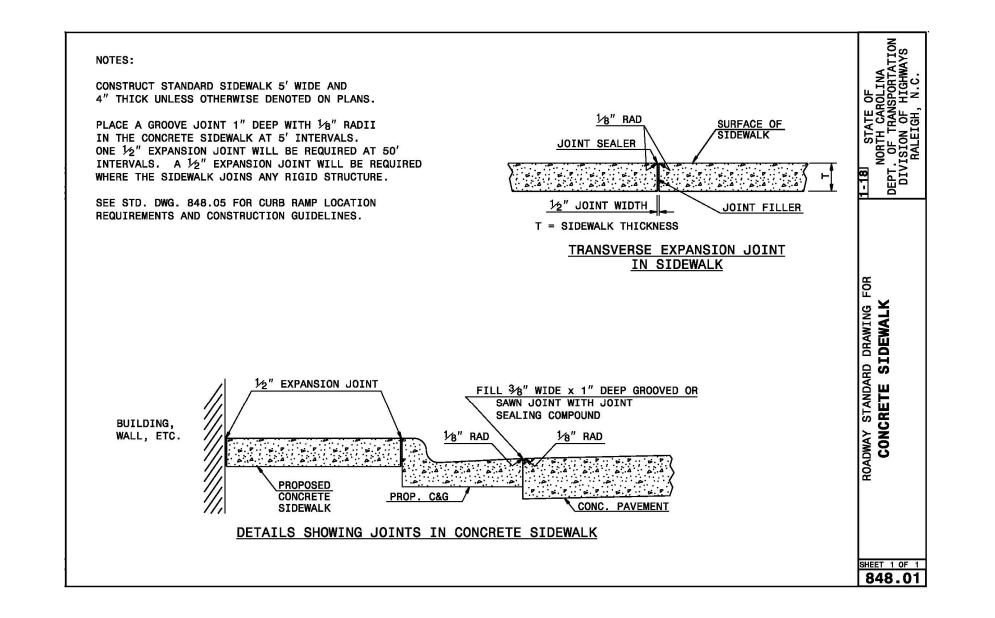
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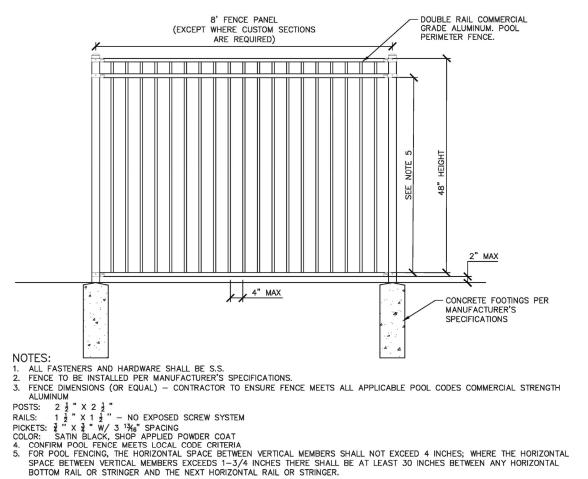











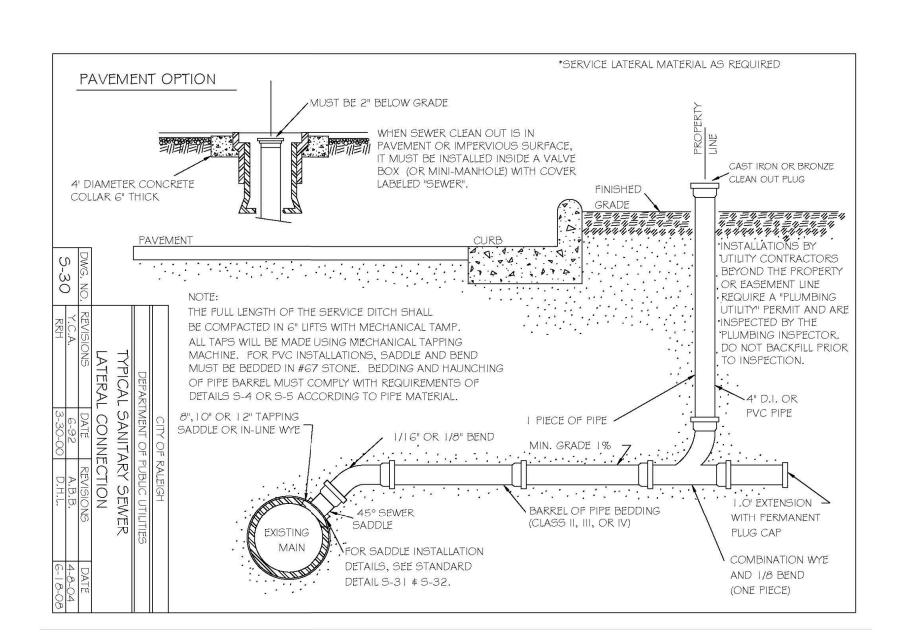

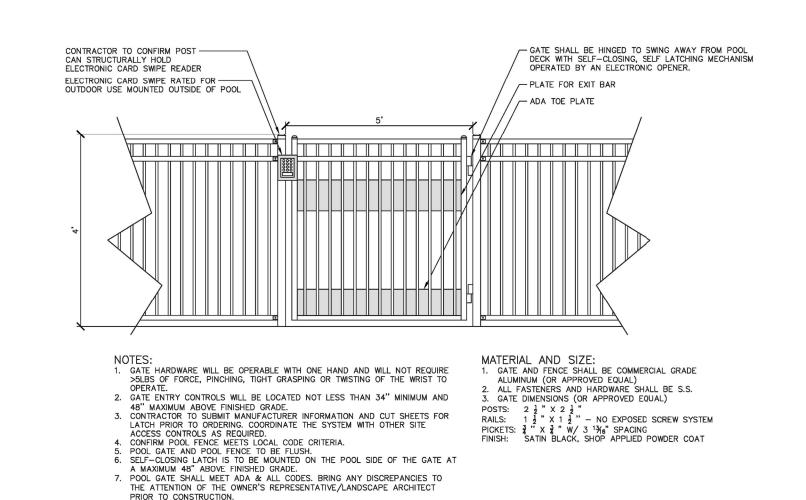

PRIOR TO CONSTRUCTION.
4. FENCE TO BE INSTALLED PER MANUFACTURER'S SPECIFICATIONS.

POOL FENCE AND GATE

PRELIMINARY DRAWING - NOT RELEASED FOR CONSTRUCTION

SCALE:

NTS

2024-02-29

1111 DAII JONES DETAILS PRESTLEIGH AT J AMENITY (SITE 2/29/2024 PROJECT NO: DESIGN BY: JJB DRAWN BY: RSF

Company vil Engineers

Nau Ilting Civ

The Consul