ARDEN SENIOR LIVING CENTER

BURLINGTON MILLS ROAD ROLESVILLE, NORTH CAROLINA

ZONING CONDITIONS

- DEVELOPMENT OF THE PROPERTY SHALL BE IN SUBSTANTIAL CONFORMANCE WITH
 THE ACCOMPANYING EXHIBIT E CONCEPT PLAN. LOCATIONS SHOWN FOR COMMITTED
 ELEMENTS INCLUDING, BUT NOT LIMITED TO, SETBACKS, GREENWAYS, STREETS, AND
 OPEN SPACE AREAS SHOWN ON THE CONCEPT PLAN ARE CONCEPTUAL AND PROVIDED
 FOR ILLUSTRATION AND CONTEXT ONLY. FINAL LOCATIONS OF ELEMENTS SHALL BE
 DETERMINED AT SUBSEQUENT STAGES OF APPROVAL.
 ONLY THE FOLLOWING USES SHALL BE PERMITTED ON THE PROPERTY:
- 2.1. RESIDENTIAL CARE AND ASSOCIATED ACCESSORY USE.3. DEVELOPMENT SHALL BE LIMITED TO A MAXIMUM OF 164 RESIDENTIAL UNITS.

SITE DEVELOPMENT PLAN

PROJECT NUMBER: SPEC23422 DATE: JANUARY 03, 2023

BURLINGTON MILLS ROAD SITE BURLINGTON MILLS ROAD COMMO SHAPE AVENUE COMMO SHAPE AVENUE AND SHAPE AVENUE AND SHAPE AVENUE COMMO SHAPE AVENUE

VICINITY MAP

SITE AND OPEN SPACE AREAS TOTAL SITE AREA RESIDENTIAL 10.42 AC RH-CZ(RESIDENTIAL CARE) 164 TOTAL UNITS 164 OVERALL DENSITY 15.72 DU/AC 15% OF TOTAL SITE AREA REQUIRED OPEN SPACE 1.56 AC REQUIRED 4.31 AC PROVIDED

PARCEL OWNER LIST				
PIN	OWNER	AREA		
1758-48-6155	BROTHERS FORTY SIX LLC	9.99 AC.		
1758-58-2090	WALLBROOK LANDO LLC	0.43 AC.		

PIN	1758486155; 1758582090
CASE NUMBER	MA22-10
REAL ESTATE ID	074571; 0224145
PROPOSED SITE AREA	10.42 AC
EXISTING ZONING	GC-CZ
PROPOSED ZONING	RESIDENTIAL CARE (RH-CZ)
EXISTING NUMBER OF LOTS	2 (TOTAL)
PROPOSED NUMBER OF LOTS	1 (TOTAL)
WATERSHED OVERLAY	UPPER NEUSE
WATER SUPPLY WATERSHED	NEUSE - MILBURNIE LAKE(MILBURNIE CREEK)
RIVER BASIN	NEUSE
COMMUNITY PLAN DESIGNATION	RESIDENTIAL CARE
EXISTING USE	VACANT
PROPOSED USE	164 RESIDENTIAL UNITS
	136 - APARTMENT UNITS
	14 - MULTIFAMILY DUPLEXES (28 UNITS)
MAXIMUM UNITS ALLOWED	164 RESIDENTIAL UNITS
DENSITY	MAXIMUM 15.72 DU/AC
	PROPOSED 15.72 DU/AC (164 UNITS / 10.43 AC)
BUILDING HEIGHT	MAXIMUM 60'
	PROPOSED 1 STORY & 4 STORY WITH BASEMENT
PARKING	
PARKING	PD D D C C D
	131 ON STREET STREES
	42 GARAGE SPACES
ACCECCIDI E DADVING	193 TOTAL SPACES
ACCESSIBLE PARKING	REQUIRED 193 SPACES x XXXX = 10 SPACES (2 VAN)
INADEDVIOLIC ARES	PROPOSED 16 SPACES (16 VAN) FXISTING TOTAL IMPERVIOUS = 0.00 AC
IMPERVIOUS AREA	EXISTING TOTAL IMPERVIOUS = 0.00 AC
	PROPOSED TOTAL IMPERVIOUS = 5.45 AC

SHEET IN	DEA
C0.00	PROJECT NOTES
1 OF 1	ALTA/NSPS SURVEY (PREPARED BY PENONI ASSOCIATES)
1 OF 1	ALTA/NSPS SURVEY (PREPARED BY PENONI ASSOCIATES)
C2.00	OVERALL SITE PLAN
C2.01	SITE PLAN AREA "A"
C2.02	SITE PLAN AREA "B"
C3.00	OVERALL GRADING AND STORM DRAINAGE PLAN
C3.01	GRADING AND STORM DRAINAGE PLAN AREA "A"
C3.02	GRADING AND STORM DRAINAGE PLAN AREA "B"
C4.00	OVERALL UTILITY PLAN
C4.01	UTILITY PLAN AREA "A"
C4.01	UTILITY PLAN AREA "B"
C8.00	SITE DETAILS
C8.01	STORM DRAINAGE DETAILS
C8.02	STORM DRAINAGE DETAILS
C8.03	WATER DETAILS
C8.04	WATER DETAILS
C8.05	SEWER DETAILS
C8.06	SEWER DETAILS
L1.0	OPEN SPACE PLAN DESIGNED BY OTHERS
L1.1	OVERALL PLANTING KEY PLAN
L1.2-1.4	ENLARGED PLANTING KEY PLAN AREAS
L1.5	PLANTING AND IRRIGATION NOTES & SPECIFICATIONS
L2.0	OVERALL AMENITY AREA HARDSCAPE PLAN
L2.1-L2.2	ENLARGED HARDSCAPE PLAN AREAS
L3.1-L3.3	LANDSCAPE DETAILS
L4.1	WET POND SCM PLANTING PLAN



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phone 919. 361. 5000 fax 919. 361. 2269 license number: C-0293, C-187

www.mcadamsco.com

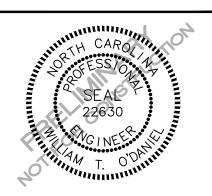
CONTACT

JUAN MONTES montes@mcadamsco.com PHONE: 919. 361. 5000

CLIENT

BUVERMO INVESTMENTS, INC 7315 WISCONSIN AVENUE SUITE 925W BETHESDA, MARYLAND, 20814

PROJECT DIRECTORY



REVISIONS

NO. DATE

PRELIMINARY PLAT PLAN FOR:

ARDEN SENIOR LIVING CENTER ROLESVILLE, NORTH CAROLINA PROJECT NUMBER: SPEC-23422

GENERAL NOTES:

- 1. ALL DIMENSIONS AND GRADES SHOWN ON THE PLANS SHALL BE FIELD VERIFIED BY THE CONTRACTOR PRIOR TO CONSTRUCTION. CONTRACTOR SHALL NOTIFY THE OWNER IF ANY DISCREPANCIES EXIST PRIOR TO PROCEEDING WITH CONSTRUCTION FOR NECESSARY PLAN OR GRADE CHANGES. NO EXTRA COMPENSATION SHALL BE PAID TO THE CONTRACTOR FOR ANY WORK DONE DUE TO DIMENSIONS OR GRADES SHOWN INCORRECTLY ON THESE PLANS IF SUCH NOTIFICATION HAS NOT BEEN GIVEN.
- 2. THERE MAY BE WETLANDS WITHIN THIS SITE. IT IS THE OWNER'S RESPONSIBILITY FOR WETLANDS JURISDICTION AND PERMIT DISTURBANCE PRIOR TO ANY GRADING ACTIVITY.

THE PROJECT WITH A COPY OF THE TRANSMITTAL LETTER TO THE OWNER.

SITE PLAN NOTES

- 1. ALL CONSTRUCTION SHALL CONFORM TO THE LATEST TOWN OF ROLESVILLE AND/OR NCDOT STANDARDS AND SPECIFICATIONS AS APPLICABLE.
- 2. ALL DIMENSIONS SHOWN ON SITE PLAN ARE MEASURED TO BACK OF CURB UNLESS OTHERWISE NOTED.
- 3. CONTRACTOR SHALL MAINTAIN AN "AS-BUILT" SET OF DRAWINGS TO RECORD THE EXACT LOCATION OF ALL PIPING PRIOR TO CONCEALMENT. DRAWINGS SHALL BE GIVEN TO THE ENGINEER UPON COMPLETION OF
- 4. EXISTING IMPROVEMENTS DAMAGED DURING CONSTRUCTION SHALL BE REPLACED/RESTORED TO THEIR ORIGINAL CONDITION AND TO THE SATISFACTION OF THE OWNER, BY THE CONTRACTOR RESPONSIBLE FOR
- 5. THE CONTRACTOR SHALL NOTE THAT THE DRAWINGS MAY NOT SHOW EVERY OFFSET, TRANSITION, FITTING, ETC. THAT MAY BE REQUIRED. THE CONTRACTOR SHALL INSTALL SUCH STANDARD APPURTENANCES AS REQUIRED TO CLOSELY FOLLOW THE GRADES AND ALIGNMENTS DEPICTED ON THE PLANS.
- 6. CONTRACTOR SHALL NOTIFY "NC811" (811) OR (1-800-632-4949) AT LEAST 3 FULL BUSINESS DAYS PRIOR TO BEGINNING CONSTRUCTION OR EXCAVATION TO HAVE EXISTING UTILITIES LOCATED. CONTRACTOR SHALL CONTACT ANY LOCAL UTILITIES THAT PROVIDE THEIR OWN LOCATOR SERVICES INDEPENDENT OF "NC811" REPORT ANY DISCREPANCIES TO THE ENGINEER IMMEDIATELY.
- 7. CONTRACTOR IS RESPONSIBLE FOR COORDINATING CONSTRUCTION ACTIVITIES WITH THE APPROPRIATE UTILITY COMPANIES FOR ANY REQUIRED RELOCATIONS (I.E. POWER POLES, TELEPHONE PEDESTALS, WATER
- 8. ALL DIMENSIONS AND GRADES SHOWN ON THE PLANS SHALL BE FIELD VERIFIED BY THE CONTRACTOR PRIOR TO CONSTRUCTION. CONTRACTOR SHALL NOTIFY THE ENGINEER IF ANY DISCREPANCIES EXIST PRIOR TO PROCEEDING WITH CONSTRUCTION, FOR NECESSARY PLAN OR GRADE CHANGES, NO EXTRA COMPENSATION SHALL BE PAID TO CONTRACTOR FOR ANY WORK DONE DUE TO DIMENSIONS OR GRADES SHOWN INCORRECTLY ON THESE PLANS IF SUCH NOTIFICATION HAS NOT BEEN GIVEN.
- 9. ACCESSIBLE RAMPS SHALL BE CONSTRUCTED IN ACCORDANCE WITH NCDOT DETAILS.
- 10. ALL SIDEWALKS THAT CONNECT TO THE PUBLIC RIGHT-OF-WAY MUST BE ACCESSIBLE TO PERSONS WHO ARE BLIND, HAVE LOW VISION AND PEOPLE WITH MOBILITY DISABILITIES. PEDESTRIAN EXISTING ROUTES AND ALTERNATE PEDESTRIAN ROUTES DURING CONSTRUCTION WILL BE REQUIRED TO BE COMPLIANT WITH THE PUBLIC RIGHTS OF WAY ACCESSIBILITY GUIDELINES (PROWAG), 2010 ADA STANDARDS FOR ACCESSIBLE DESIGN AND THE MANUAL ON UNIFORM TRAFFIC CONTROL DEVICES (MUTCD).
- 11. TYPICAL PAVEMENT SECTION DETAILS ARE SHOWN WITHIN THIS SET AND INTENDED TO BE A MINIMUM PAVEMENT SECTION REQUIREMENT. THE CURRENT GEOTECHNICAL REPORT SHALL OVER-RIDE ALL TYPICAL PAVEMENT SECTIONS SHOWN, IF THE GEOTECHNICAL ENGINEER DEEMS A HEAVIER SECTION IS REQUIRED.
- 12. EQUIPMENT AND PRODUCTS OTHER THAN THOSE SPECIFIED MAY BE USED PROVIDED APPROVAL HAS BEEN OBTAINED FROM THE OWNER IN WRITING PRIOR TO ORDERING OR INSTALLATION. THE CONTRACTOR SHALL WAIVE ANY CLAIM FOR ADDITIONAL COST RELATED TO SUBSTITUTION OF ALTERNATE EQUIPMENT.
- 13. ALL SIGNAGE ASSOCIATED WITH THE PUBLIC STREET SYSTEM SHALL ADHERE TO MUTCD STANDARDS AND SPECIFICATIONS.

NOTES:

- 1. ROADS LABELED AS PUBLIC WILL BE DEDICATED AS PUBLIC ROW TO BE MAINTANED BY THE TOWN OF ROLESVILLE.
- 2. ROADS LABELED AS PRIVATE WILL BE DEDICATED AS PRIVATE AND BE MAINTAINED BY THE HOA.
- 3. GREENWAY EASEMENTS LABELED AS PUBLIC WILL BE DEDICATED AS PUBLIC AND BE MAINTAINED BY THE TOWN OF ROLESVILLE.
- 4. SANITARY SEWER EASEMENTS WILL BE DEDICATED AS PUBLIC

STORM DRAINAGE NOTES

EASEMENTS TO THE CITY OF RALEIGH.

- 1. ALL STORM DRAINAGE PIPES SHOWN SHALL BE REINFORCED CONCRETE (RCP) (MINIMUM CLASS III) UNLESS NOTED OTHERWISE. CONTRACTOR TO COORDINATE WITH THE GEOTECH TO VERIFY TYPE OF BEDDING REQUIRED BASED ON SOIL CONDITIONS. CONTRACTOR TO SELECT REQUIRED CLASS OF PIPE BASED ON DEPTH OF PIPE AND BEDDING PROVIDED PER THE AMERICAN CONCRETE PIPE ASSOCIATION GUIDELINES.
- 2. ALL STORM DRAINAGE CONSTRUCTION SHALL BE IN ACCORDANCE WITH THE TOWN OF ROLESVILLE STANDARDS.
- 3. ALL CONCRETE SHALL MEET A MINIMUM 3000 PSI COMPRESSIVE STRENGTH.
- 4 ALL PIPE IN STORM DRAIN STRUCTURES SHALL BE STRUCK EVEN WITH INSIDE WALL.
- 5. ALL PIPE JOINTS SHALL BE MADE WITH PREFORMED JOINT SEALER, WHICH CONFORMS TO AASHTO SPECIFICATION M-198 FOR TYPE B FLEXIBLE PLASTIC GASKETS UNLESS OTHERWISE NOTED.
- 6. THE INTERIOR SURFACES OF ALL STORM DRAINAGE STRUCTURES SHALL BE POINTED UP AND SMOOTHED TO AN ACCEPTABLE STANDARD, USING MORTAR MIXED TO MANUFACTURER'S SPECIFICATIONS.
- 7. ALL BACKFILL SHALL BE NON-PLASTIC IN NATURE. FREE FROM ROOTS, VEGETATION MATTER, WASTE CONSTRUCTION MATERIAL OR OTHER OBJECTIONABLE MATERIAL. SAID MATERIAL SHALL BE CAPABLE OF BEING COMPACTED BY MECHANICAL MEANS AND SHALL HAVE NO TENDENCY TO FLOW OR BEHAVE IN A PLASTIC MANNER UNDER THE TAMPING BLOWS OR PROOF ROLLING.
- 8. MATERIALS DEEMED BY THE OWNER'S REPRESENTATIVE OR GEOTECH AS UNSUITABLE FOR BACKFILL PURPOSES SHALL BE REMOVED AND REPLACED WITH SUITABLE MATERIAL.
- 9. BACKFILLING OF TRENCHES SHALL BE ACCOMPLISHED IMMEDIATELY AFTER PIPE IS LAID. THE FILL AROUND THE PIPE SHALL BE THOROUGHLY COMPACTED TO 95 % OF THE MAXIMUM DRY DENSITY OBTAINABLE WITH THE STANDARD PROCTOR TEST. THE TOP EIGHT (8) INCHES SHALL BE COMPACTED TO 100 PERCENT STANDARD PROCTOR.
- 10. UNDER NO CIRCUMSTANCES SHALL WATER BE ALLOWED TO RISE IN UNBACKFILLED TRENCHES AFTER PIPE HAS BEEN PLACED.
- 11. ALL CONCRETE PIPE AND PRECAST STORM STRUCTURES SHALL MEET NCDOT STANDARDS BY MANUFACTURER.
- 12. CONTRACTOR SHALL BE RESPONSIBLE FOR CHECKING ALL PIPE AND STRUCTURES FOR CRACKS OR BREAKS, PRIOR TO INSTALLATION.

GRADING NOTES

- 1. ALL DIMENSIONS AND GRADES SHOWN ON THE PLANS SHALL BE FIELD VERIFIED BY THE CONTRACTOR PRIOR TO CONSTRUCTION. CONTRACTOR SHALL NOTIFY THE ENGINEER IF ANY DISCREPANCIES EXIST PRIOR TO PROCEEDING WITH CONSTRUCTION, FOR NECESSARY PLAN OR GRADE CHANGES. NO EXTRA COMPENSATION SHALL BE PAID TO THE CONTRACTOR FOR ANY WORK DONE DUE TO DIMENSIONS OR GRADES SHOWN INCORRECTLY ON THESE PLANS IF SUCH NOTIFICATION HAS NOT BEEN GIVEN.
- 2. OCCUPATIONAL SAFETY AND HEALTH ADMINISTRATION (OSHA) STANDARDS FOR EXCAVATIONS; FINAL RULE 29CFR PART 1926. SUBPART "P" APPLIES TO ALL EXCAVATIONS EXCEEDING FIVE (5) FEET IN DEPTH. EXCAVATION EXCEEDING TWENTY (20) FEET IN DEPTH REQUIRES THE DESIGN OF A TRENCH SAFETY SYSTEM BY A REGISTERED PROFESSIONAL ENGINEER, PROVIDED BY CONTRACTOR RESPONSIBLE FOR
- 3. ALL CONSTRUCTION SHALL BE IN ACCORDANCE WITH THE TOWN OF ROLESVILLE AND/OR NCDOT STANDARDS AND SPECIFICATIONS AS APPLICABLE.
- 4. CONTRACTOR SHALL NOTIFY "NC811" (811) OR (1-800-632-4949) AT LEAST 3 FULL BUSINESS DAYS PRIOR TO BEGINNING CONSTRUCTION OR EXCAVATION TO HAVE EXISTING UTILITIES LOCATED. CONTRACTOR SHALL CONTACT ANY LOCAL UTILITIES THAT PROVIDE THEIR OWN LOCATOR SERVICES INDEPENDENT OF "NC811". REPORT ANY DISCREPANCIES TO THE ENGINEER IMMEDIATELY.
- 5. CONSTRUCTION, MAINTENANCE AND REMOVAL OF ALL EROSION CONTROL DEVICES ARE THE RESPONSIBILITY OF THE GENERAL CONTRACTOR. TIMING OF REMOVAL SHALL BE COORDINATED WITH THE EROSION CONTROL INSPECTOR.
- 6. EXISTING UTILITIES AND STRUCTURES SHOWN, BOTH UNDERGROUND AND ABOVE GROUND, ARE BASED ON A FIELD SURVEY AND THE BEST AVAILABLE RECORD DRAWINGS. THE CONTRACTOR SHALL VERIFY FIELD CONDITIONS PRIOR TO BEGINNING RELATED CONSTRUCTION. ANY DISCREPANCIES SHALL BE REPORTED TO THE ENGINEER IMMEDIATELY.
- 7. SOIL UNDER BUILDINGS, PAVED AREAS AND WITHIN SLOPES GREATER THAN 3:1 (H:V) SHALL BE APPROVED, PLACED AND COMPACTED AS RECOMMENDED BY THE GEOTECHNICAL ENGINEER.

RETAINING WALL NOTES

- THE RETAINING WALL ALIGNMENT SHOWN ON THESE PLANS DEPICTS THE LOCATION OF THE FRONT FACE OF THE RETAINING WALL AT THE TOP OF THE WALL. THE CONTRACTOR IS RESPONSIBLE FOR ENSURING RETAINING WALLS ARE NOT LOCATED IN ANY STREAM BUFFERS, AND THEIR CONSTRUCTION DOES NOT ENCROACH INTO ANY ADIACENT PROPERTIES DUE TO ANY BATTER INCORPORATED IN THE DESIGN OF THE WALLS.
- RETAINING WALLS ARE TO BE DESIGN-BUILD PROJECTS BY THE CONTRACTOR. IT SHALL BE THE CONTRACTOR'S RESPONSIBILITY TO OBTAIN FINAL CONSTRUCTION DRAWINGS FROM A REGISTERED ENGINEER AND GAIN ALL REQUIRED PERMITS NECESSARY FOR THE CONSTRUCTION OF THE RETAINING WALLS.
- RETAINING WALLS SHALL BE ASSUMED TO BE BACKFILLED WITH OFF-SITE BORROW MATERIAL OR PROCESSED FILL, UNLESS THE CONTRACTOR CAN PROVIDE TO THE OWNER WITH CONFIRMATION FROM THE GEOTECHNICAL ENGINEER AND THE RETAINING WALL DESIGNER, THAT READILY AVAILABLE ON-SITE SOILS CAN BE USED.
- THE TOP AND BOTTOM OF WALL ELEVATIONS SHOWN ON THESE PLANS IDENTIFY FINISHED GRADE FLEVATIONS ONLY. THE EXTENT THAT THE RETAINING WALL WILL BE EXTENDED BELOW GRADE TO THE FOOTING OR ABOVE GRADE TO THE TOP OF THE CAP BLOCK COURSE SHALL BE IDENTIFIED ON THE RETAINING WALL CONSTRUCTION
- 5. ALL RETAINING WALLS OVER 30" HIGH SHALL HAVE A SAFETY FENCE (DESIGN BY OTHERS).
- ANY TIEBACK SYSTEMS FOR THE RETAINING WALLS SHALL NOT BE ALLOWED WITHIN PUBLIC RIGHT-OF-WAY.

CITY OF RALEIGH PUBLIC UTILITIES

STANDARD UTILITY NOTES (AS APPLICABLE)

- ALL MATERIALS & CONSTRUCTION METHODS SHALL BE IN ACCORDANCE WITH CITY OF RALEIGH DESIGN STANDARDS, DETAILS & SPECIFICATIONS (REFERENCE: CORPUD HANDBOOK, CURRENT EDITION)
- 2. UTILITY SEPARATION REQUIREMENTS:
- a. A DISTANCE OF 100' SHALL BE MAINTAINED BETWEEN SANITARY SEWER & ANY PRIVATE OR PUBLIC WATER SUPPLY SOURCE SUCH AS AN IMPOUNDED RESERVOIR USED AS A SOURCE OF DRINKING WATER. IF ADEQUATE LATERAL SEPARATION CANNOT BE ACHIEVED, FERROUS SANITARY SEWER PIPE SHALL BE SPECIFIED & INSTALLED TO WATERLINE SPECIFICATIONS. HOWEVER, THE MINIMUM SEPARATION SHALL NOT BE LESS THAN 25' FROM A PRIVATE WELL OR 50' FROM A PUBLIC WELL.
- b. WHEN INSTALLING WATER &/OR SEWER MAINS, THE HORIZONTAL SEPARATION BETWEEN UTILITIES SHALL BE 10'. IF THIS SEPARATION CANNOT BE MAINTAINED DUE TO EXISTING CONDITIONS, THE VARIATION ALLOWED IS THE WATER MAIN IN A SEPARATE TRENCH WITH THE ELEVATION OF THE WATER MAIN AT LEAST 18" ABOVE THE TOP OF THE SEWER & MUST BE APPROVED BY THE PUBLIC UTILITIES DIRECTOR. ALL DISTANCES ARE MEASURED FROM OUTSIDE DIAMETER TO
- c. WHERE IT IS IMPOSSIBLE TO OBTAIN PROPER SEPARATION, OR ANYTIME A SANITARY SEWER PASSES OVER A WATERMAIN, DIP MATERIALS OR STEEL ENCASEMENT EXTENDED 10' ON EACH SIDE OF CROSSING MUST BE SPECIFIED & INSTALLED TO WATERLINE SPECIFICATIONS.
- d. 5.0' MINIMUM HORIZONTAL SEPARATION IS REQUIRED BETWEEN ALL SANITARY SEWER & STORM SEWER FACILITIES, UNLESS DIP MATERIAL IS SPECIFIED FOR SANITARY SEWER.
- e. MAINTAIN 18" MIN. VERTICAL SEPARATION AT ALL WATERMAIN & RCP STORM DRAIN CROSSINGS; MAINTAIN 18" MIN. VERTICAL SEPARATION AT ALL SANITARY SEWER & RCP STORM DRAIN CROSSINGS. WHERE ADEQUATE SEPARATIONS CANNOT BE ACHIEVED, SPECIFY DIP MATERIALS & A CONCRETE CRADLE HAVING 6" MIN. CLEARANCE (PER CORPUD DETAILS W-41 &
- f. ALL OTHER UNDERGROUND UTILITIES SHALL CROSS WATER & SEWER FACILITIES WITH 18" MIN. VERTICAL SEPARATION
- 3. ANY NECESSARY FIELD REVISIONS ARE SUBJECT TO REVIEW & APPROVAL OF AN AMENDED PLAN &/OR PROFILE BY THE CITY OF RALEIGH PUBLIC UTILITIES DEPARTMENT PRIOR TO CONSTRUCTION.
- 4. CONTRACTOR SHALL MAINTAIN CONTINUOUS WATER & SEWER SERVICE TO EXISTING RESIDENCES & BUSINESSES THROUGHOUT CONSTRUCTION OF PROJECT. ANY NECESSARY SERVICE INTERRUPTIONS SHALL BE PRECEDED BY A 24 HOUR ADVANCE NOTICE TO THE CITY OF RALEIGH PUBLIC UTILITIES DEPARTMENT.
- 5. 3.0' MINIMUM COVER IS REQUIRED ON ALL WATER MAINS & SEWER FORCEMAINS. 4.0' MINIMUM COVER IS REQUIRED ON ALL REUSE MAINS.
- IT IS THE DEVELOPER'S RESPONSIBILITY TO ABANDON OR REMOVE EXISTING WATER & SEWER SERVICES NOT BEING USED IN REDEVELOPMENT OF A SITE UNLESS OTHERWISE DIRECTED BY THE CITY OF RALEIGH PUBLIC UTILITIES DEPARTMENT. THIS INCLUDES ABANDONING TAP AT MAIN & REMOVAL OF SERVICE FROM ROW OR EASEMENT PER CORPUD HANDBOOK PROCEDURE.
- 7. INSTALL 3/4" COPPER WATER SERVICES WITH METERS LOCATED AT ROW OR WITHIN A 2'X2' WATERLINE EASEMENT IMMEDIATELY ADJACENT. NOTE: IT IS THE APPLICANT'S RESPONSIBILITY TO PROPERLY SIZE THE WATER SERVICE FOR EACH
- 8. INSTALL 4" PVC SEWER SERVICES @ 1.0% MINIMUM GRADE WITH CLEANOUTS LOCATED AT ROW OR EASEMENT LINE & SPACED EVERY 75 LINEAR FEET MAXIMUM.
- 9. PRESSURE REDUCING VALVES ARE REQUIRED ON ALL WATER SERVICES EXCEEDING 80 PSI; BACKWATER VALVES ARE REQUIRED ON ALL SANITARY SEWER SERVICES HAVING BUILDING DRAINS LOWER THAN 1.0' ABOVE THE NEXT UPSTREAM MANHOLE.
- 10. ALL ENVIRONMENTAL PERMITS APPLICABLE TO THE PROJECT MUST BE OBTAINED FROM NCDWQ, USACE &/OR FEMA FOR ANY RIPARIAN BUFFER, WETLAND &/OR FLOODPLAIN IMPACTS (RESPECTIVELY) PRIOR TO CONSTRUCTION.
- 11. NCDOT / RAILROAD ENCROACHMENT AGREEMENTS ARE REQUIRED FOR ANY UTILITY WORK (INCLUDING MAIN EXTENSIONS & SERVICE TAPS) WITHIN STATE OR RAILROAD ROW PRIOR TO CONSTRUCTION.
- 12. GREASE INTERCEPTOR / OIL WATER SEPARATOR SIZING CALCULATIONS & INSTALLATION SPECIFICATIONS SHALL BE APPROVED BY THE CORPUD FOG PROGRAM COORDINATOR PRIOR TO ISSUANCE OF A BUILDING PERMIT. CONTACT TIM BEASLEY AT (919) 996-2334 OR TIMOTHY.BEASLEY@RALEIGHNC.GOV FOR MORE INFORMATION.
- 13. CROSS-CONNECTION CONTROL PROTECTION DEVICES ARE REQUIRED BASED ON DEGREE OF HEALTH HAZARD INVOLVED AS LISTED IN APPENDIX-B OF THE RULES GOVERNING PUBLIC WATER SYSTEMS IN NORTH CAROLINA. THESE GUIDELINES ARE THE MINIMUM REQUIREMENTS. THE DEVICES SHALL MEET AMERICAN SOCIETY OF SANITARY ENGINEERING (ASSE) STANDARDS OR BE ON THE UNIVERSITY OF SOUTHERN CALIFORNIA APPROVAL LIST. THE DEVICES SHALL BE INSTALLED AND TESTED (BOTH INITIAL AND PERIODIC TESTING THEREAFTER) IN ACCORDANCE WITH THE MANUFACTURER'S RECOMMENDATIONS OR THE LOCAL CROSS-CONNECTION CONTROL PROGRAM, WHICHEVER IS MORE STRINGENT. CONTACT JOANIE HARTLEY AT (919) 996-5923 OR JOANIE.HARTLEY@RALEIGHNC.GOV FOR MORE INFORMATION.



621 Hillsborough Street Suite 500 Raleigh, NC 27603

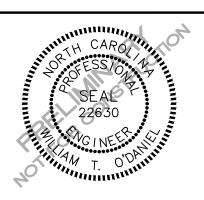
The John R. McAdams Company,

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www.mcadamsco.com

CLIENT

BUVERMO INVESTMENTS, INC 7315 WISCONSIN AVENUE SUITE 925W BETHESDA, MARYLAND, 20814



REVISIONS

NO. DATE

PLAN INFORMATION

PROJECT NO. SPEC-23422 FILENAME SPEC23422-Site-N1 CHECKED BY DRAWN BY

SCALE 01. 03. 2024

SHEET

PROJECT NOTES

CHICAGO TITLE INSURANCE COMPANY COMMITMENT NUMBER: 22-13599CH ADDITIONAL REFERENCE: 1028-5031 COMMITMENT DATE: AUGUST 8, 2022 AT 05:00 PM SCHEDULE B - SECTION II

- 1. ANY DEFECT, LIEN, ENCUMBRANCE, ADVERSE CLAIM, OR OTHER MATTER THAT APPEARS FOR THE FIRST TIME IN THE PUBLIC RECORDS OR IS CREATED, ATTACHES, OR IS DISCLOSED BETWEEN THE COMMITMENT DATE AND THE DATE ON WHICH ALL OF THE SCHEDULE B, PART I - REQUIREMENTS ARE MET. (NOT A SURVEY RELATED MATTER)
- 2. TAXES OR ASSESSMENTS FOR THE YEAR 2023, AND SUBSEQUENT YEARS, NOT YET DUE OR PAYABLE. (NOT A SURVEY RELATED MATTER)
- 3. ANY DISCREPANCY, CONFLICT, MATTERS REGARDING ACCESS, SHORTAGE IN AREA OR BOUNDARY LINES, ENCROACHMENT, ENCUMBRANCE, VIOLATION, VARIATION, OVERLAP, SETBACK, EASEMENT OR CLAIMS OF EASEMENT, RIPARIAN RIGHT, AND TITLE TO LAND WITHIN ROADS, WAYS, RAILROADS, WATERCOURSES, BURIAL GROUNDS, MARSHES, DREDGED OR FILLED AREAS OR LAND BELOW THE MEAN HIGH WATER MARK OR WITHIN THE BOUNDS OF ANY ADJOINING BODY OF WATER, OR OTHER ADVERSE CIRCUMSTANCE AFFECTING THE TITLE THAT WOULD BE DISCLOSED BY A CURRENT INSPECTION AND ACCURATE AND COMPLETE LAND SURVEY OF THE LAND. (AS SHOWN ON SURVEY)
- 4. ANY RIGHT, EASEMENT, SETBACK, INTEREST, CLAIM, ENCROACHMENT, ENCUMBRANCE, VIOLATION, VARIATIONS OR OTHER ADVERSE CIRCUMSTANCE AFFECTING THE TITLE DISCLOSED BY PLAT(S) RECORDED IN BOOK OF MAPS 1961, PAGE 97; AND BOOK OF MAPS 2008, PAGE 1281. (PUBLIC RIGHT-OF-WAY FOR BURLINGTON MILLS ROAD HAS BEEN UPDATED BY DEPARTMENT OF TRANSPORTATION TAKE RECORDED IN DEED BOOK 18598 PAGE 229. SEE EXCEPTION 7)
- 5. ELECTRIC LINE RIGHT-OF-WAY EASEMENT WAKE ELECTRIC MEMBERSHIP CORPORATION RECORDED IN BOOK 3869, PAGE 23. (DOES NOT APPEAR TO AFFECT SUBJECT PROPERTY)
- 6. DEED OF EASEMENT FOR SIGHT DISTANCE TO THE NORTH CAROLINA DEPARTMENT OF TRANSPORTATION RECORDED IN BOOK 14283, PAGE 2030. (AS SHOWN ON SURVEY)
- 7. DEED FOR HIGHWAY RIGHT OF WAY TO THE DEPARTMENT OF TRANSPORTATION RECORDED IN BOOK 18598, PAGE 229. (AS SHOWN ON SURVEY)

FLOOD ZONE DESIGNATION

SAID SURVEYED PROPERTY IS LOCATED WITHIN AN AREA HAVING A ZONE DESIGNATION "X" AREA ON MINIMAL FLOOD HAZARD ON FLOOD INSURANCE RATE MAP NO. 3720175800K, DATED 7/19/2022, IN WAKE COUNTY, NORTH CAROLINA, WHICH IS THE CURRENT FLOOD INSURANCE RATE MAP FOR THE COMMUNITY IN WHICH SAID SURVEYED PROPERTY IS SITUATED.

LEGAL DESCRIPTION

PROPERTY OF BROTHERS FORTY SIX, LLC

PIN: 1758486155

LYING AND BEING SITUATE IN WAKE COUNTY, NC, AND BEING MORE PARTICULARLY DESCRIBED AS FOLLOWS:

BEING ALL OF TRACT 2 AS SHOWN ON A MAP ENTITLED "SUBDIVISION FOR WAKE COUNTY BOARD OF EDUCATION" ACCORDING TO THE PLAT THEREOF RECORDED IN BOOK OF MAPS 2008, PAGE 1281 IN THE OFFICE OF THE REGISTER OF DEEDS OF WAKE COUNTY, NORTH CAROLINA.

NOTES:

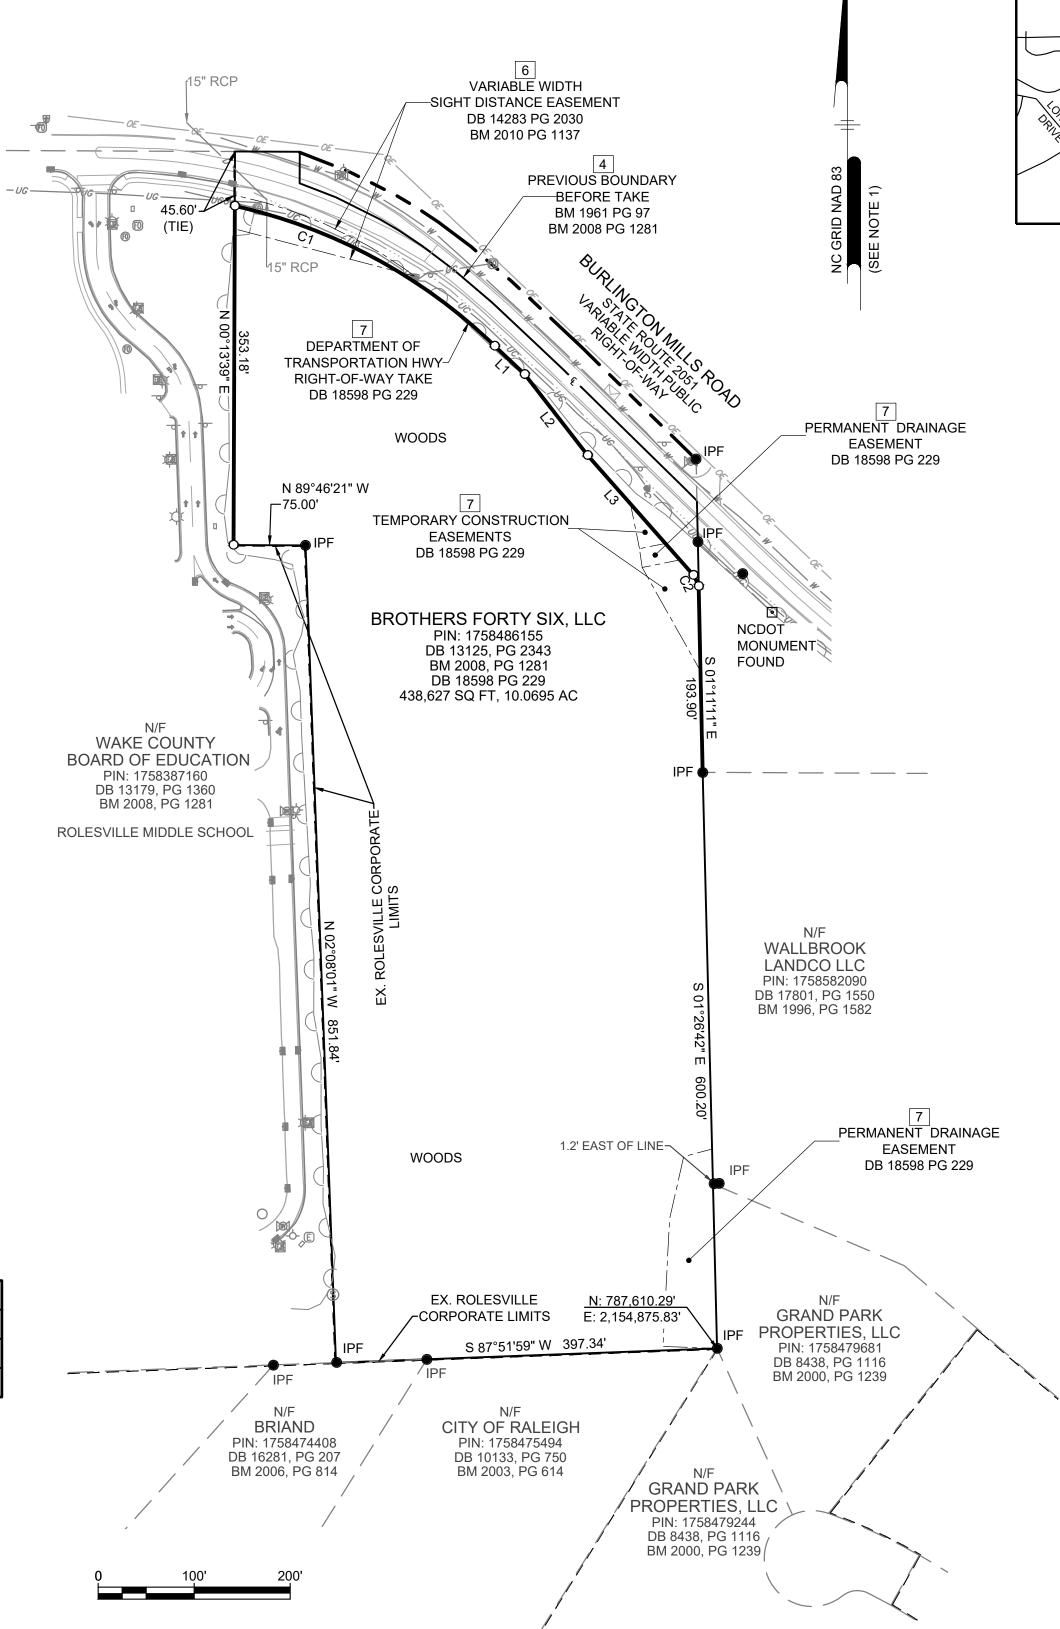
- COORDINATES PROVIDED, REFERENCE NORTH CAROLINA STATE PLANE NAD83 (NSRS 2011) DATUM, REFERENCED FROM NC VRS NETWORK.
- 2. BOUNDARY INFORMATION NOTED HEREON AND VERIFIED BY A FIELD SURVEY IS WITHIN ALTA/NSPS DEFINED TOLERANCE FOR RELATIVE POSITIONAL PRECISION.
- 3. THERE WAS NO OBSERVED EVIDENCE OF CURRENT BUILDING ADDITIONS, EARTH MOVING WORK, CONSTRUCTION, SOLID WASTE DUMP, SANITARY LANDFILL OR SUMP ON SITE.
- 4. THE SURVEY AND INFORMATION, COURSES AND DISTANCES SHOWN
- THEREON ARE ACCURATE. 5. EXCEPT AS SHOWN, THERE ARE NO APPARENT ENCROACHMENTS ONTO ADJOINING PREMISES, STREETS, ALLEYS OR EASEMENT AREAS BY ANY BUILDINGS, STRUCTURES OR OTHER IMPROVEMENTS, AND NO ENCROACHMENTS ONTO THE PREMISES BY BUILDINGS, STRUCTURES OR
- OTHER IMPROVEMENTS SITUATED ON ADJOINING PREMISES. 6. EXCEPT AS SHOWN, THERE ARE NO VISIBLE OR APPARENT EASEMENTS OR
- RIGHTS OF WAY ACROSS THE PREMISES. 7. THE PREMISES HAS DIRECT ACCESS TO BURLINGTON MILLS ROAD, A
- DEDICATED PUBLIC ROAD.
- 8. THE PARCEL IS CONTIGUOUS WITHOUT ANY GAPS OR GORES. 9. THERE IS NO VISIBLE EVIDENCE OF CEMETERIES OR BURIAL GROUNDS
- 10. NO BUILDINGS WERE OBSERVED ON THE SUBJECT PARCEL DURING THE
- COURSE OF THIS SURVEY. 11. NO EVIDENCE OF RECENT STREET OR SIDEWALK CONSTRUCTION OR REPAIRS WERE OBSERVED IN THE PROCESS OF CONDUCTING THE
- 12. TABLE A ITEM 6(a): NO ZONING REPORT OR LETTER PROVIDED TO THE
- SURVEYOR. PROPERTY IS ZONED RO BY WAKE COUNTY GIS. 13. TABLE A ITEM 11(b): UNDERGROUND UTILITIES LOCATED BY NORTH
- CAROLINA 811 TICKET NUMBER A222524072 DATED 9/09/2022. 14. WETLANDS OR HAZARDOUS MATERIALS WERE NEITHER OBSERVED OR INVESTIGATED DURING THE PERFORMANCE OF THIS SURVEY.

FGF	Γ	
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STORM INLET BOTTOM OF DITCH SITE, MAIL BOX SITE, SIGN SANITARY SEWER, CLEAN—OUT SANITARY SEWER, MANHOLE VEGETATION, TREE LINE WATER, FIRE HYDRANT WATER, STUB OUT WATER, UNDERGROUND WATER, VALVE COMMUNICATION, UNDERGROUND FIBER OPTIC, MANHOLE FIBER OPTIC, PEDESTAL FIBER OPTIC, STUB OUT NATURAL GAS, VALVE NATURAL GAS, UNDERGROUND POWER, JUNCTION BOX POWER, LIGHT POWER, OVERHEAD POWER, PEDESTAL PROPERTY, LINE LEGAL RIGHT—OF—WAY PROPERTY, CORNER FOUND		
SITE, MAIL BOX SITE, SIGN SANITARY SEWER, CLEAN-OUT SANITARY SEWER, MANHOLE VEGETATION, TREE LINE WATER, FIRE HYDRANT WATER, STUB OUT WATER, UNDERGROUND WATER, VALVE COMMUNICATION, UNDERGROUND FIBER OPTIC, MANHOLE FIBER OPTIC, PEDESTAL FIBER OPTIC, STUB OUT NATURAL GAS, VALVE NATURAL GAS, UNDERGROUND POWER, JUNCTION BOX POWER, LIGHT POWER, OVERHEAD POWER, PEDESTAL PROPERTY, LINE LEGAL RIGHT-OF-WAY PROPERTY, CORNER FOUND	=	STORM INLET
SITE, SIGN SANITARY SEWER, CLEAN-OUT SANITARY SEWER, MANHOLE VEGETATION, TREE LINE WATER, FIRE HYDRANT WATER, STUB OUT WATER, UNDERGROUND WATER, VALVE COMMUNICATION, UNDERGROUND FIBER OPTIC, MANHOLE FIBER OPTIC, STUB OUT NATURAL GAS, VALVE NATURAL GAS, UNDERGROUND NATURAL GAS, UNDERGROUND POWER, JUNCTION BOX POWER, LIGHT POWER, OVERHEAD POWER, OVERHEAD POWER, PEDESTAL PROPERTY, LINE LEGAL RIGHT-OF-WAY PROPERTY, CORNER FOUND		BOTTOM OF DITCH
SANITARY SEWER, CLEAN-OUT S SANITARY SEWER, MANHOLE VEGETATION, TREE LINE WATER, FIRE HYDRANT WATER, STUB OUT WATER, UNDERGROUND WATER, VALVE COMMUNICATION, UNDERGROUND FIBER OPTIC, MANHOLE FIBER OPTIC, PEDESTAL FIBER OPTIC, STUB OUT NATURAL GAS, VALVE NATURAL GAS, UNDERGROUND POWER, JUNCTION BOX POWER, LIGHT POWER, OVERHEAD POWER, PEDESTAL PROPERTY, LINE LEGAL RIGHT-OF-WAY PROPERTY, CORNER FOUND	\square	SITE, MAIL BOX
S SANITARY SEWER, MANHOLE VEGETATION, TREE LINE WATER, FIRE HYDRANT WATER, STUB OUT WATER, UNDERGROUND WATER, VALVE COMMUNICATION, UNDERGROUND FIBER OPTIC, MANHOLE FIBER OPTIC, PEDESTAL FIBER OPTIC, STUB OUT NATURAL GAS, VALVE NATURAL GAS, UNDERGROUND POWER, JUNCTION BOX POWER, LIGHT POWER, OVERHEAD POWER, PEDESTAL PROPERTY, LINE LEGAL RIGHT—OF—WAY PROPERTY, CORNER FOUND	-0-	SITE, SIGN
VEGETATION, TREE LINE WATER, FIRE HYDRANT WATER, STUB OUT WATER, UNDERGROUND WATER, VALVE COMMUNICATION, UNDERGROUND FIBER OPTIC, MANHOLE FIBER OPTIC, PEDESTAL FIBER OPTIC, STUB OUT NATURAL GAS, VALVE NATURAL GAS, UNDERGROUND POWER, JUNCTION BOX POWER, LIGHT POWER, PEDESTAL PROPERTY, LINE LEGAL RIGHT—OF—WAY PROPERTY, CORNER FOUND	0	SANITARY SEWER, CLEAN-OUT
WATER, FIRE HYDRANT WATER, STUB OUT WATER, UNDERGROUND WATER, VALVE COMMUNICATION, UNDERGROUND FIBER OPTIC, MANHOLE FIBER OPTIC, PEDESTAL FIBER OPTIC, STUB OUT NATURAL GAS, VALVE NATURAL GAS, UNDERGROUND POWER, JUNCTION BOX POWER, LIGHT POWER, OVERHEAD POWER, PEDESTAL PROPERTY, LINE LEGAL RIGHT—OF—WAY PROPERTY, CORNER FOUND	\$	SANITARY SEWER, MANHOLE
WATER, STUB OUT WATER, UNDERGROUND WATER, VALVE COMMUNICATION, UNDERGROUND FIBER OPTIC, MANHOLE FIBER OPTIC, PEDESTAL FIBER OPTIC, STUB OUT NATURAL GAS, VALVE NATURAL GAS, UNDERGROUND POWER, JUNCTION BOX POWER, LIGHT POWER, OVERHEAD POWER, PEDESTAL PROPERTY, LINE LEGAL RIGHT—OF—WAY PROPERTY, CORNER FOUND		_ VEGETATION, TREE LINE
WATER, UNDERGROUND WATER, VALVE COMMUNICATION, UNDERGROUND FIBER OPTIC, MANHOLE FIBER OPTIC, PEDESTAL FIBER OPTIC, STUB OUT NATURAL GAS, VALVE NATURAL GAS, UNDERGROUND POWER, JUNCTION BOX POWER, LIGHT POWER, OVERHEAD POWER, PEDESTAL PROPERTY, LINE LEGAL RIGHT—OF—WAY PROPERTY, CORNER FOUND	-6-	WATER, FIRE HYDRANT
WATER, VALVE COMMUNICATION, UNDERGROUND FIBER OPTIC, MANHOLE FIBER OPTIC, PEDESTAL FIBER OPTIC, STUB OUT NATURAL GAS, VALVE NATURAL GAS, UNDERGROUND POWER, JUNCTION BOX POWER, LIGHT POWER, OVERHEAD POWER, PEDESTAL PROPERTY, LINE LEGAL RIGHT—OF—WAY PROPERTY, CORNER FOUND	₩	WATER, STUB OUT
COMMUNICATION, UNDERGROUND FIBER OPTIC, MANHOLE FIBER OPTIC, PEDESTAL FIBER OPTIC, STUB OUT NATURAL GAS, VALVE NATURAL GAS, UNDERGROUND POWER, JUNCTION BOX POWER, LIGHT POWER, OVERHEAD POWER, PEDESTAL PROPERTY, LINE LEGAL RIGHT—OF—WAY PROPERTY, CORNER FOUND	w w	_ WATER, UNDERGROUND
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FIBER OPTIC, PEDESTAL FIBER OPTIC, STUB OUT NATURAL GAS, VALVE NATURAL GAS, UNDERGROUND POWER, JUNCTION BOX POWER, LIGHT POWER, OVERHEAD POWER, PEDESTAL PROPERTY, LINE LEGAL RIGHT—OF—WAY PROPERTY, CORNER FOUND	UCUC	COMMUNICATION, UNDERGROUND
FIBER OPTIC, STUB OUT NATURAL GAS, VALVE NATURAL GAS, UNDERGROUND POWER, JUNCTION BOX POWER, LIGHT POWER, OVERHEAD POWER, PEDESTAL PROPERTY, LINE LEGAL RIGHT—OF—WAY PROPERTY, CORNER FOUND	FO	FIBER OPTIC, MANHOLE
NATURAL GAS, VALVE NATURAL GAS, UNDERGROUND POWER, JUNCTION BOX POWER, LIGHT POWER, OVERHEAD POWER, PEDESTAL PROPERTY, LINE LEGAL RIGHT—OF—WAY PROPERTY, CORNER FOUND	FO	FIBER OPTIC, PEDESTAL
POWER, JUNCTION BOX POWER, LIGHT POWER, OVERHEAD POWER, PEDESTAL PROPERTY, LINE LEGAL RIGHT—OF—WAY PROPERTY, CORNER FOUND	•	FIBER OPTIC, STUB OUT
POWER, JUNCTION BOX POWER, LIGHT POWER, OVERHEAD POWER, PEDESTAL PROPERTY, LINE LEGAL RIGHT-OF-WAY PROPERTY, CORNER FOUND		NATURAL GAS, VALVE
POWER, LIGHT POWER, OVERHEAD POWER, PEDESTAL PROPERTY, LINE LEGAL RIGHT-OF-WAY PROPERTY, CORNER FOUND	UGUG	NATURAL GAS, UNDERGROUND
POWER, OVERHEAD POWER, PEDESTAL PROPERTY, LINE LEGAL RIGHT-OF-WAY PROPERTY, CORNER FOUND	EJB	POWER, JUNCTION BOX
POWER, PEDESTAL PROPERTY, LINE LEGAL RIGHT-OF-WAY PROPERTY, CORNER FOUND	\Diamond	POWER, LIGHT
PROPERTY, LINE LEGAL RIGHT-OF-WAY PROPERTY, CORNER FOUND		POWER, OVERHEAD
•		PROPERTY, LINE LEGAL RIGHT—OF—WAY
-	• • • • • • • • • • • • • • • • • • •	PROPERTY, CORNER SET PROPERTY, CONCRETE MONUMENT — PROPERTY, ADJOINING LINE

LINE TABLE					
LINE#	BEARING	DISTANCE			
L1	S 46°37'46" E	42.97'			
L2	S 37°52'58" E	106.82'			
L3	S 41°24'08" E	166.49'			

CURVE TABLE						
CURVE#	RADIUS	DELTA	ARC LENGTH	TANGENT	CHORD LENGTH	CHORD BEARING
C1	567.00'	031°27'47"	311.36'	159.71	307.46'	S 61°41'13" E
C2	503.00'	001°27'41"	12.83'	6.42	12.83'	S 25°56'33" E



I FURTHER CERTIFY TO ONE OR MORE OF THE FOLLOWING AS INDICATED:

☑ 1. THAT THE SURVEY IS OF AN EXISTING PARCEL OR PARCELS OF LAND OR ONE OR MORE EXISTING EASEMENTS AND DOES NOT CREATE A NEW STREET OR CHANGE AN EXISTING STREET. FOR THE PURPOSES OF THIS SUBSECTION, AN "EXISTING PARCEL" OR "EXISTING EASEMENT" IS AN AREA OF LAND DESCRIBED IN A SINGLE, LEGAL DESCRIPTION OR LEGALLY RECORDED SUBDIVISION THAT HAS BEEN OR MAY BE LEGALLY CONVEYED TO A NEW OWNER BY DEED IN ITS EXISTING CONFIGURATION.

TO: TBD, LLC, A NORTH CAROLINA LIMITED LIABILITY COMPANY AND/OR ITS SUCCESSORS AND ASSIGNS, AS THEIR INTERESTS MAY APPEAR AND FC ROLESVILLE, LLC, A DELAWARE LIMITED LIABILITY COMPANY. THIS IS TO CERTIFY THAT THIS MAP OR PLAT AND THE SURVEY ON WHICH IT IS BASED WERE MADE IN ACCORDANCE WITH THE 2021 MINIMUM STANDARD DETAIL REQUIREMENTS FOR ALTA/NSPS LAND TITLE SURVEYS, JOINTLY ESTABLISHED AND ADOPTED BY ALTA AND NSPS, AND INCLUDES ITEMS 1, 2, 3, 4, 6(a), 8, 11(b), 13, 16 AND 17 OF TABLE A THEREOF.

THE FIELD WORK WAS COMPLETED IN SEPTEMBER, 2022.

BRUCE J. FREDERICK, L-4246



WATER OR

VICINITY MAP

NO SCALE



ALL DOCUMENTS PREPARED BY PENNONI ASSOCIATES ARE INSTRUMENTS OF SERVICE IN RESPECT OF THE PROJECT. THEY ARE NOT INTENDED OR REPRESENTE TO BE SUITABLE FOR REUSE BY OWNER OR OTHERS OF THE EXTENSIONS OF THE PROJECT OR ON ANY OTHER

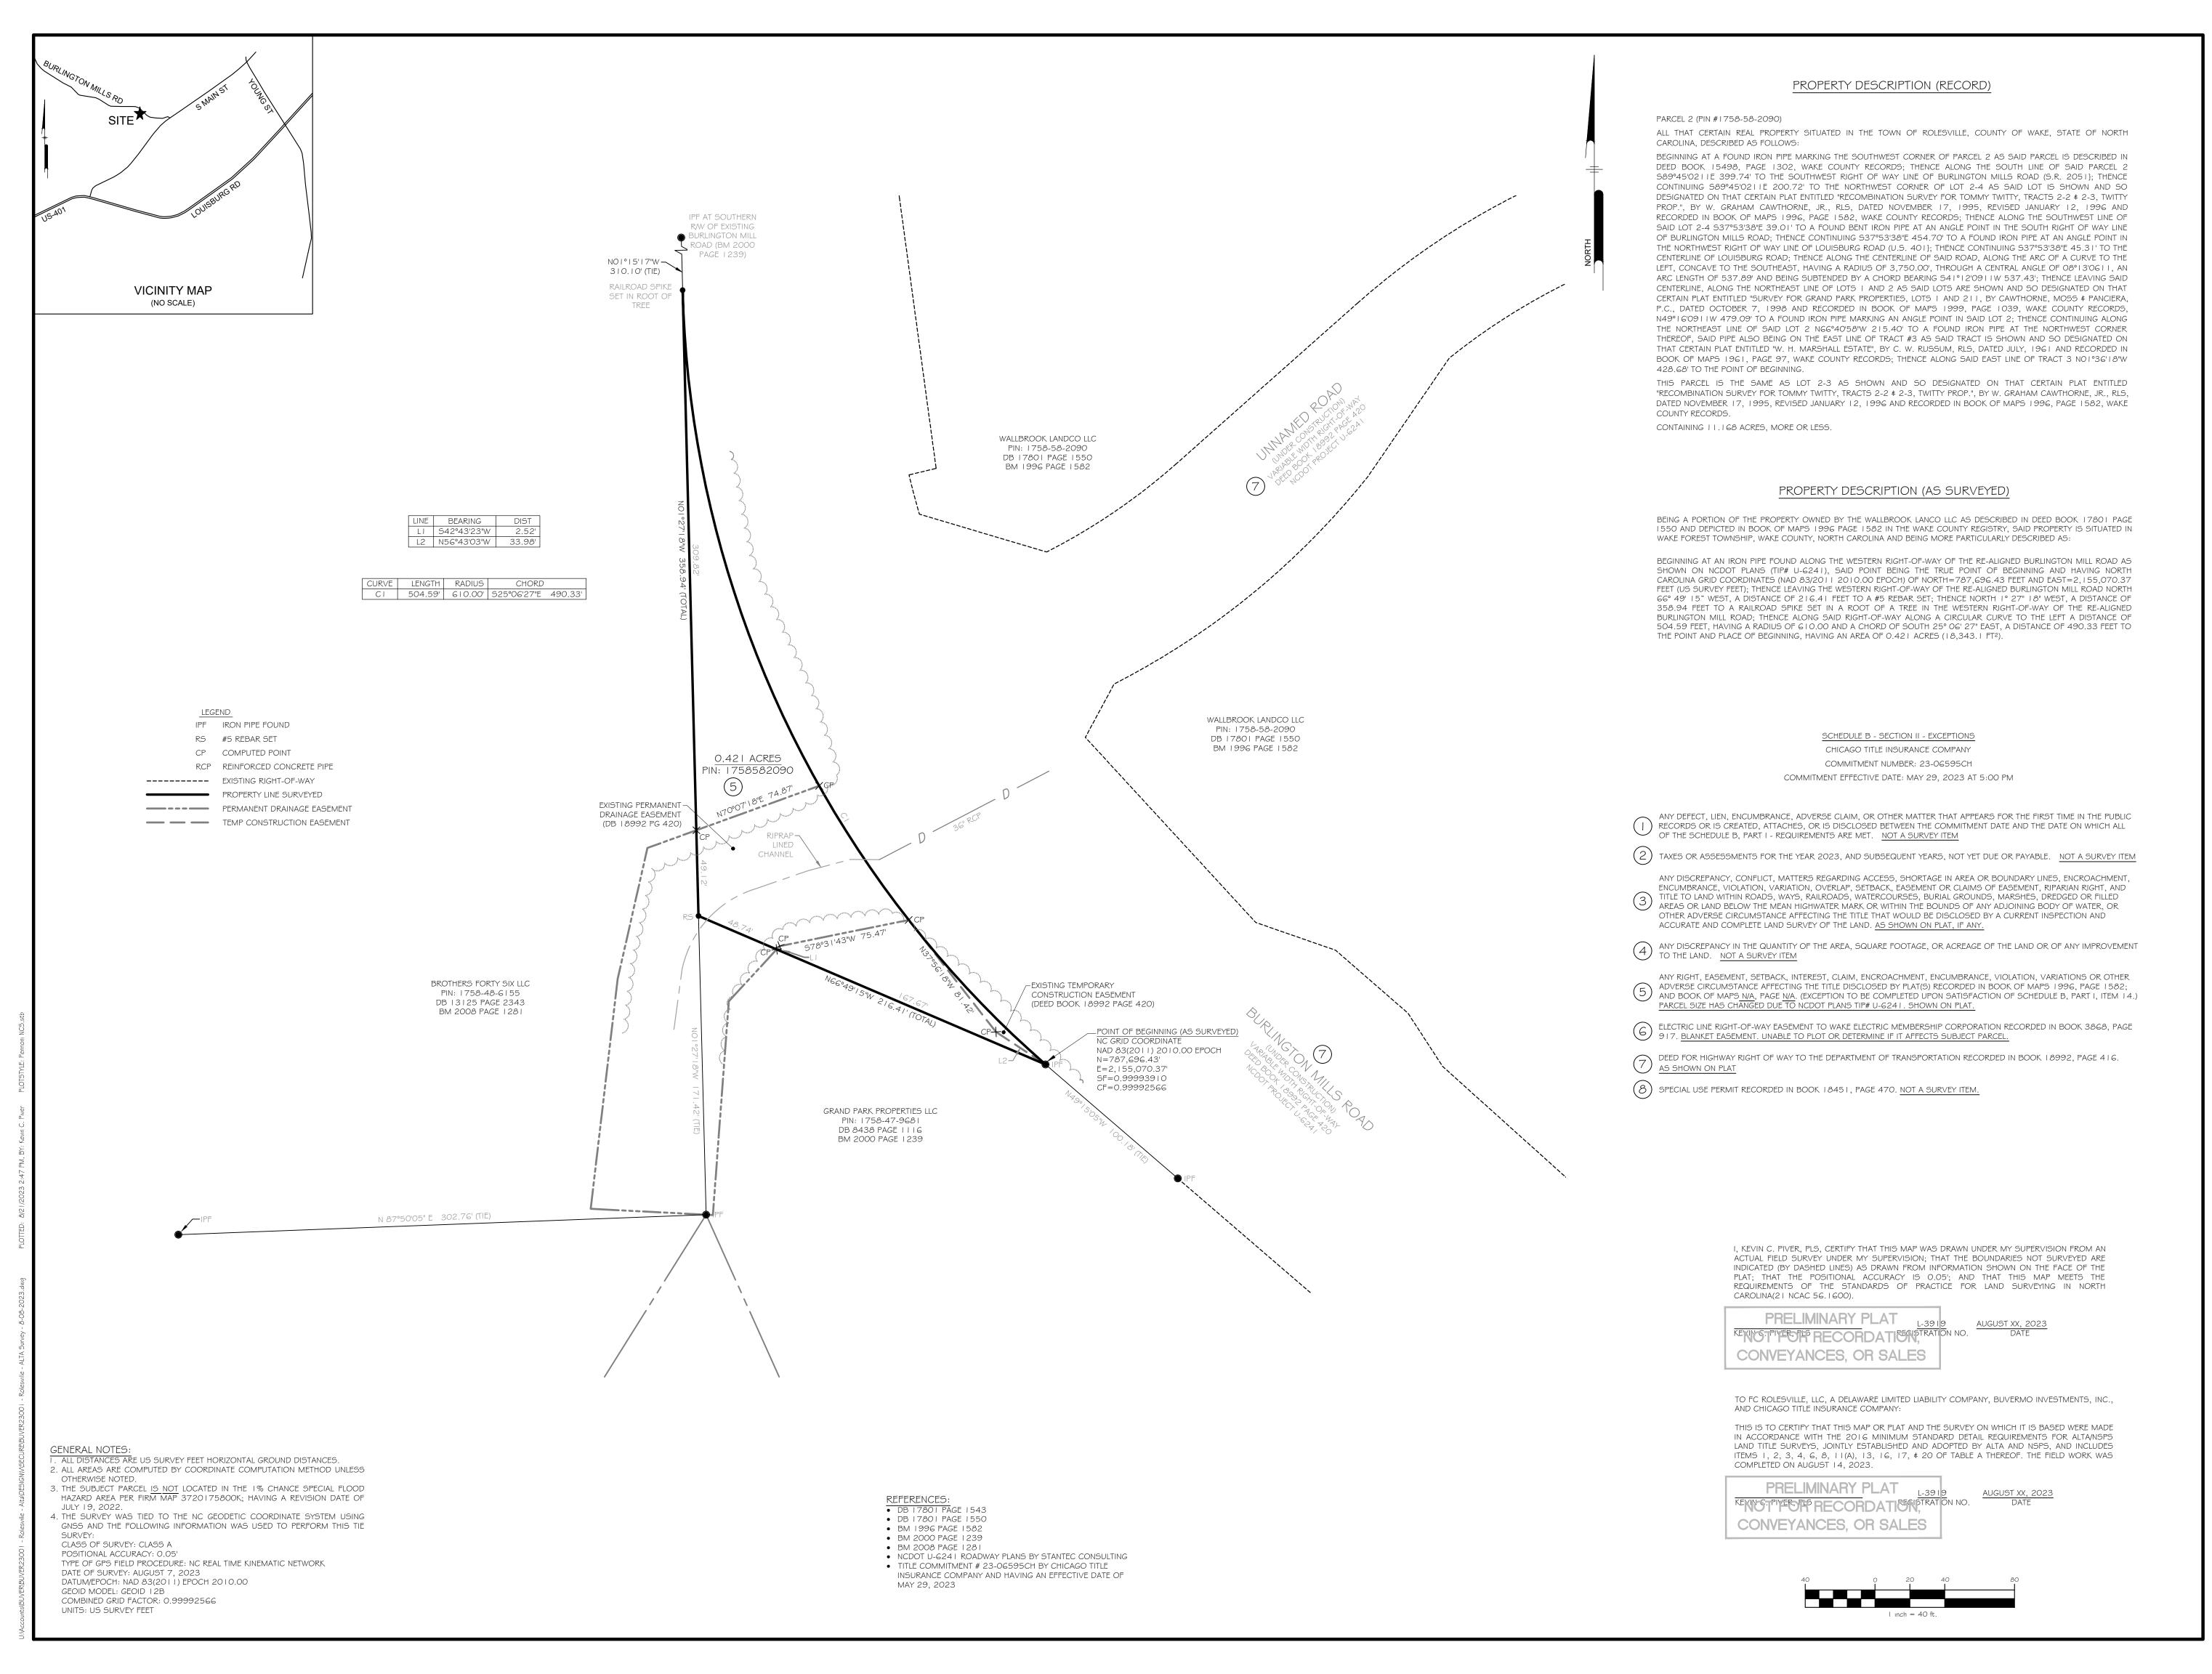
PROJECT. ANY REUSE WITHOUT WRITTEN VERIFICATION OR ADAPTATION BY PENNONI ASSOCIATES FOR THE SPECIFIC PURPOSE INTENDED WILL BE AT OWNERS SOLE RISK AND WITHOUT LIABILITY OR LEGAL EXPOSURE TO PENNONI ASSOCIATES; AND OWNER SHALL INDEMNIFY AND HOLD HARMLESS PENNONI ASSOCIATES FROM ALL CLAIMS, DAMAGES, LOSSES AN EXPENSES ARISING OUT OF OR RESULTING THEREFROM

2022-10-04 RAWING SCALE 1"=100' DRAWN BY DCF PPROVED BY

BUVER22001

PROJECT

SHEET 1 OF 1



Pennoni Fim License

PENNONI ASSOCIATES
5430 Wade Park Boulevard, S

E FOREST TOWNSHIP, WAKE COUNTON
INVESTMENTS, INC.

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ON STACE

PROJECT BUVER2300 |

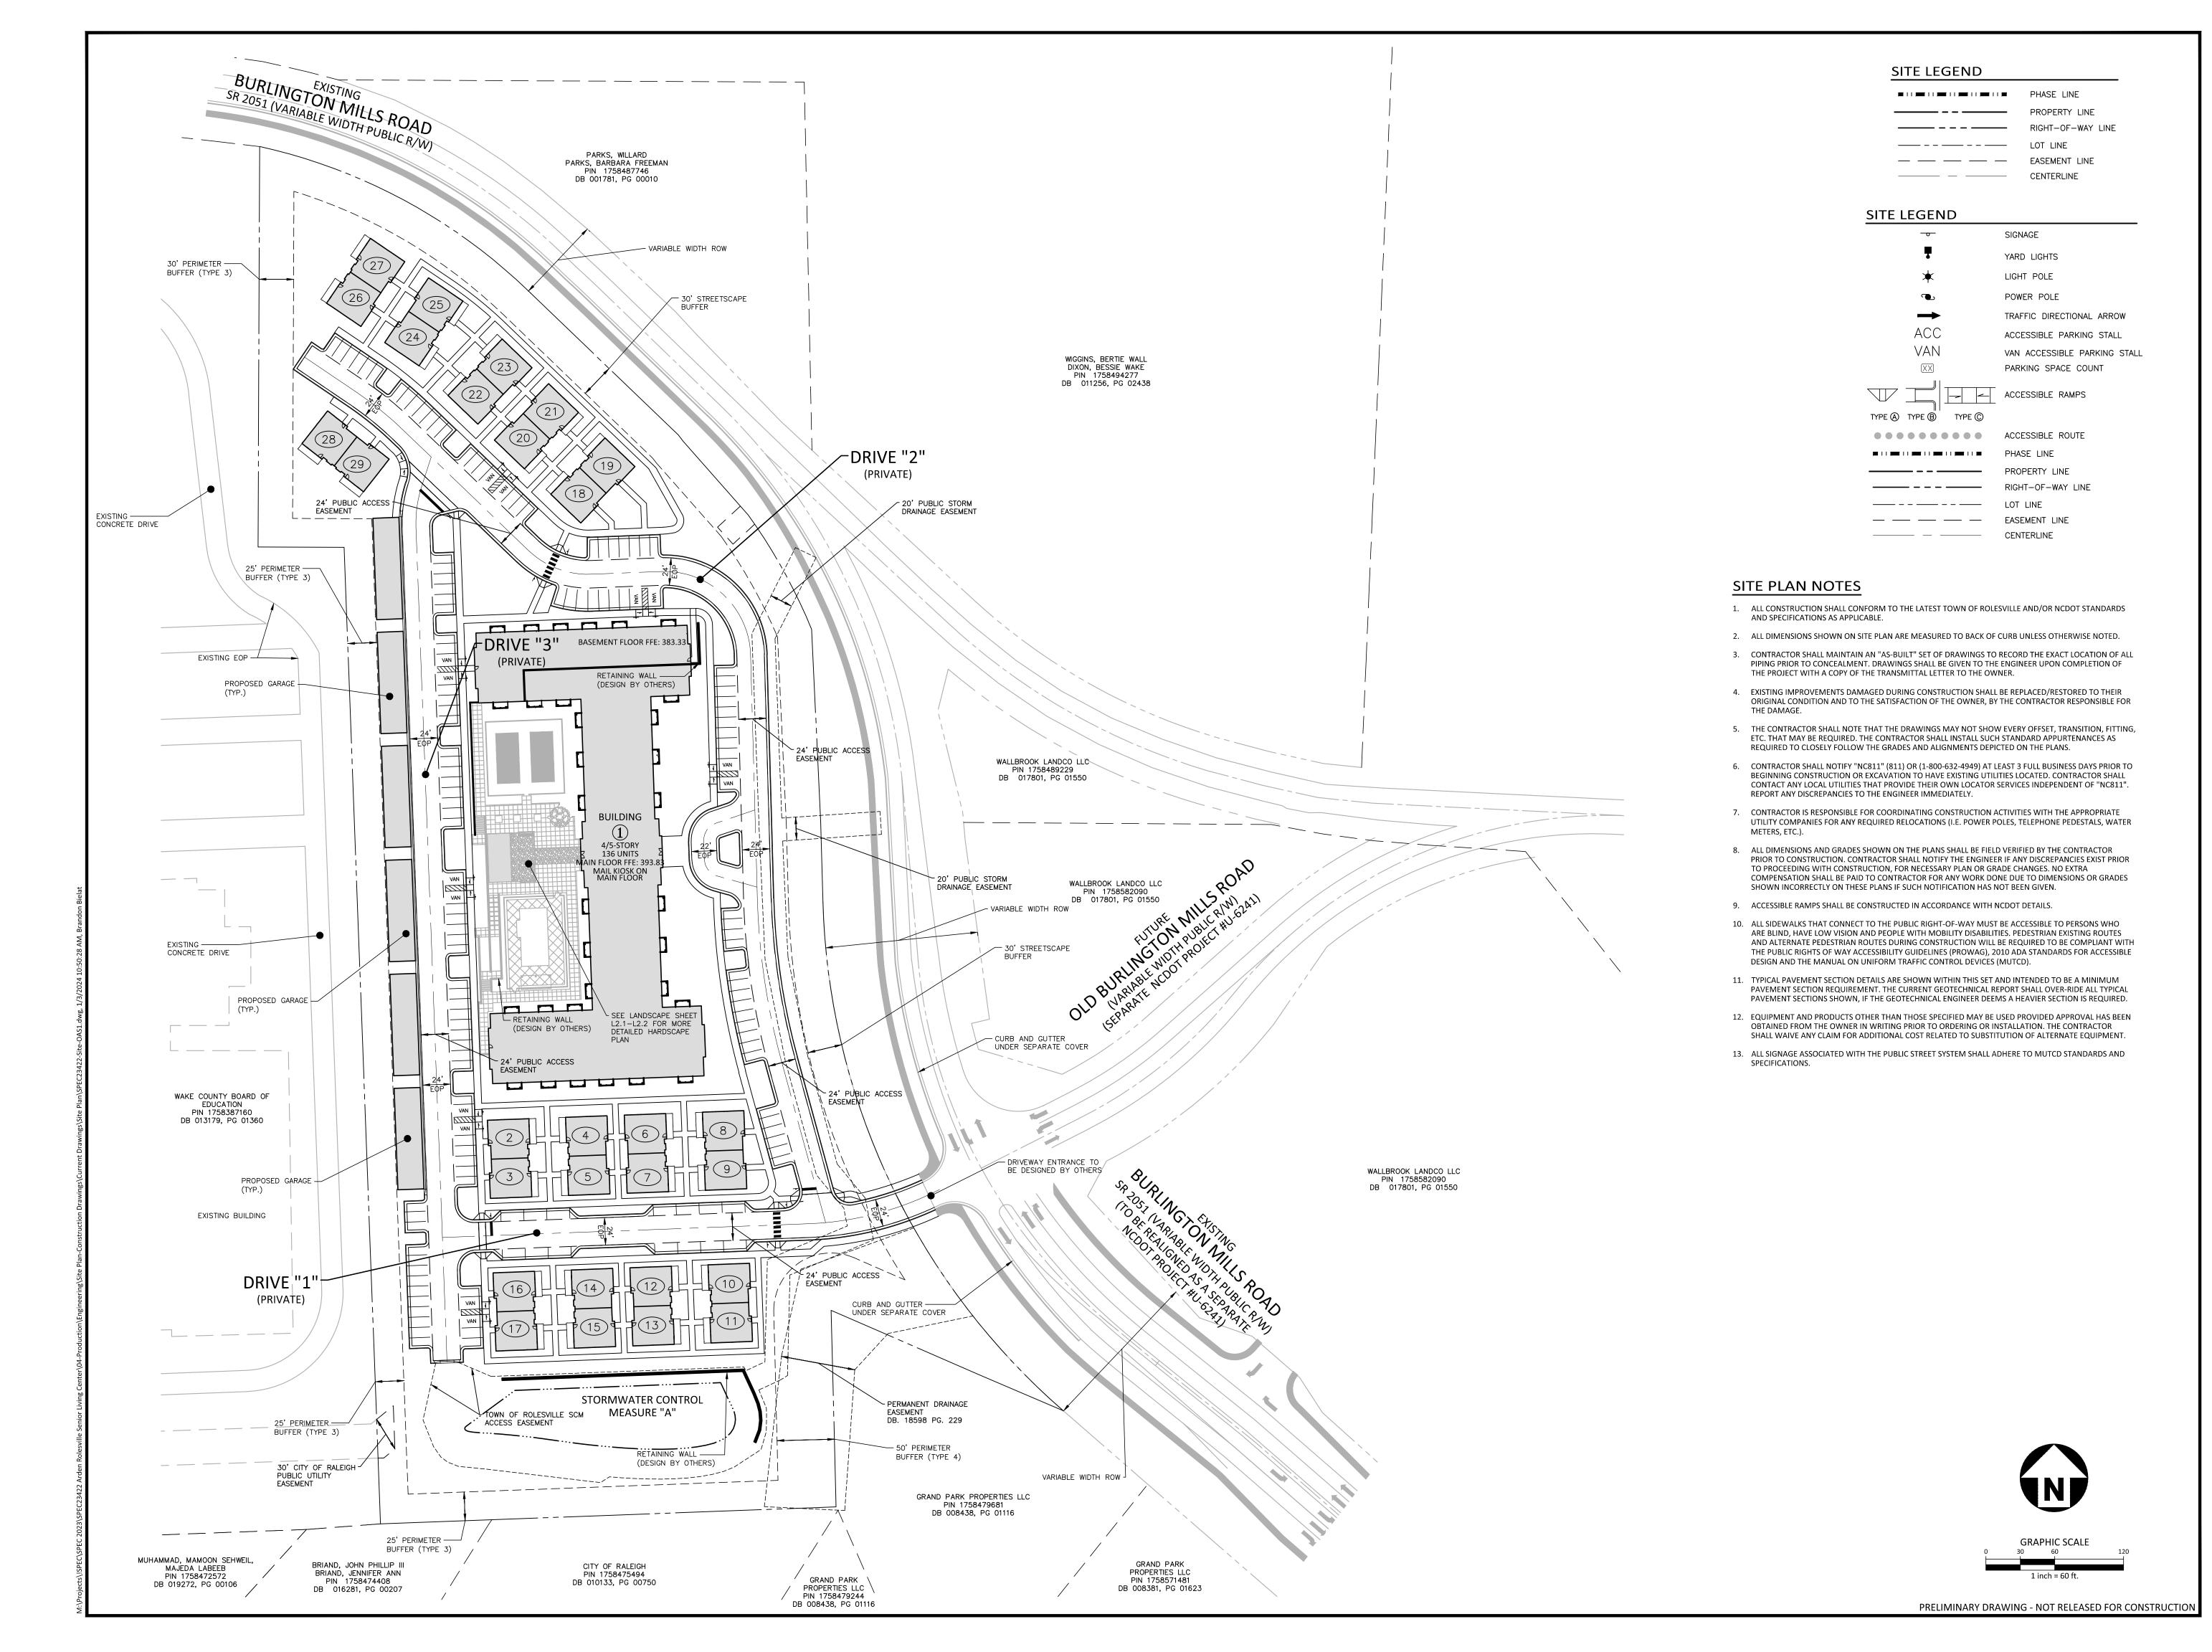
DATE 2023-08-07

DRAWING SCALE | " = 40"

DRAWN BY MGR

SHEET | OF |

PPROVED BY





McAdams

The John R. McAdams Company, Inc. 621 Hillsborough Street Suite 500 Raleigh, NC 27603

phone 919. 361. 5000 fax 919. 361. 2269 license number: C-0293, C-187

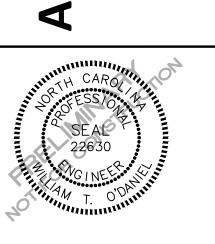
www.mcadamsco.com

CLIENT

BUVERMO INVESTMENTS, INC 7315 WISCONSIN AVENUE SUITE 925W BETHESDA, MARYLAND, 20814

TER TER

RDEN SENIOR LIVING CENTER SITE DEVELOPMENT PLAN ROLESVILLE, NORTH CAROLINA



REVISIONS

NO. DATE

PLAN INFORMATION

PROJECT NO. SPEC-23422

FILENAME SPEC23422-SITE-OAS1

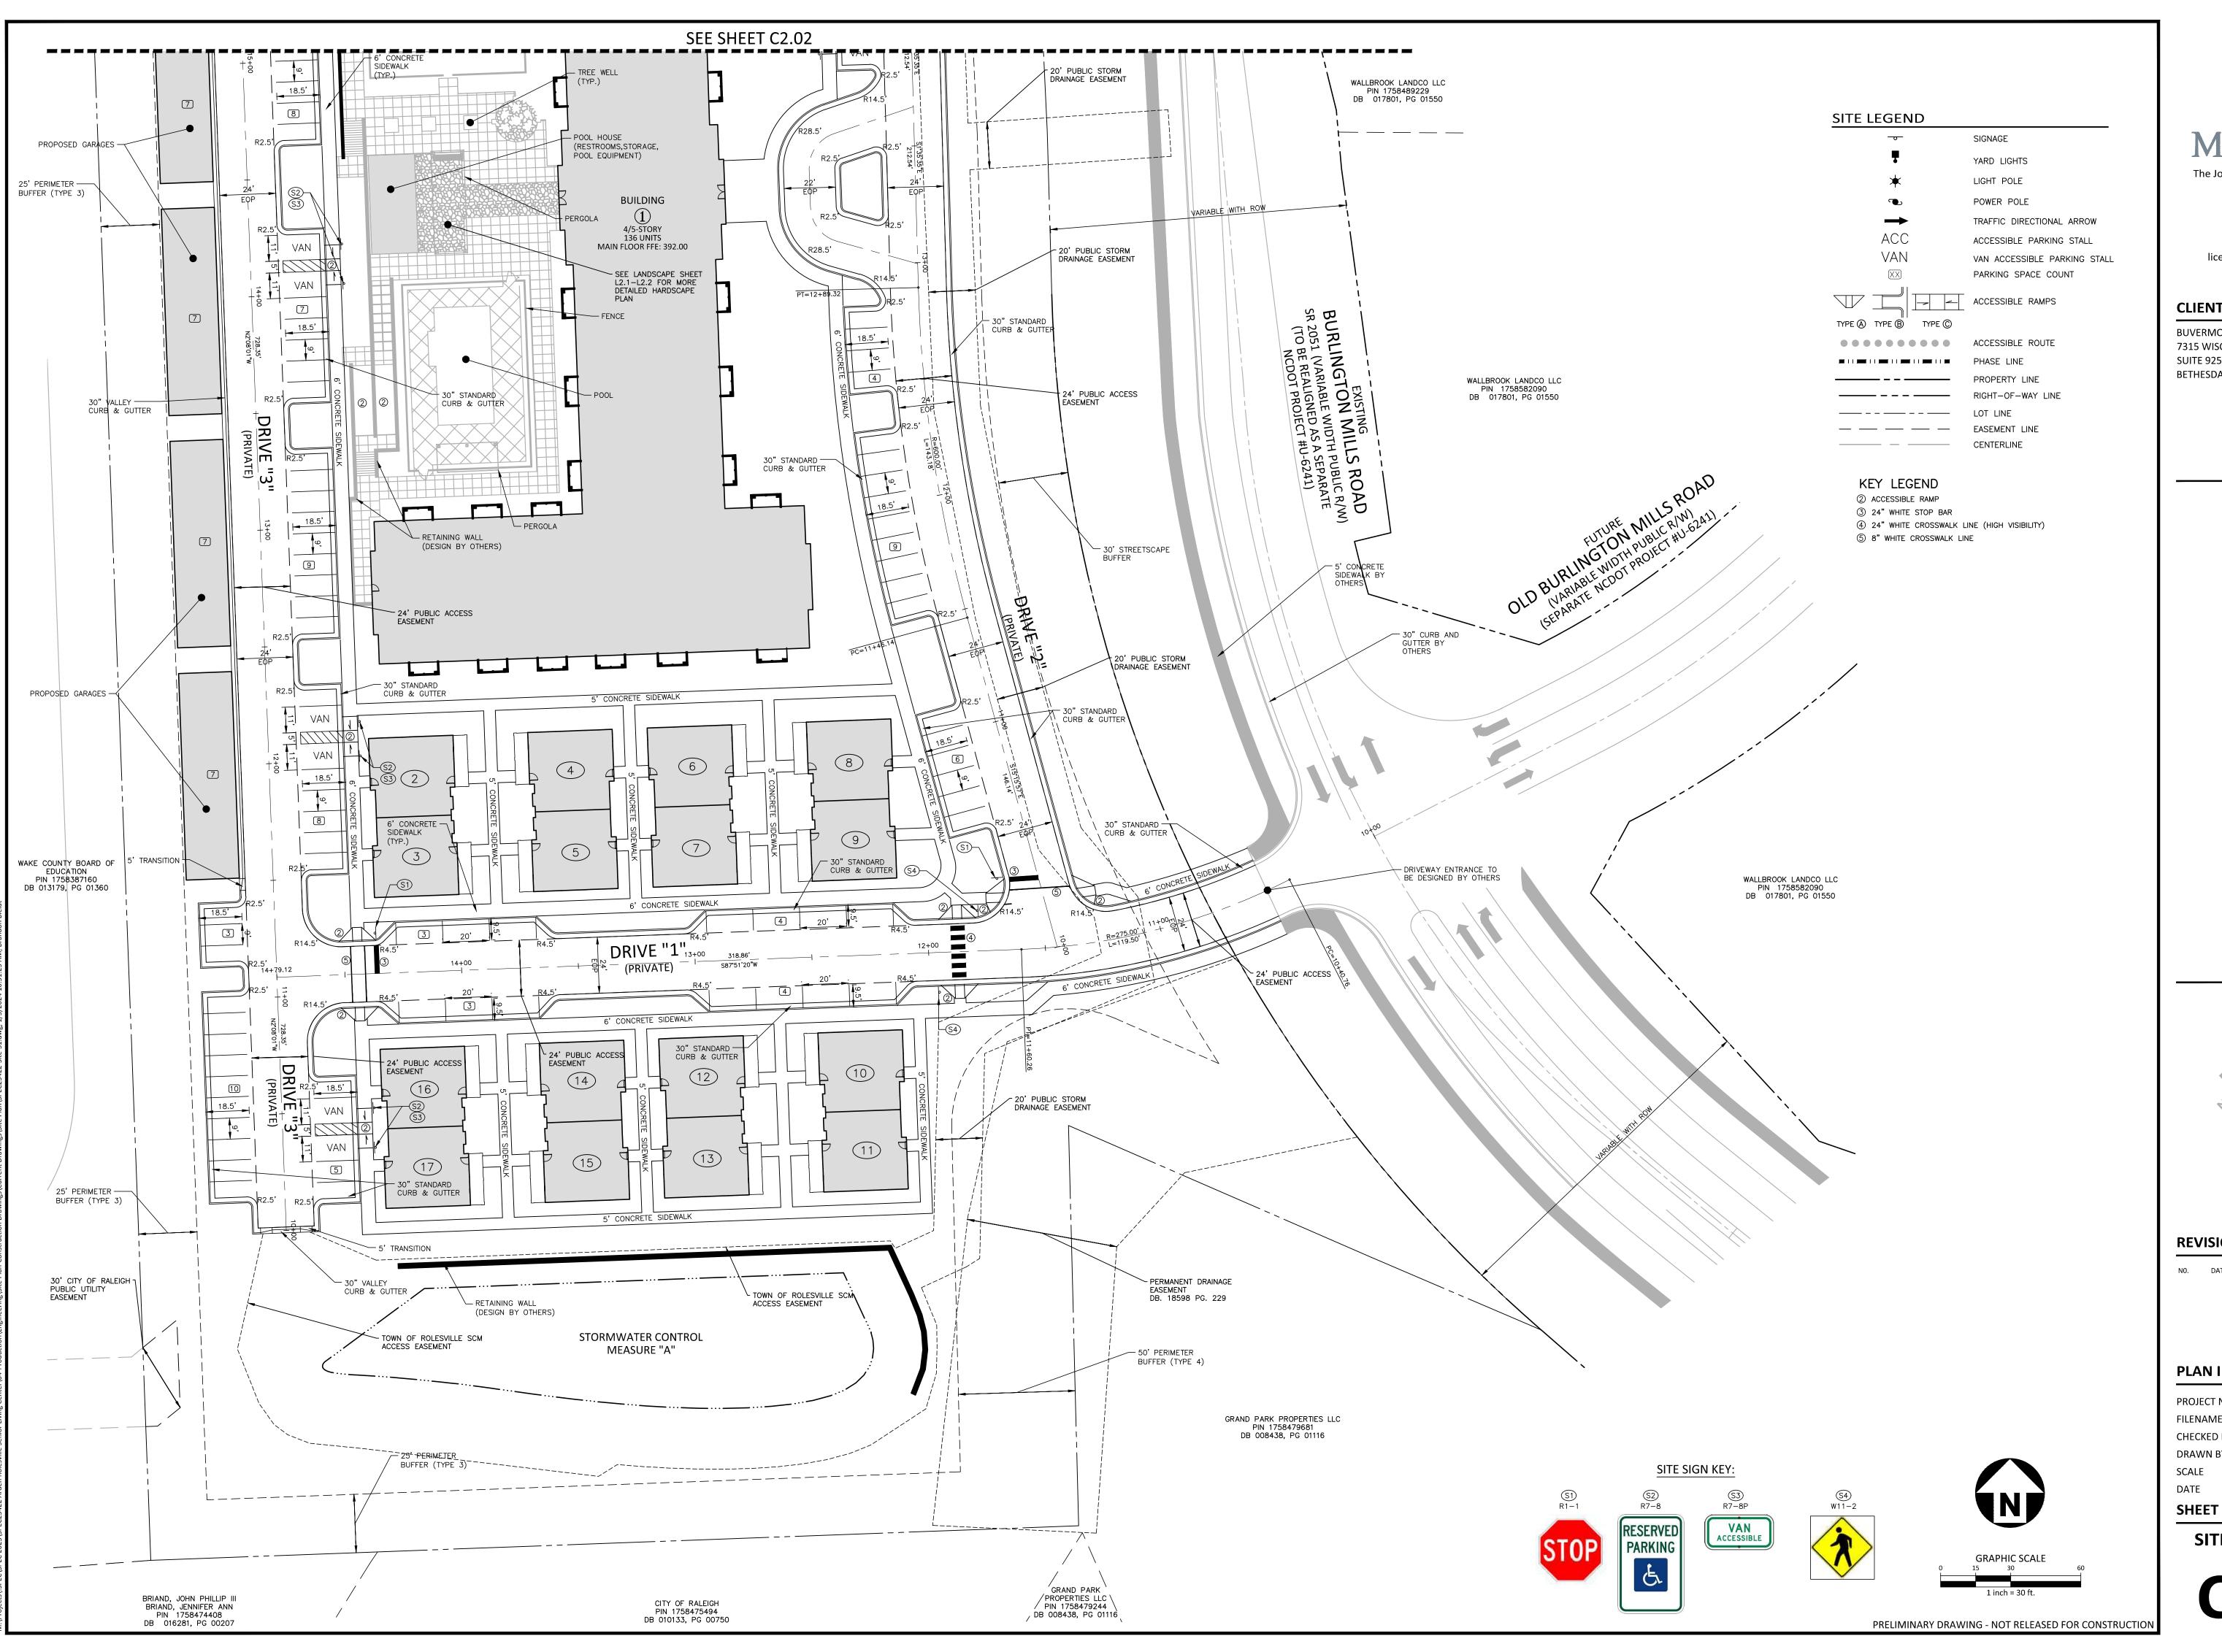
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DRAWN BY JMS

SCALE 1"=60'
DATE 01. 03. 2024

OVERALL SITE PLAN

C2.00





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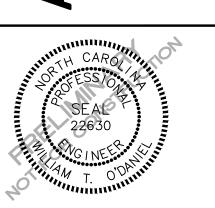
phone 919. 361. 5000 fax 919. 361. 2269 license number: C-0293, C-187

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CENTER **ARDEN**



REVISIONS

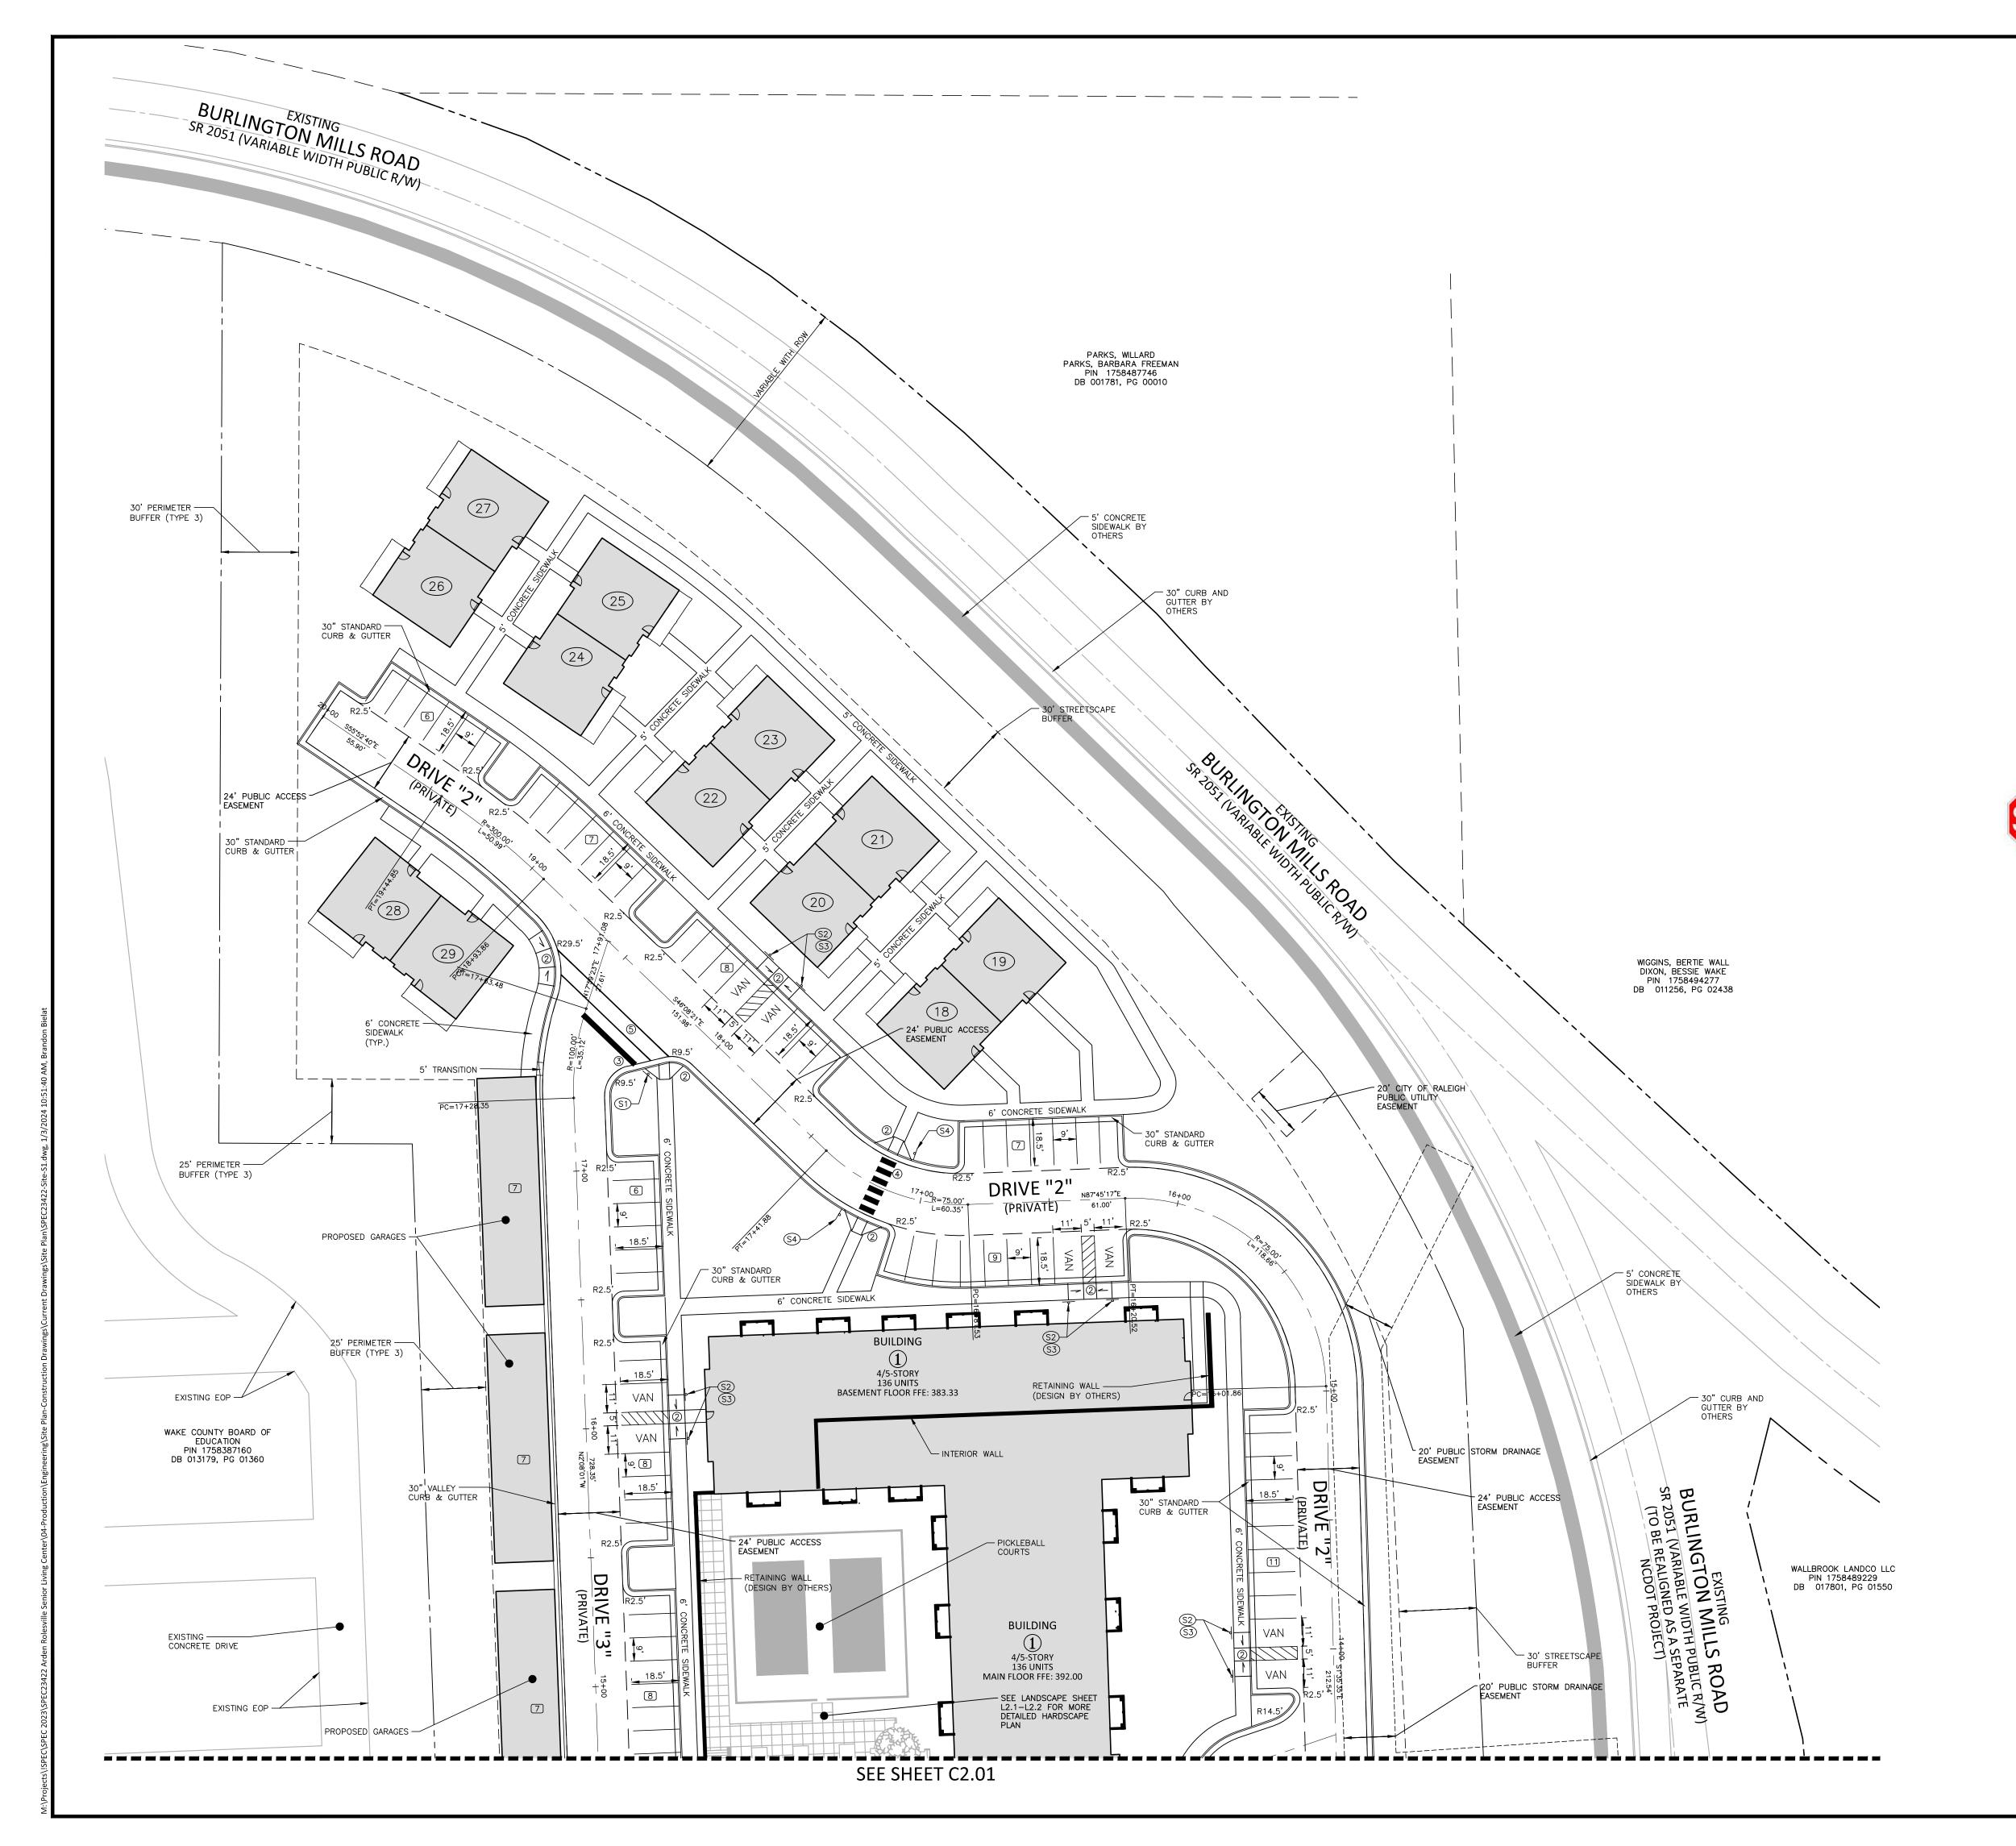
NO. DATE

PLAN INFORMATION

PROJECT NO. SPEC-23422 SPEC23422-SITE-S1 FILENAME CHECKED BY DRAWN BY SCALE

1"=30' 01. 03. 2024

SITE PLAN AREA "A"





SIGNAGE YARD LIGHTS LIGHT POLE POWER POLE TRAFFIC DIRECTIONAL ARROW ACCESSIBLE PARKING STALL VAN ACCESSIBLE PARKING STALL PARKING SPACE COUNT ACCESSIBLE RAMPS TYPE A TYPE B TYPE C

ACCESSIBLE ROUTE ____ - - ___ LOT LINE

PHASE LINE PROPERTY LINE RIGHT-OF-WAY LINE EASEMENT LINE CENTERLINE

KEY LEGEND

② ACCESSIBLE RAMP 3 24" WHITE STOP BAR

4 24" WHITE CROSSWALK LINE (HIGH VISIBILITY)

5 8" WHITE CROSSWALK LINE

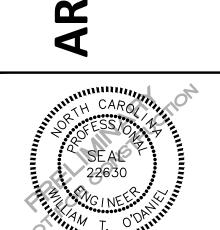
SITE SIGN KEY:











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Raleigh, NC 27603

phone 919. 361. 5000

fax 919. 361. 2269 license number: C-0293, C-187

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BETHESDA, MARYLAND, 20814

CENTER

7315 WISCONSIN AVENUE

CLIENT

SUITE 925W

REVISIONS

NO. DATE

PLAN INFORMATION

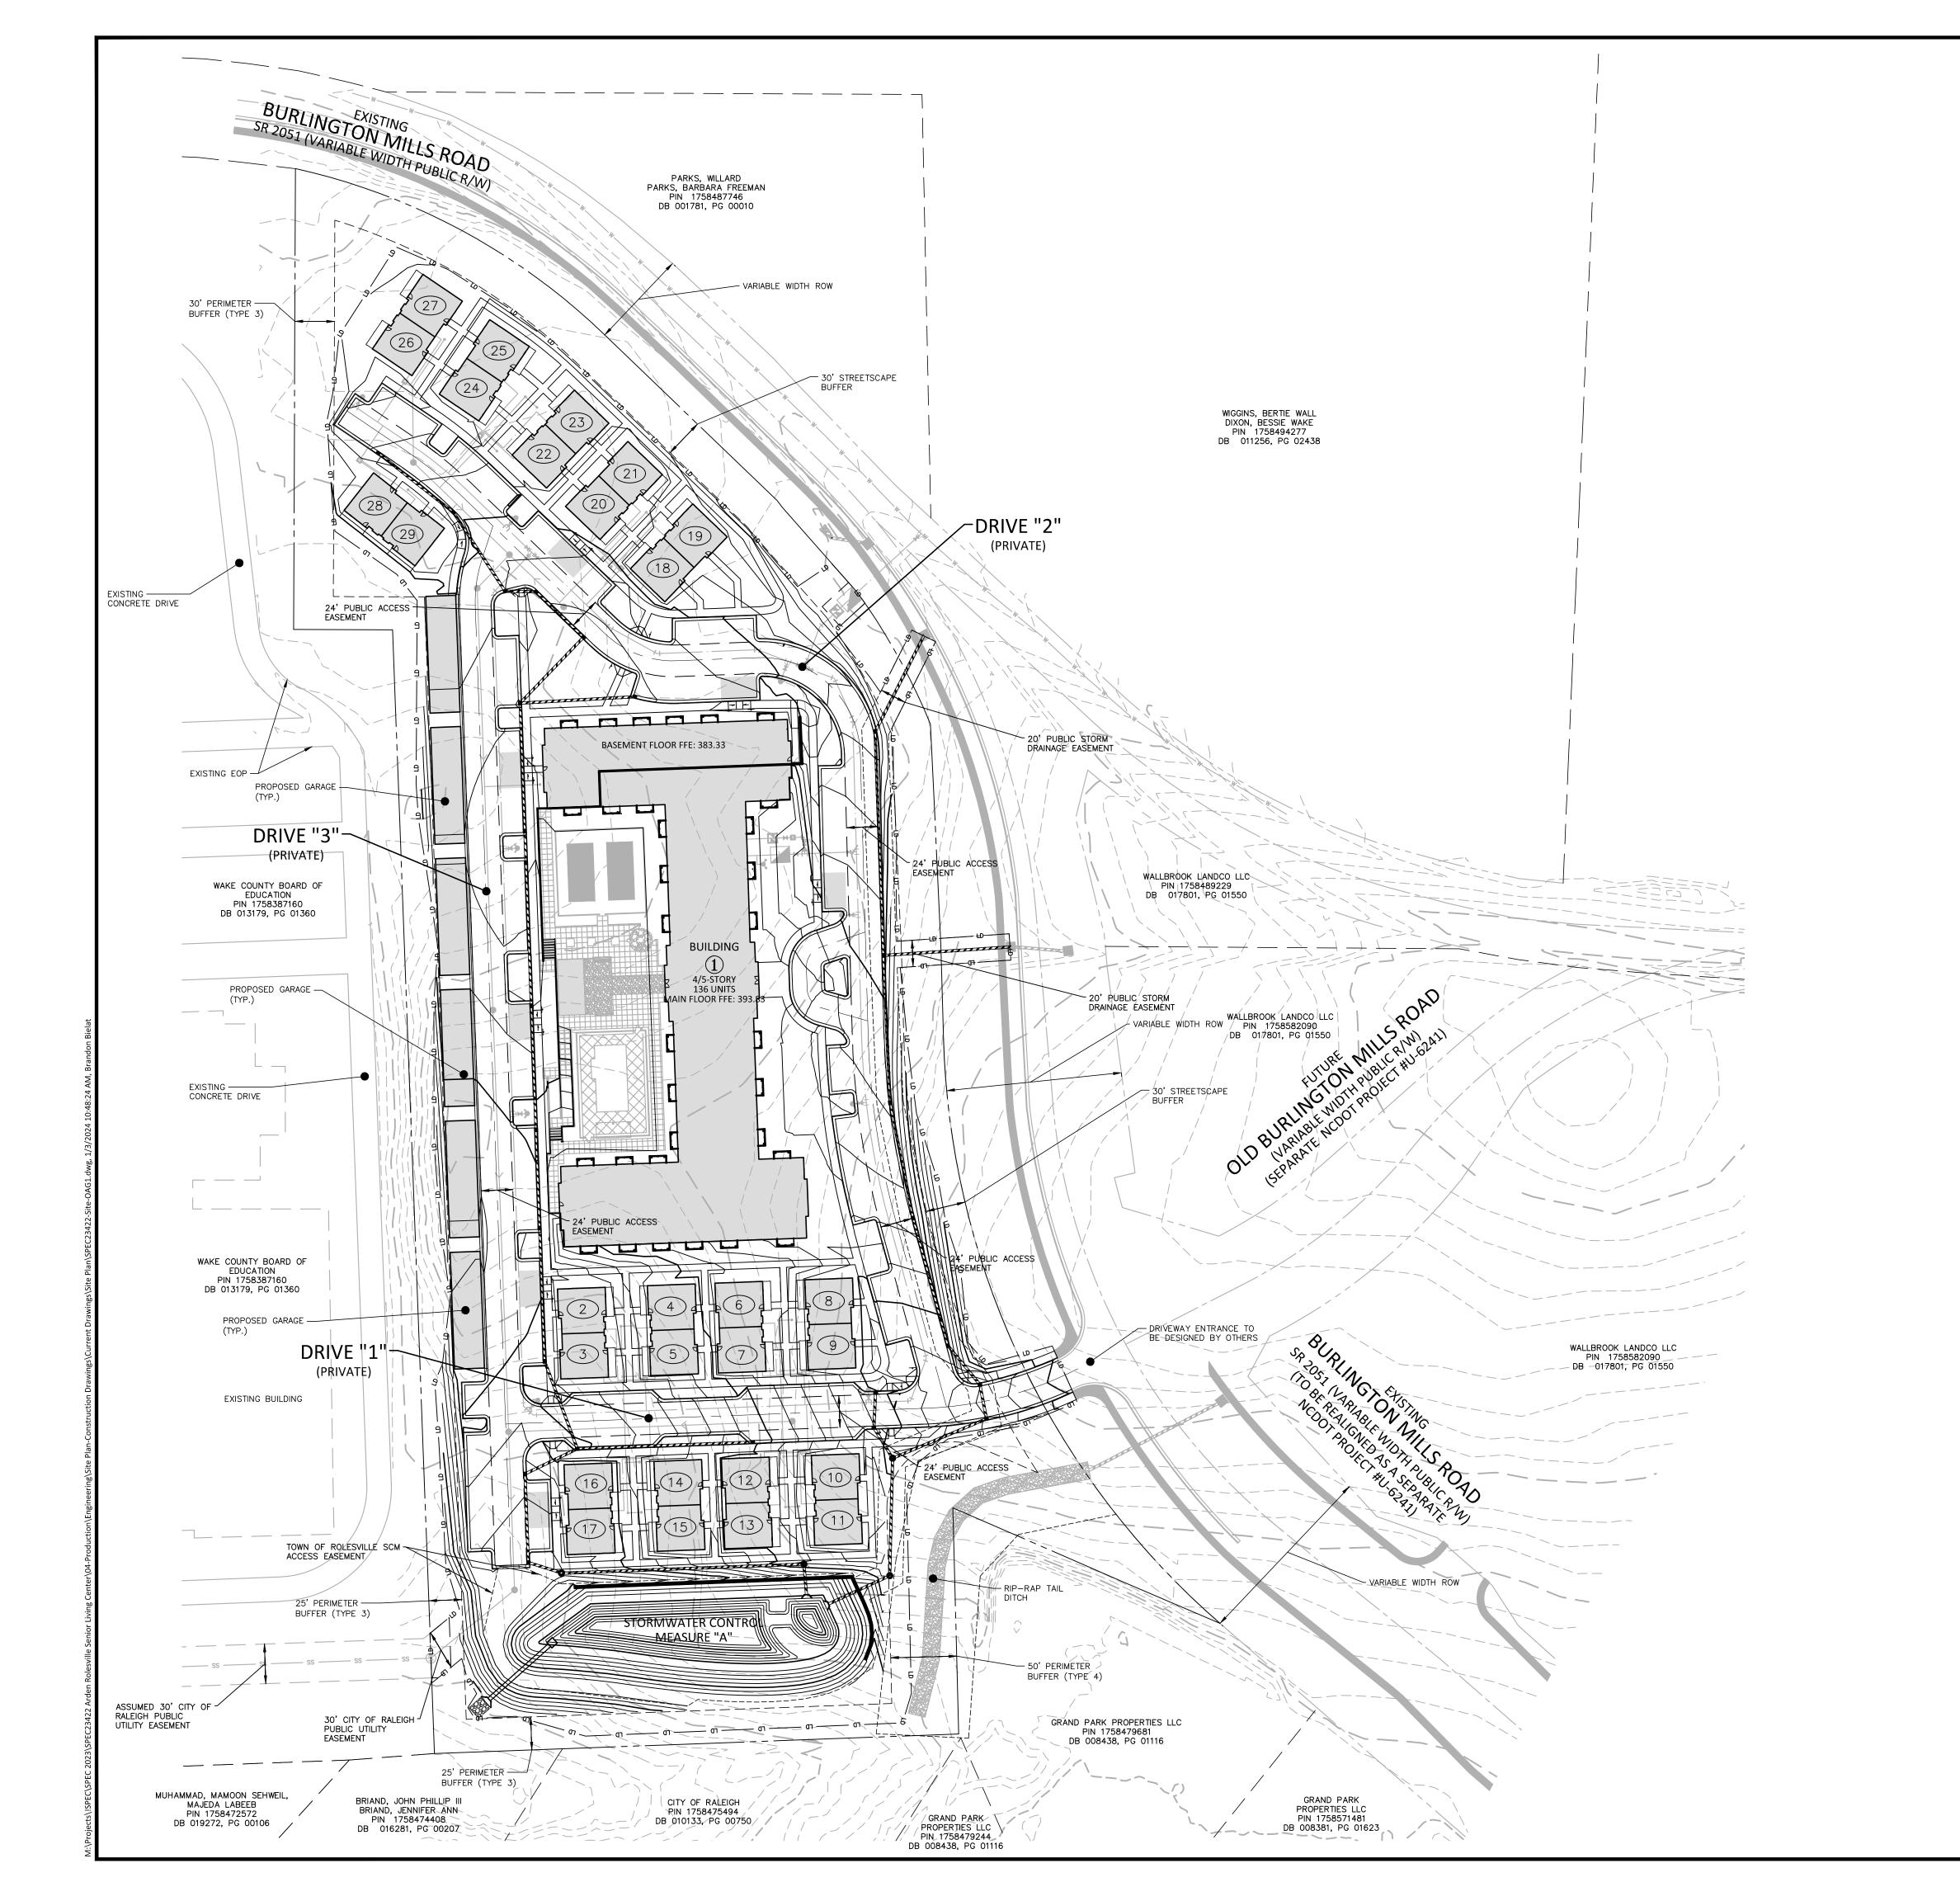
PROJECT NO. SPEC-23422 SPEC23422-SITE-S1 FILENAME CHECKED BY

DRAWN BY SCALE 1"=30' DATE 01. 03. 2024 SHEET

SITE PLAN AREA "B"

C2.02

PRELIMINARY DRAWING - NOT RELEASED FOR CONSTRUCTION





FLARED END SECTION ENDWALL SECTION CATCH BASIN DROP INLET STORM SERVICE INLET STORM SERVICE ROOF-DRAIN JUNCTION BOX DRAINAGE FLOW ARROW LINE BREAK SYMBOL TOP & BOTTOM CURB ELEVATIONS TW=223.00 — TOP OF WALL ELEVATION
BW=213.00 — BOTTOM OF WALL ELEVATION ---- BOTTOM OF WALL ELEVATION (NOTE: BOTTOM OF WALL IS GROUND ÈLEVATION NOT WALL FOUNDATION) + 250.60 SPOT ELEVATION STORM DRAINAGE

ROOF DRAIN, 8" ADS NON-PERFORATED TUBING OR EQUAL 1.0% MIN. SLOPE 3' MIN. COVER PVC SCHEDULE 40 IN TRAFFIC AREAS

— TP — TP — TP — TREE PROTECTION FENCE -----LD ------ LIMITS OF DISTURBANCE

WOODED AREA ______250 ____ MAJOR CONTOUR _____ MINOR CONTOUR EXISTING MAJOR CONTOUR _____252____ EXISTING MINOR CONTOUR — — — EASEMENT LINE

ACCESSIBLE PARKING AREA (2% MAX. SLOPE IN ALL DIRECTIONS)



PRELIMINARY DRAWING - NOT RELEASED FOR CONSTRUCTION



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CLIENT

SUITE 925W

REVISIONS

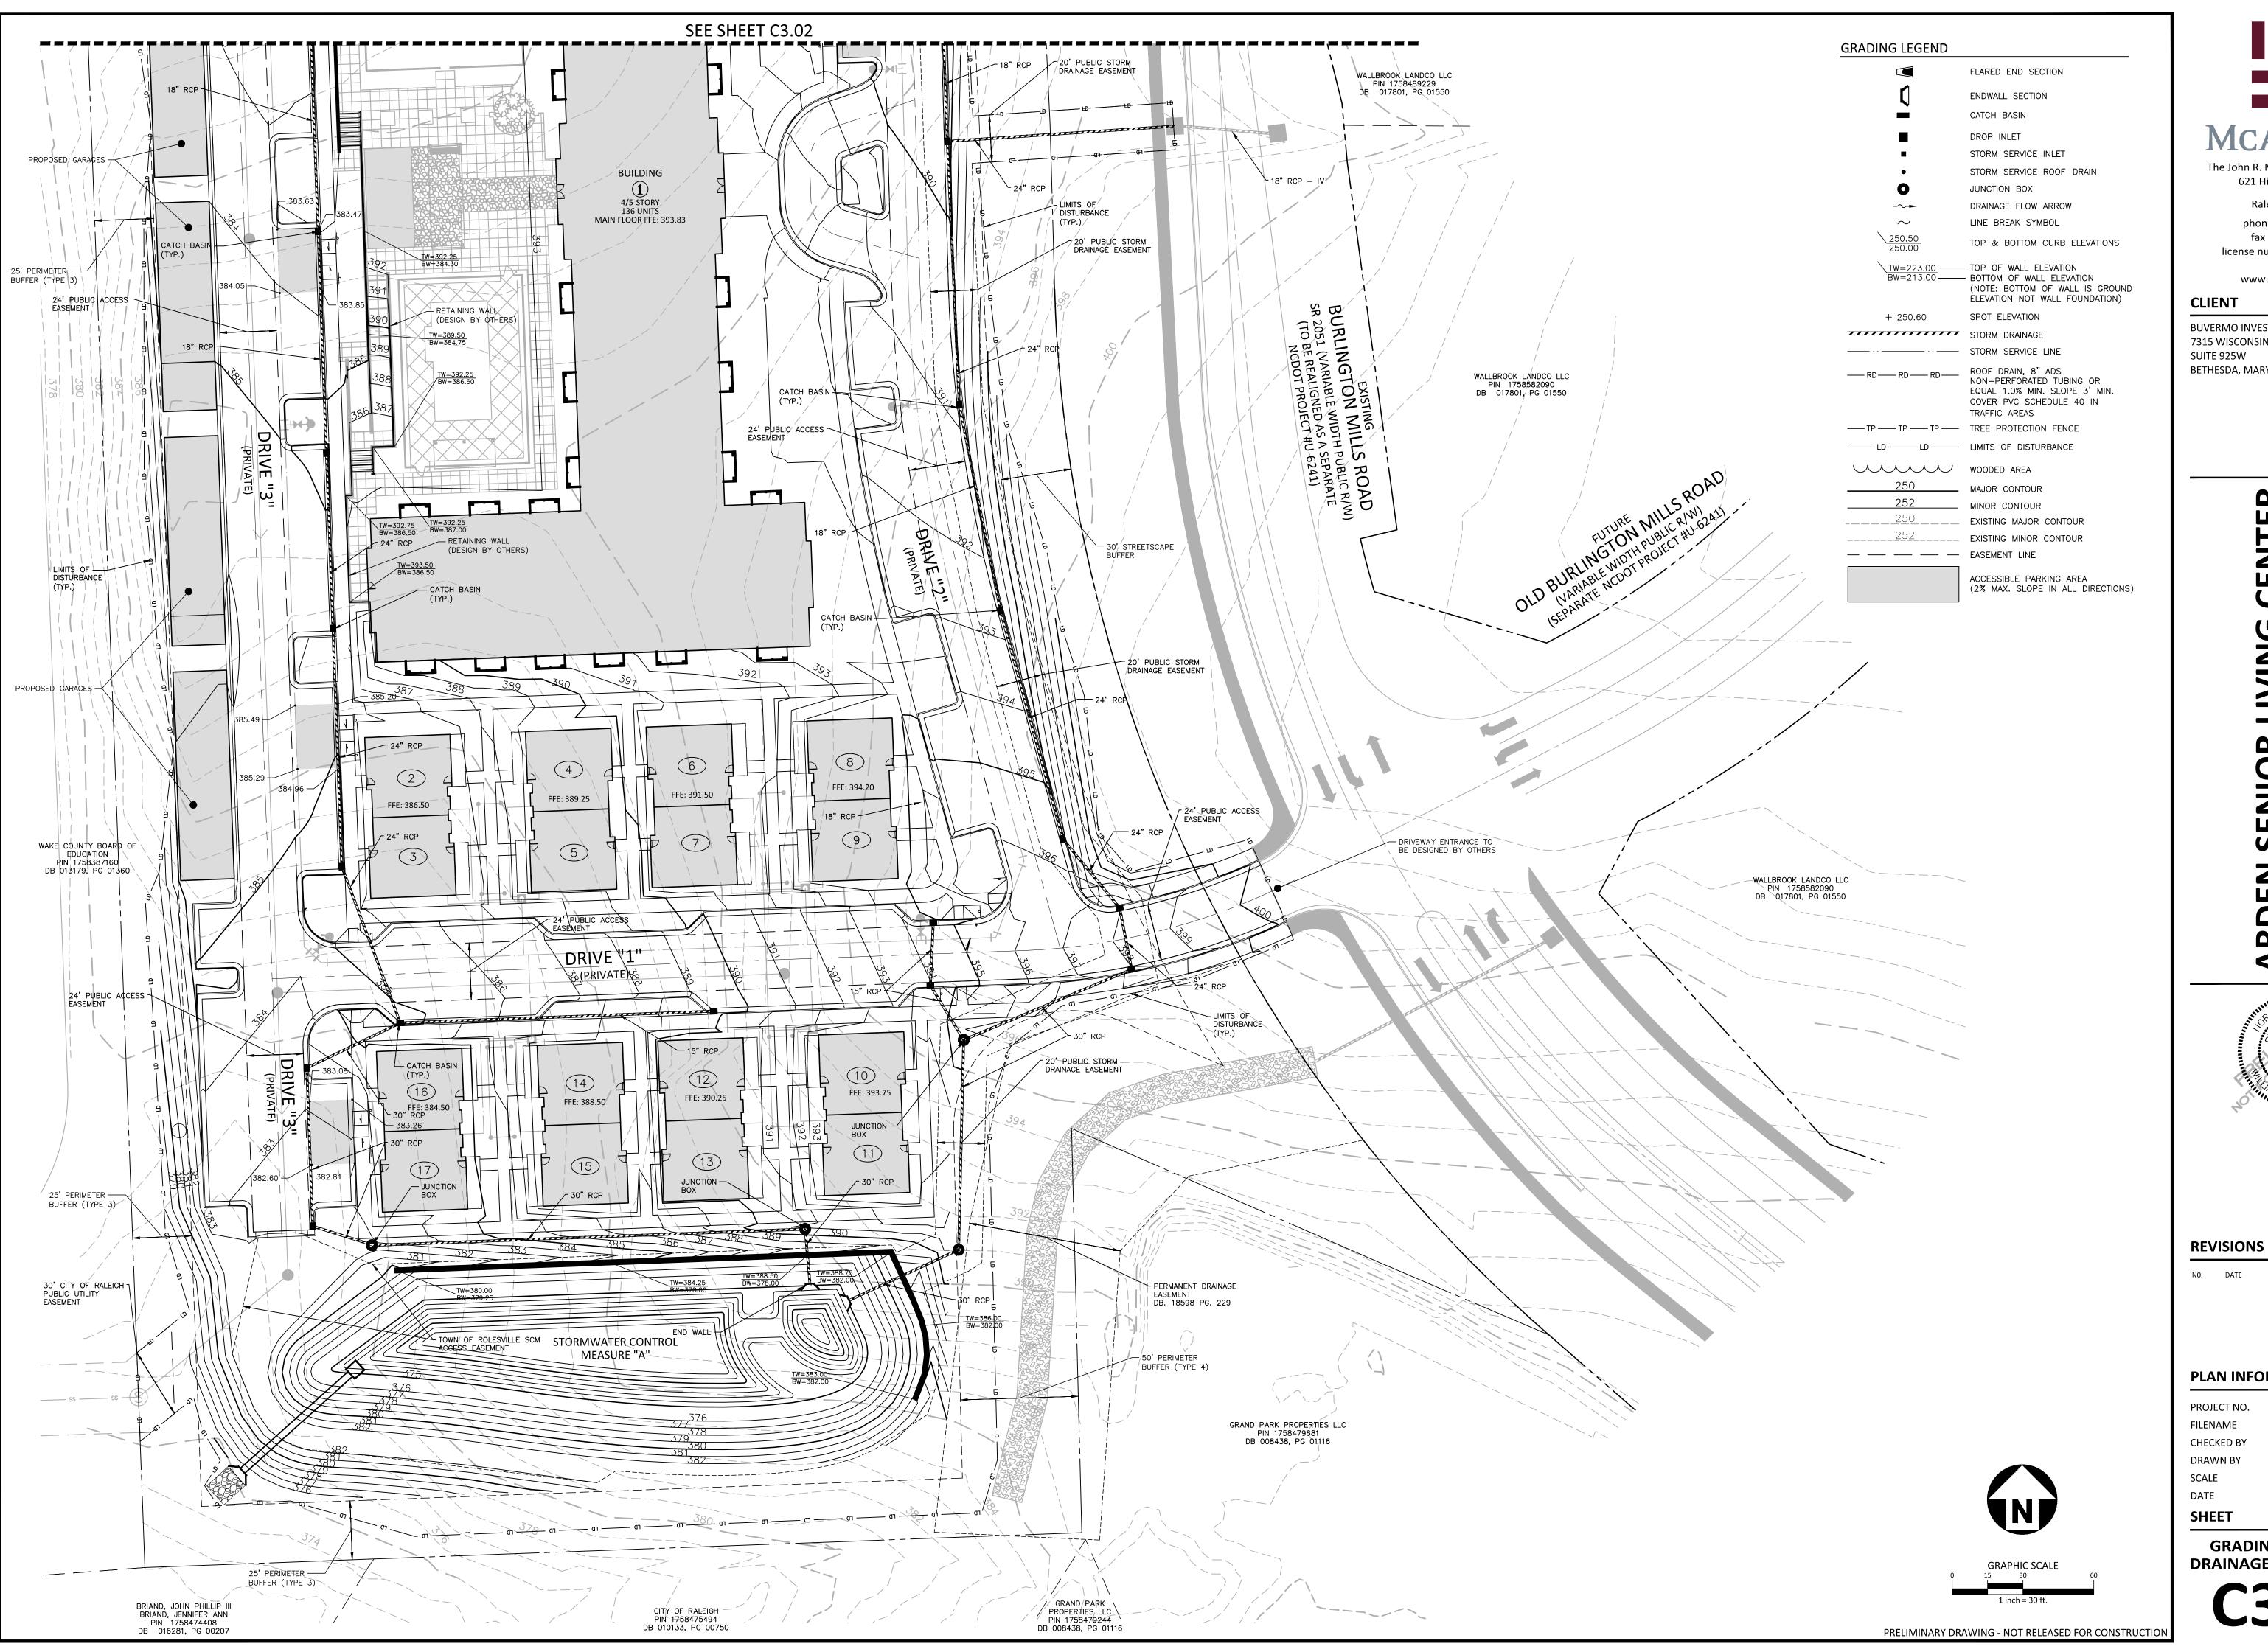
NO. DATE

PLAN INFORMATION

PROJECT NO. SPEC-23422 SPEC23422-SITE-OAG1 FILENAME CHECKED BY

DRAWN BY SCALE 1"=60' DATE 01. 03. 2024

SHEET **OVERALL GRADING AND** STORM DRAINAGE PLAN





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BETHESDA, MARYLAND, 20814

7315 WISCONSIN AVENUE SUITE 925W

CENTER

PLAN INFORMATION

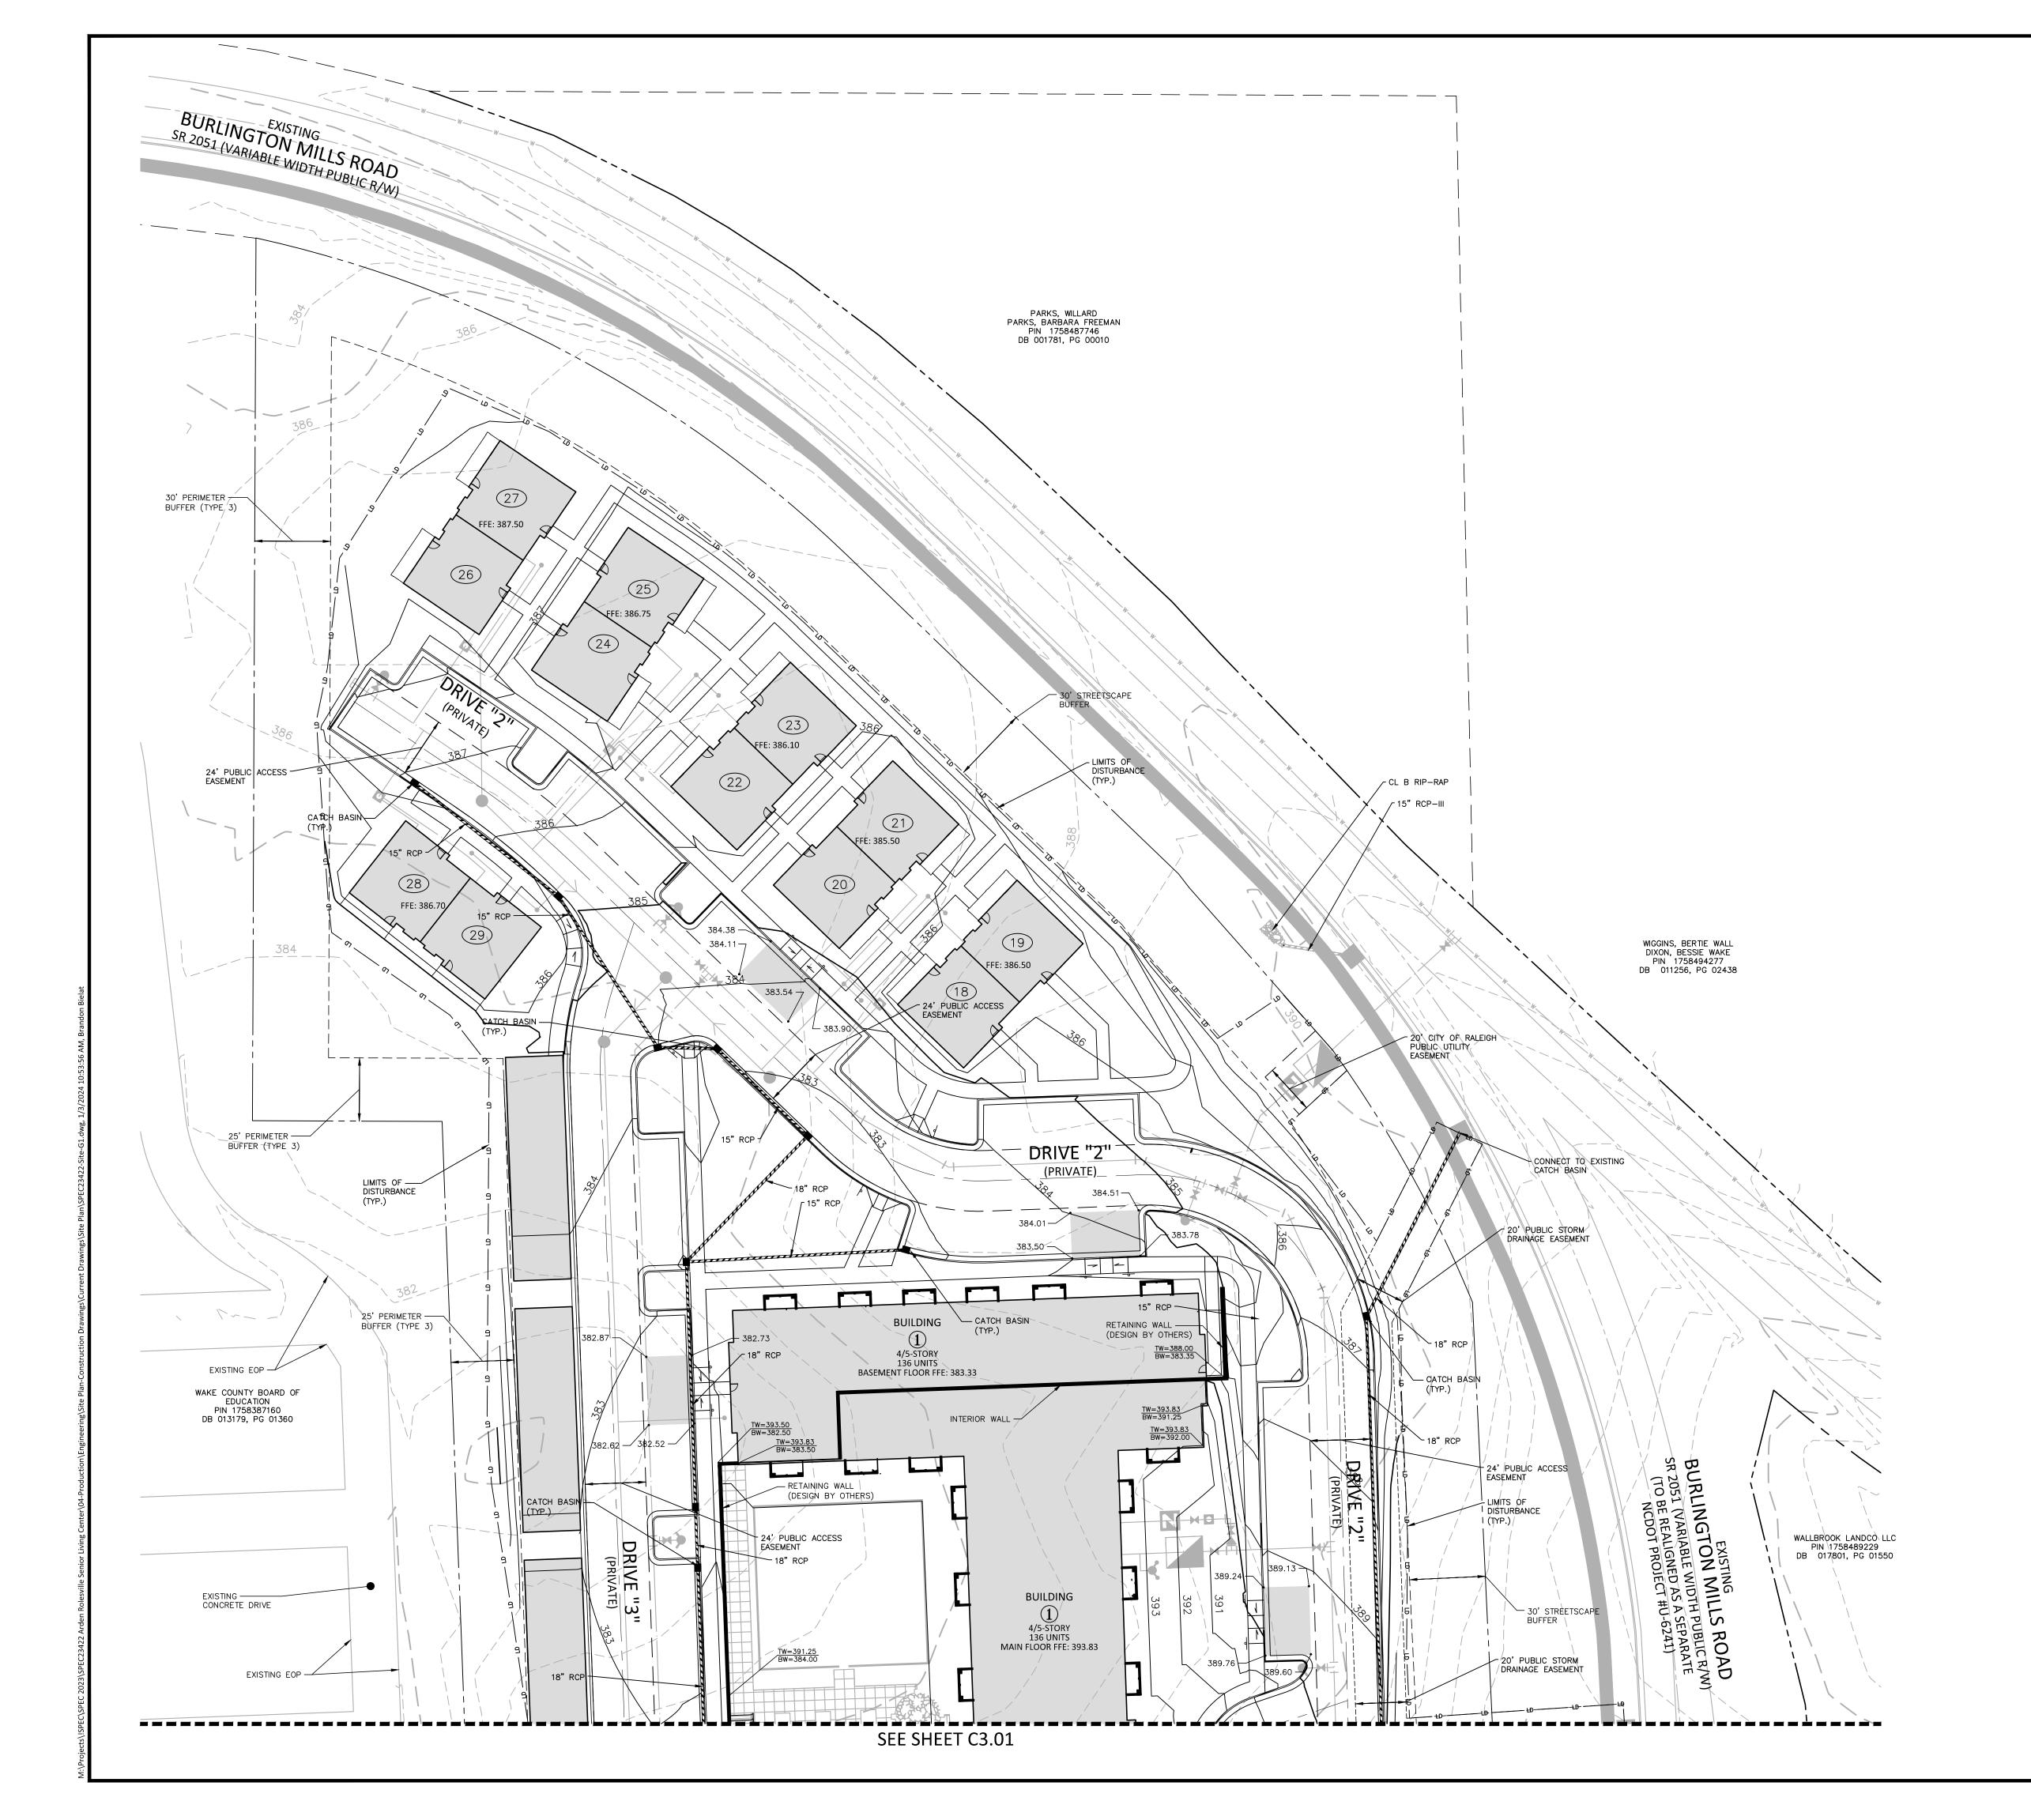
PROJECT NO. SPEC-23422 FILENAME SPEC23422-SITE-G1

CHECKED BY DRAWN BY

DATE 01. 03. 2024 SHEET

DRAINAGE PLAN - AREA "A"

GRADING AND STORM



GRADING LEGEND

FLARED END SECTION

ENDWALL SECTION CATCH BASIN

DROP INLET STORM SERVICE INLET STORM SERVICE ROOF-DRAIN JUNCTION BOX

DRAINAGE FLOW ARROW LINE BREAK SYMBOL TOP & BOTTOM CURB ELEVATIONS

TW=223.00 TOP OF WALL ELEVATION
BW=213.00 BOTTOM OF WALL ELEVATION

(NOTE: BOTTOM OF WALL IS GROUND ELEVATION NOT WALL FOUNDATION)

SPOT ELEVATION + 250.60 STORM DRAINAGE

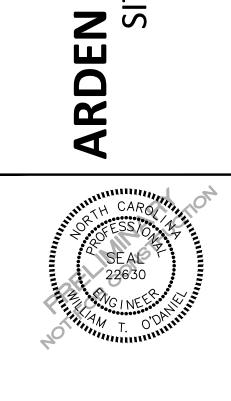
> ROOF DRAIN, 8" ADS NON-PERFORATED TUBING OR EQUAL 1.0% MIN. SLOPE 3' MIN.

COVER PVC SCHEDULE 40 IN TRAFFIC AREAS — TP — TP — TP — TREE PROTECTION FENCE

-----LD ------ LIMITS OF DISTURBANCE WOODED AREA

______250 ____ MAJOR CONTOUR ______ 252 MINOR CONTOUR EXISTING MAJOR CONTOUR 252 EXISTING MINOR CONTOUR — — — EASEMENT LINE

> ACCESSIBLE PARKING AREA (2% MAX. SLOPE IN ALL DIRECTIONS)



REVISIONS

NO. DATE

PLAN INFORMATION

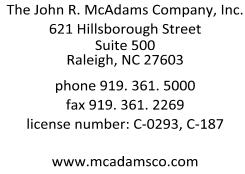
PROJECT NO. SPEC-23422 FILENAME CHECKED BY

DRAWN BY SCALE 1"=30'

SHEET **GRADING AND STORM**

C3.02

PRELIMINARY DRAWING - NOT RELEASED FOR CONSTRUCTION



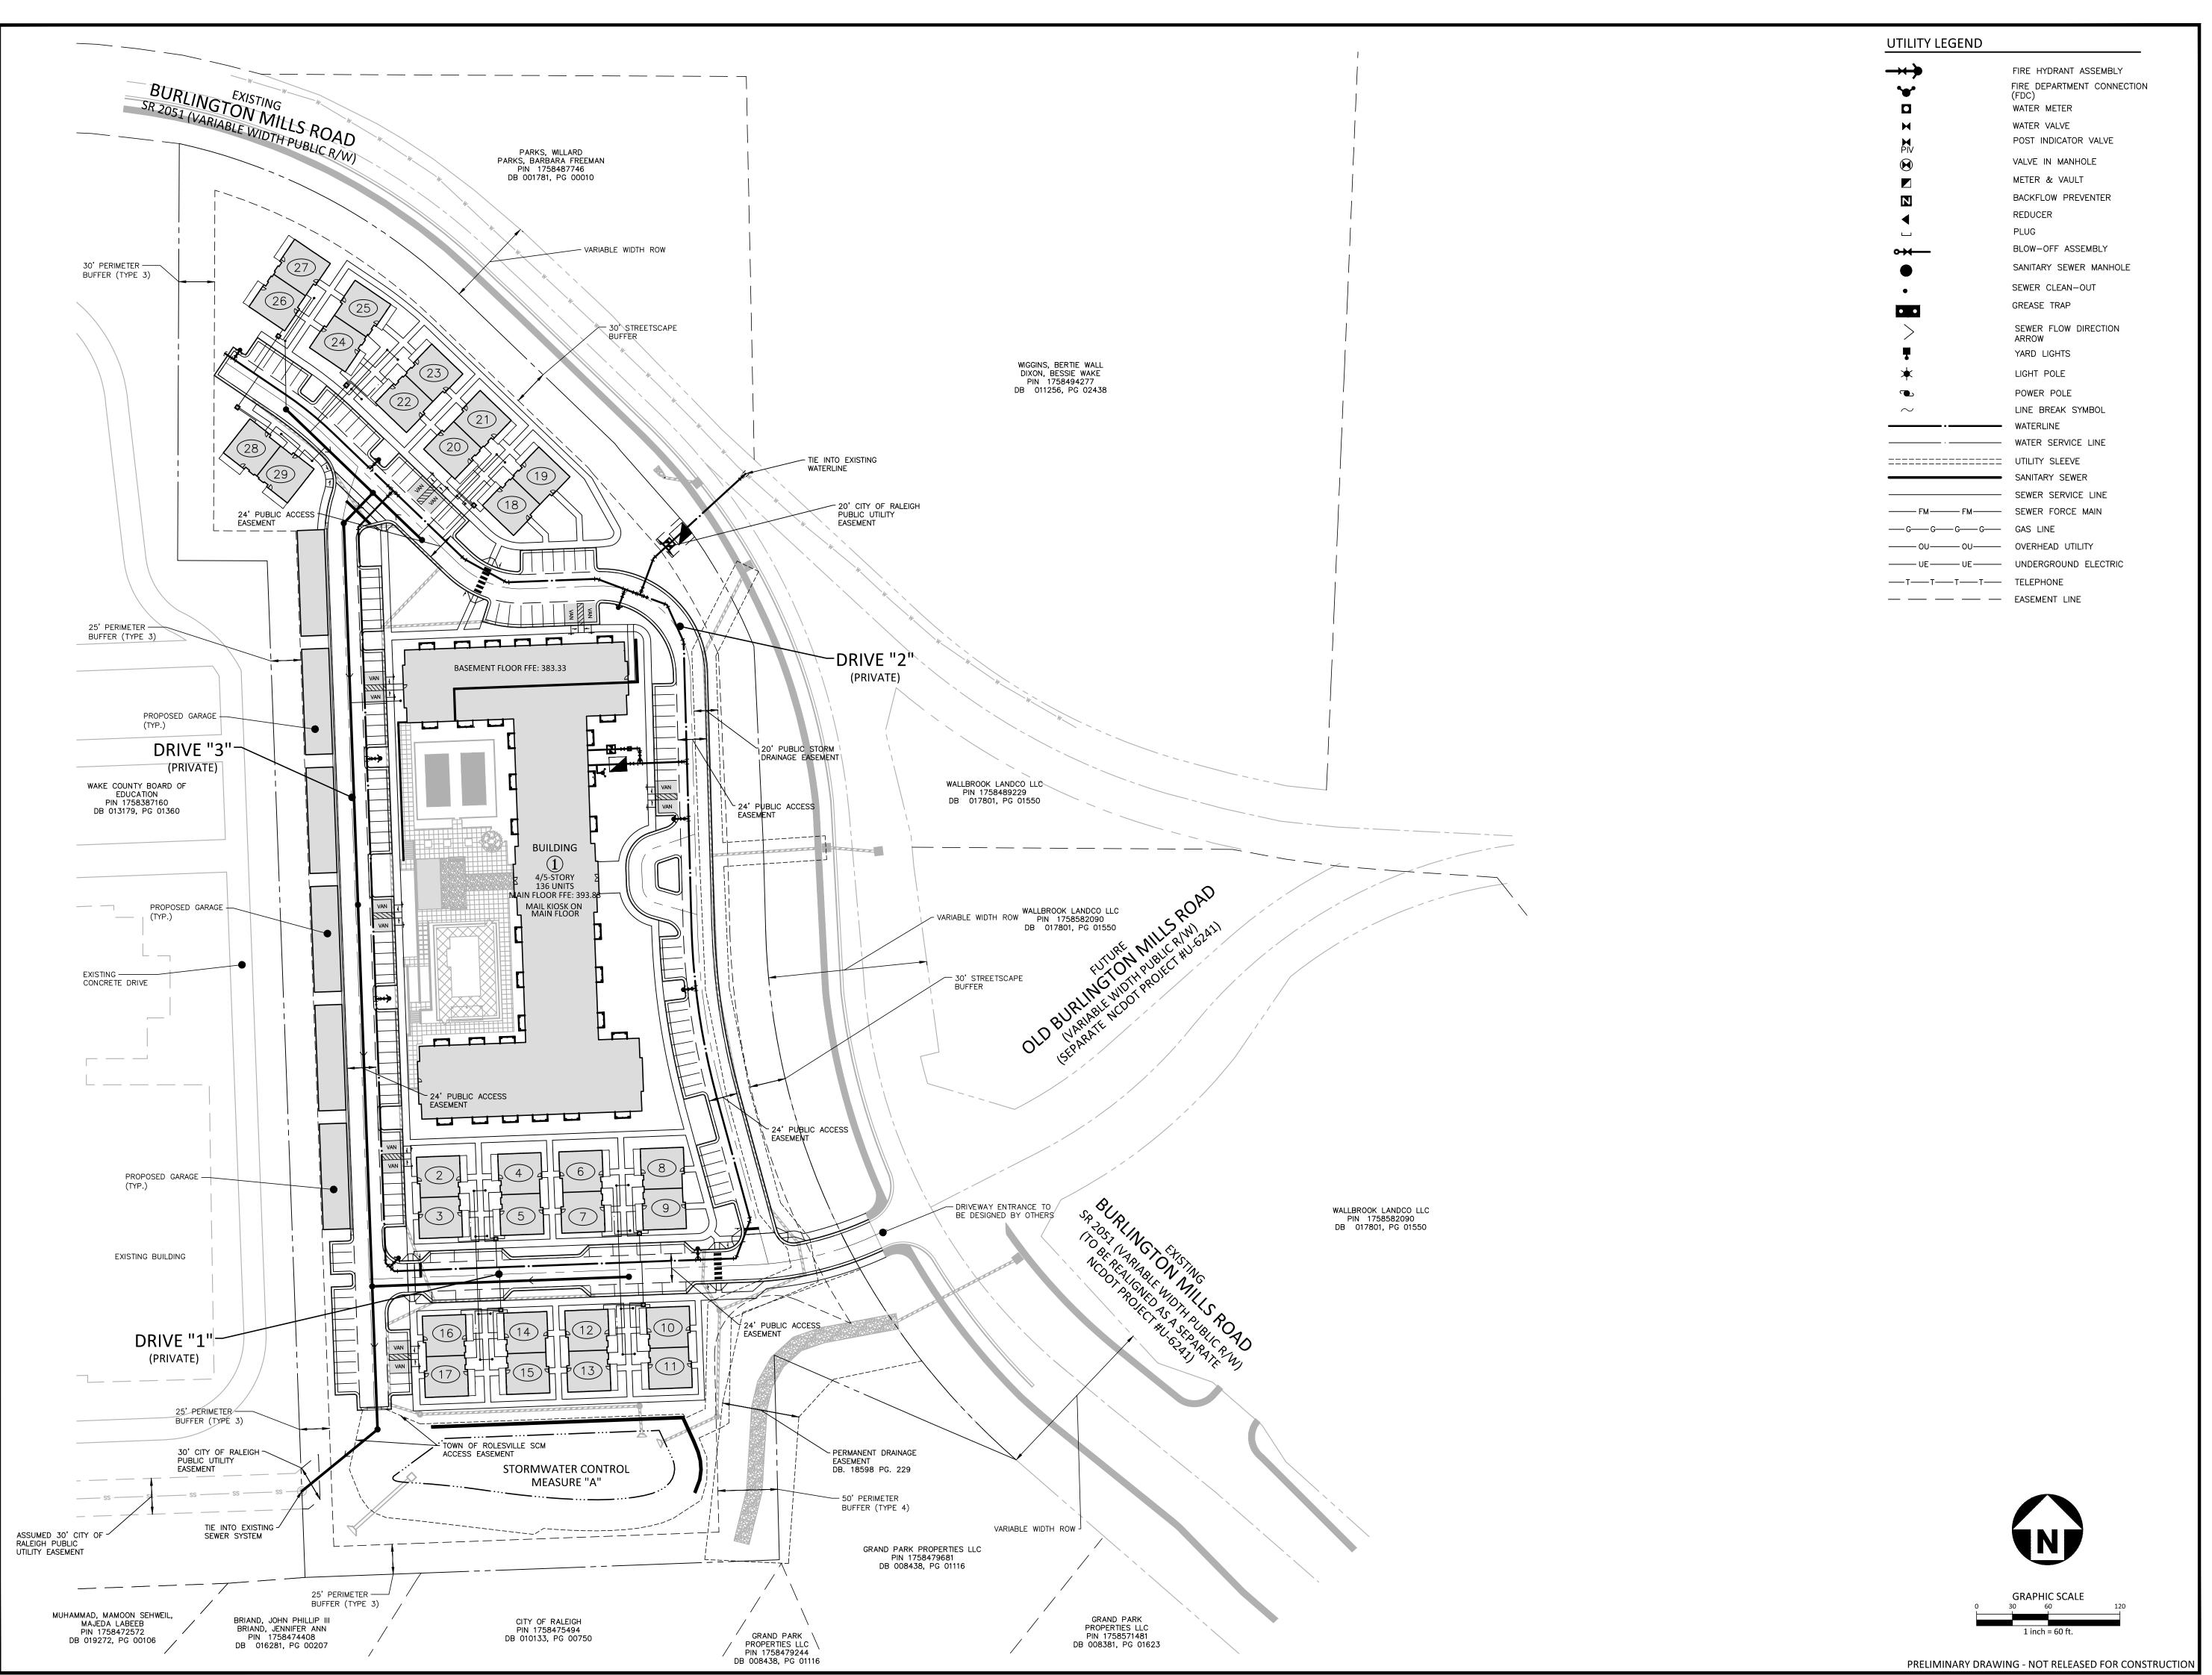
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BUVERMO INVESTMENTS, INC 7315 WISCONSIN AVENUE SUITE 925W BETHESDA, MARYLAND, 20814

SPEC23422-SITE-G1

DATE 01. 03. 2024

DRAINAGE PLAN - AREA "B"





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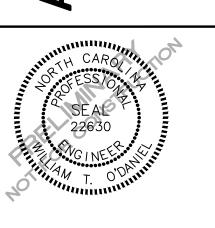
license number: C-0293, C-187

CLIENT

BUVERMO INVESTMENTS, INC 7315 WISCONSIN AVENUE SUITE 925W BETHESDA, MARYLAND, 20814

~

ARDEN SENIOR LIVING CENTER
SITE DEVELOPMENT PLAN
ROLESVILLE, NORTH CAROLINA



REVISIONS

NO. DATE

PLAN INFORMATION

PROJECT NO. SPEC-23422

FILENAME SPEC23422-SITE-OAU1

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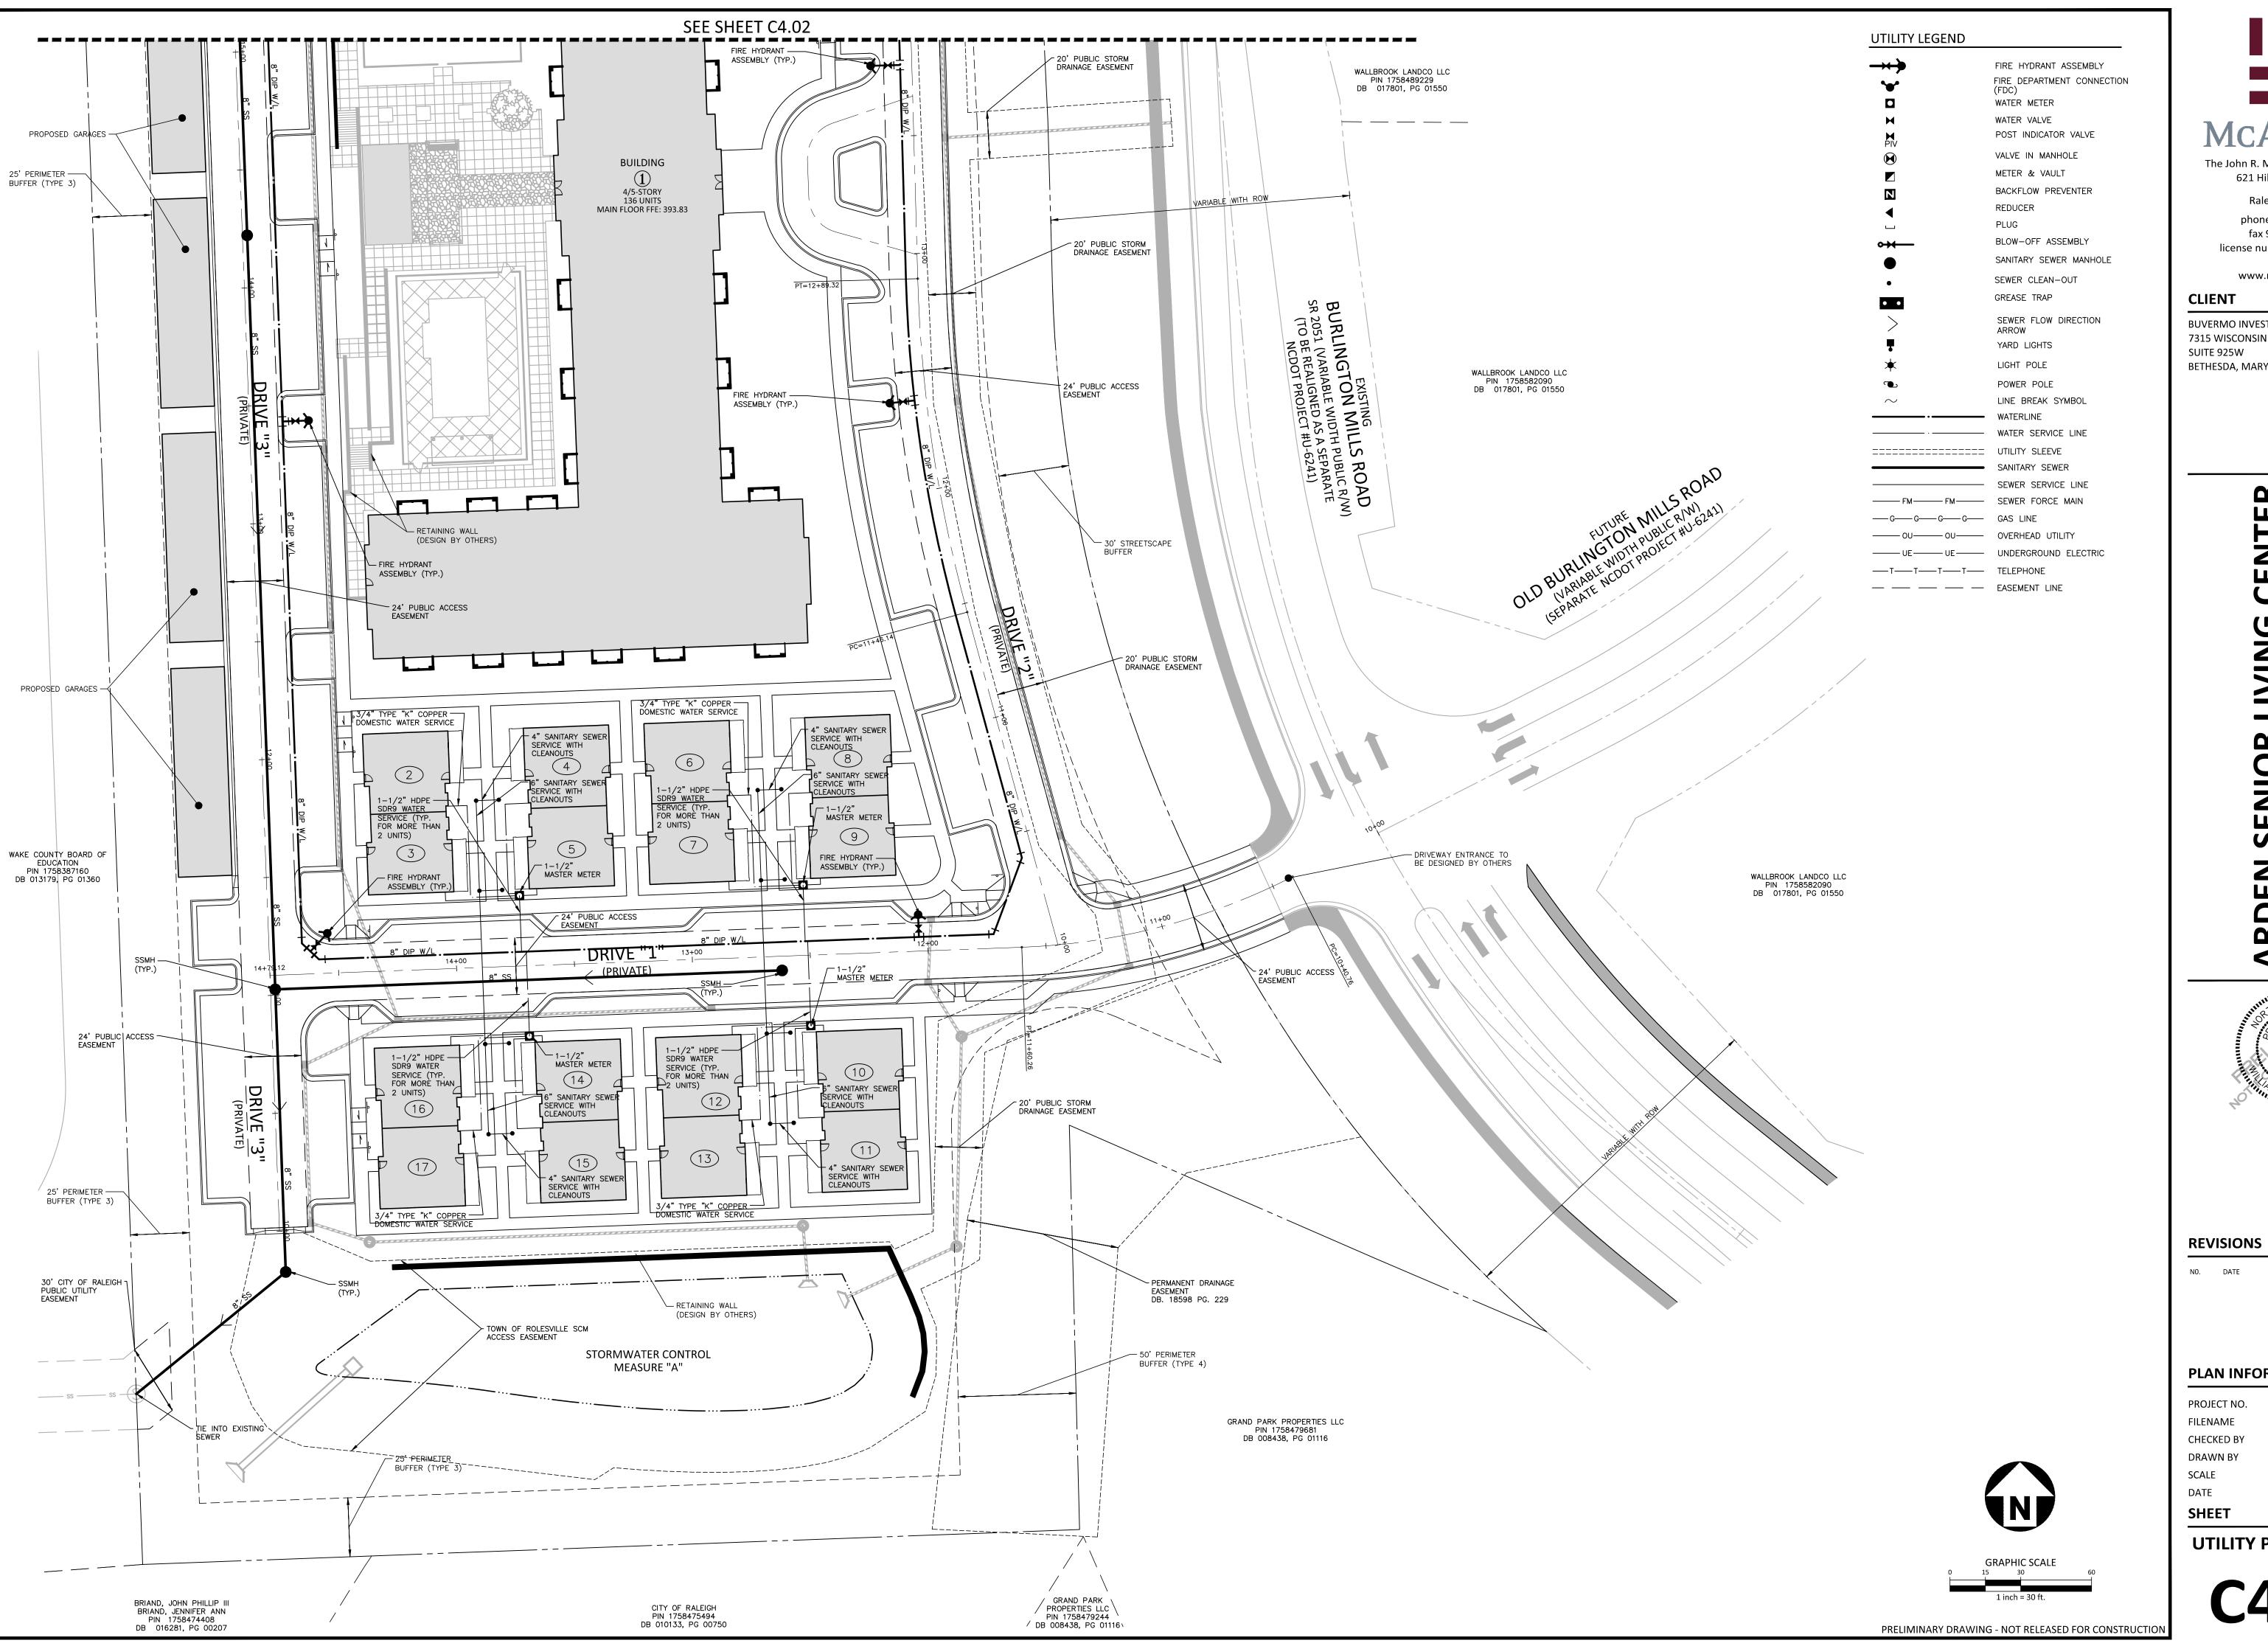
SCALE 1"=60'

DATE 01. 03. 2024

SHEET

OVERALL UTILITY PLAN

C4.00





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> phone 919. 361. 5000 fax 919. 361. 2269

license number: C-0293, C-187

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CLIENT

7315 WISCONSIN AVENUE

BUVERMO INVESTMENTS, INC

SUITE 925W BETHESDA, MARYLAND, 20814

ARDEN

PLAN INFORMATION

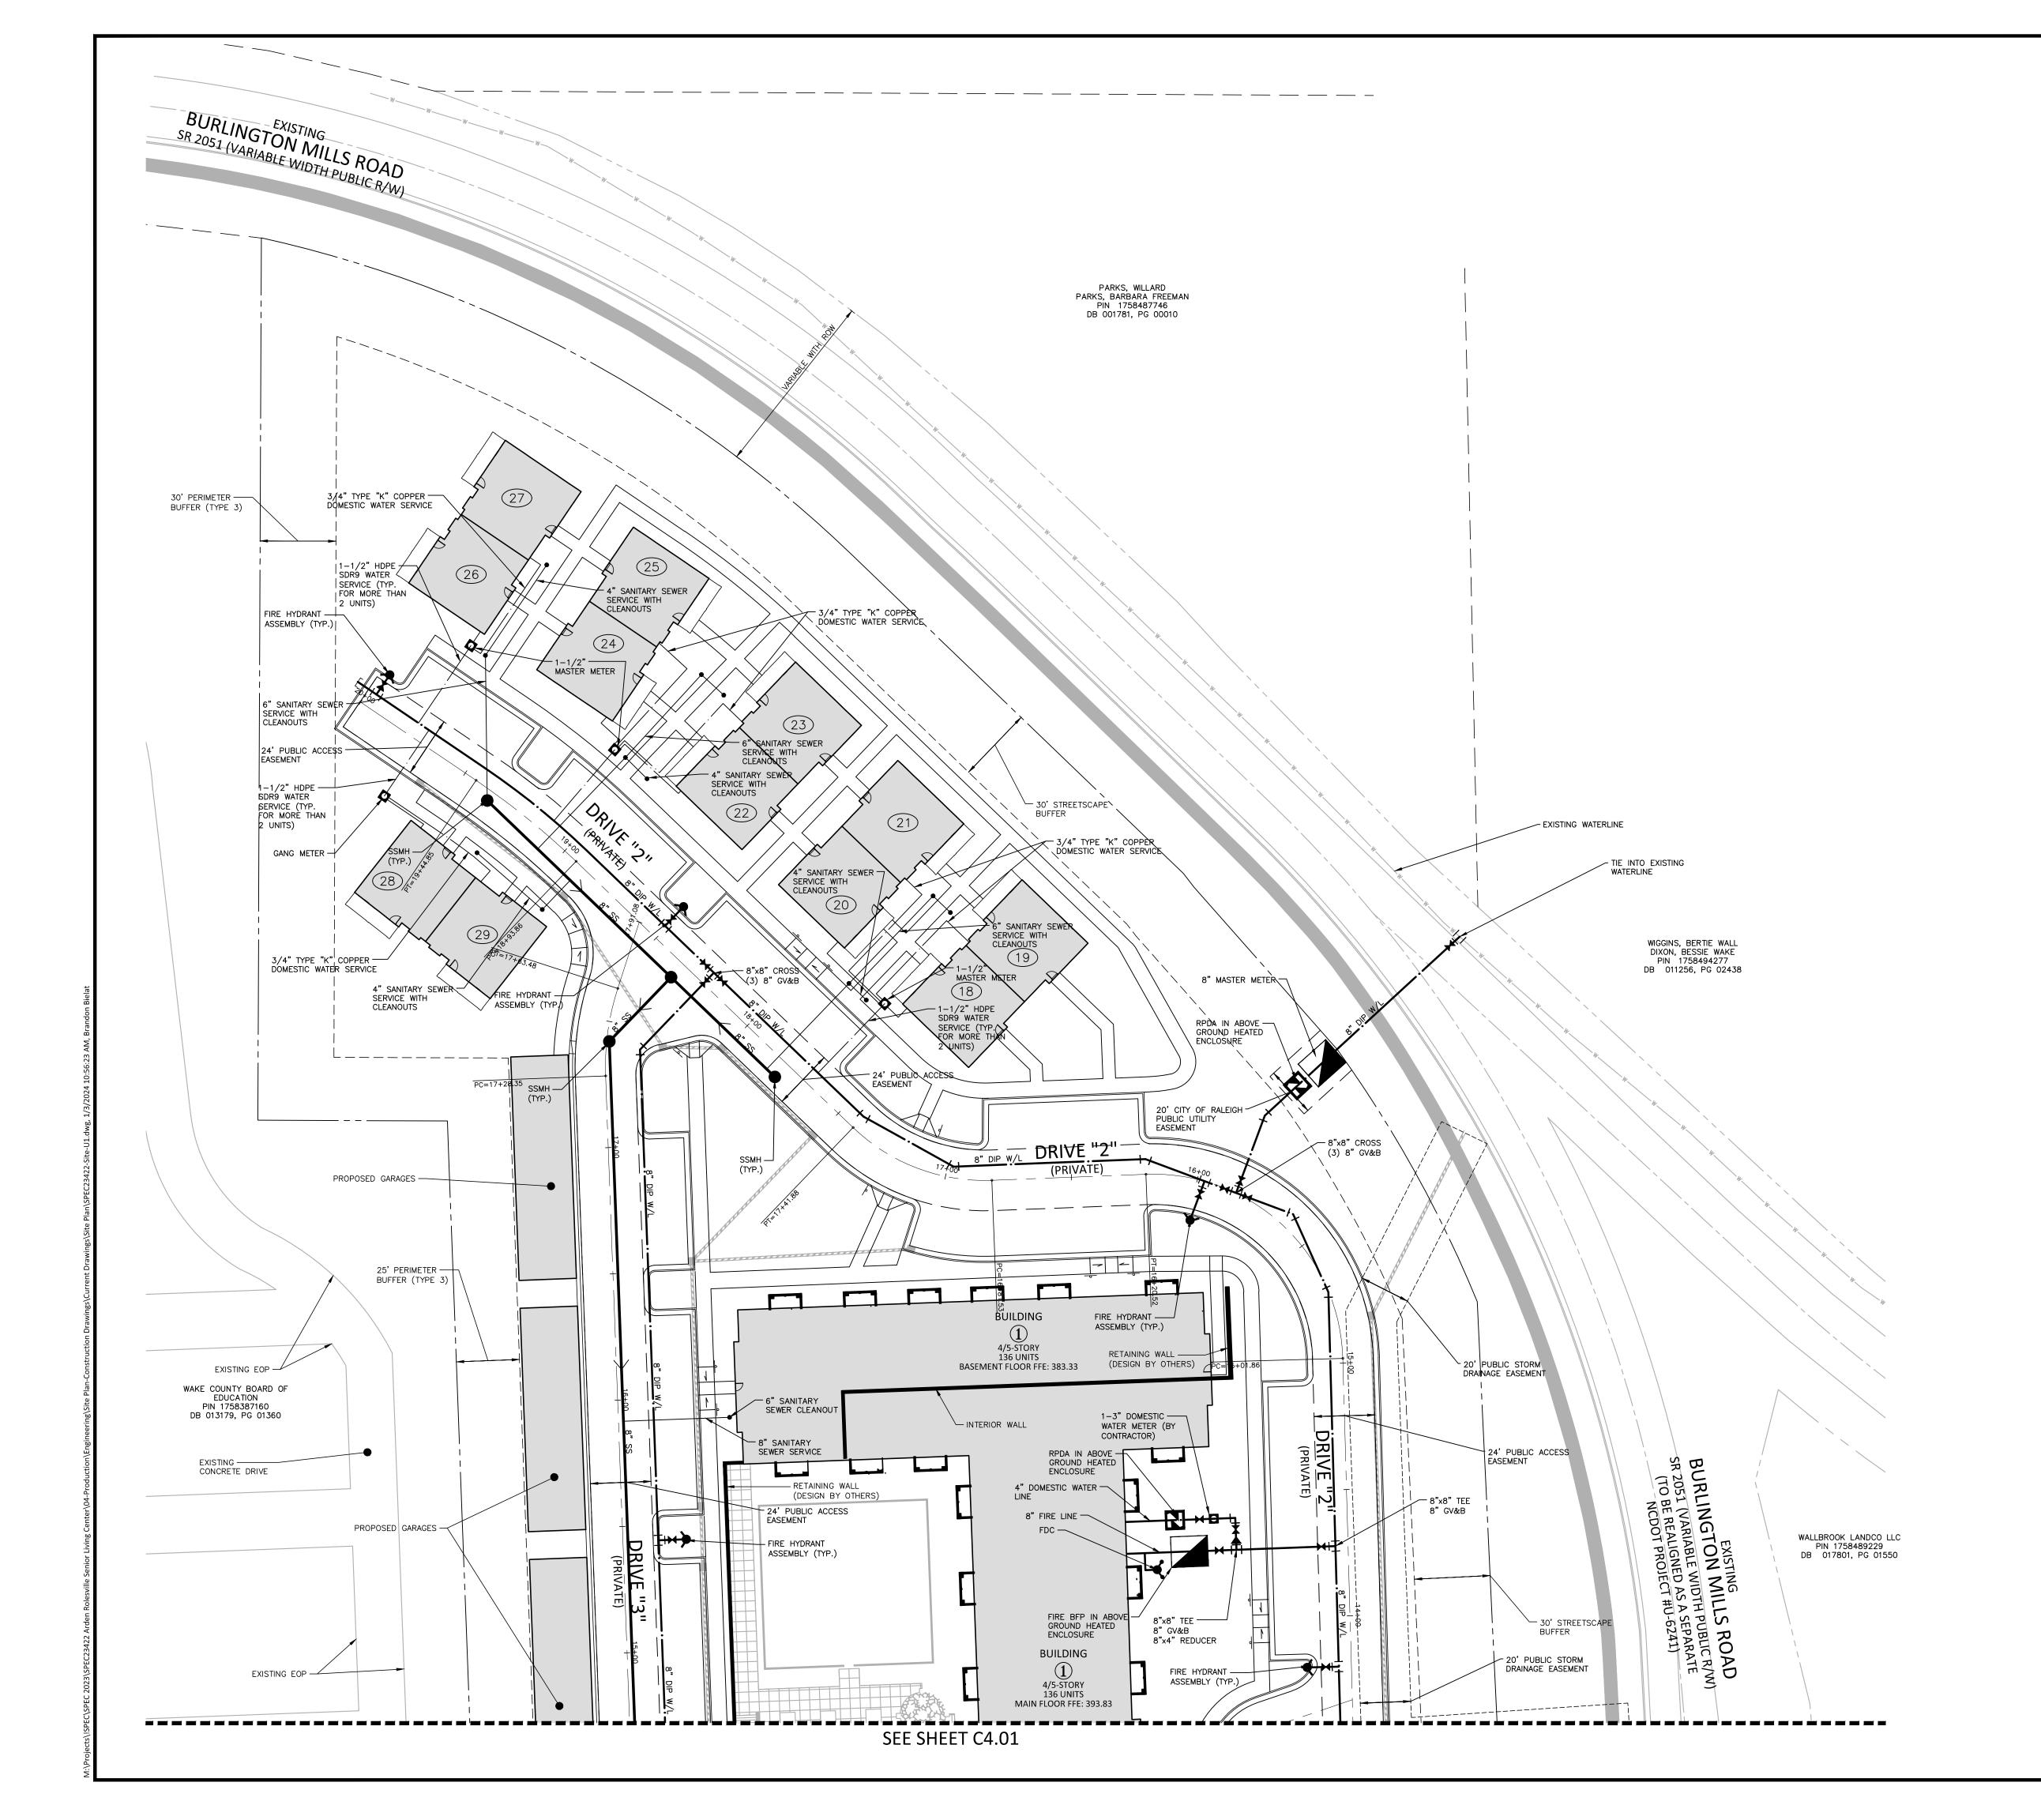
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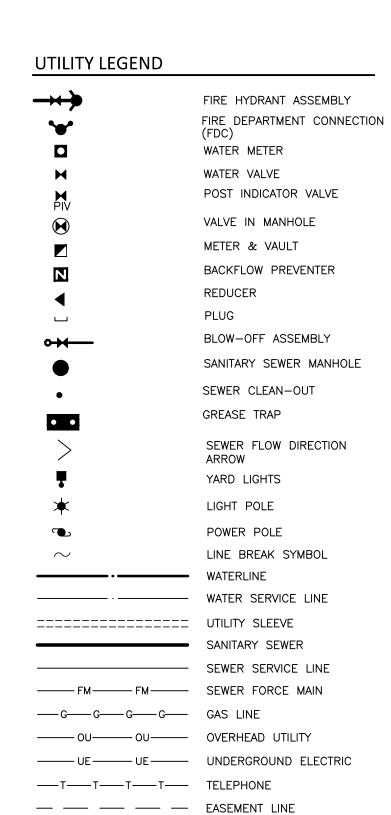
SPEC23422-SITE-U1 FILENAME CHECKED BY

SCALE 1"=30' DATE 01. 03. 2024

SHEET **UTILITY PLAN AREA "A"**

C4.01







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Raleigh, NC 27603 phone 919. 361. 5000 fax 919. 361. 2269

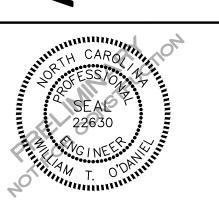
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license number: C-0293, C-187

CLIENT

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ARDEN



REVISIONS

NO. DATE

PLAN INFORMATION

PROJECT NO. SPEC-23422 SPEC23422-SITE-U1 FILENAME CHECKED BY

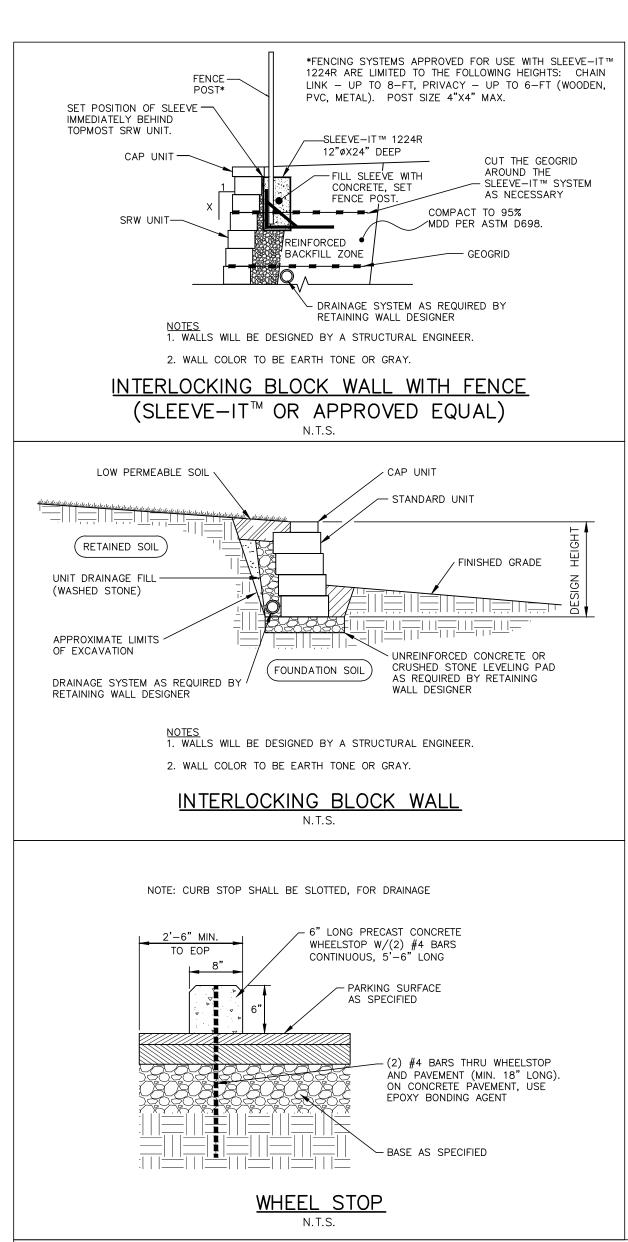
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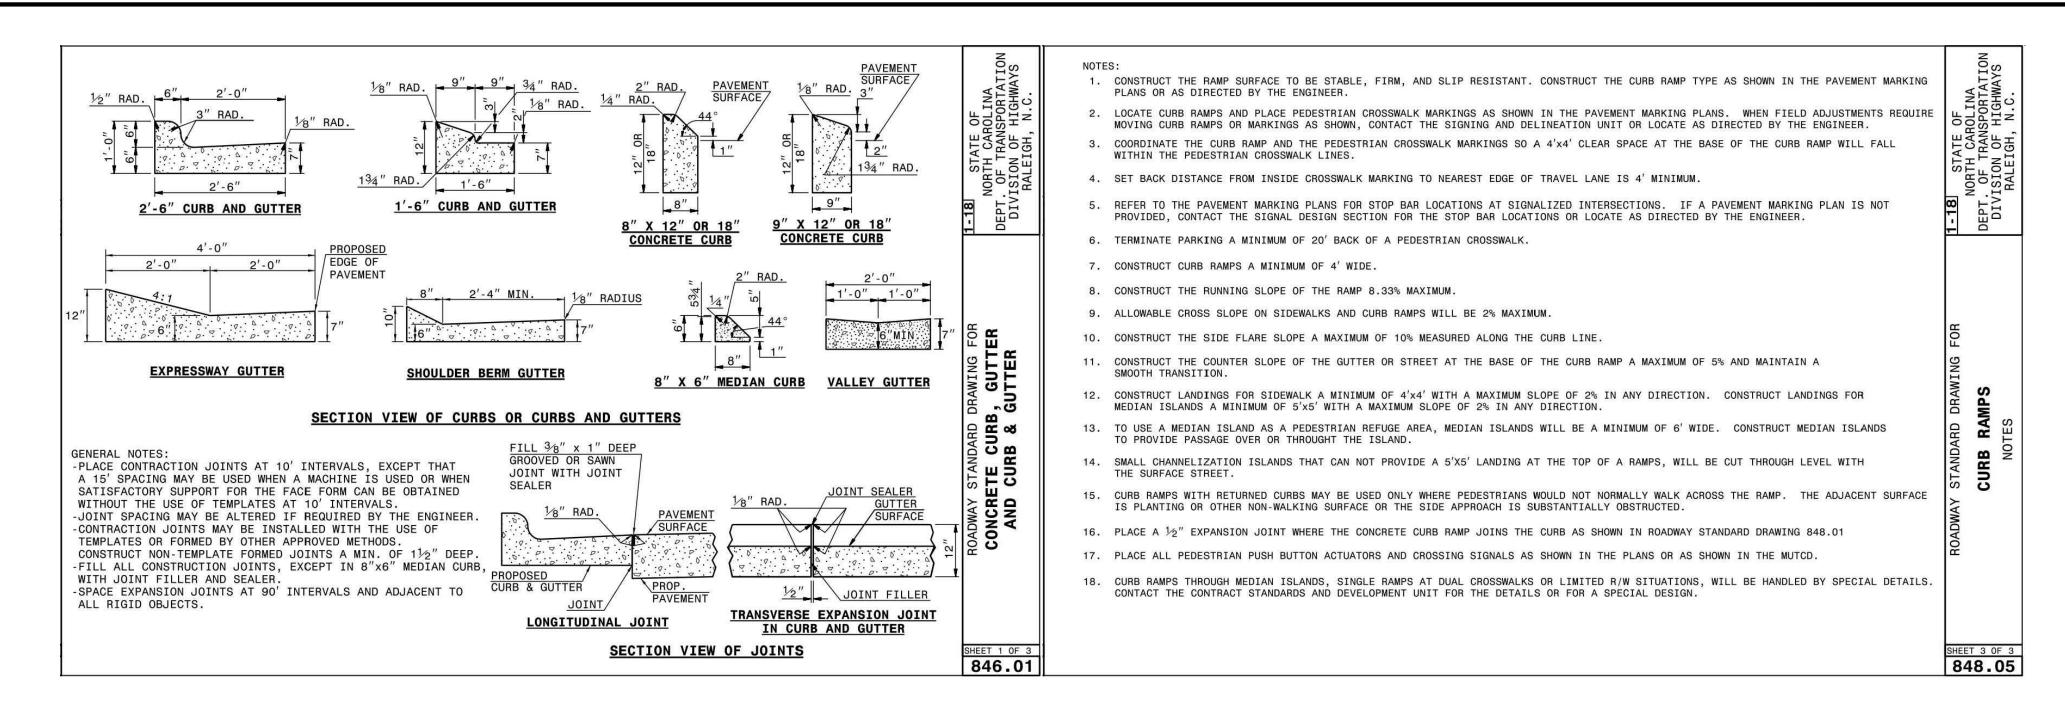
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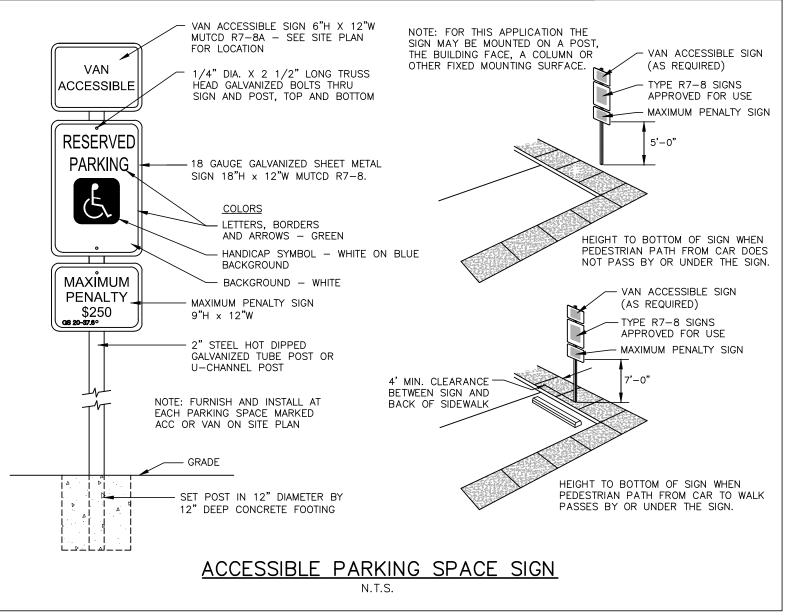
UTILITY PLAN AREA "B"

C4.02

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fax 919. 361. 2269 license number: C-0293, C-187

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CLIENIT

CLIENT

BUVERMO INVESTMENTS, INC 7315 WISCONSIN AVENUE SUITE 925W BETHESDA, MARYLAND, 20814

LIVING CENTER MENT PLAN

CAROLLAND SEAL PLANTS AND TO THE CONTRACT OF T

RDE

REVISIONS

NO. DATE

PLAN INFORMATION

PROJECT NO. SPEC-23422
FILENAME SPEC23422-D1
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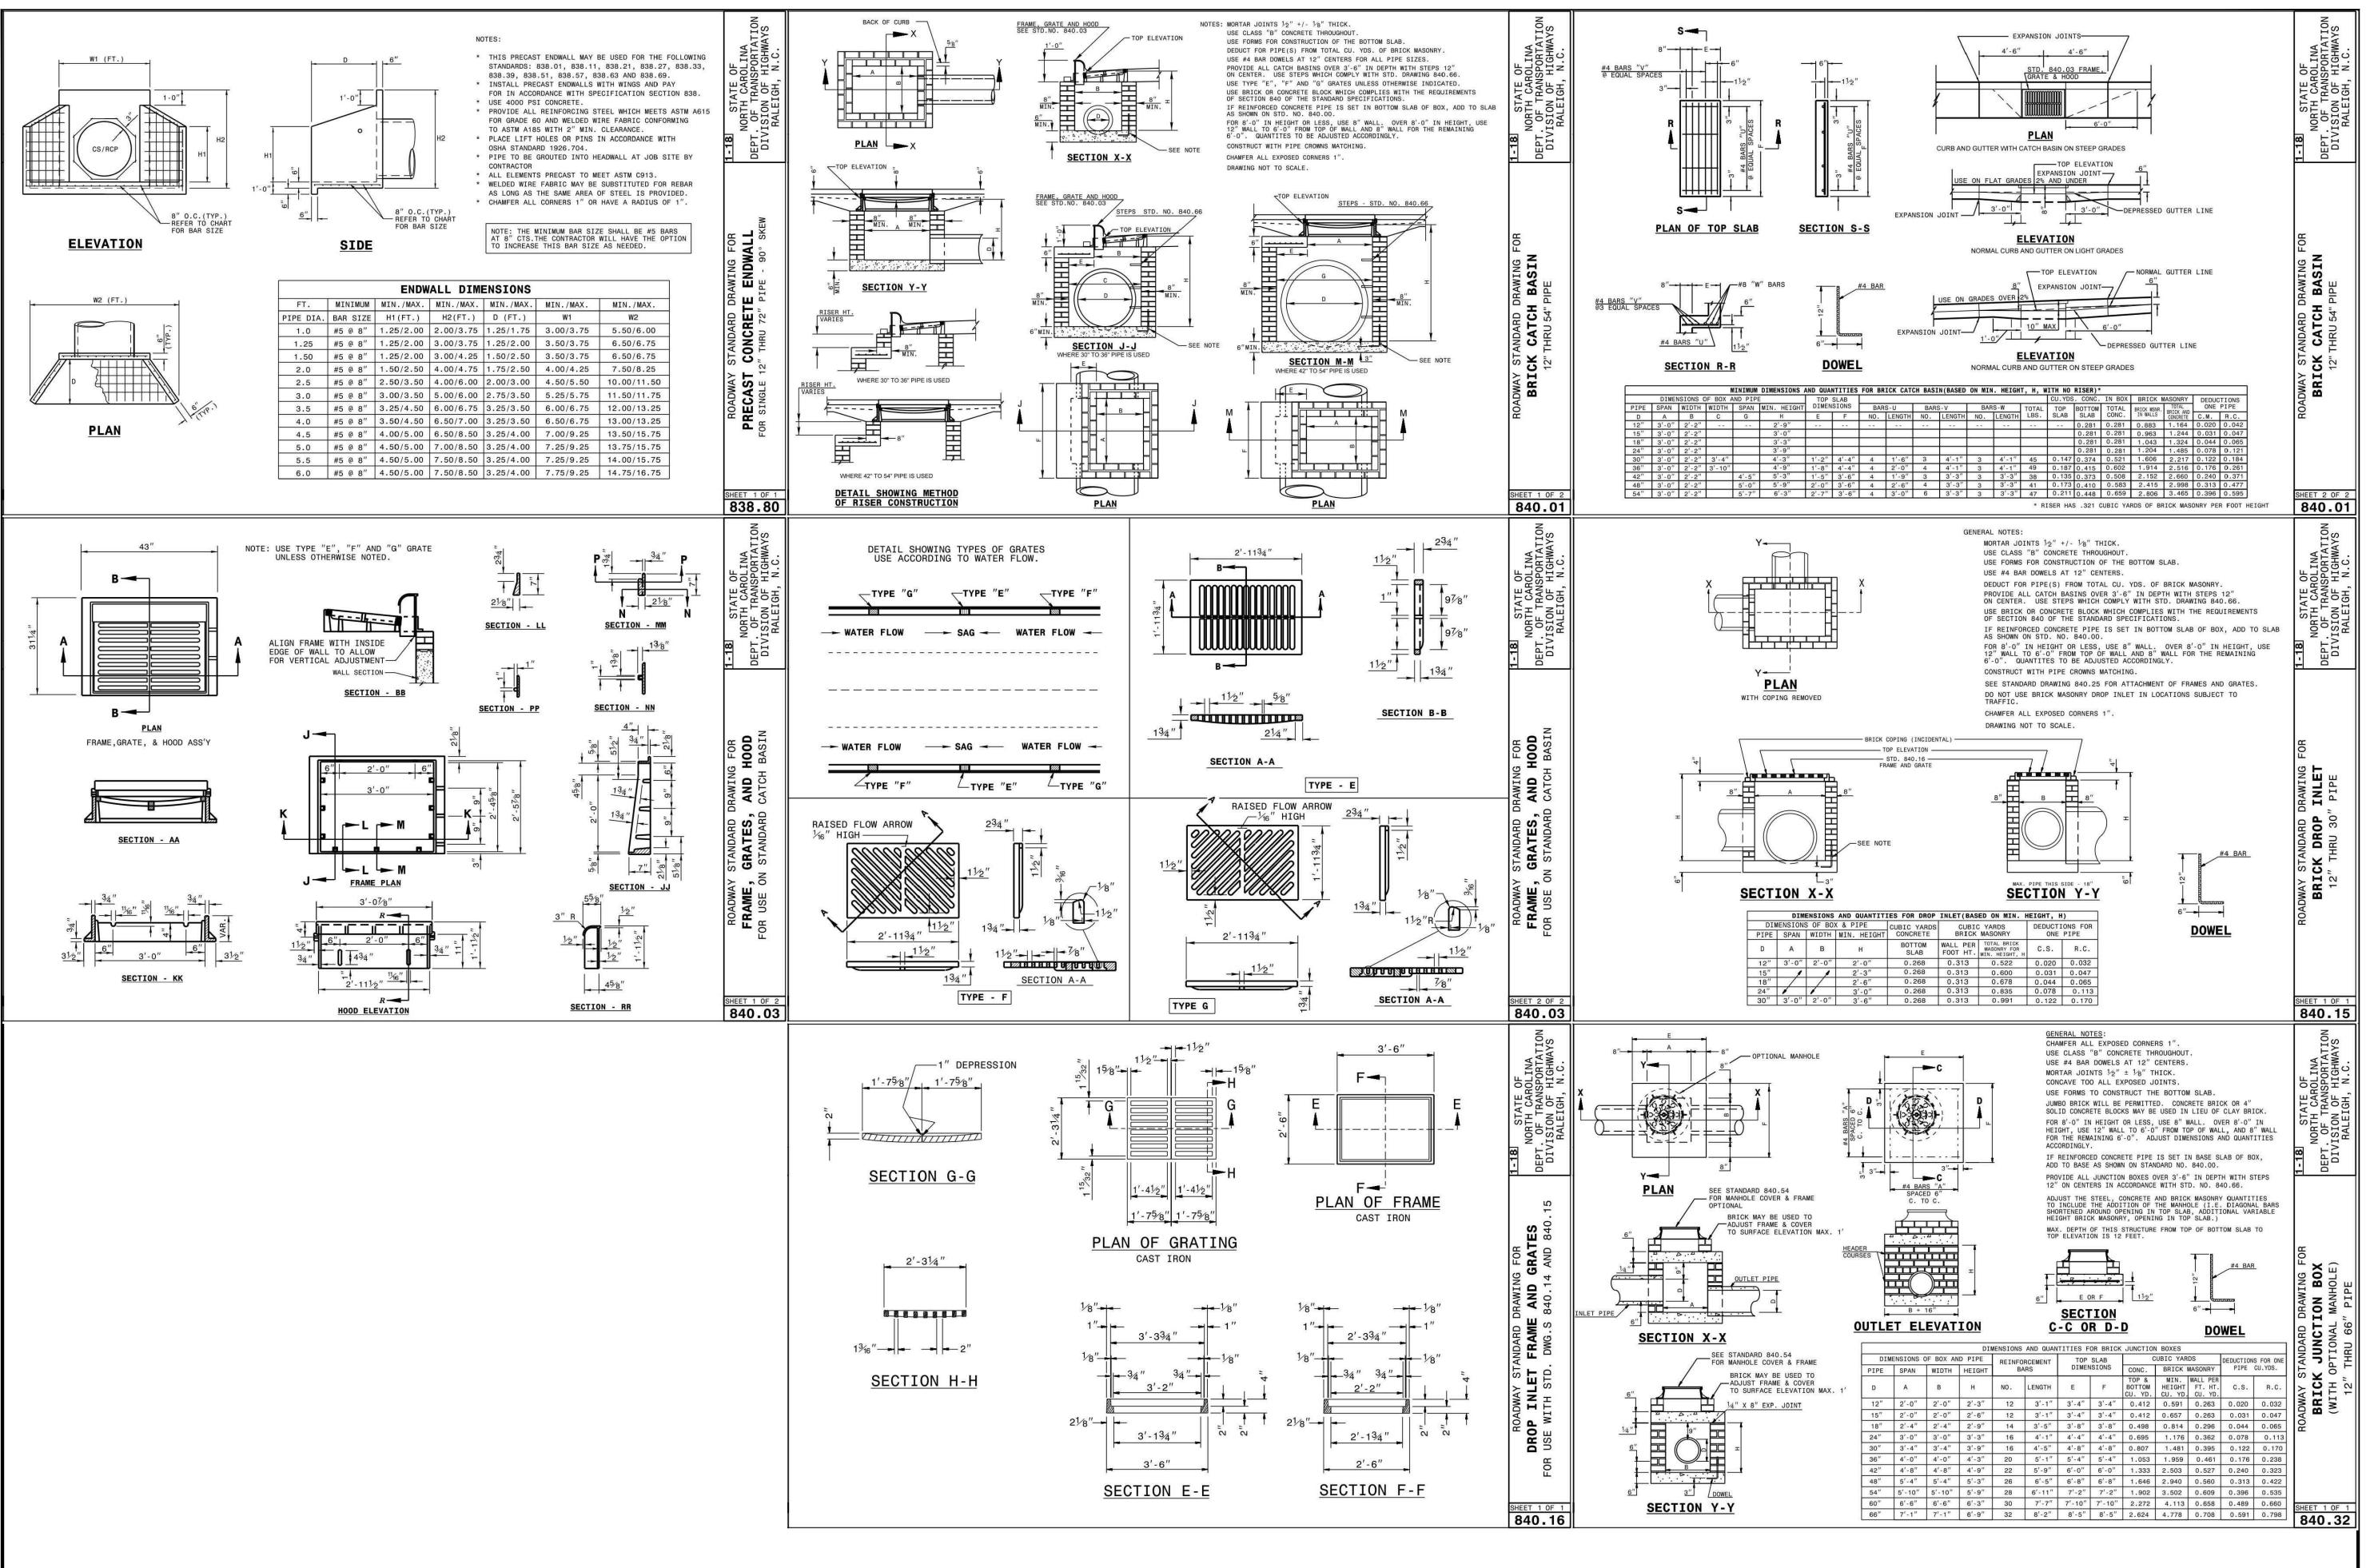
SCALE
DATE
SHEET

SITE DETAILS

N.T.S.

01. 03. 2024

C8.00





McAdams

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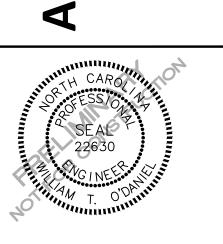
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ENIOR LIVING CENTE DEVELOPMENT PLAN



RDE

REVISIONS

NO. DATE

PLAN INFORMATION

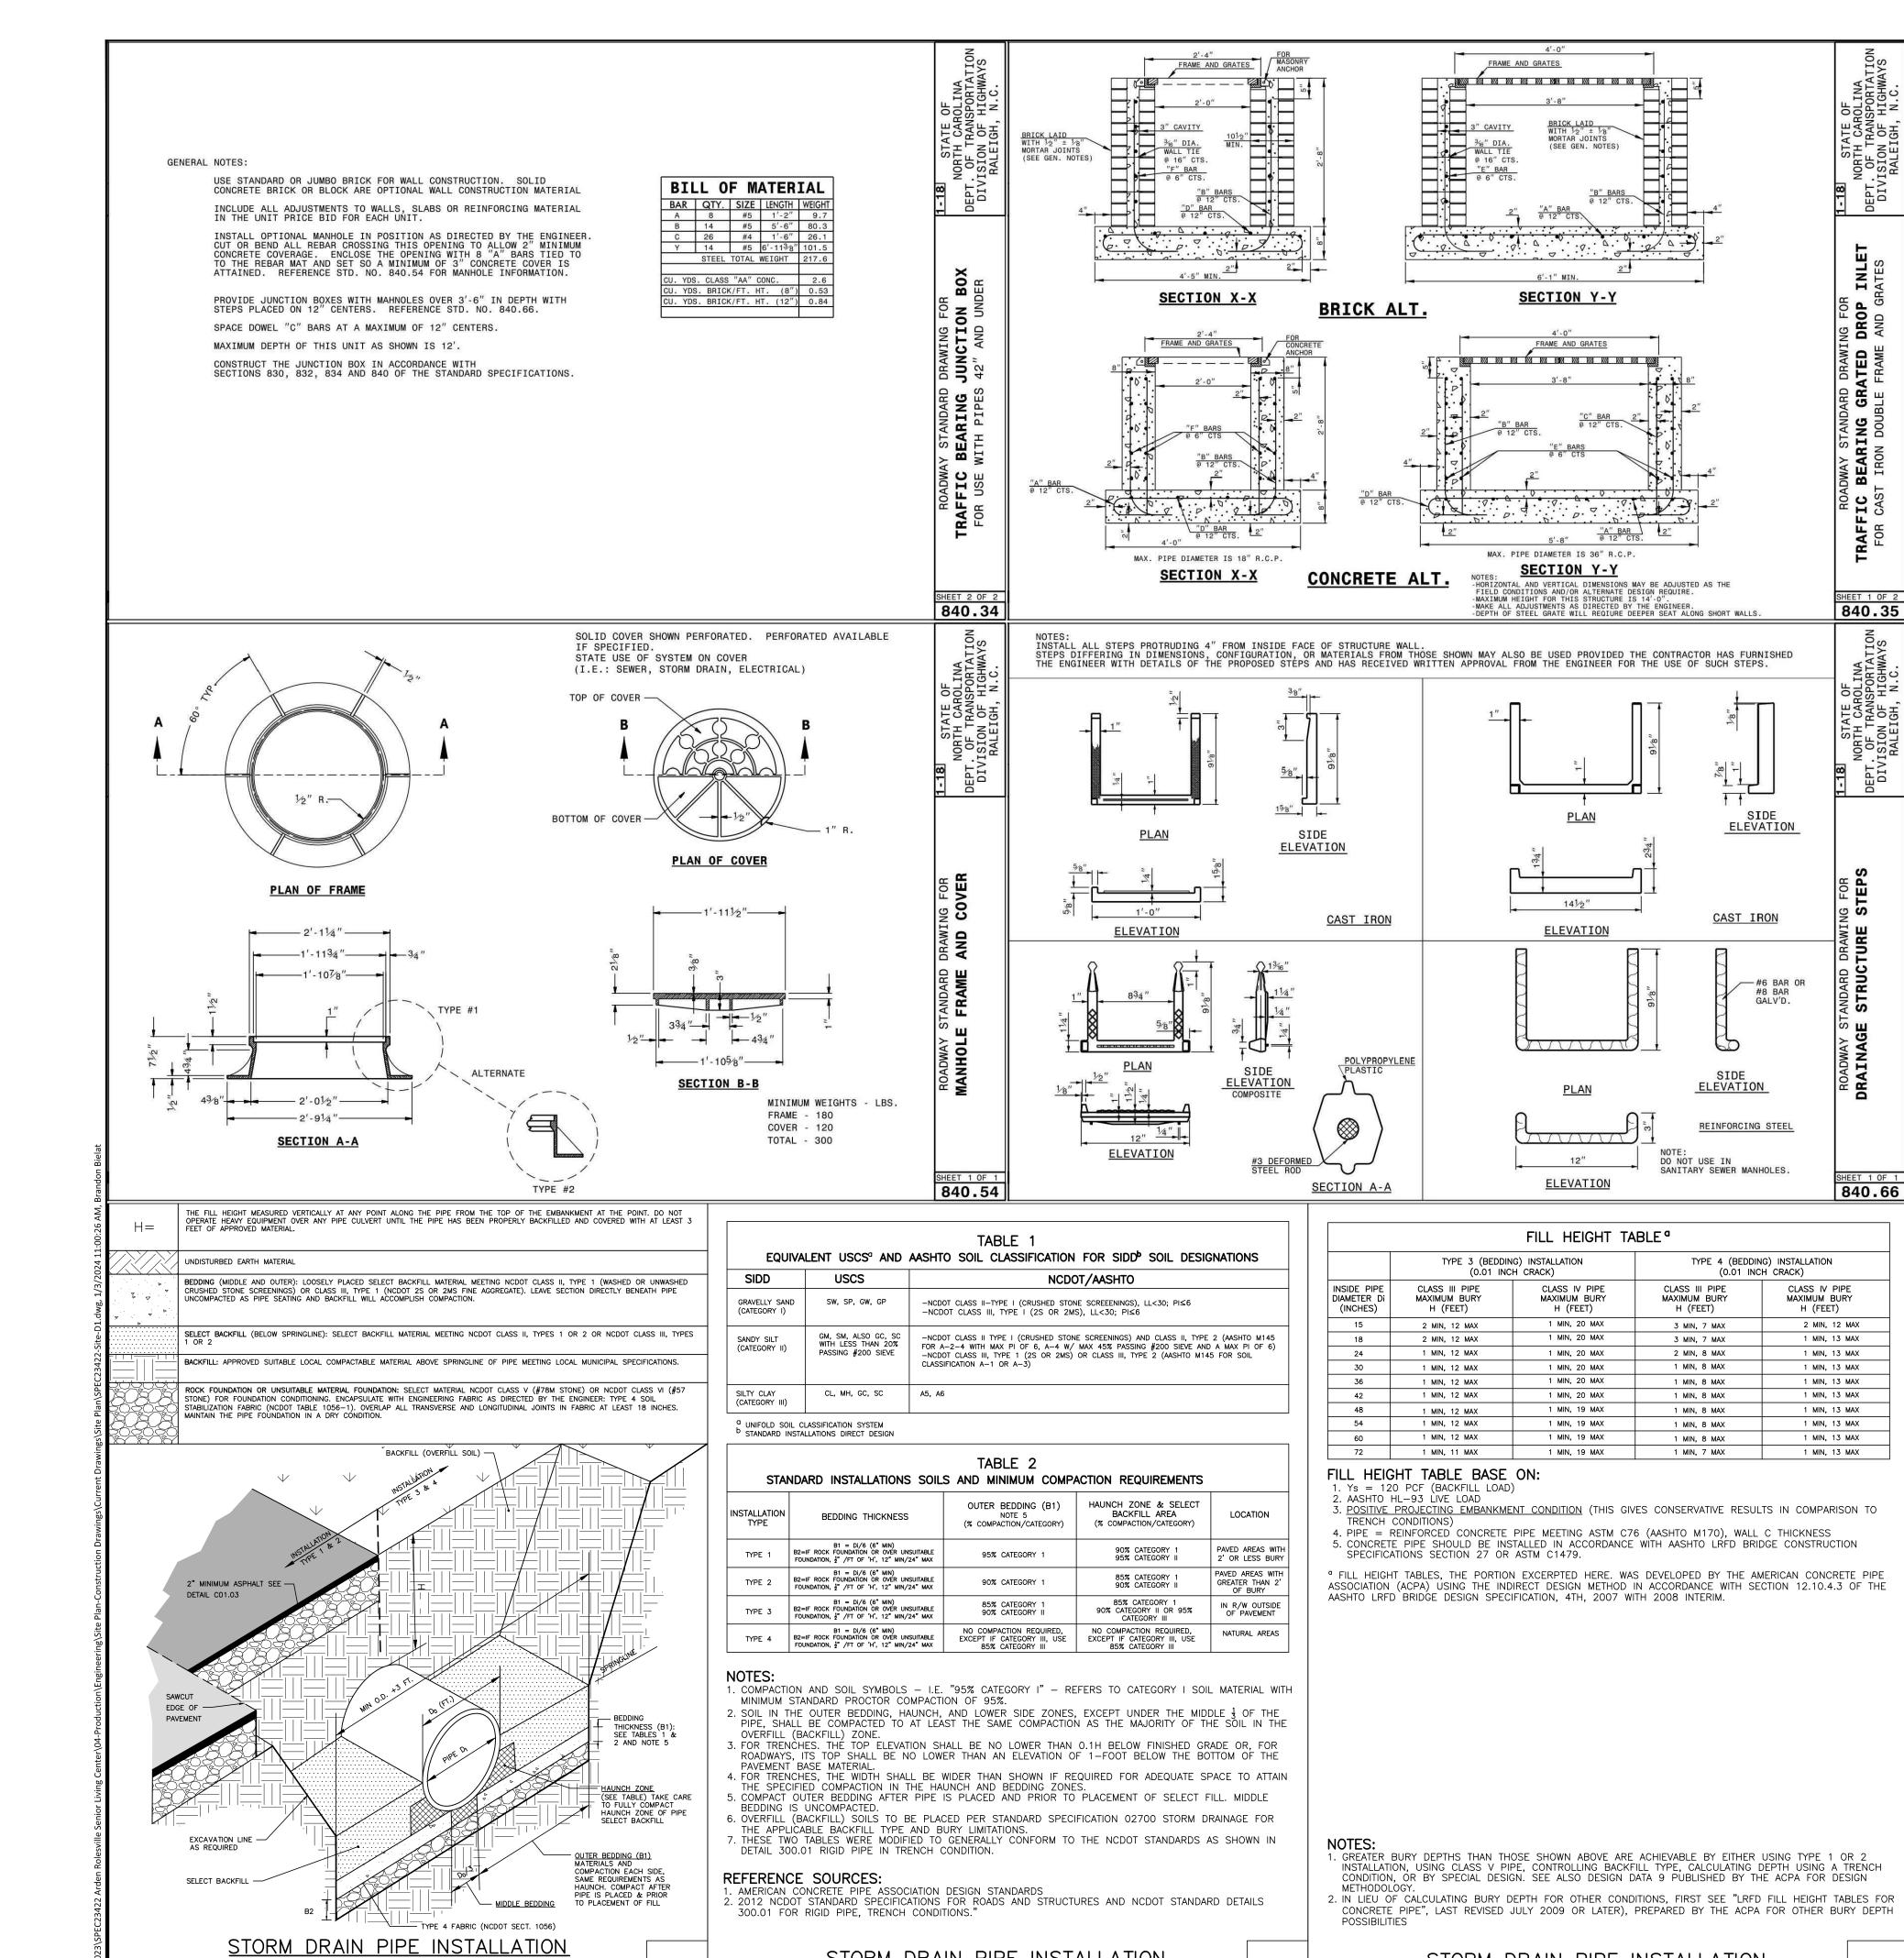
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FILENAME SPEC23422-D1
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DATE
SHEET

STORM DRAINAGE

C8.01

01. 03. 2024



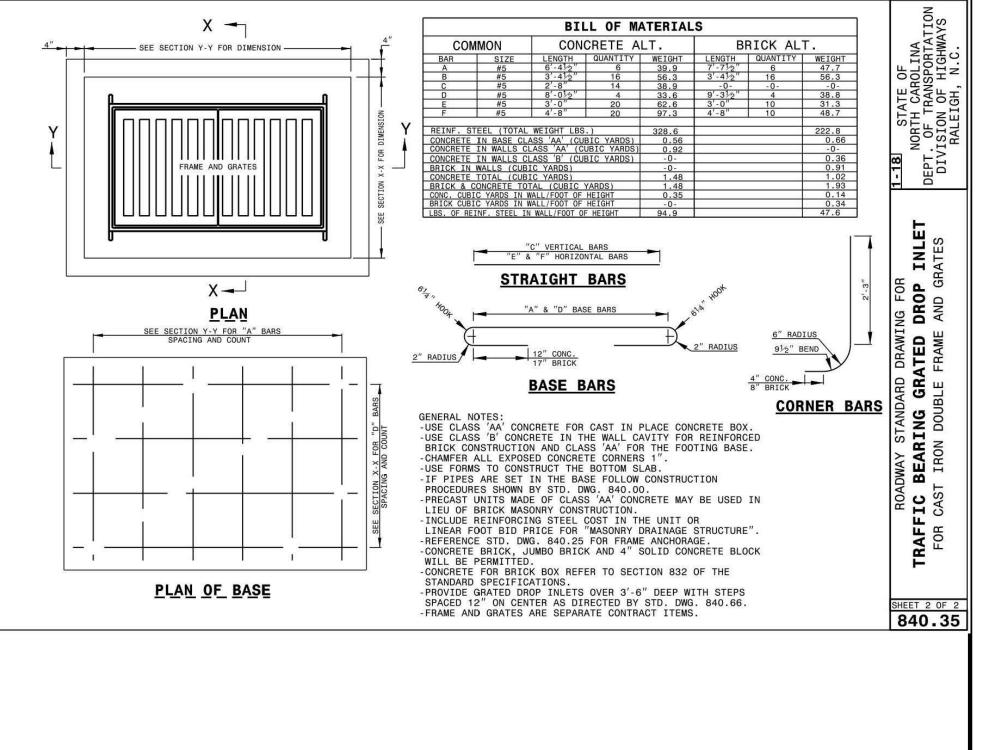
STORM DRAIN PIPE INSTALLATION

2 OF 3

1 OF 3

STORM DRAIN PIPE INSTALLATION

3 OF 3



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4

REVISIONS

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PLAN INFORMATION

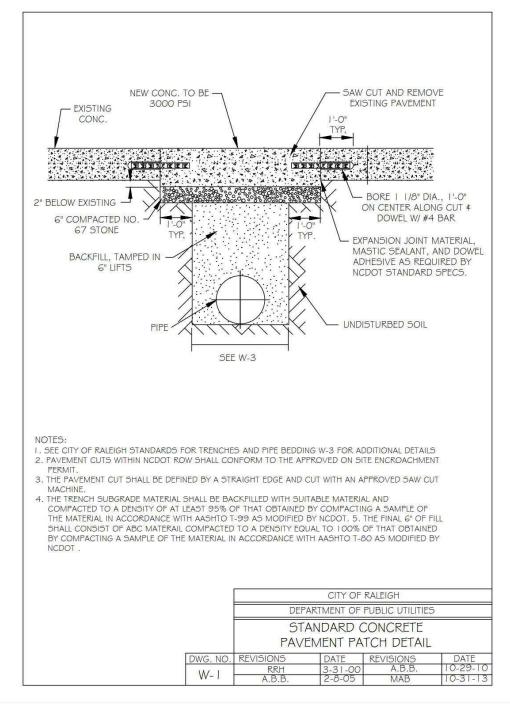
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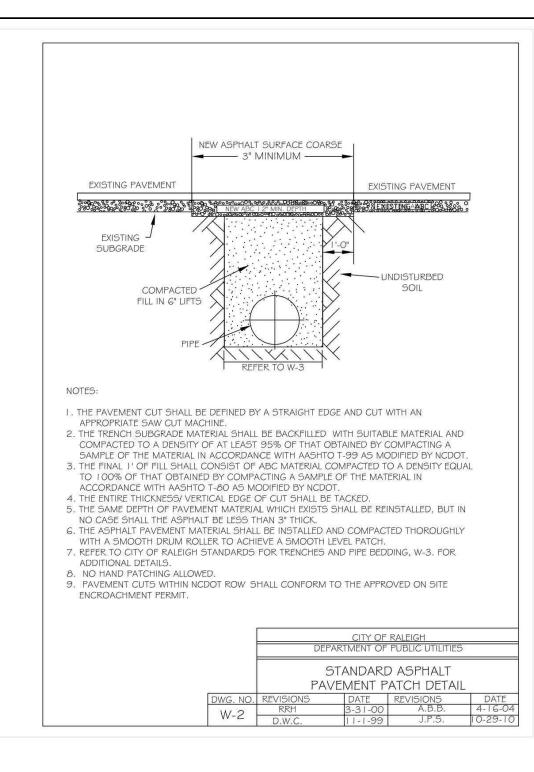
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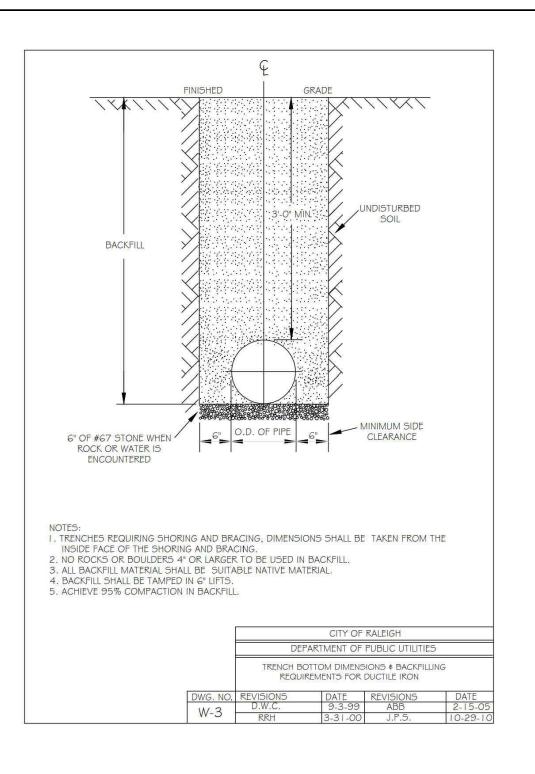
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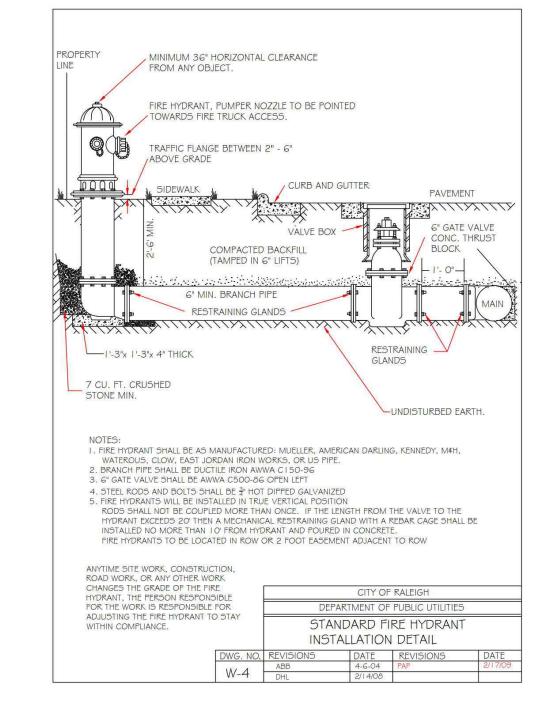
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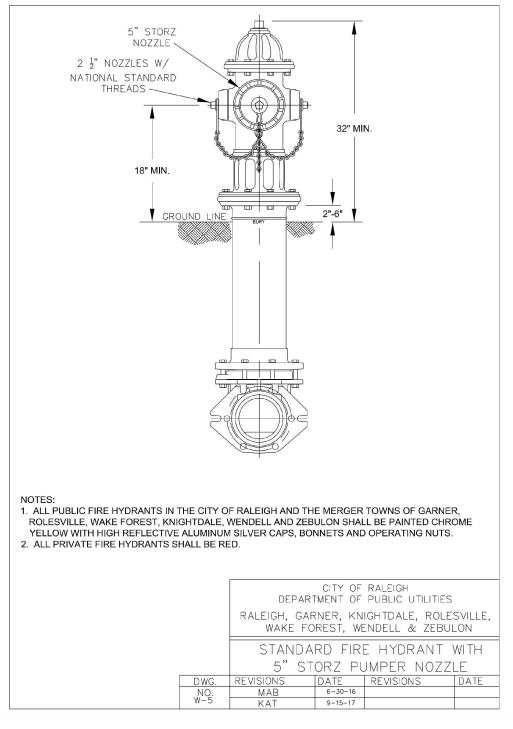
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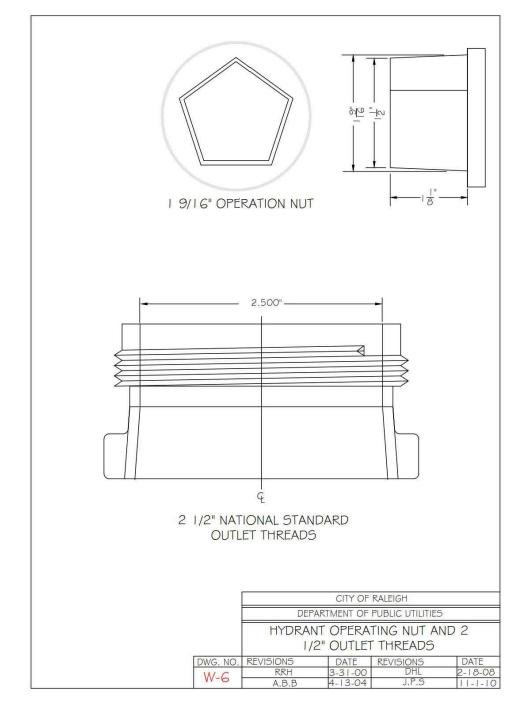


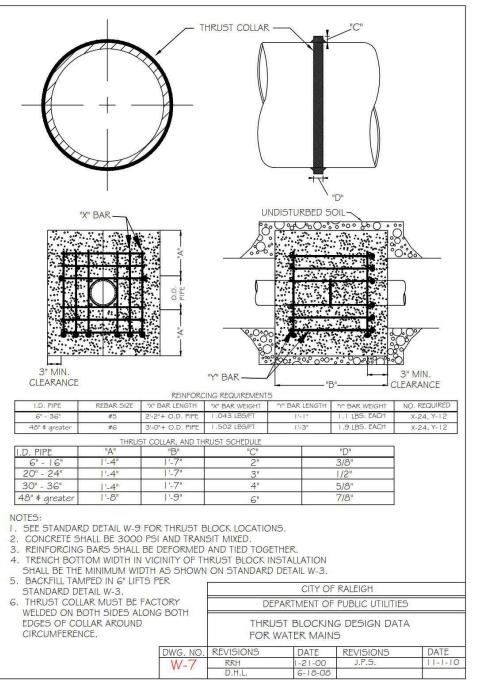


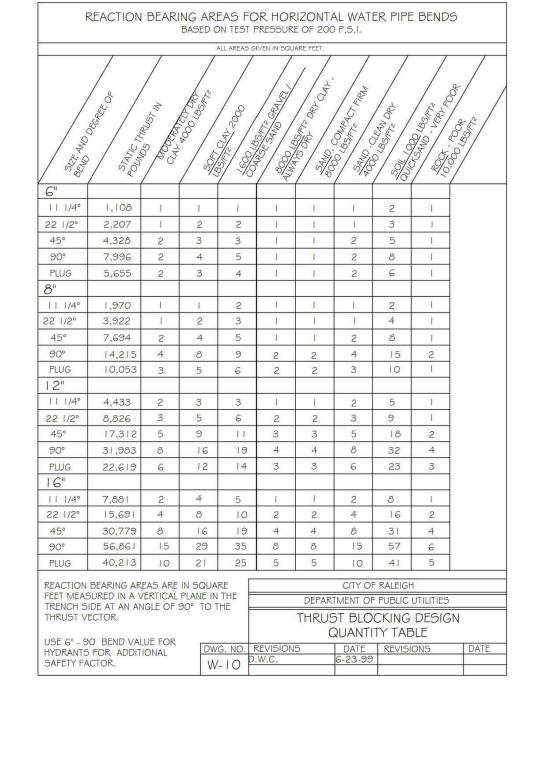


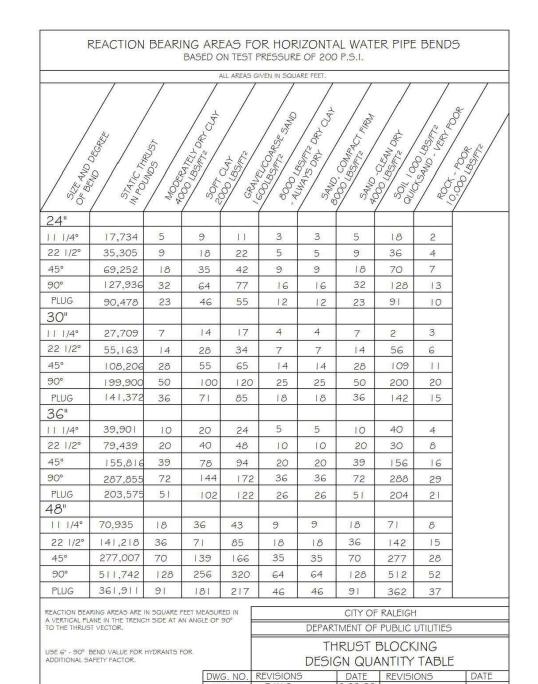


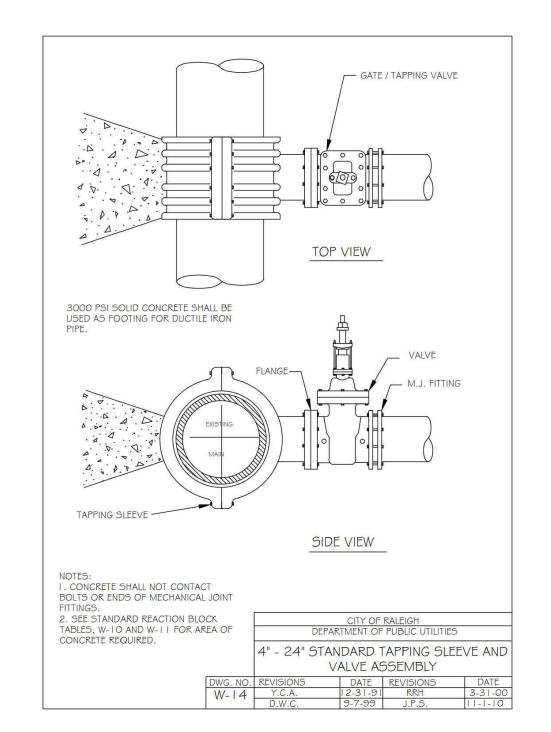


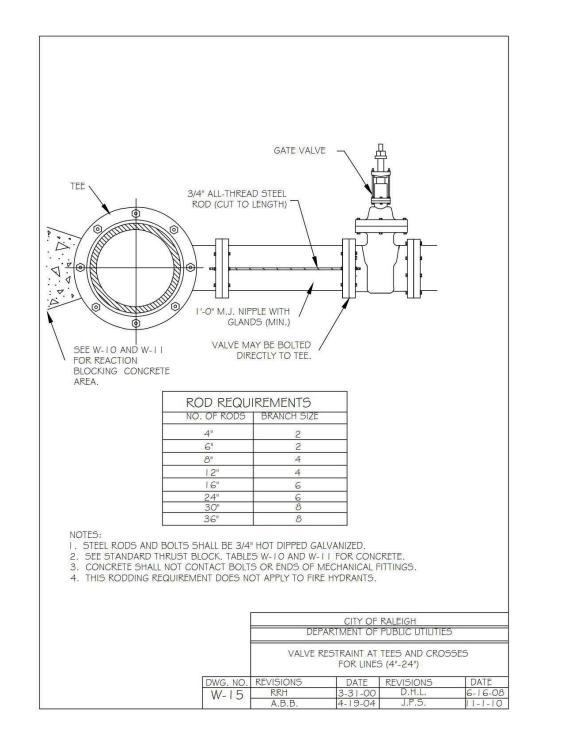














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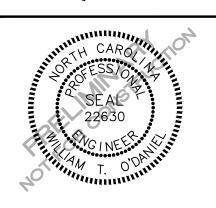
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4

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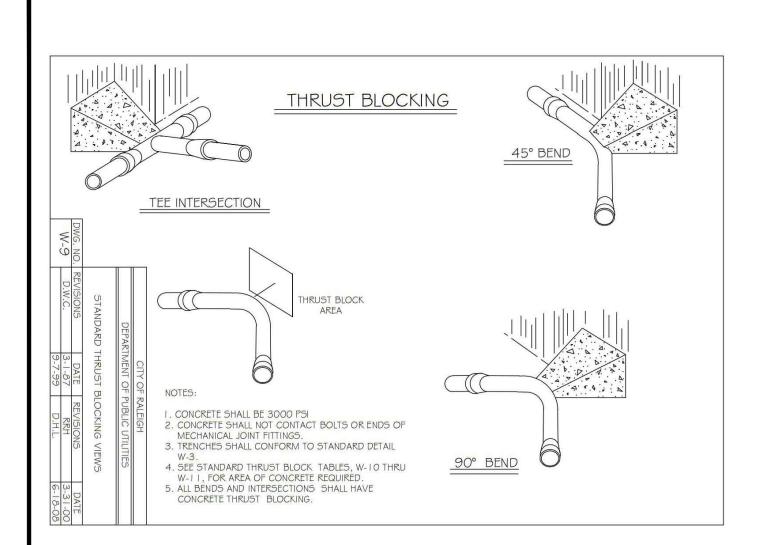
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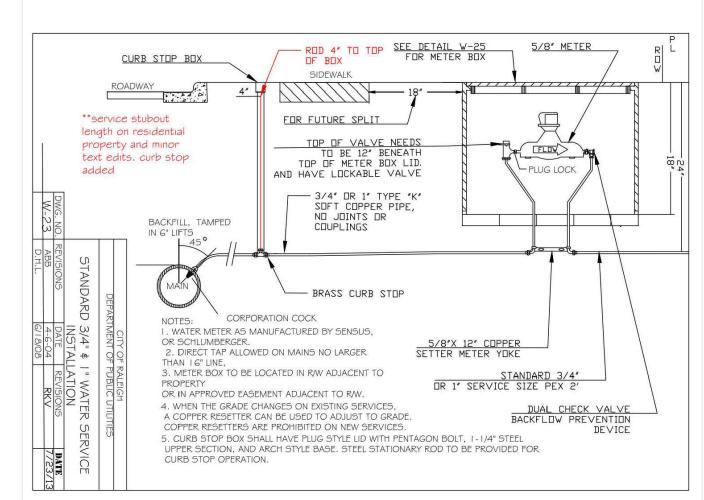
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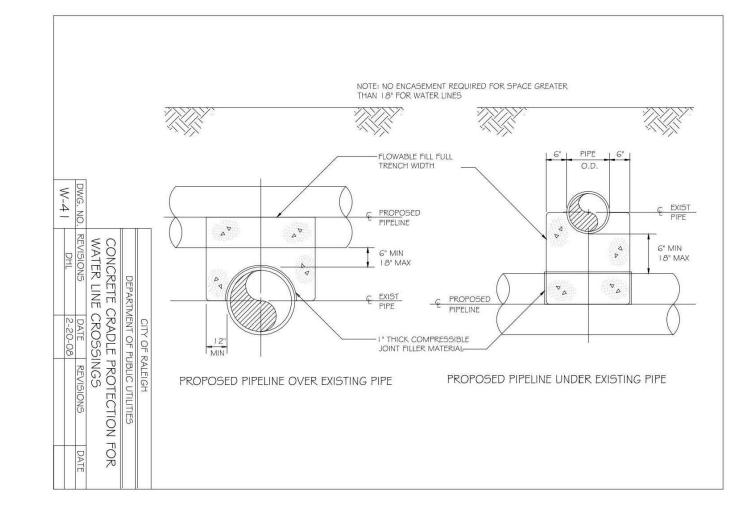
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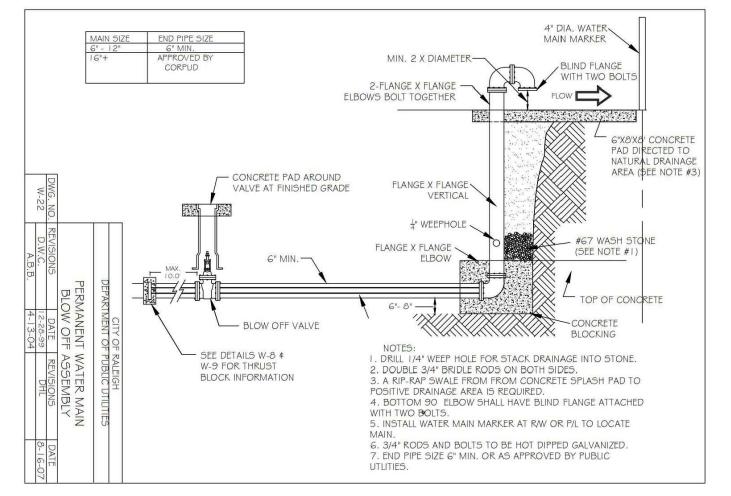
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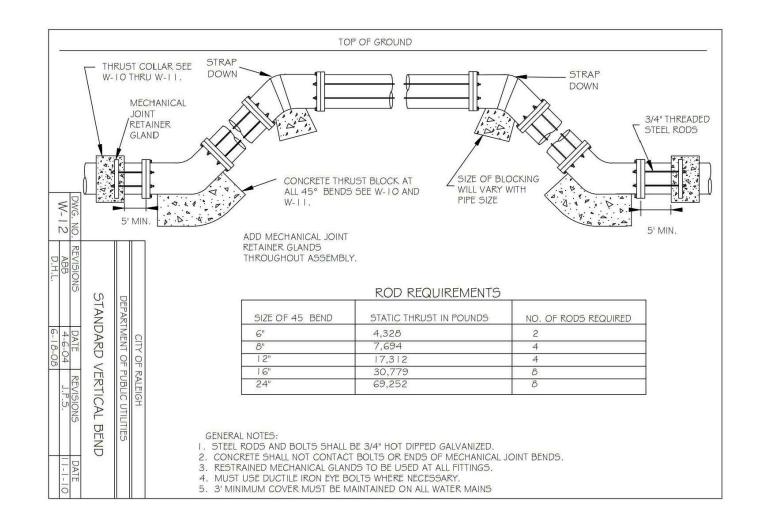
WATER DETAILS

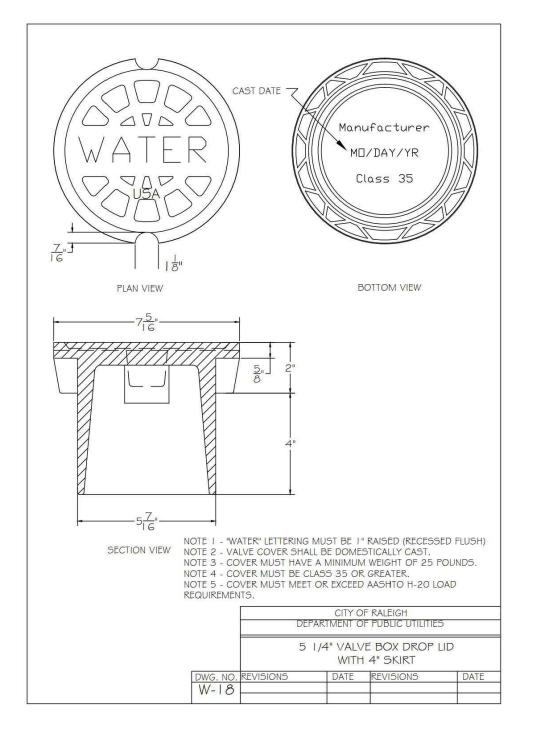


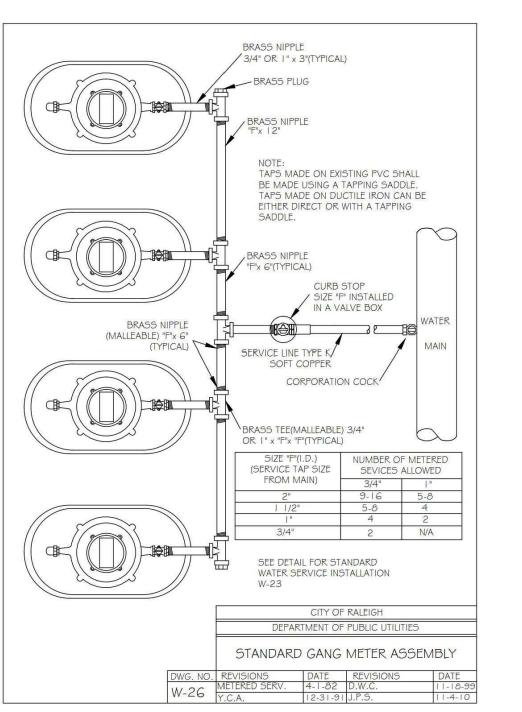


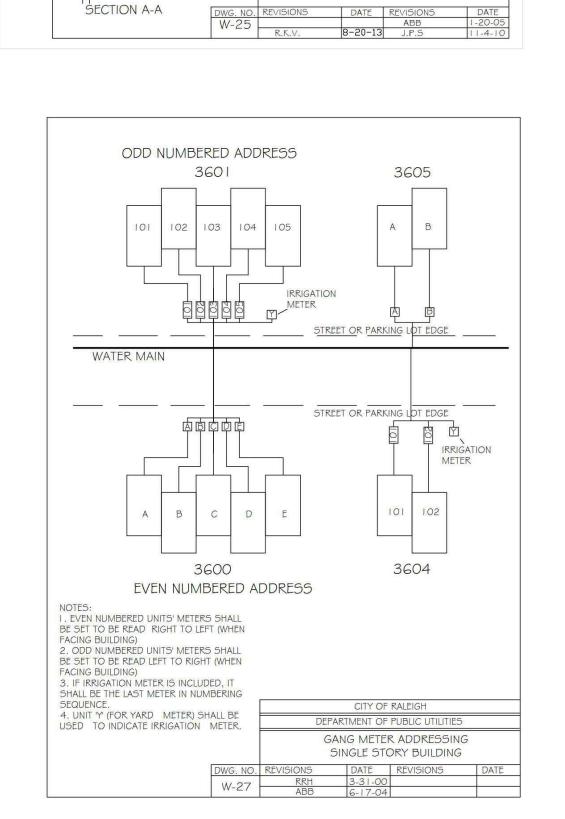












1.75" -

- 13/16" TYP.

1 1/2"

SECTION C-C

1. COVER WEIGHT: 13 LBS +/- 5%

2. LIDS TO BE COATED WITH BITUMINOUS COAL TAR COATING

3. BOXES AND LIDS MUST BE

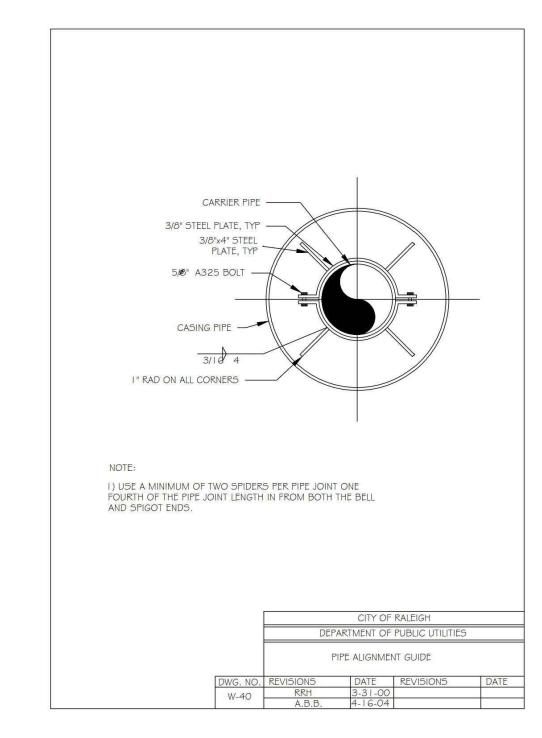
MANUFACTURED FROM SAME DOMESTIC FOUNDRY.

CITY OF RALEIGH DEPARTMENT OF PUBLIC UTILITIES

WATER METER BOX DETAIL

<u>_7/8</u>"

SECTION B-B





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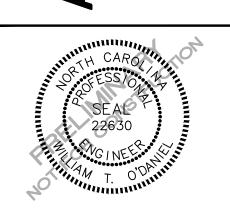
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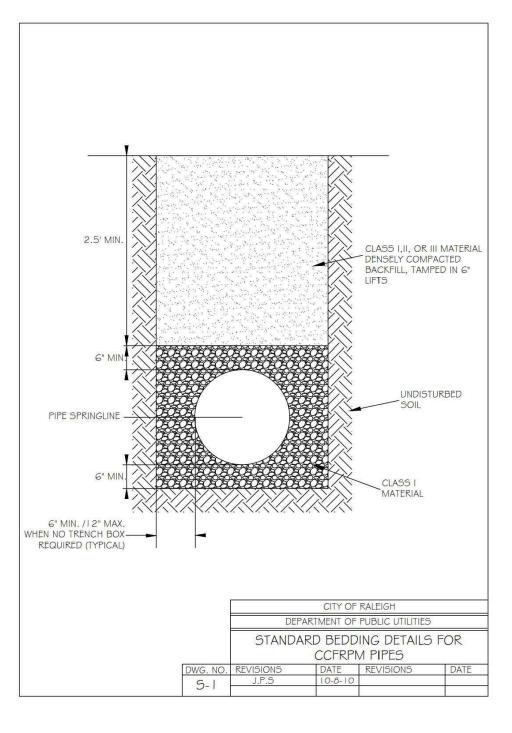
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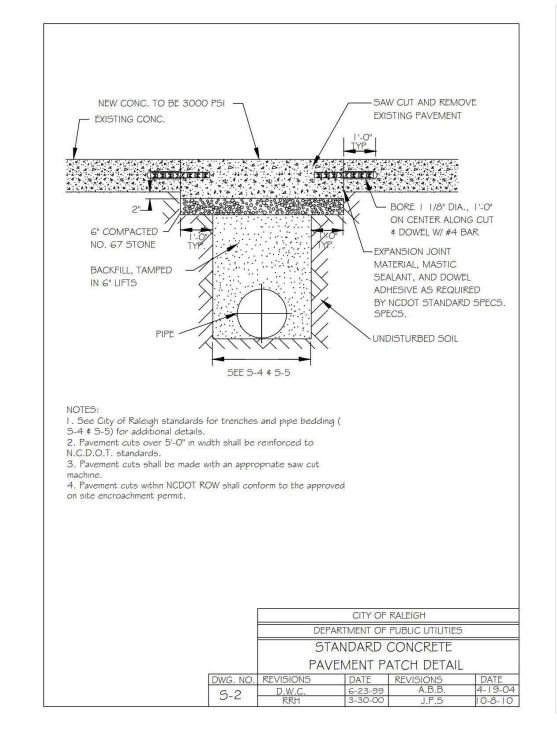
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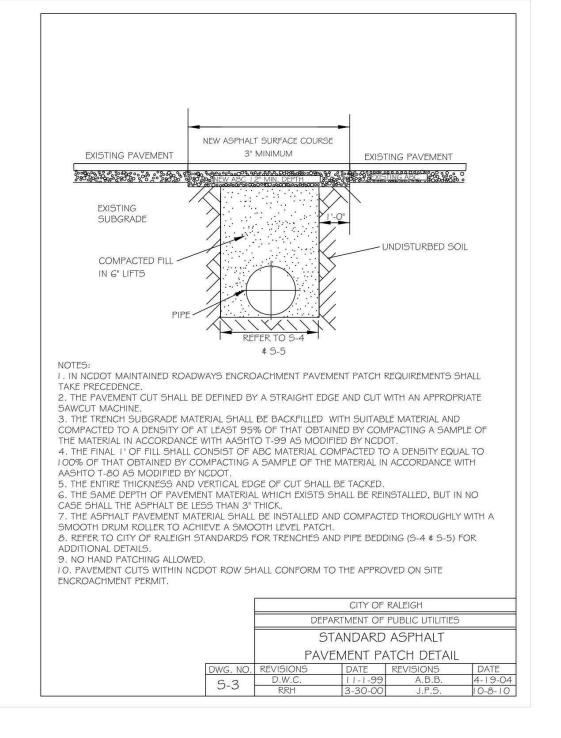
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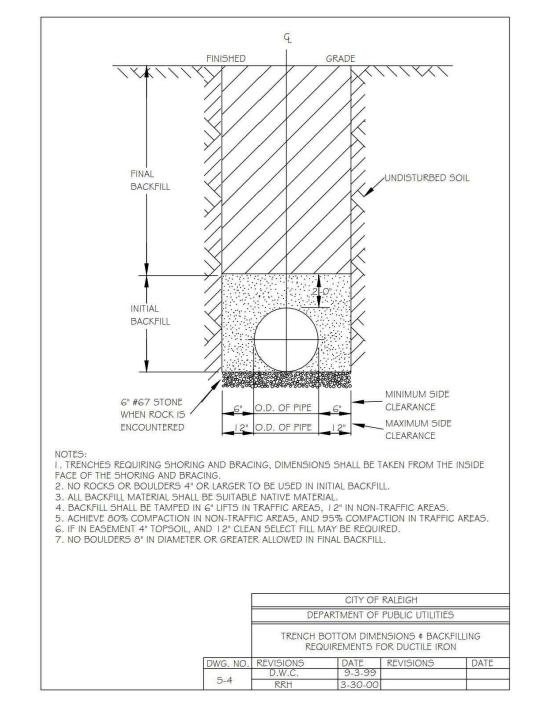
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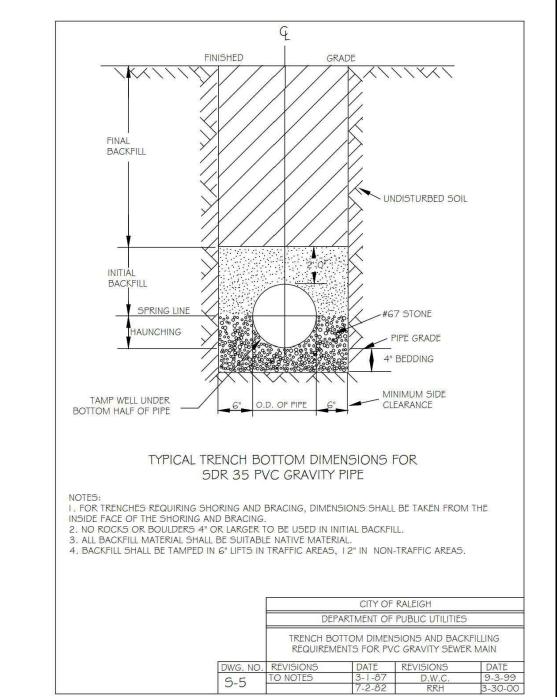
WATER DETAILS

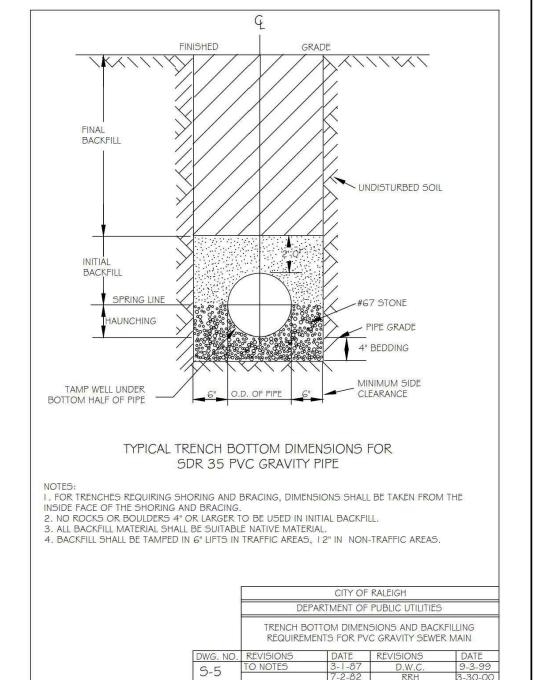


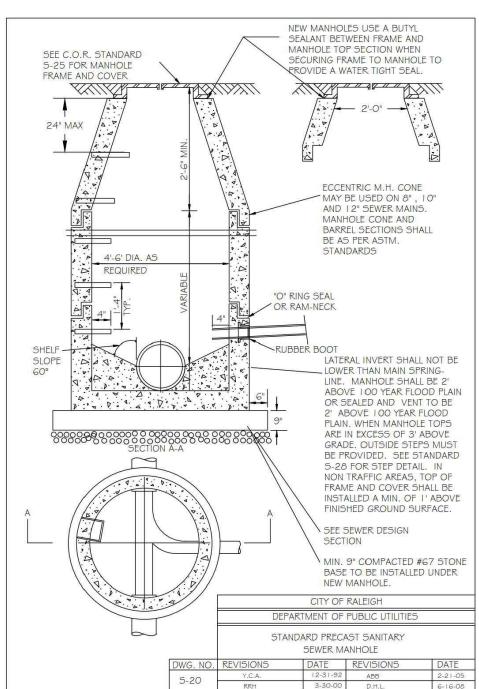


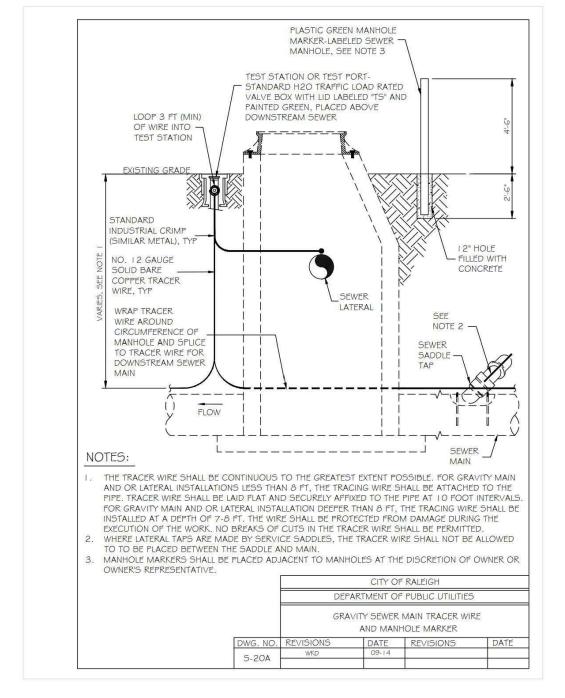


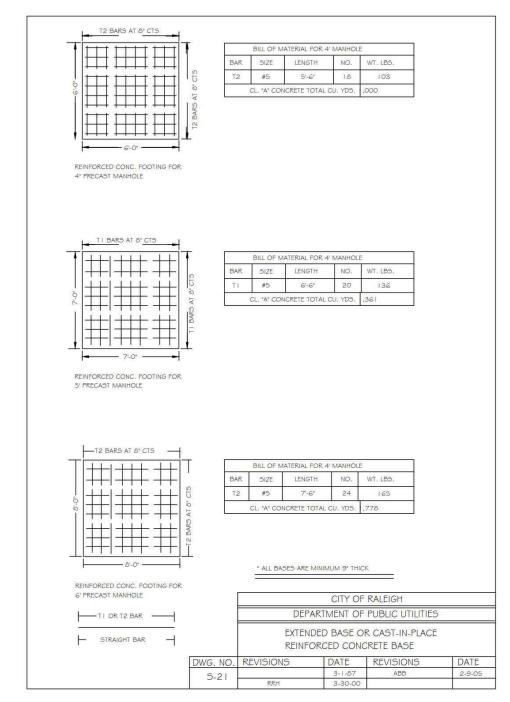


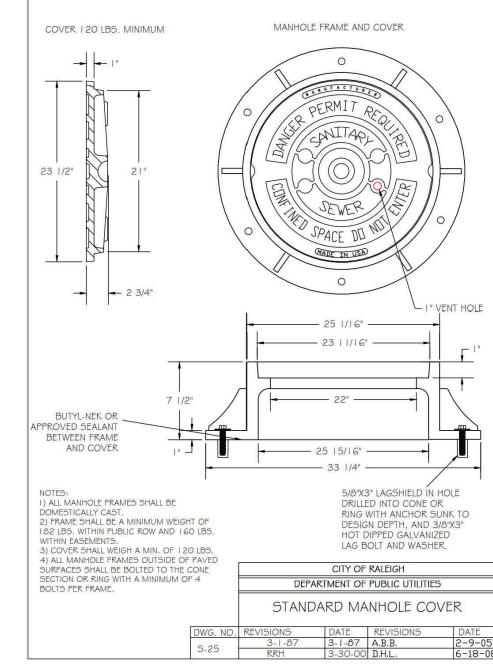


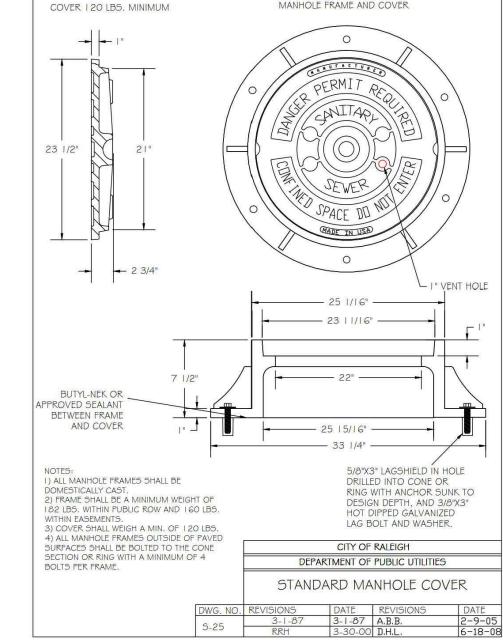


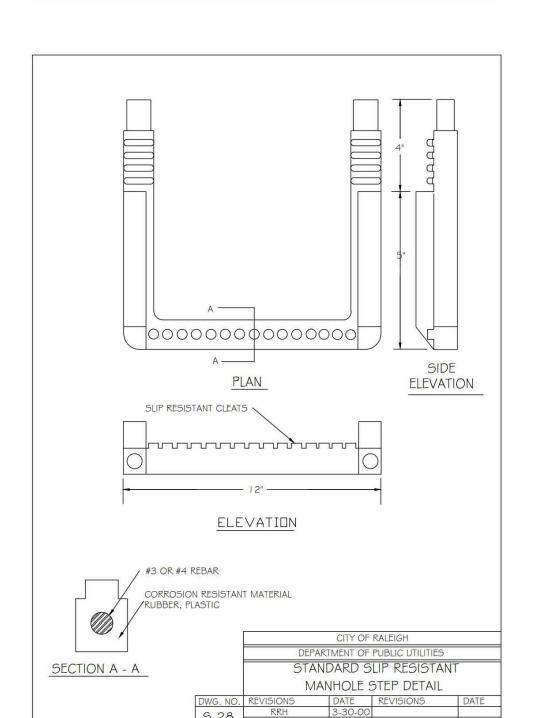


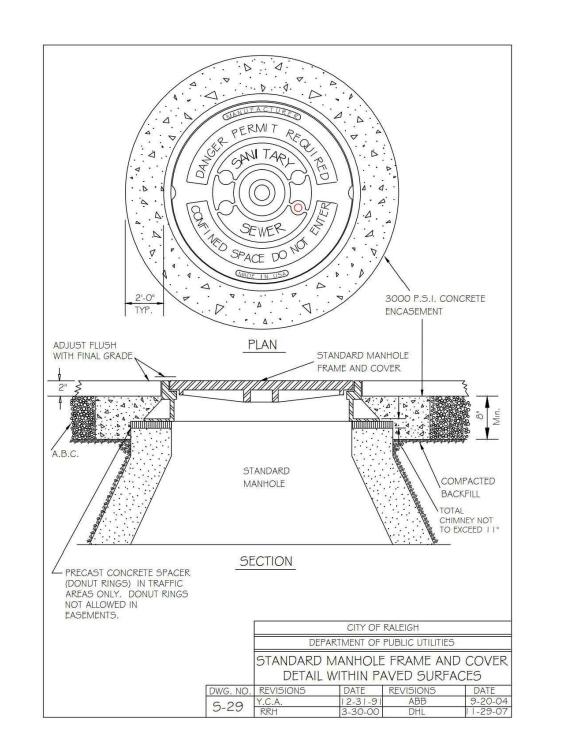


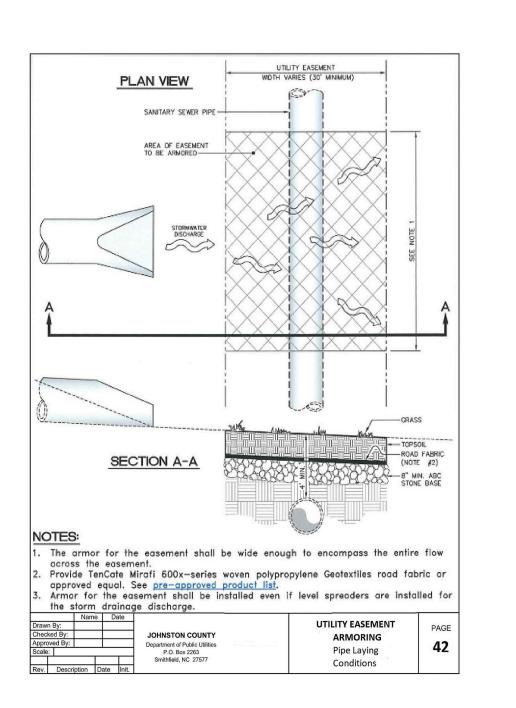


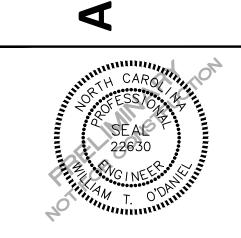












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7315 WISCONSIN AVENUE

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SUITE 925W

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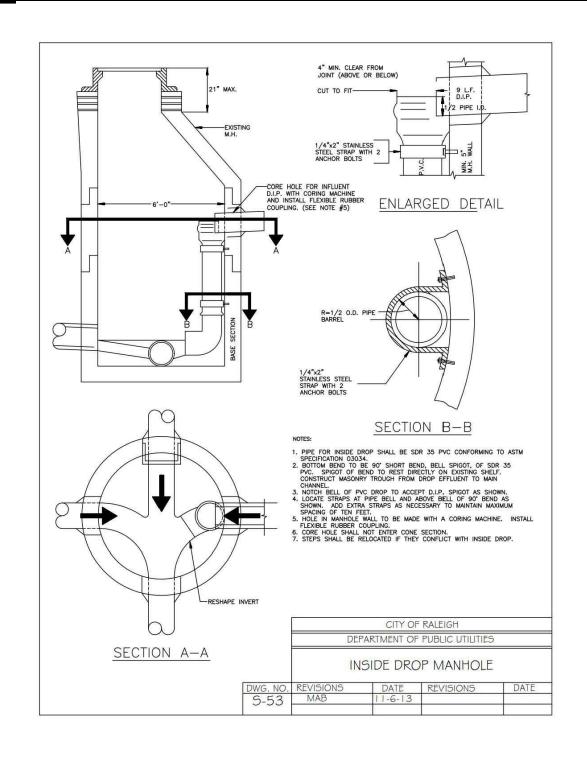
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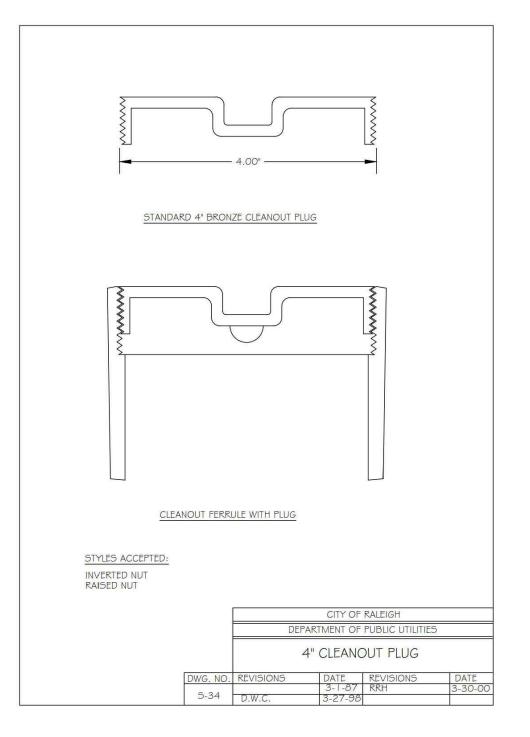
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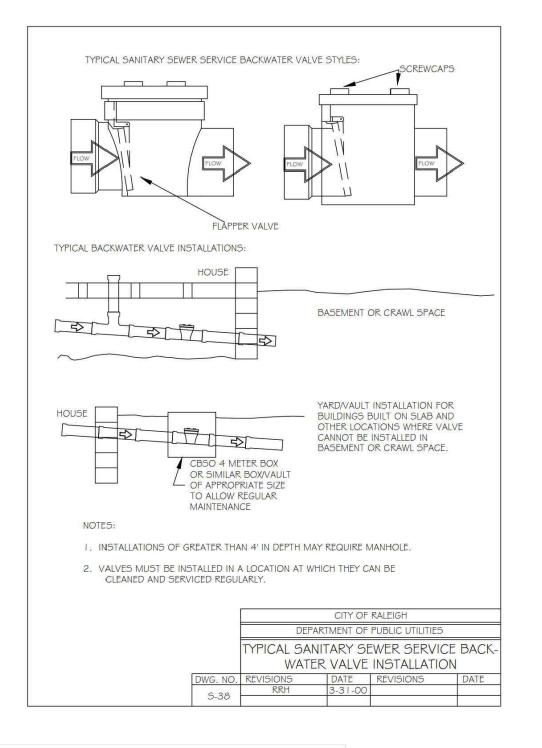
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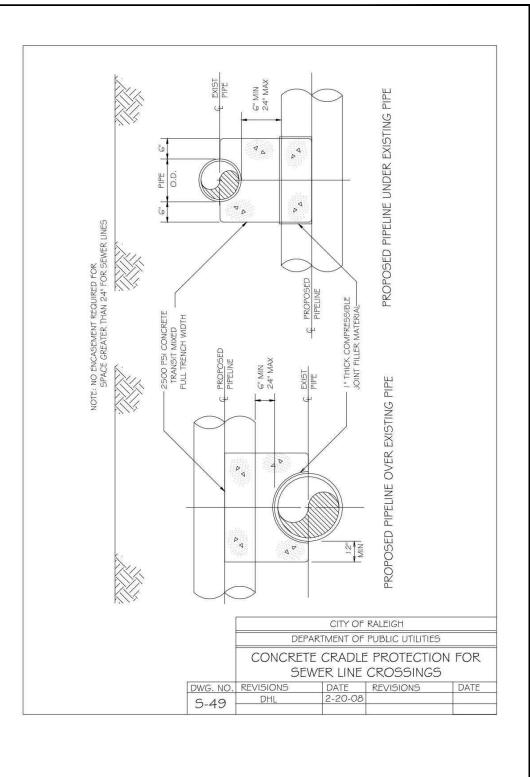
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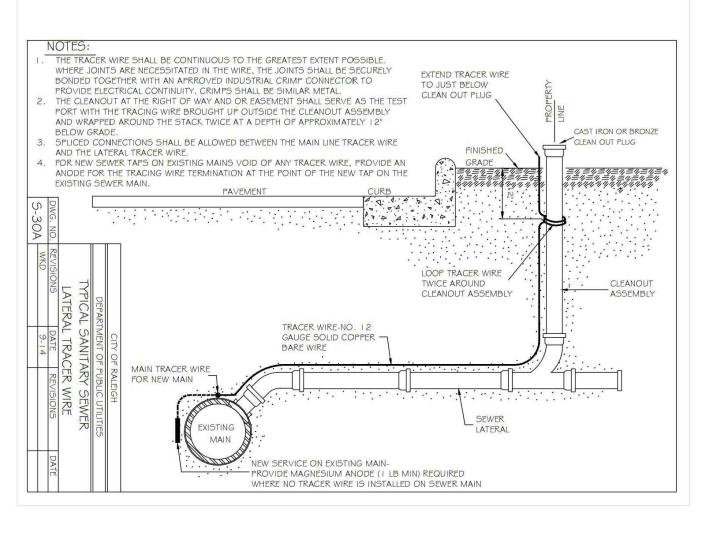
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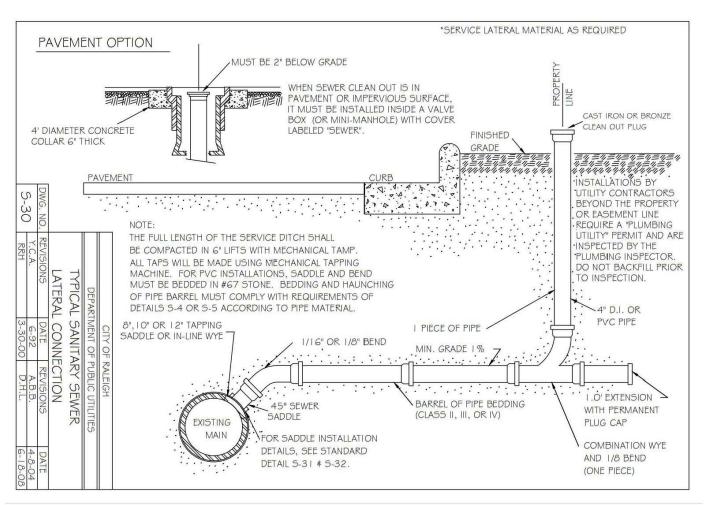














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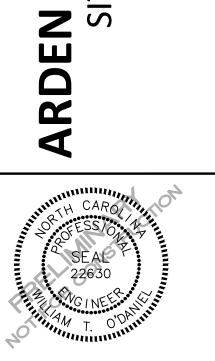
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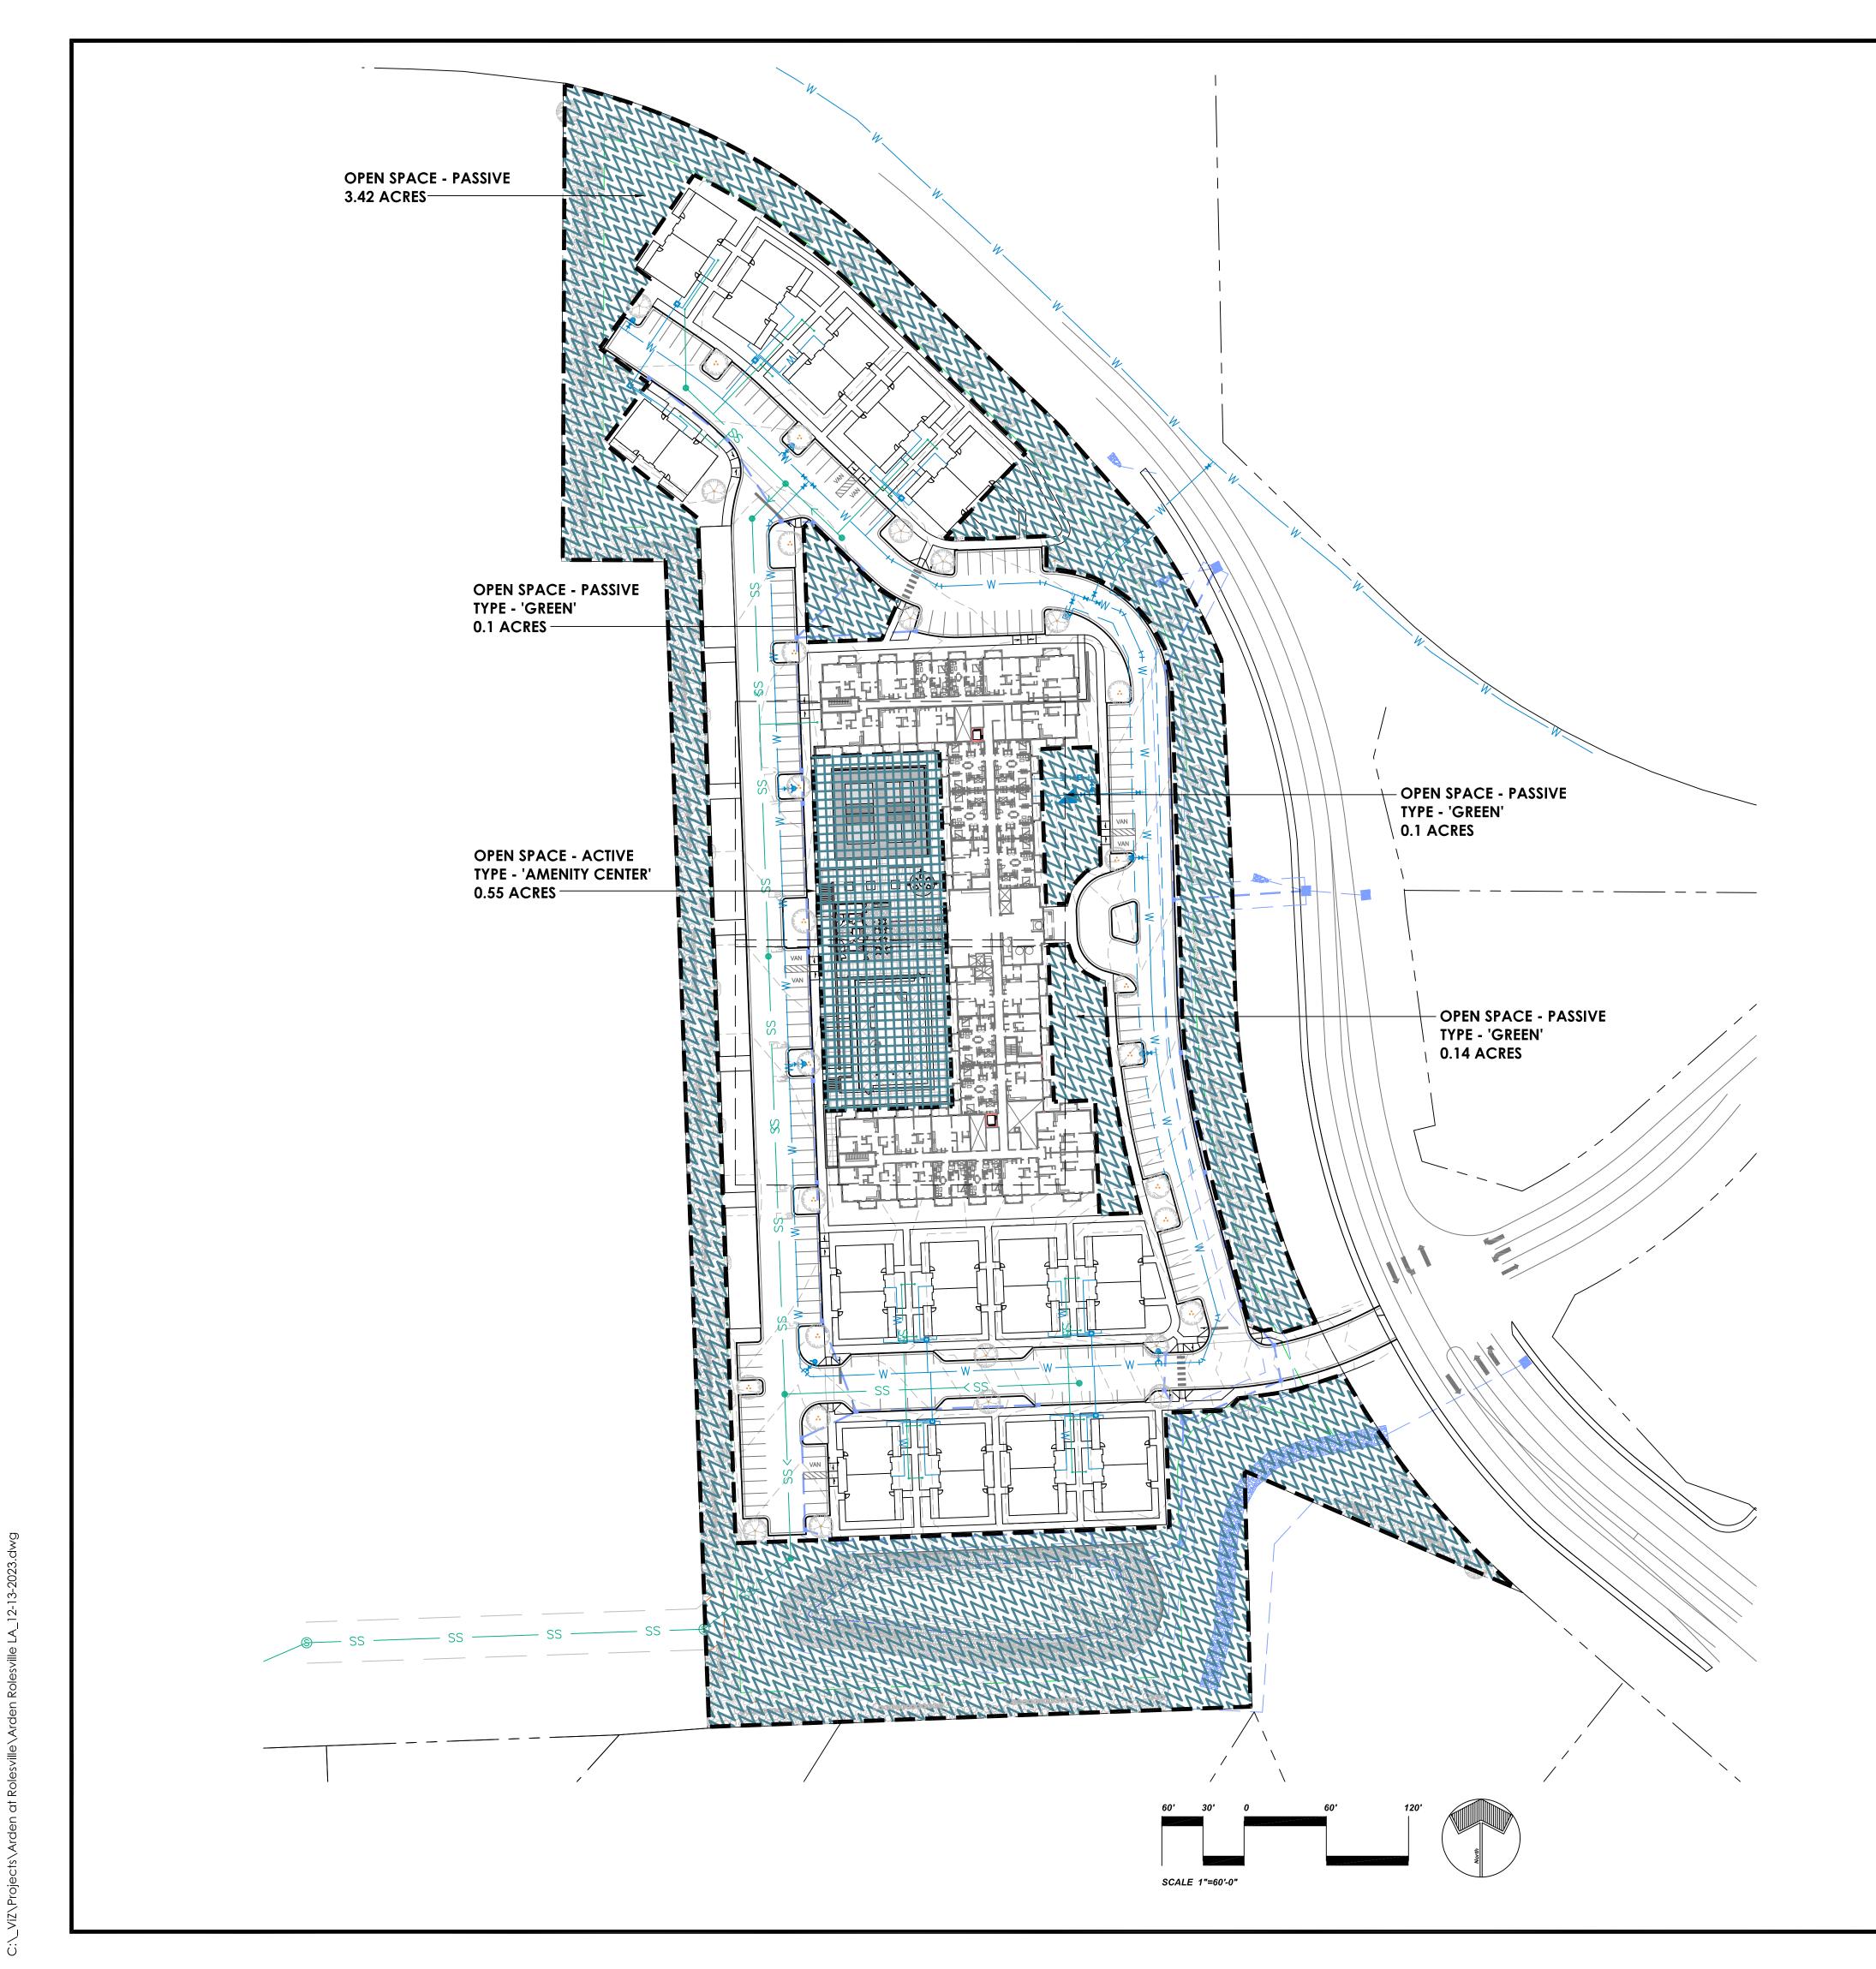
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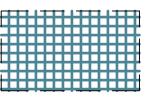
SCALE N.T.S. DATE 01. 03. 2024 SHEET

SEWER DETAILS



TOWN OF ROLESVILLE OPEN SPACE NOTES:

- 1. ALL PLANTING AND LANDSCAPE SHALL BE IN ACCORDANCE WITH ARTICLE 6.2 OF THE TOWN OF ROLESVILLE LAND DEVELOPMENT ORDINANCE.
- 2. SEE CIVIL ENGINEERING DRAWINGS FOR REQUIRED TREE CONSERVATION AREAS, AND BUFFER LOCATIONS/DIMENSIONS IF APPLICABLE.
- 3. ALL PLANT MATERIAL SHALL BE NATIVE, AND AS REQUIRED IN SECTION 6.2.4.
- 4. LDO SECTION 6.2.1 OPEN SPACE:
 - SITE ACREAGE = 10.4 ACRES @ 15% OPEN SPACE REQUIRED = 1.56 ACRES. OPEN SPACE DEVELOPMENTS REQUIRED = ONE SMALL AND ONE MEDIUM OPEN SPACE PROVIDED = 4.31 ACRES



ACTIVE OPEN SPACE



PASSIVE OPEN SPACE

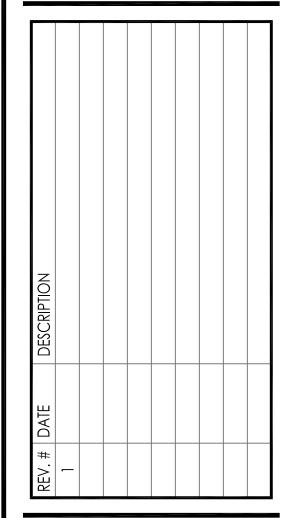


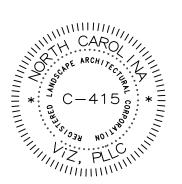
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Arden at Rolesville
ior Living Developmen







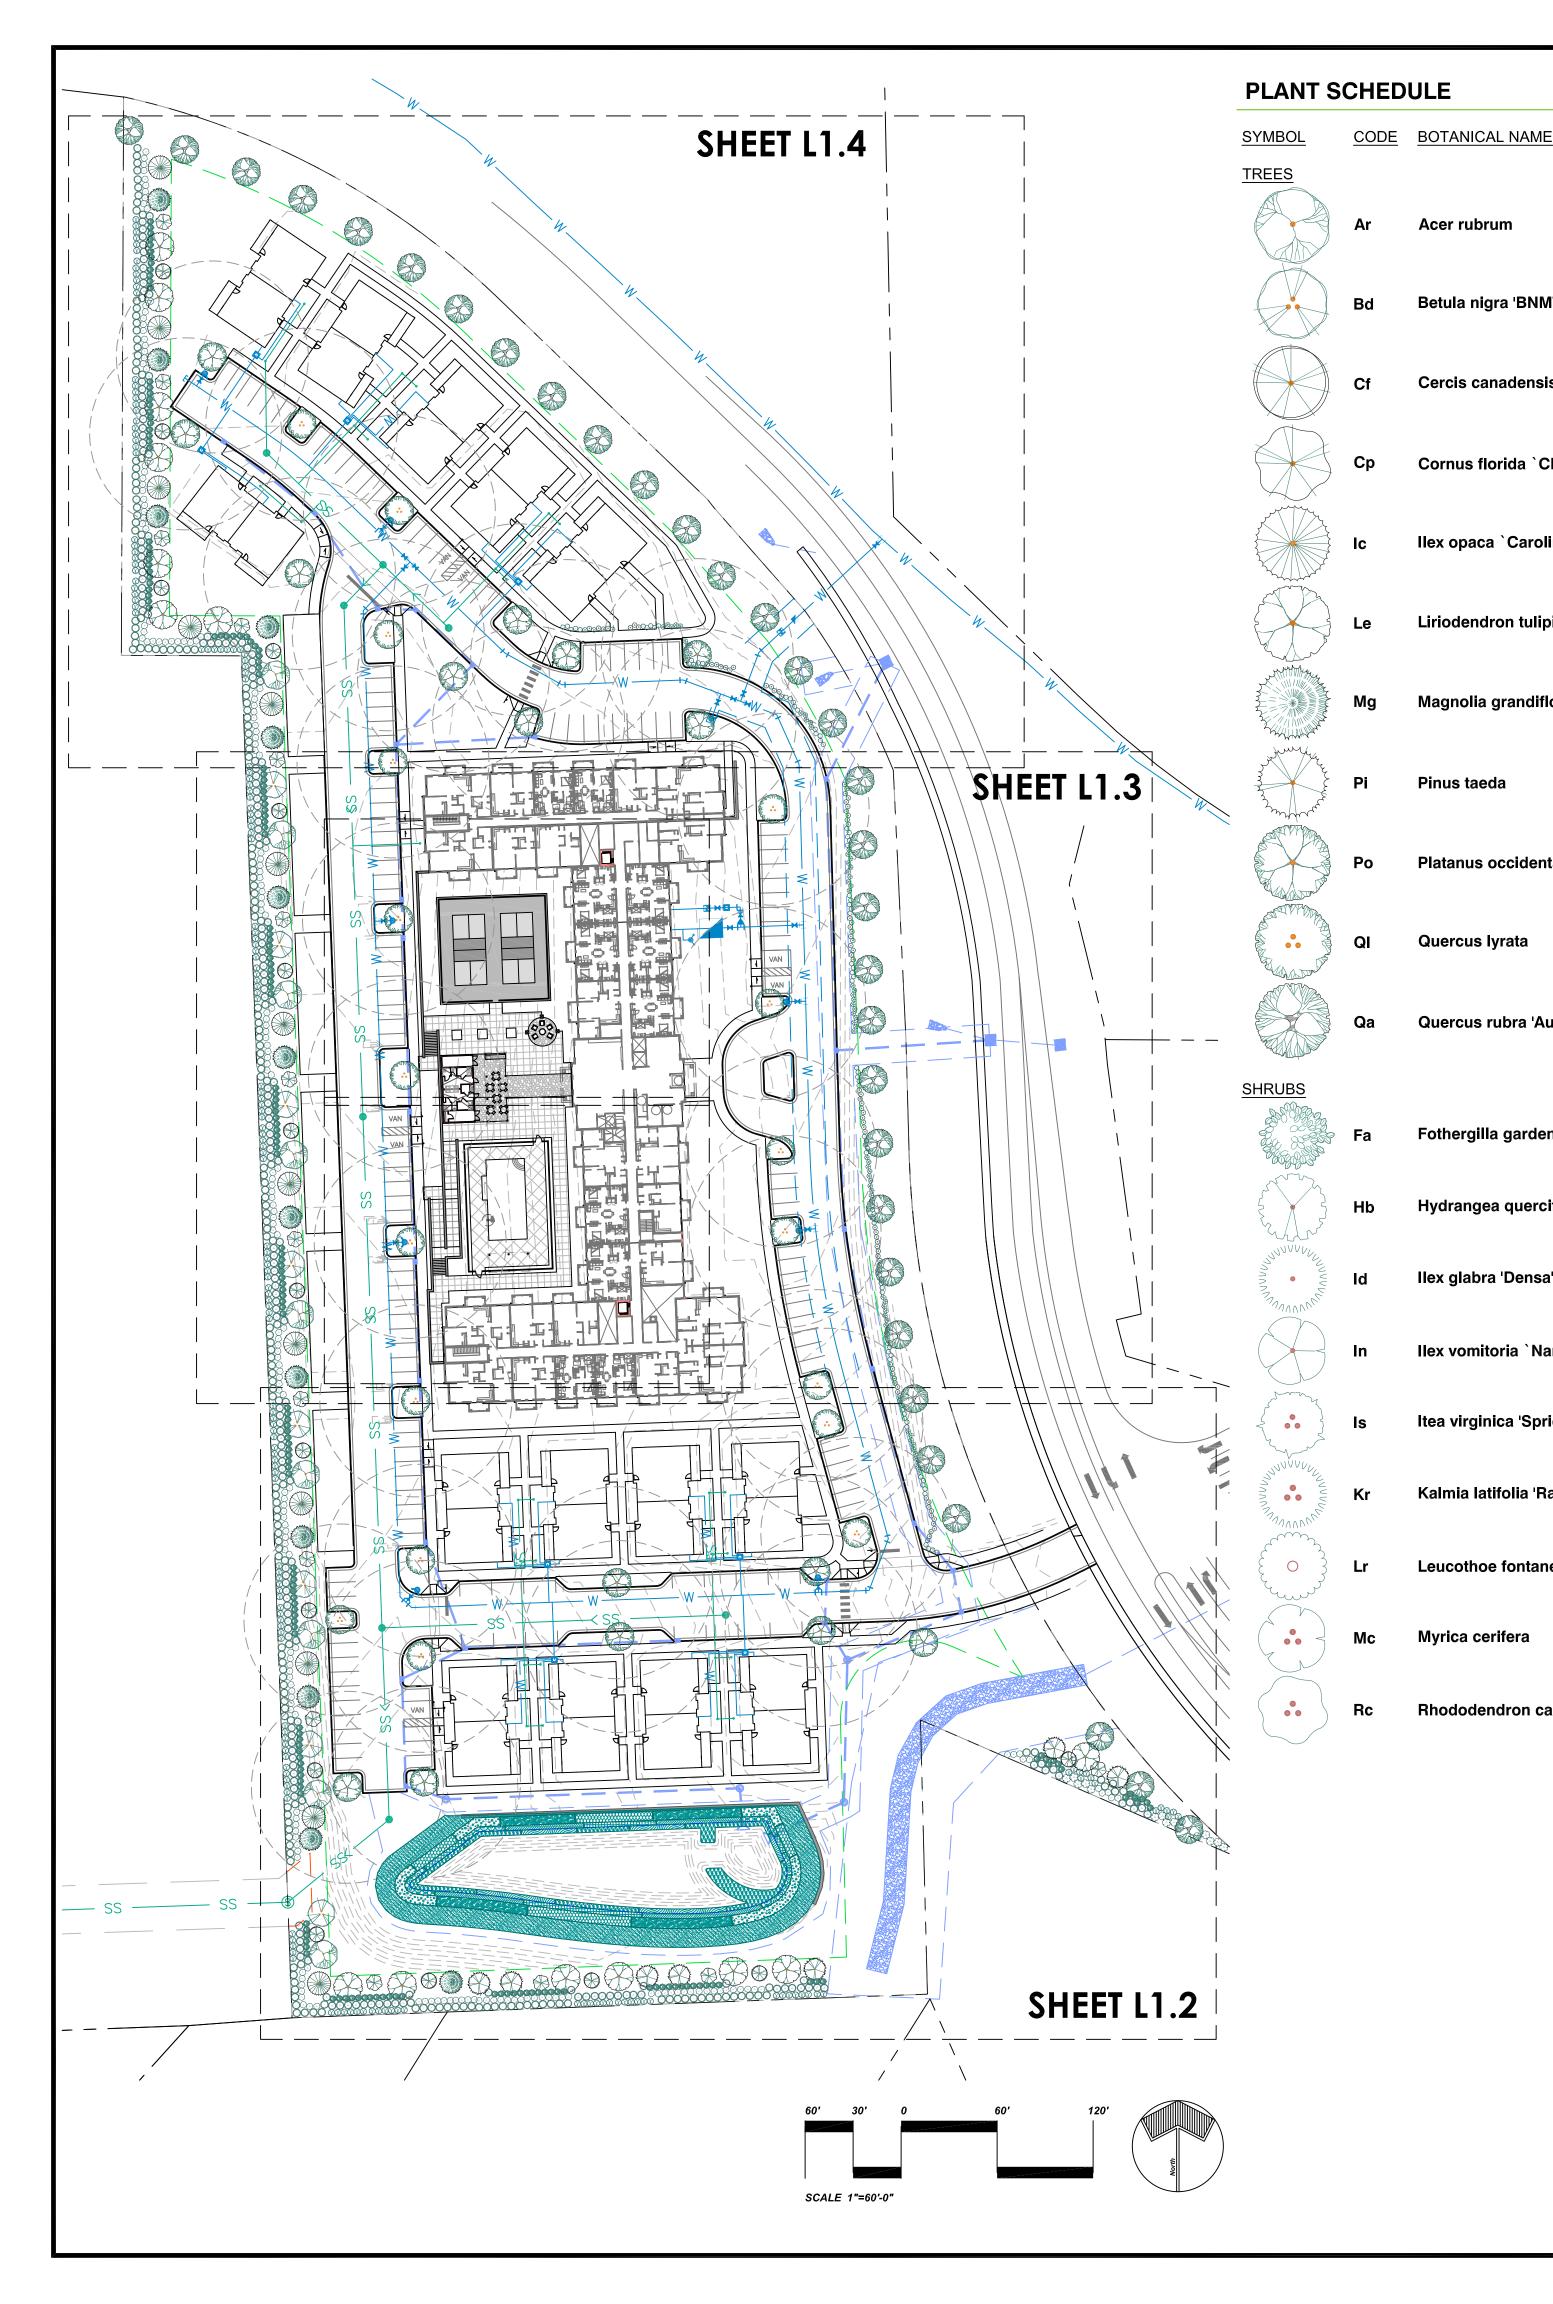
DATE: SCALE: JOB NUMBER: DESIGNED BY:

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OPEN SPACE PLAN

L-1.0



PLANT SPECIES NOTES:

SIZE

2" Cal. 9

2" Cal. 8

1" Cal. 16

1" Cal. 15

2" Cal. 13

2" Cal. 14

2" Cal. 7

2" Cal. 16

2" Cal. 18

2" Cal. 32

3 gal.

3 gal. 66

3 gal. 81

3 gal. 15

3 gal. 201

196

<u>QTY</u>

COMMON NAME

Dura Heat River Birch

Forest Pansy Redbud

Cherokee Princess Dogwood

Carolina #2 American Holly

Emerald City Tulip Poplar

Magnolia grandiflora `Claudia Wannamaker` Claudia W. Southern Magnolia 2" Cal. 13

Loblolly Pine

Overcup Oak

Aurea Red Oak

Inkberry Holly

Wax Myrtle

Dwarf Yaupon Holly

Little Henry® Sweetspire

Rainbow Drooping Leucothoe

Carolina Rhododendron

Mt. Airy Dwarf Witchalder

Gatsby Gal® Oakleaf Hydrangea 3 gal.

Raspberry Glow Mountain Laurel 3 gal.

American Sycamore

Red Maple

Acer rubrum

Betula nigra 'BNMTF' TM

Ilex opaca `Carolina #2`

Pinus taeda

Quercus lyrata

Platanus occidentalis

Quercus rubra 'Aurea'

Ilex glabra 'Densa'

Ilex vomitoria `Nana`

Fothergilla gardenii `Mt. Airy`

Hydrangea quercifolia `Brenhill'

Kalmia latifolia 'Raspberry Glow'

Leucothoe fontanesiana 'Rainbow'

Rhododendron carolinianum

Cercis canadensis `Forest Pansy` TM

Cornus florida `Cherokee Princess`

Liriodendron tulipifera 'JFS-Oz' TM

AS REQUIRED ALL PLANT MATERIAL SHALL BE NATIVE, AND AS LISTED IN THE TOWN OF ROLESVILLE LDO. PLANT SPECIES MUST BE APPROVED BY THE TOWN.

2. ALL PLANT MATERIAL INDICATED IN THE PLANT SCHEDULE IS DERIVED FROM SOURCES THROUGHOUT NORTH CAROLINA INDICATING NATIVE PLANT SPECIES.

TOWN OF ROLESVILLE LANDSCAPE NOTES:

1. ALL PLANTING AND LANDSCAPE SHALL BE IN ACCORDANCE WITH ARTICLE 6.2 OF THE TOWN OF ROLESVILLE LAND DEVELOPMENT ORDINANCE.

2. SEE CIVIL ENGINEERING DRAWINGS FOR REQUIRED TREE CONSERVATION AREAS, AND BUFFER LOCATIONS/DIMENSIONS IF APPLICABLE.

3. ALL PLANT MATERIAL SHALL BE NATIVE, AND AS REQUIRED IN SECTION 6.2.4.

4. ALL IRRIGATION SHALL BE DRIP WITH NO OVERHEAD SPRAY TYPE.

5. LDO SECTION 6.2.1 - OPEN SPACE:

SITE ACREAGE = 10.4 ACRES @ 15% OPEN SPACE REQUIRED = 1.56 ACRES. OPEN SPACE DEVELOPMENTS REQUIRED = ONE SMALL AND ONE MEDIUM

6. LDO SECTION 6.2.2 - BUFFERING:

TYPE 3 PERIMETER BUFFERS ARE REQUIRED: 4 CANOPY TREES, 2 UNDERSTORY TREES, 60 SHRUBS 30' STREET BUFFER UNDISTURBED: STREET TREE EVERY 40 LINEAR FEET PROVIDED

7. LDO SECTION 6.2.4.4 - PARKING LANDSCAPING:

ALL PARKING SPACES SHALL BE WITHIN 60' FEET OF A CANOPY TREE. PARKING PERIMETER PLANTINGS SHALL BE PLACED AS A CONTINUOUS ROW OF SHRUBS NO GREATER THAN THREE FEET ON CENTER

SEE SHEETS L-1.2 - L-1.4 FOR ENLARGED PLANTING LOCATIONS.

TRANSITION BETWEEN PLANT BEDS AND LAWN AREAS.

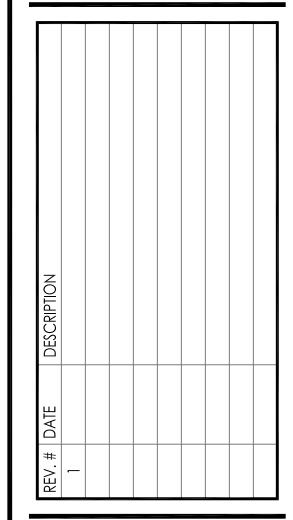
- CONTRACTOR TO VERIFY PLANT TOTALS. IF THERE IS A CONFLICT IN PLANT TOTALS BETWEEN QUANTITIES SHOWN IN THE PLANT LEGEND AND THOSE INDICTED ON THE PLANS, THE PLANT LEGEND QUANTITIES AND SUMMARY QUANTITIES SHALL TAKE PRECEDENCE.
- 3. PLANTS SHALL ONLY BE PLANTED FROM OCTOBER 1 MAY 15 UNLESS ALTERNATIVE DATES ARE
- 4. SEE CIVIL ENGINEERING DRAWINGS FOR LOCATIONS OF SITE DEVELOPMENT ELEMENTS, UTILITIES, TREE PRESERVATION AREAS, BUFFER YARDS, AND/OR OTHER REQUIRED AREAS AND EASEMENTS.
- 5. THE CONTRACTOR SHALL VERIFY LOCATION AND ELEVATION OF ALL UNDERGROUND UTILITIES. THE LOCATION OF ALL EXISTING UTILITIES ARE NOT NECESSARILY SHOWN ON THE PLANS, AND WHERE SHOWN ARE APPROXIMATE. THE CONTRACTOR SHALL ON HIS OWN INITIATIVE AND AT NO ADDITIONAL COST TO THE OWNER, HAVE LOCATED ALL UNDERGROUND LINES AND STRUCTURES NO CLAIMS FOR DAMAGES OR EXTRA COMPENSATION SHALL ACCRUE TO THE CONTRACTOR FROM THE PRESENCE OF SUCH PIPE, OTHER OBSTRUCTIONS, OR FROM ANY DELAY DUE TO REMOVAL OR REARRANGEMENT OF SAME. THE CONTRACTOR SHALL BE RESPONSIBLE FOR ANY DAMAGES TO UNDERGROUND STRUCTURES. THE CONTRACTOR IS RESPONSIBLE FOR CONTACTING ALL NON-SUBSCRIBING UTILITIES.
- 6. ALL DISTURBED AREAS THAT ARE NOT PLANT BEDS SHALL BE GRASS SEED. 7. THE LANDSCAPE CONTRACTOR SHALL PERFORM FINISH GRADING TO ENSURE A SMOOTH
- ALL PLANTING AND LANDSCAPE WORK SHALL BE IN ACCORDANCE WITH CURRENTTOWN STANDARDS.

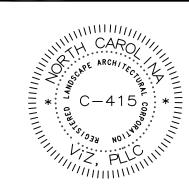


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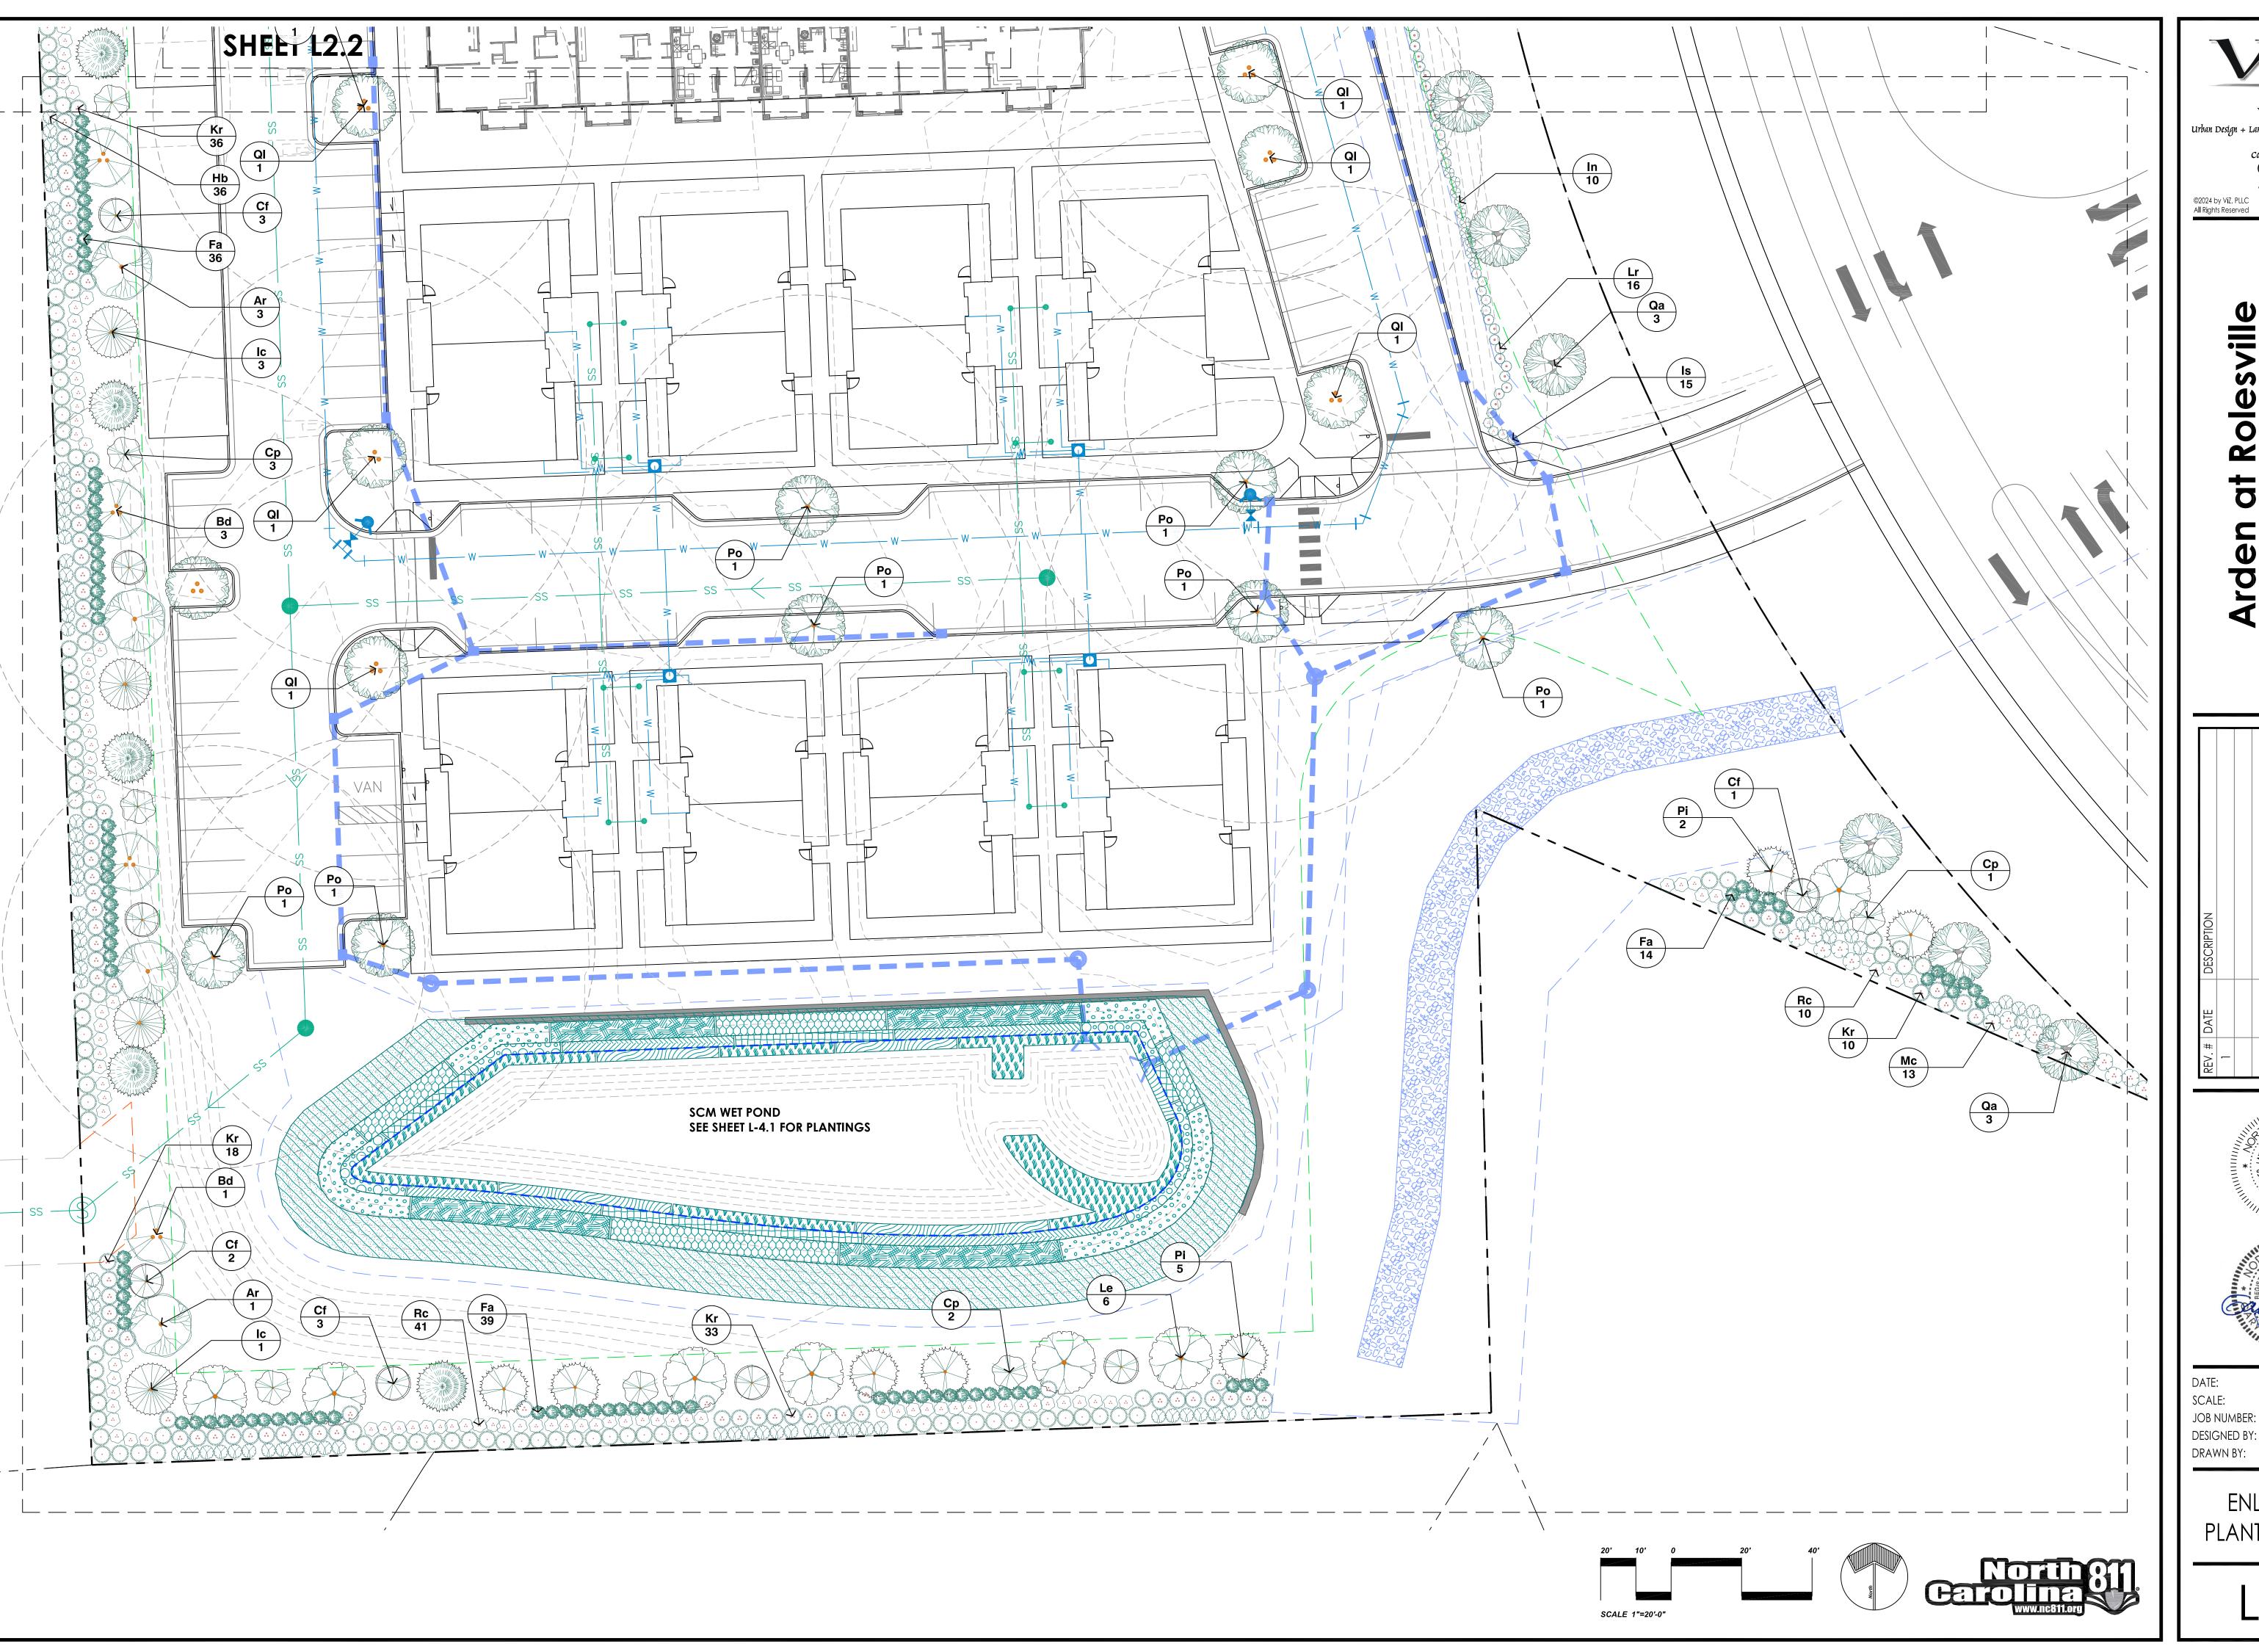
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OVERALL PLANTING KEY PLAN

L-

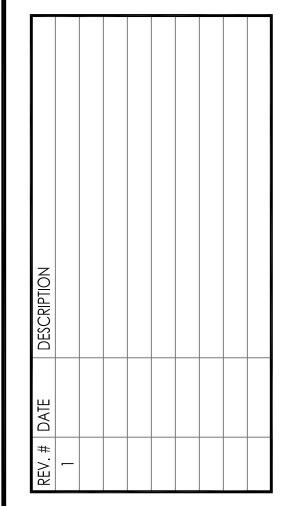
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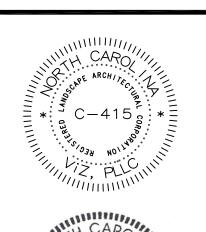




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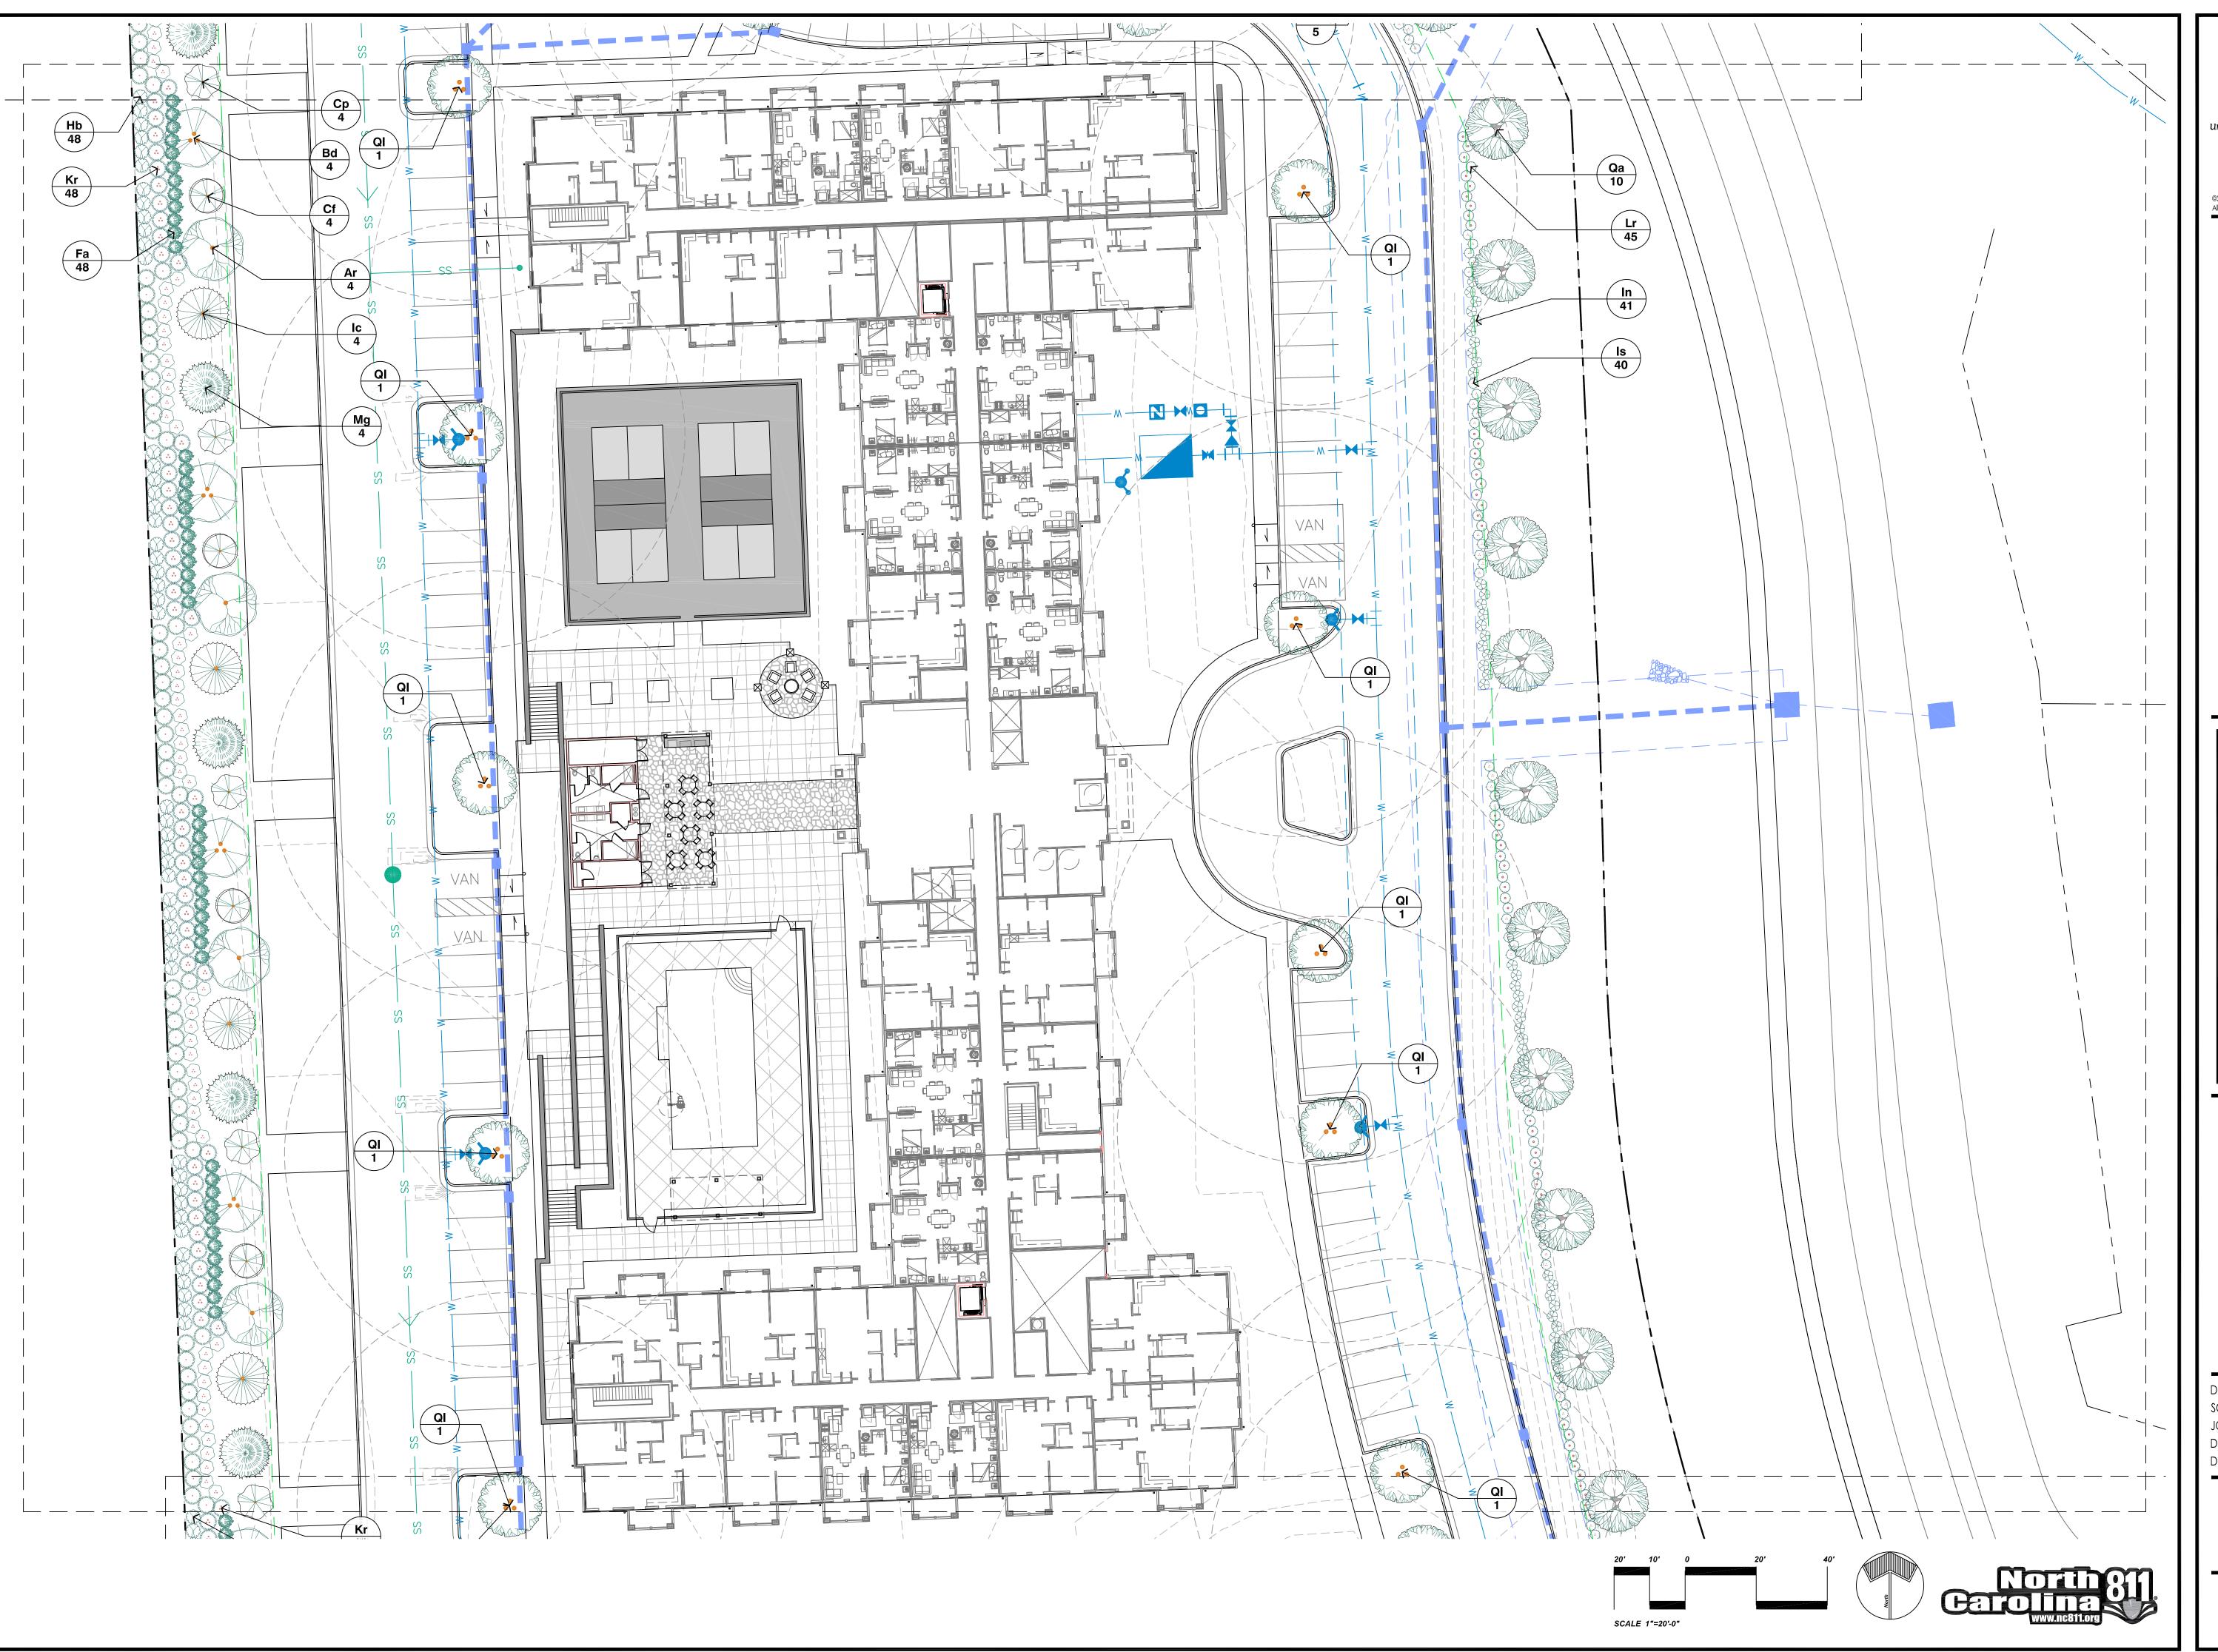




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AS SHOWN 23-68.1

ENLARGED PLANTING PLAN

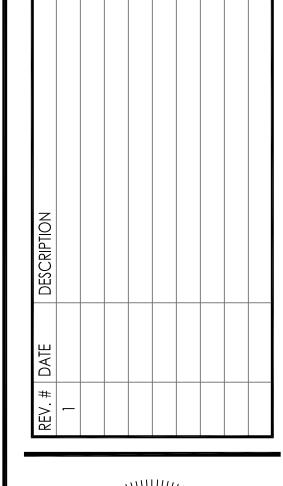


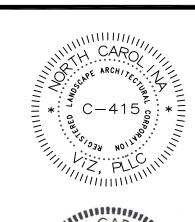
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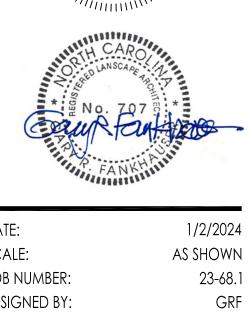
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Living Der Rolesville,



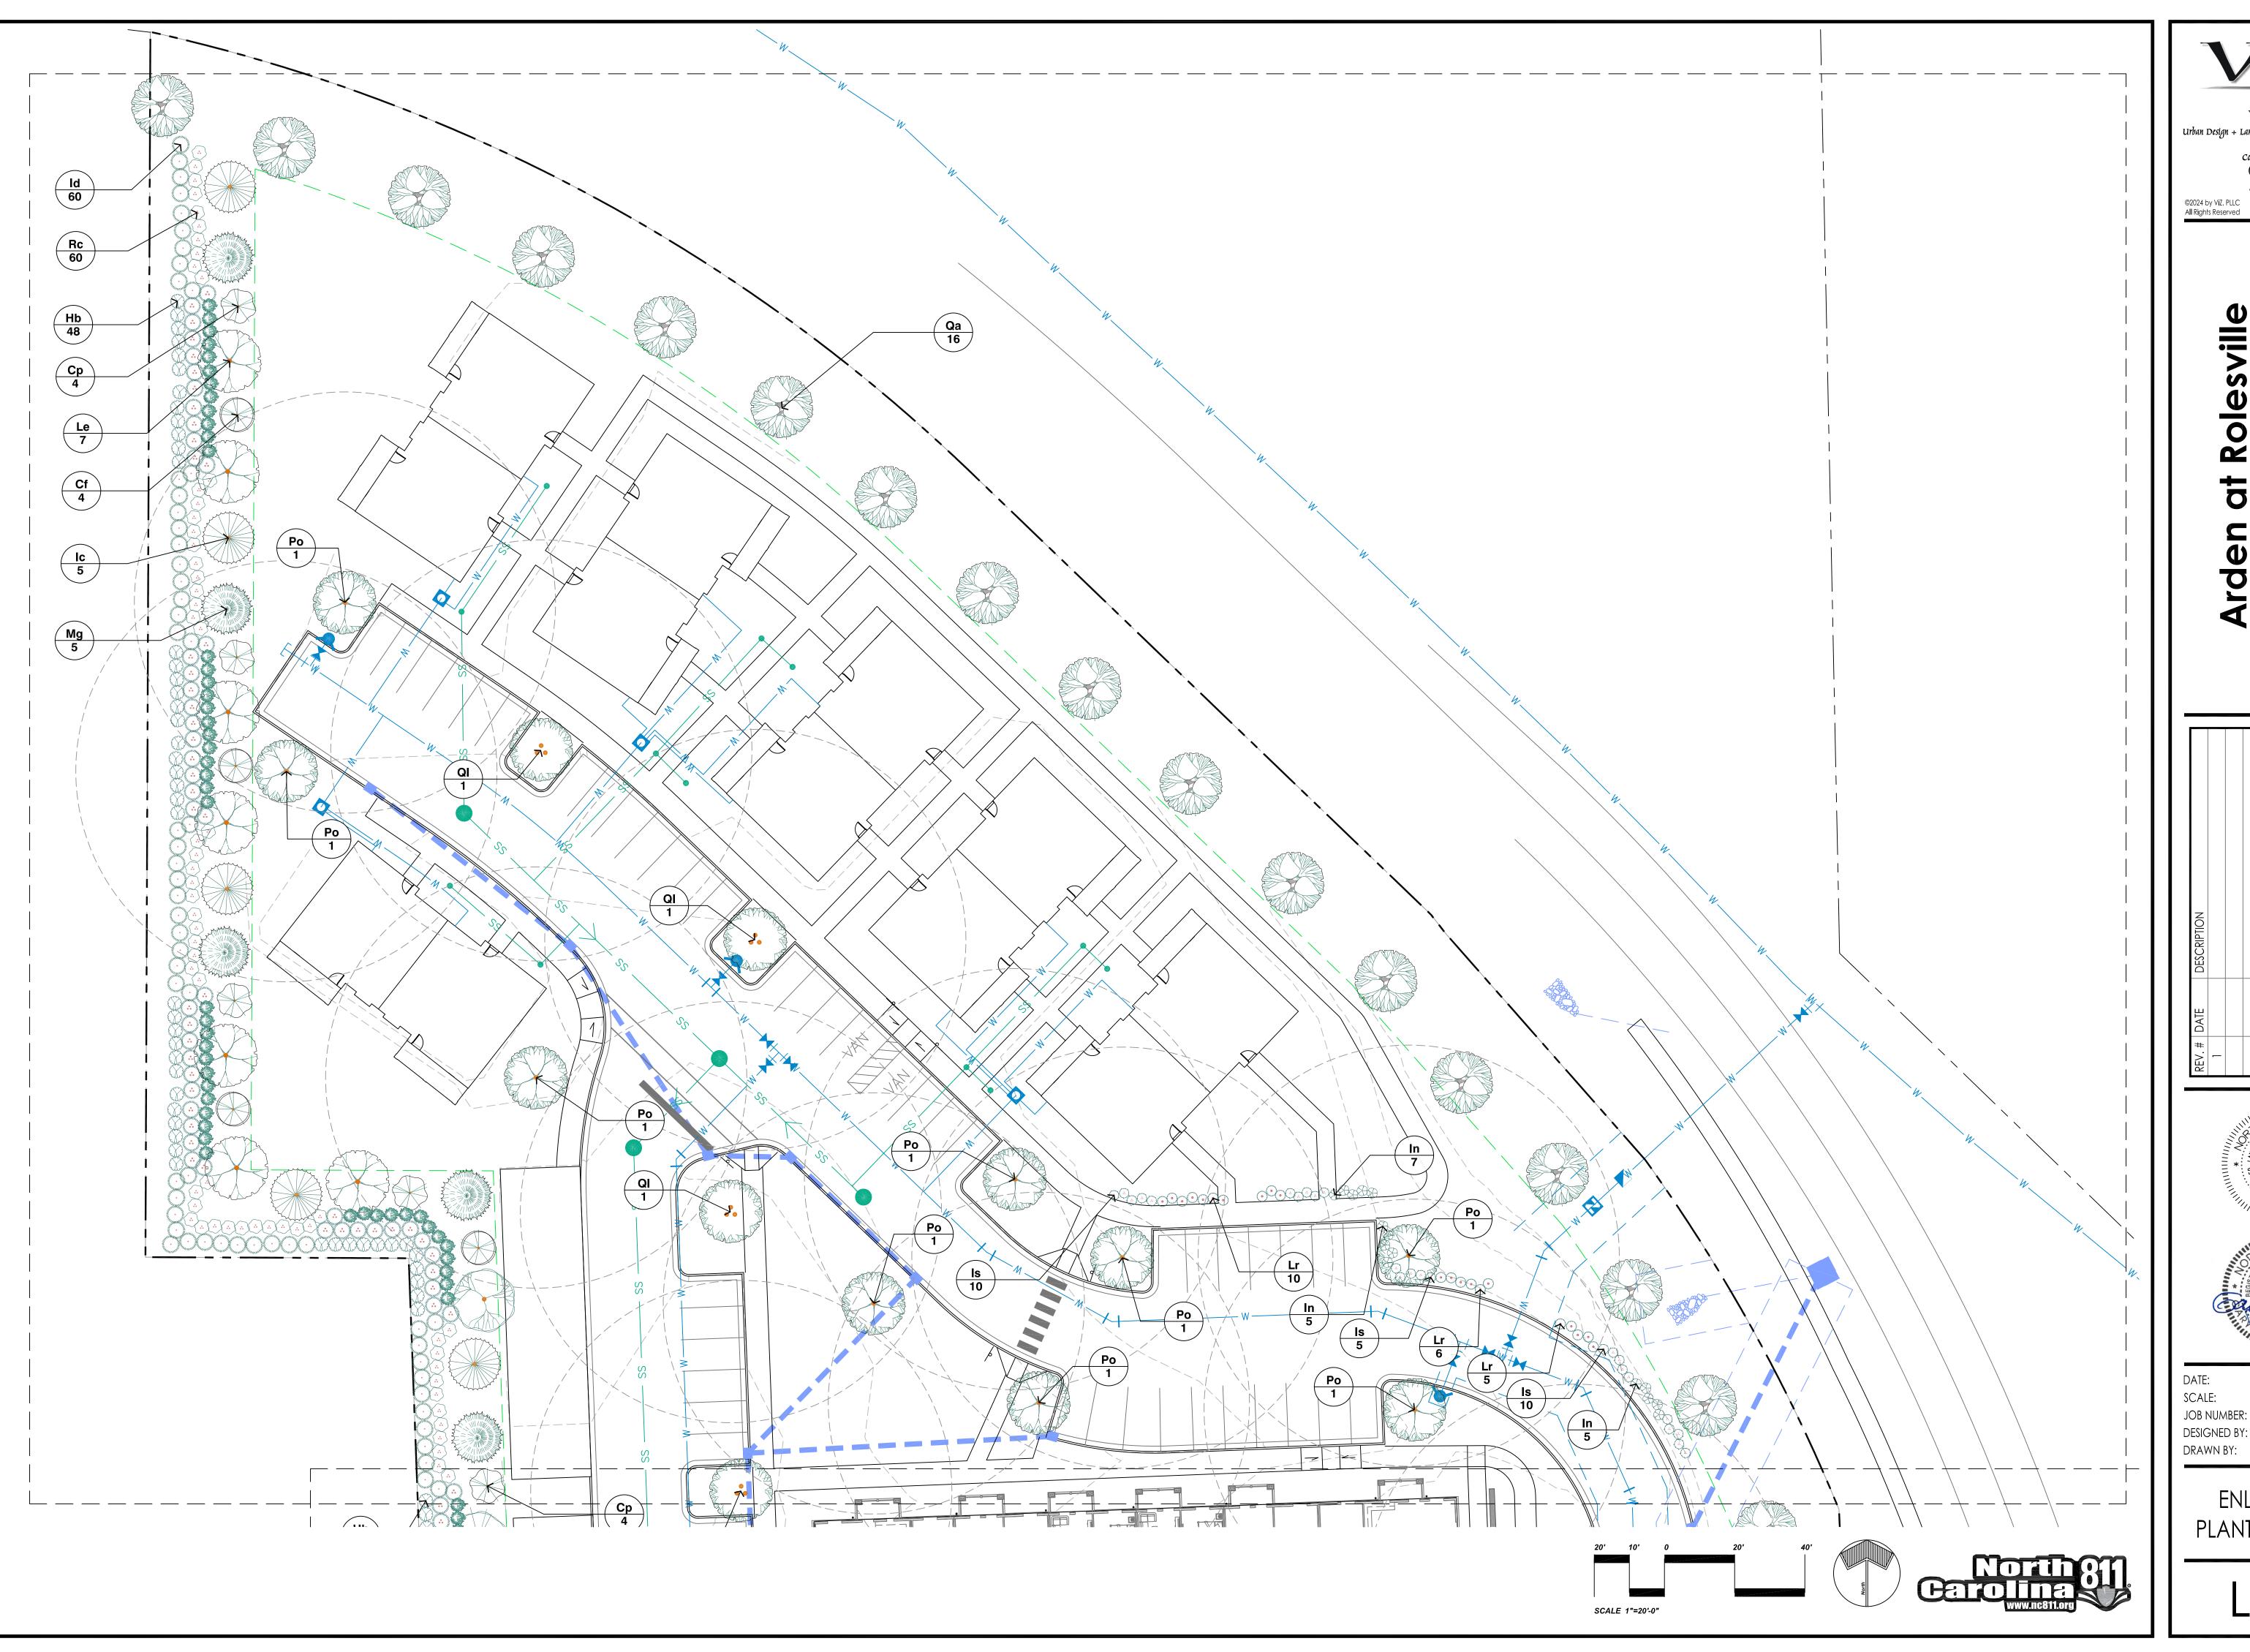




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ENLARGED PLANTING PLAN

L- I



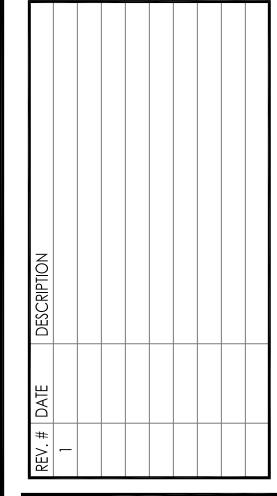


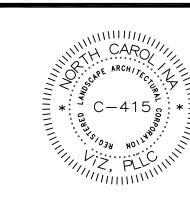
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1/2/2024 AS SHOWN 23-68.1 GRF

ENLARGED PLANTING PLAN

IRRIGATION SPECIFICATIONS

PERFORMANCE REQUIREMENTS:

IRRIGATION ZONE CONTROL SHALL BE AUTOMATIC OPERATION WITH CONTROLLER AND AUTOMATIC CONTROL VALVES.

- DELEGATED DESIGN: DESIGN 100 PERCENT COVERAGE IRRIGATION SYSTEM
- USING PERFORMANCE REQUIREMENTS AND DESIGN CRITERIA INDICATED. MINIMUM WORKING PRESSURES: THE FOLLOWING ARE MINIMUM PRESSURE REQUIREMENTS FOR PIPING, VALVES, AND SPECIALTIES UNLESS OTHERWISE

INDICATED: IRRIGATION MAIN PIPING: 65 PSI; CIRCUIT PIPING: 40 PSI. 4. ACTION SUBMITTALS:

- A. PRODUCT DATA: FOR EACH TYPE OF PRODUCT INDICATED. INCLUDE RATED CAPACITIES, OPERATING CHARACTERISTICS AND FURNISHED SPECIALTIES AND ACCESSORIES.
- B. SUSTAINABLE DESIGN SUBMITTALS: WATER CONSERVING AND LOW-FLOW **MEASURES**
- C. WIRING DIAGRAMS: FOR POWER, SIGNAL, AND CONTROL WIRING
- D. DELEGATED-DESIGN SUBMITTAL: FOR IRRIGATION SYSTEMS INDICATED TO COMPLY WITH PERFORMANCE REQUIREMENTS AND DESIGN CRITERIA
- CLOSEOUT SUBMITTALS: OPERATION AND MAINTENANCE DATA.

5. QUALITY ASSURANCE

ELECTRICAL COMPONENTS, DEVICES, AND ACCESSORIES: LISTED AND LABELED AS DEFINED IN NFPA 70, BY A QUALIFIED TESTING AGENCY, AND MARKED FOR INTENDED LOCATION AND

PIPES, TUBES, AND FITTINGS:

COMPLY WITH REQUIREMENTS IN THE PIPING SCHEDULE FOR APPLICATIONS OF PIPE, TUBE, AND FITTING MATERIALS, AND FOR JOINING METHODS FOR SPECIFIC SERVICES, SERVICE LOCATIONS, AND PIPE SIZES.

AUTOMATIC CONTROL VALVES:

- BRONZE, AUTOMATIC CONTROL VALVES: CAST-BRONZE BODY, NORMALLY DIAPHRAGM TYPE WITH MANUAL-FLOW ADJUSTMENT, AND OPERATED BY 24-V AC SOLENOID.
- B. PLASTIC, AUTOMATIC CONTROL VALVES: MOLDED-PLASTIC BODY NORMALLY CLOSED, DIAPHRAGM TYPE WITH MANUAL-FLOW ADJUSTMENT, AND OPERATED BY 24-V AC SOLENOID.

8. SPRINKLERS:

GENERAL REQUIREMENTS: DESIGNED FOR UNIFORM COVERAGE OVER ENTIRE SPRAY OR DRIP AREA INDICATED AT AVAILABLE WATER PRESSURE.

CONTROLLERS:

- A. CONTROLLER STATIONS FOR AUTOMATIC CONTROL VALVES: EACH STATION IS VARIABLE. INCLUDE SWITCH FOR MANUAL OR AUTOMATIC OPERATION OF EACH STATION.
- EXTERIOR CONTROL ENCLOSURES: NEMA 250, TYPE 4, WEATHERPROOF, WITH LOCKING COVER AND MATCHING KEYS; INCLUDE PROVISION FOR GROUNDING.
- C. INTERIOR CONTROL ENCLOSURES: NEMA 250, TYPE 12, DRIP-PROOF, WITH LOCKING COVER AND MATCHING KEYS.
- 10. CONTROL TRANSFORMER: 24-V SECONDARY, WITH PRIMARY FUSE
- 11. TIMING DEVICE: ADJUSTABLE, 24-HOUR, 14-DAY CLOCK, WITH AUTOMATIC OPERATIONS TO SKIP OPERATION ANY DAY IN TIMER PERIOD, TO OPERATE
- EVERY OTHER DAY, OR TO OPERATE TWO OR MORE TIMES DAILY. 12. MOISTURE SENSOR: ADJUSTABLE FROM ONE TO SEVEN DAYS, TO SHUT OFF WATER FLOW DURING RAIN.
- 13. WIRING: UL 493, TYPE UF MULTICONDUCTOR, WITH SOLID-COPPER CONDUCTORS; INSULATED CABLE; SUITABLE FOR DIRECT BURIAL.

14. BOXES FOR AUTOMATIC CONTROL VALVES:

- A. PLASTIC BOXES: BOX AND COVER, WITH OPEN BOTTOM AND OPENINGS FOR PIPING: DESIGNED FOR INSTALLING FLUSH WITH GRADE.
- DRAINAGE BACKFILL: WASHED GRAVEL OR CRUSHED STONE.

15. EARTHWORK:

- A. INSTALL WARNING TAPE DIRECTLY ABOVE PRESSURE PIPING, 12 INCHES BELOW FINISHED GRADES, EXCEPT 6 INCHES BELOW SUBGRADE UNDER PAVEMENT AND SLABS.
- PROVIDE MINIMUM COVER OVER TOP OF UNDERGROUND PIPING ACCORDING TO LOCAL CODE AND INDUSTRY STANDARDS.

17. PIPING INSTALLATION:

- A. SHOP DRAWINGS SHALL INDICATE LOCATION AND ARRANGEMENT OF PIPING SYSTEM. INSTALL PIPING AS INDICATED UNLESS DEVIATIONS ARE APPROVED TO COORDINATE WITH OTHER TRADES.
- INSTALL PIPING AT MINIMUM UNIFORM SLOPE OF 0.5 PERCENT DOWN VALVES. INSTALL PIPING FREE OF SAGS AND BENDS INSTALL GROUPS OF PIPES PARALLEL TO EACH OTHER, SPACED TO PERMIT VALVE SERVICING. INSTALL FITTINGS FOR CHANGES IN DIRECTION AND BRANCH CONNECTIONS. LAY PIPING ON SOLID SUBBASE, UNIFORMLY SLOPED WITHOUT HUMPS OR DEPRESSIONS.
- C. INSTALL PVC PIPING IN DRY WEATHER WHEN TEMPERATURE IS ABOVE 40 DEG F. ALLOW JOINTS TO CURE AT LEAST 24 HOURS BEFORE TESTING.
- **18. JOINT CONSTRUCTION:** JOIN WITH INSERT FITTINGS AND BANDS OR FASTENERS ACCORDING TO PIPING MANUFACTURER'S WRITTEN INSTRUCTIONS.
- 19. VALVE INSTALLATION: INSTALL UNDERGROUND VALVES IN CURB-VALVE CASINGS WITH TOPS FLUSH WITH GRADE.

20. SPRINKLER AND EMITTER INSTALLATION:

- A. INSTALL SPRINKLERS AND EMITTERS AFTER HYDROSTATIC TEST IS COMPLETED.
 - B. INSTALL SPRINKLERS AND EMITTERS AT MANUFACTURER'S RECOMMENDED HEIGHTS.

21. AUTOMATIC IRRIGATION-CONTROL SYSTEM:

- A. EQUIPMENT MOUNTING: INSTALL INTERIOR CONTROLLERS AS INDICATED ON DRAWINGS. PLACE AND SECURE ANCHORAGE DEVICES. TEMPLATES, DIAGRAMS, INSTRUCTIONS, **USE SETTING DRAWINGS** AND DIRECTIONS FURNISHED WITH ITEMS TO BE INSTALL ANCHOR BOLTS TO ELEVATIONS REQUIRED FOR PROPER ATTACHMENT TO SUPPORTED EQUIPMENT.
- EQUIPMENT MOUNTING: INSTALL EXTERIOR FREESTANDING CONTROLLERS ON CONCRETE BASES. PLACE AND SECURE ANCHORAGE DEVICES. USE SETTING DRAWINGS, TEMPLATES, DIAGRAMS, INSTRUCTIONS, AND DIRECTIONS FURNISHED WITH ITEMS TO BE EMBEDDED. ANCHOR BOLTS TO ELEVATIONS REQUIRED FOR PROPER ATTACHMENT TO SUPPORTED EQUIPMENT.
- C. INSTALL CONTROL CABLE IN SAME TRENCH AS IRRIGATION PIPING AND PROVIDE CONDUCTORS OF SIZE NOT SMALLER THAN RECOMMENDED BY CONTROLLER MANUFACTURER.
- D. INSTALL CABLE IN SEPARATE SLEEVE UNDER PAVED AREAS.
- 22. IDENTIFICATION: IDENTIFY SYSTEM COMPONENTS.
- EQUIPMENT NAMEPLATES AND SIGNS: INSTALL ENGRAVED PLASTIC-LAMINATE EQUIPMENT NAMEPLATES AND SIGNS ON EACH AUTOMATIC CONTROLLER.
- 23. WARNING TAPES: ARRANGE FOR INSTALLATION OF CONTINUOUS UNDERGROUND, DETECTABLE WARNING TAPES OVER UNDERGROUND PIPING DURING BACKFILLING OF TRENCHES.

24. FIELD QUALITY CONTROL: PERFORM TESTS AND INSPECTIONS.

- A. LEAK TEST: AFTER INSTALLATION, CHARGE SYSTEM AND TEST FOR LEAKS. REPAIR LEAKS AND RETEST UNTIL NO LEAKS EXIST.
- B. OPERATIONAL TEST: AFTER ELECTRICAL CIRCUITRY HAS BEEN ENERGIZED OPERATE CONTROLLERS AND AUTOMATIC CONTROL VALVES TO CONFIRM PROPER SYSTEM OPERATION.
- C. TEST AND ADJUST CONTROLS AND SAFETIES. REPLACE DAMAGED AND MALFUNCTIONING CONTROLS AND EQUIPMENT. ANY IRRIGATION PRODUCT WILL BE CONSIDERED DEFECTIVE IF IT DOES NOT PASS TESTS AND INSPECTIONS.

PREPARE TEST AND INSPECTION REPORTS

25. ADJUSTING: ADJUST SETTINGS OF CONTROLLERS.

- A. ADJUST AUTOMATIC CONTROL VALVES TO PROVIDE FLOW RATE AT RATED PRESSURE REQUIRED FOR EACH SPRINKLER CIRCUIT. OPERATING
- RELATION TO PLANTS AND FINISH GRADE.

PLANTING SPECIFICATIONS

1. PLANT MATERIAL

- A. FURNISH NURSERY-GROWN PLANTS INDICATED IN PLANT LEGEND SHOWN ON DRAWINGS AND COMPLYING WITH ANSI Z60.1 - 2014, AMERICAN STANDARD FOR NURSERY STOCK
- B. ANNUALS: PROVIDE HEALTHY, DISEASE-FREE PLANTS OF SPECIES AND VARIETY SHOWN OR LISTED, WITH WELL-ESTABLISHED ROOT SYSTEMS. PROVIDE ONLY PLANTS THAT ARE ACCLIMATED TO OUTDOOR CONDITIONS BEFORE DELIVERY
- C. CONTRACTOR SHALL PROVIDE A ONE YEAR WARRANTY FROM FINAL ACCEPTANCE ON ALL PLANTS UNLESS APPROVED OTHERWISE BY THE OWNER.

2. SOIL AMENDMENTS AS REQUIRED FROM SOILS REPORT/TESTING

- A. LIME: ASTM C 602, AGRICULTURAL LIMING MATERIAL CONTAINING A MINIMUM OF 80 PERCENT CALCIUM CARBONATE EQUIVALENT.
- B. SULFUR: GRANULAR, BIODEGRADABLE, AND CONTAINING A MINIMUM OF 90 PERCENT SULFUR.
- C. IRON SULFATE: GRANULATED FERROUS SULFATE CONTAINING A MINIMUM OF 20 PERCENT IRON AND 10 PERCENT SULFUR.
- D. ALUMINUM SULFATE: COMMERCIAL GRADE, UNADULTERATED
- E. PERLITE: HORTICULTURAL PERLITE, SOIL AMENDMENT GRADE.
- F. AGRICULTURAL GYPSUM: MINIMUM 90 PERCENT CALCIUM SULFATE.
- G. SAND: CLEAN, WASHED, NATURAL OR MANUFACTURED, AND FREE OF TOXIC MATERIALS. H. COMPOST: WELL-COMPOSTED, STABLE, AND WEED-FREE ORGANIC MATTER, PH RANGE OF 5.5 TO 8; MOISTURE CONTENT 35 TO 55 PERCENT BY WEIGHT; 100 PERCENT PASSING
- THROUGH 3/4-INCH SIEVE I. SPHAGNUM PEAT: PARTIALLY DECOMPOSED SPHAGNUM PEAT MOSS, FINELY DIVIDED OR GRANULAR TEXTURE, WITH A PH RANGE OF 3.4 TO 4.8.
- J. MANURE: WELL-ROTTED, UNLEACHED, STABLE OR CATTLE MANURE CONTAINING NOT MORE THAN 25 PERCENT BY VOLUME OF STRAW, SAWDUST, OR OTHER BEDDING MATERIALS; FREE OF TOXIC SUBSTANCES, STONES, STICKS, SOIL, WEED SEED, DEBRIS, AND MATERIAL HARMFUL TO PLANT GROWTH.

3. FERTILIZERS

- A. BONEMEAL: COMMERCIAL, RAW OR STEAMED, FINELY GROUND; A MINIMUM OF 1 PERCENT NITROGEN AND 10 PERCENT PHOSPHORIC ACID.
- B. SUPERPHOSPHATE: COMMERCIAL, PHOSPHATE MIXTURE, SOLUBLE; A MINIMUM OF 20 PERCENT AVAILABLE PHOSPHORIC ACID.
- C. COMMERCIAL FERTILIZER: COMMERCIAL-GRADE COMPLETE FERTILIZER OF NEUTRAL CHARACTER, CONSISTING OF FAST- AND SLOW-RELEASE NITROGEN.

D. SLOW-RELEASE FERTILIZER: GRANULAR OR PELLETED FERTILIZER.

4. PLANTING MIX

- A. PLANTING MIX: SHALL BE NATURAL, FERTILE, AGRICULTURAL TOPSOIL, CAPABLE OF SUSTAINING VIGOROUS PLANT GROWTH, WITH PH RANGE OF 5.5 TO 7. IT MAY BE DEVELOPED BY AMENDING THE EXISTING SOIL, OR REMOVING THE EXISTING SOIL AND REPLACING WITH NEW SOIL. IT SHALL BE FREE OF ROOTS, PLANTS, SOD, STONES, CLODS, CLAY LUMPS, POCKETS OF COARSE SAND, CONCRETE SLURRY, CONCRETE LAYERS OR CHUNKS, CEMENT, PLASTER BUILDING DEBRIS, AND OTHER EXTRANEOUS MATERIALS HARMFUL TO PLANT GROWTH PLANTING MIX SHALL NOT BE USED WHILE IN A FROZEN OR MUDDY CONDITION. UNLESS OTHERWISE SPECIFIED, THE PLANTING MIX SHALL CONTAIN THE FOLLOWING PERCENTAGES: MIN. 10% - MAX. 30% (RED CLAY WELL PULVERIZED); CLAY SHALL BE STERILE. CLAY:
 - MIN. 30% MAX. 50%
- COARSE SAND: MIN. 30% MAX. 45% (1.0mm TO 0.5mm DIA., AND FREE OF ROCK) ORGANIC MAT.:MIN. 5% (COMPOST/HUMUS SUCH AS SAWDUST OR LEAF MOLD THAT
- IS DECOMPOSED) • ELEMENTS: CALCIUM 55% - 80%; MAGNESIUM 10% - 30%; POTASSIUM 5% - 8%

B. CONTRACTOR TO PROVIDE SOILS TEST/ANALYSIS INDICATING ABOVE REQUIREMENTS

5. MULCHES A. DOUBLE HAMMERED HARDWOOD MULCH FOR ALL PLANT BEDS UNLESS OTHERWISE INDICATED.

- 6. PLANT BED ESTABLISHMENT B. ADJUST SPRINKLERS AND EMITTERS SO THEY WILL BE PROPERLY LOCATED IN A. LAYOUT PLANT BEDS AS INDICATED ON THE PLANTING PLAN AND REMOVE UNNECESSARY MATERIAL TO A MINIMUM DEPTH OF 18 INCHES.
 - B. LOOSEN SUBGRADE OF PLANTING BEDS TO A MINIMUM DEPTH OF 6 INCHES. REMOVE STONES LARGER THAN 1 INCH IN ANY DIMENSION AND STICKS, ROOTS, RUBBISH, AND OTHER EXTRANEOUS MATTER AND LEGALLY DISPOSE OF THEM OFF OWNER'S PROPERTY. C. SPREAD PLANTING MIX (SEE 4 ABOVE) TO A DEPTH OF 18 INCHES BUT NOT LESS THAN
 - REQUIRED TO MEET FINISH GRADES AFTER NATURAL SETTLEMENT. DO NOT SPREAD IF PLANTING MIX OR SUBGRADE IS FROZEN, MUDDY, OR EXCESSIVELY WET. D. FINISH GRADING: GRADE PLANTING BEDS TO A SMOOTH, UNIFORM SURFACE PLANE WITH LOOSE, UNIFORMLY FINE TEXTURE. ROLL AND RAKE, REMOVE RIDGES, AND FILL DEPRESSIONS

TO MEET FINISH GRADES. 7. EXCAVATION FOR TREES AND SHRUBS

- A. PLANTING PITS AND TRENCHES: EXCAVATE CIRCULAR PLANTING PITS WITH SIDES SLOPING INWARD AT A 45-DEGREE ANGLE. EXCAVATIONS WITH VERTICAL SIDES ARE NOT ACCEPTABLE. TRIM PERIMETER OF BOTTOM LEAVING CENTER AREA OF BOTTOM RAISED SLIGHTLY TO SUPPORT ROOT BALL AND ASSIST IN DRAINAGE AWAY FROM CENTER. DO NOT FURTHER DISTURB BASE. ENSURE THAT ROOT BALL WILL SIT ON UNDISTURBED BASE SOIL TO PREVENT SETTLING. SCARIFY SIDES OF PLANTING PIT SMEARED OR SMOOTHED DURING EXCAVATION.
- B. EXCAVATE APPROXIMATELY THREE TIMES AS WIDE AS BALL DIAMETER.
- C.DO NOT EXCAVATE DEEPER THAN DEPTH OF THE ROOT BALL, MEASURED FROM THE ROOT FLARE TO THE BOTTOM OF THE ROOT BALL.
- D. SUBSOIL AND TOPSOIL REMOVED FROM EXCAVATIONS MAY NOT BE USED SOLELY AS PLANTING MIX (SEE NOTE 4 ABOVE).

PLANTING SPECIFICATIONS (CONT.)

8. TREE, SHRUB, AND VINE PLANTING

- A. BEFORE PLANTING, VERIFY THAT ROOT FLARE IS VISIBLE AT TOP OF ROOT BALL ACCORDING TO ANSI Z60.1.
- B. REMOVE STEM GIRDLING ROOTS AND KINKED ROOTS. REMOVE INJURED ROOTS BY CUTTING CLEANLY; DO NOT BREAK.
- C. SET STOCK PLUMB AND IN CENTER OF PLANTING PIT OR TRENCH WITH ROOT FLARE
- INCH ABOVE ADJACENT FINISH GRADES.
- D. USE PLANTING SOIL FOR BACKFILL
- E. BALLED AND BURLAPPED: AFTER PLACING SOME BACKFILL AROUND ROOT BALL TO STABILIZE PLANT, CAREFULLY CUT AND REMOVE BURLAP, ROPE, AND WIRE BASKETS FROM TOPS OF ROOT BALLS AND FROM SIDES, BUT DO NOT REMOVE FROM UNDER ROOT BALLS. REMOVE PALLETS, IF ANY, BEFORE SETTING. DO NOT USE PLANTING STOCK IF ROOT BALL IS CRACKED OR BROKEN BEFORE OR DURING PLANTING OPERATION
- F. CONTAINER-GROWN: CAREFULLY REMOVE ROOT BALL FROM CONTAINER WITHOUT DAMAGING ROOT BALL OR PLANT.
- G.BACKFILL AROUND ROOT BALL IN LAYERS, TAMPING TO SETTLE SOIL AND ELIMINATE VOIDS AND AIR POCKETS. WHEN PLANTING PIT IS APPROXIMATELY ONE-HALF FILLED, WATER THOROUGHLY BEFORE PLACING REMAINDER OF BACKFILL. REPEAT WATERING UNTIL NO MORE WATER IS ABSORBED.
- H. CONTINUE BACKFILLING PROCESS. WATER AGAIN AFTER PLACING AND TAMPING FINAL LAYER OF SOIL
- I. WHEN PLANTING ON SLOPES, SET THE PLANT SO THE ROOT FLARE ON THE UPHILL SIDE IS FLUSH WITH THE SURROUNDING SOIL ON THE SLOPE; THE EDGE OF THE ROOT BALL ON THE DOWNHILL SIDE WILL BE ABOVE THE SURROUNDING SOIL. APPLY ENOUGH SOIL TO COVER THE DOWNHILL SIDE OF THE ROOT BALL
- J. PRUNE/REMOVE ONLY DEAD, DYING, OR BROKEN BRANCHES. DO NOT PRUNE FOR SHAPE. PRUNE TO RETAIN NATURAL CHARACTER.
- K. PRUNE, THIN, AND SHAPE TREES, SHRUBS, AND VINES ACCORDING TO STANDARD PROFESSIONAL HORTICULTURAL AND ARBORICULTURAL PRACTICES FOR NEWLY PLANTED PLANTS. UNLESS OTHERWISE INDICATED BY LANDSCAPE ARCHITECT, DO NOT CUT TREE LEADERS

- A. SET OUT AND SPACE GROUND COVER, PERENNIALS, AND/OR ANNUALS AS INDICATED
- D. WORK SOIL AROUND ROOTS TO ELIMINATE AIR POCKETS AND LEAVE A SLIGHT SAUCER
- E. WATER THOROUGHLY AFTER PLANTING, TAKING CARE NOT TO COVER PLANT CROWNS WITH WET SOIL.
- F. PROTECT PLANTS FROM HOT SUN AND WIND; REMOVE PROTECTION IF PLANTS SHOW EVIDENCE OF RECOVERY FROM TRANSPLANTING SHOCK.

- B. TREES AND TREE-FORM SHRUBS IN TURF AREAS: APPLY ORGANIC MULCH RING OF 3-INCH AVERAGE THICKNESS, WITH MINIMUM 36-INCH RADIUS AROUND TRUNKS OR STEMS. DO NOT PLACE MULCH WITHIN 3 INCHES OF TRUNKS OR STEMS.
- C. ORGANIC MULCH IN PLANT BEDS: APPLY 3-INCH AVERAGE THICKNESS OF MULCH OVER ENTIRE SURFACE OF PLANT BED, AND FINISH LEVEL WITH ADJACENT FINISH GRADES. DO NOT PLACE MULCH WITHIN 2 INCHES OF TRUNKS OR STEMS.

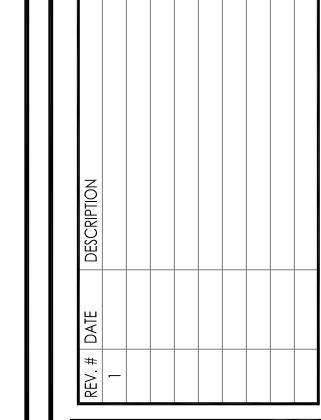
11. PLANT MAINTENANCE

- A. MAINTAIN PLANTINGS BY PRUNING, CULTIVATING, WATERING, WEEDING, FERTILIZING MULCHING, RESTORING PLANTING SAUCERS, RESETTING TO PROPER GRADES OR VERTICAL POSITION, AND PERFORMING OTHER OPERATIONS AS REQUIRED TO ESTABLISH HEALTHY, VIABLE PLANTINGS. SPRAY OR TREAT AS REQUIRED TO KEEP TREES AND SHRUBS FREE OF INSECTS AND DISEASE.
- B. SET IRRIGATION SYSTEM FOR ZONE DURATION APPLICABLE FOR NEWLY PLANTED PLANTS
- IF APPLICABLE. C. FILL IN AS NECESSARY SOIL SUBSIDENCE THAT MAY OCCUR BECAUSE OF SETTLING OR OTHER PROCESSES. REPLACE MULCH MATERIALS DAMAGED OR LOST IN AREAS OF SUBSIDENCE.
- D. APPLY TREATMENTS AS REQUIRED TO KEEP PLANT MATERIALS, PLANTED AREAS, AND SOILS FREE OF PESTS AND PATHOGENS OR DISEASE. USE PRACTICES TO MINIMIZE THE USE OF PESTICIDES AND REDUCE HAZARDS.
- E. APPLY PESTICIDES AND OTHER CHEMICAL PRODUCTS AND BIOLOGICAL CONTROL AGENTS IN ACCORDANCE WITH AUTHORITIES HAVING JURISDICTION AND MANUFACTURER'S WRITTEN RECOMMENDATIONS. COORDINATE APPLICATIONS WITH OWNER'S OPERATIONS AND OTHERS IN PROXIMITY TO THE WORK. NOTIFY OWNER BEFORE EACH APPLICATION IS PERFORMED.

F. PROTECT PLANTS FROM DAMAGE DUE TO LANDSCAPE OPERATIONS AND OPERATIONS

AND MAINTENANCE PERIODS. TREAT, REPAIR, OR REPLACE DAMAGED PLANTINGS.

OF OTHER CONTRACTORS AND TRADES. MAINTAIN PROTECTION DURING INSTALLATION



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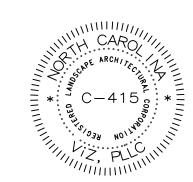
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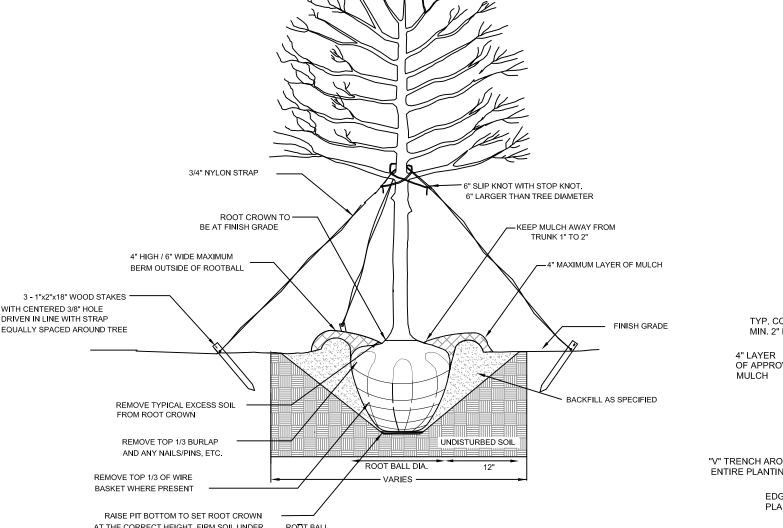
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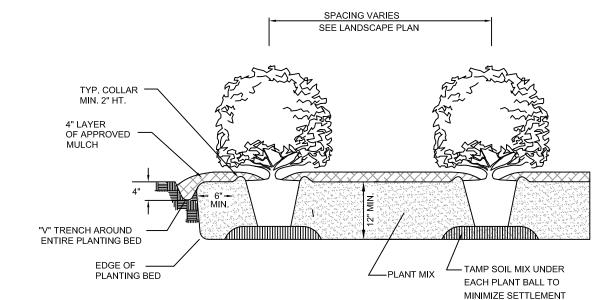
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PLANTING AND IRRIGATION NOTES & **SPECIFICATIONS**

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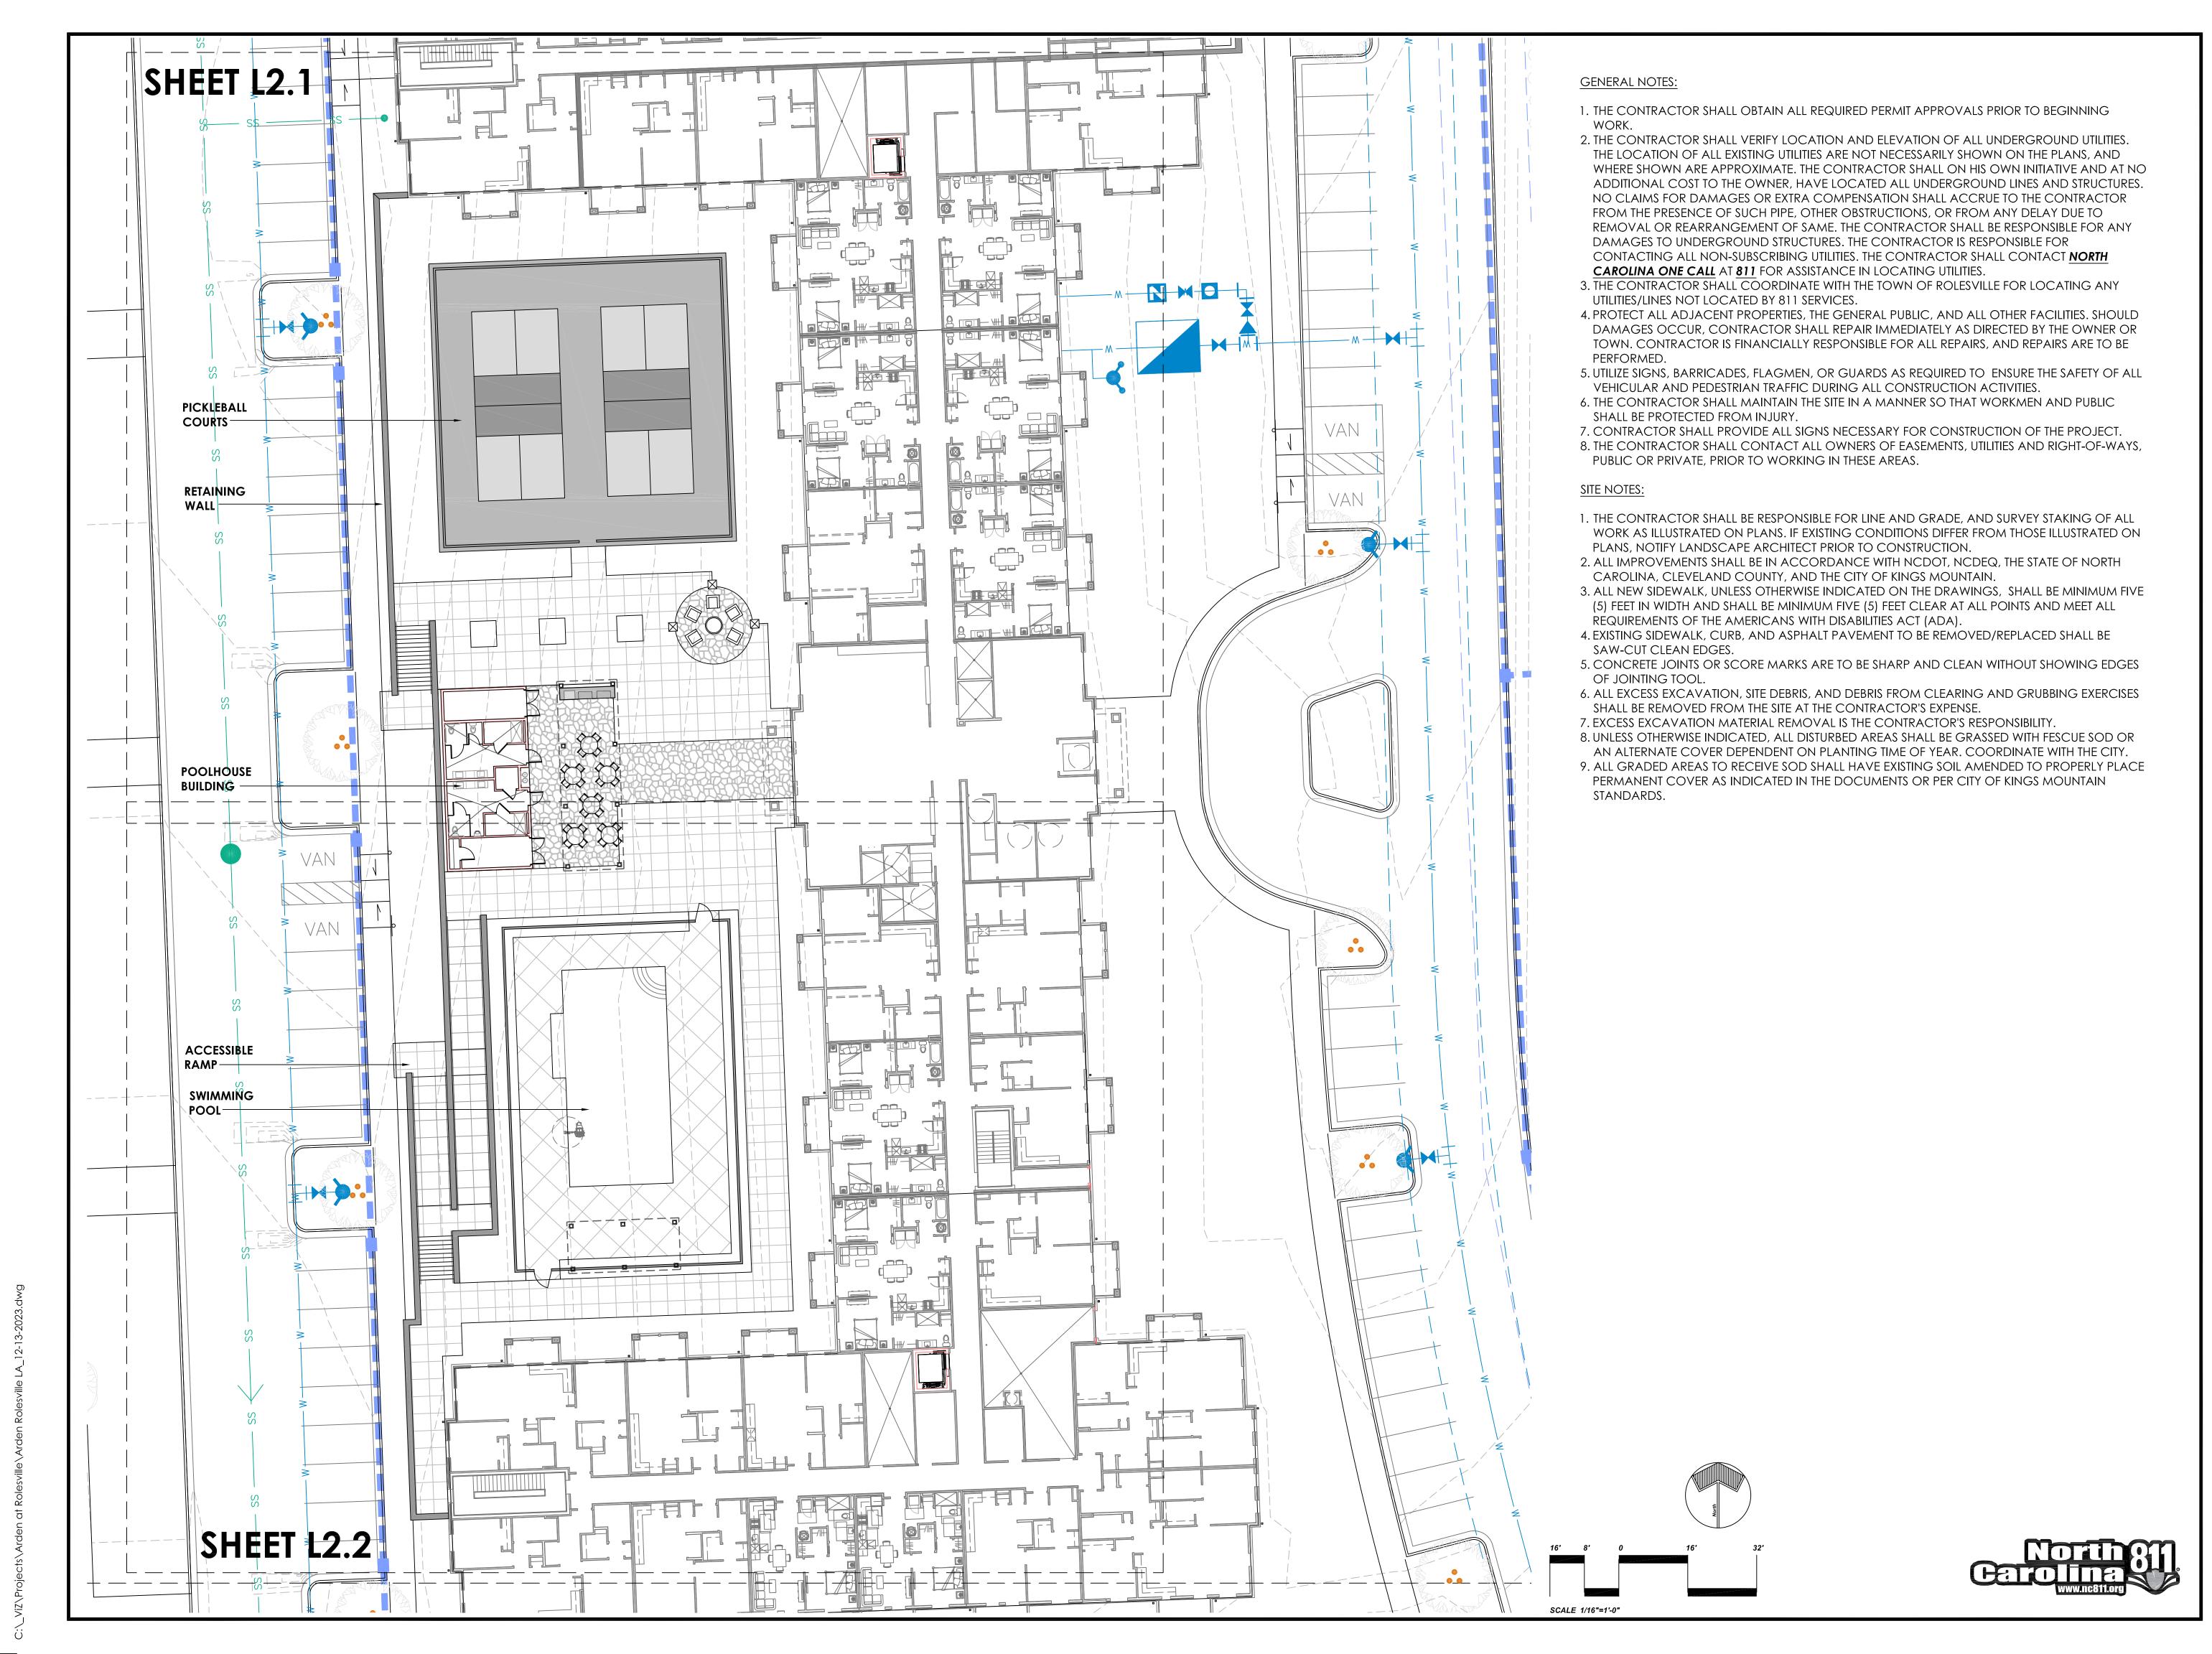


9. GROUND COVER, PERENNIAL, AND ANNUAL PLANTING

- IN EVEN ROWS WITH TRIANGULAR SPACING.
- B. USE PLANTING MIX FOR BACKFILL
- C. DIG HOLES LARGE ENOUGH TO ALLOW SPREADING OF ROOTS.
- INDENTATION AROUND PLANTS TO HOLD WATER.

10. PLANT AND PLANT BED MULCHING

- A. MULCH BACKFILLED SURFACES OF PLANTING BEDS AND OTHER AREAS INDICATED.





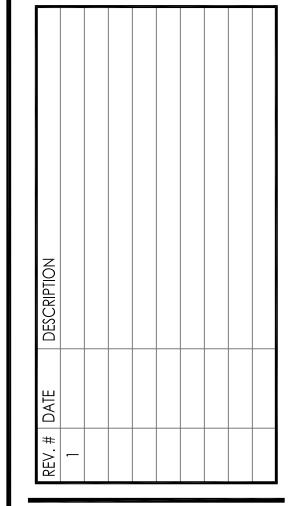
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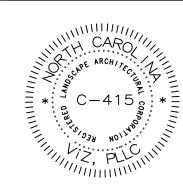
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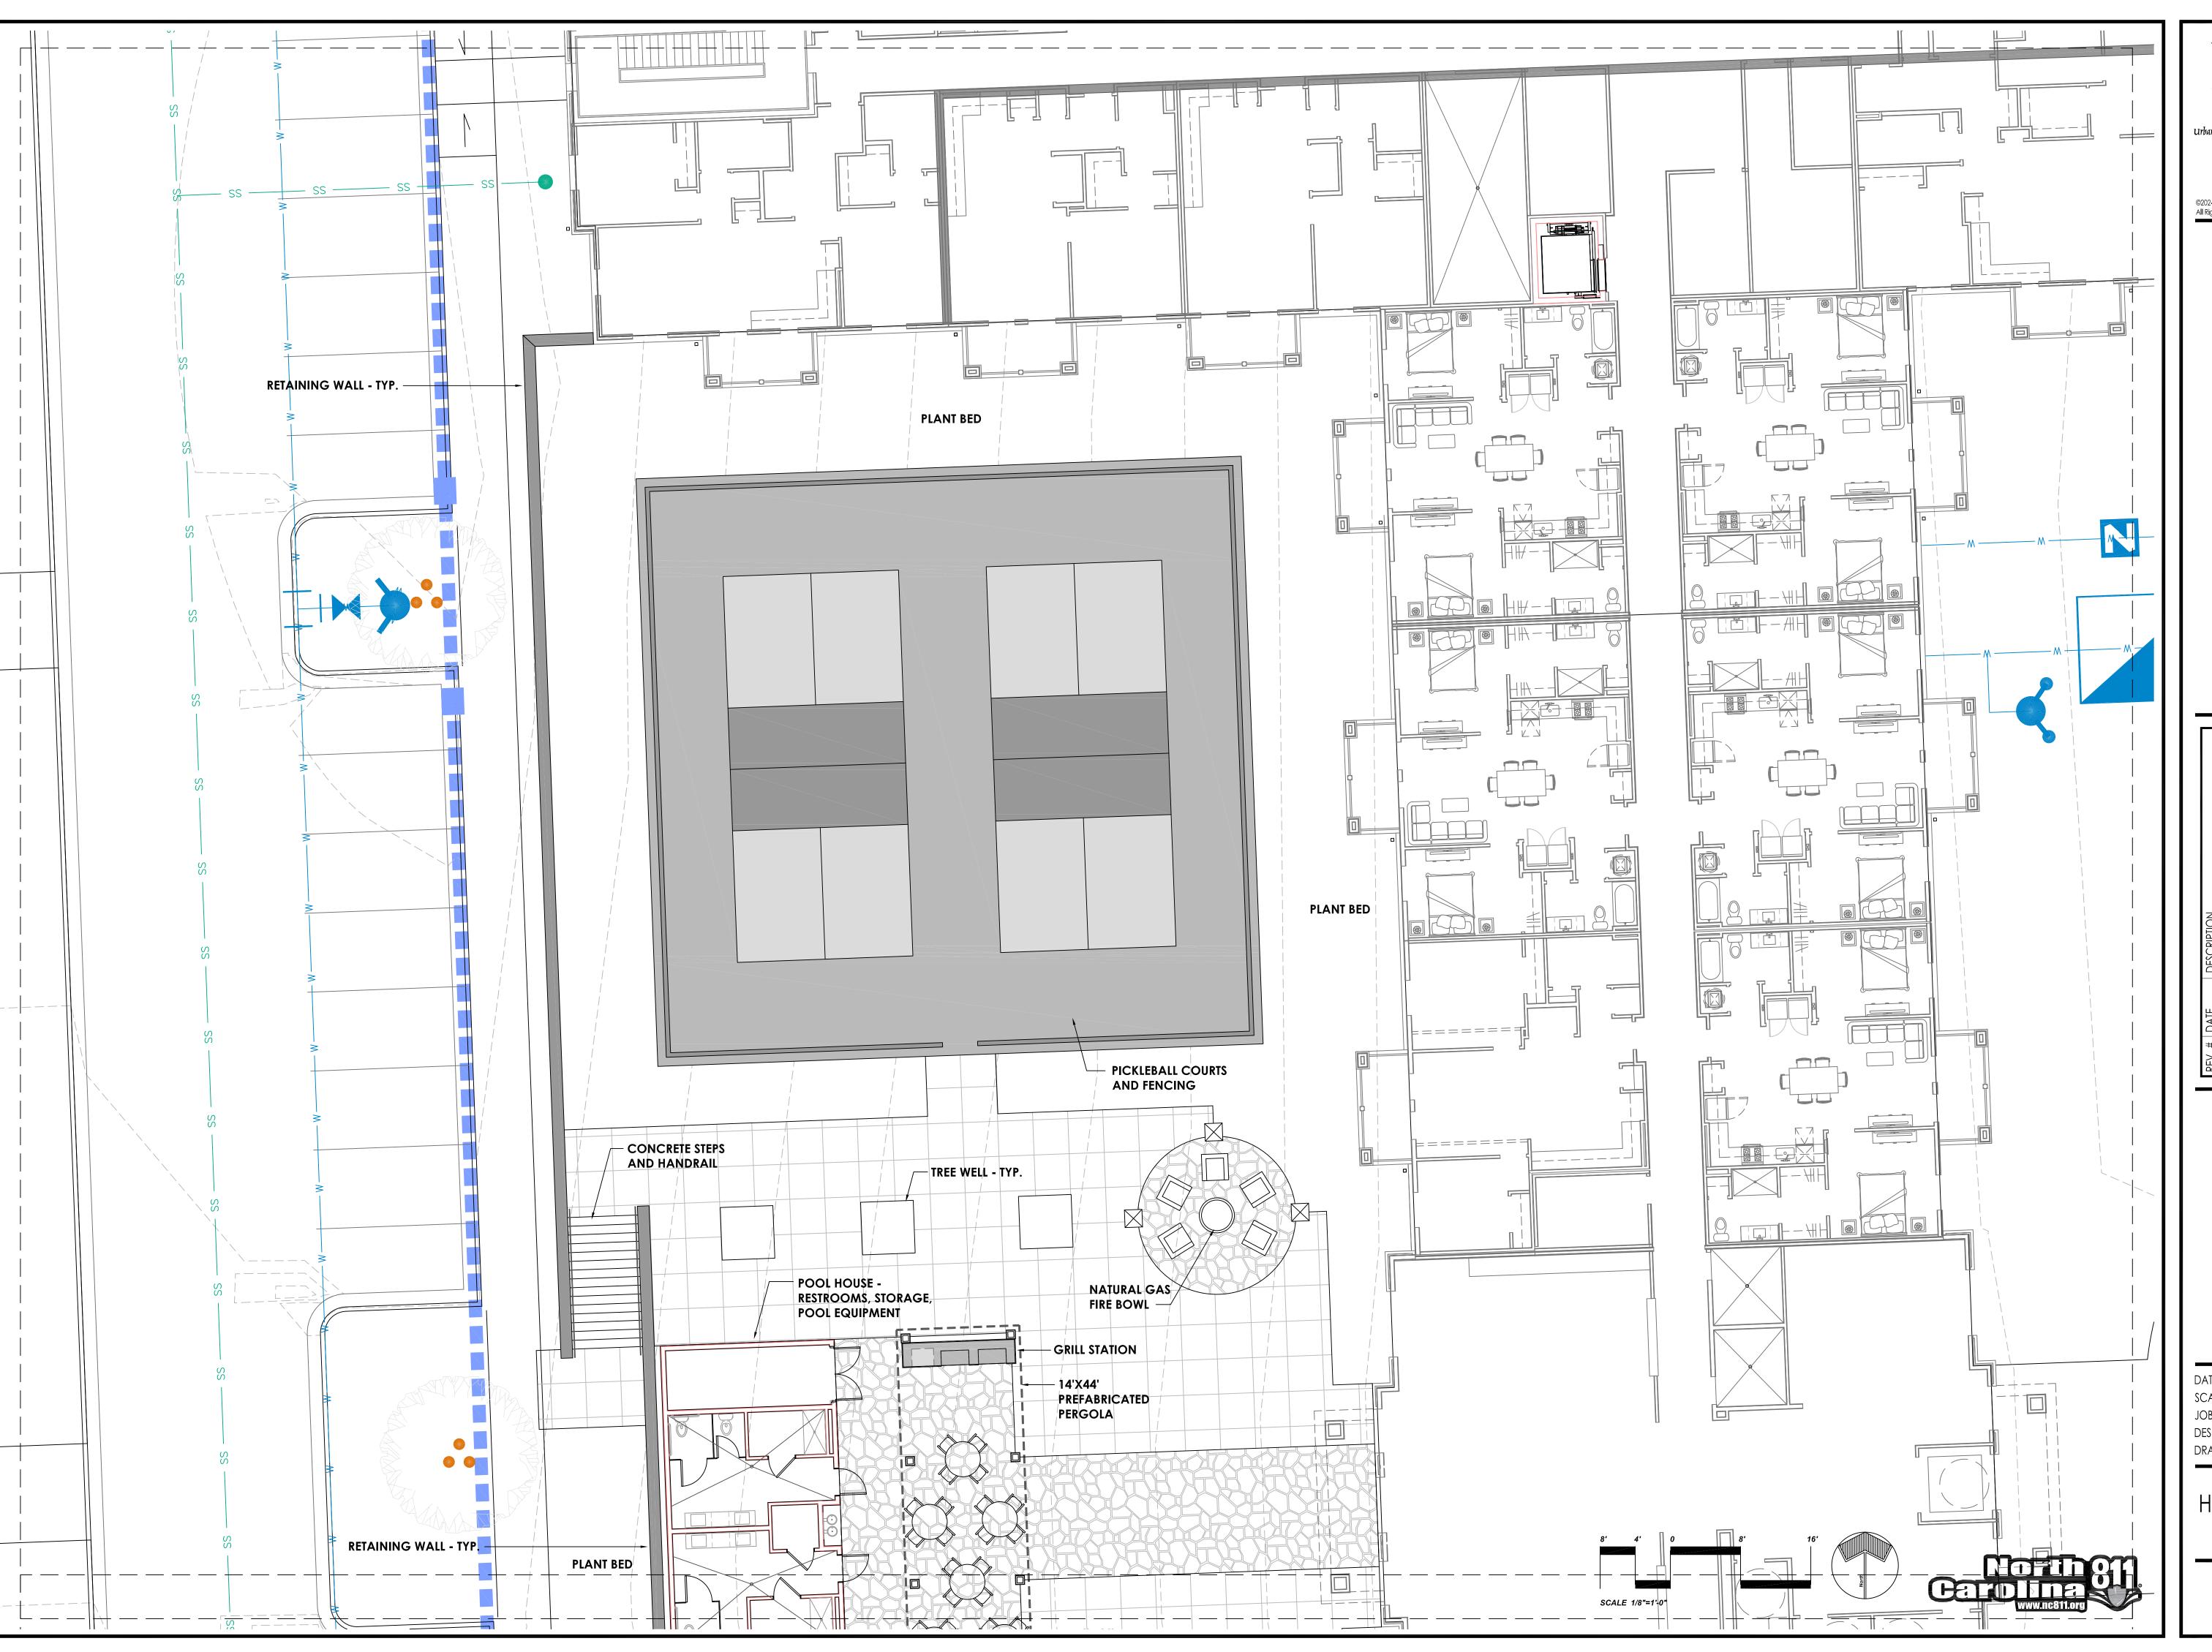
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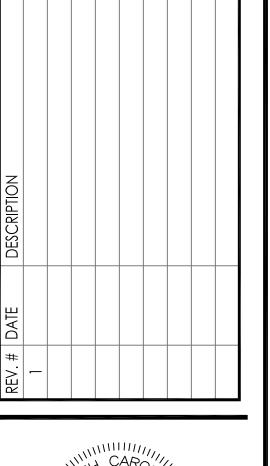
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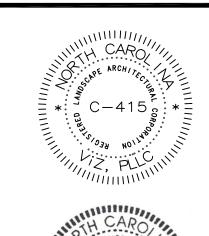
OVERALL AMENITY AREA HARDSCAPE PLAN

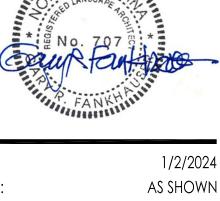


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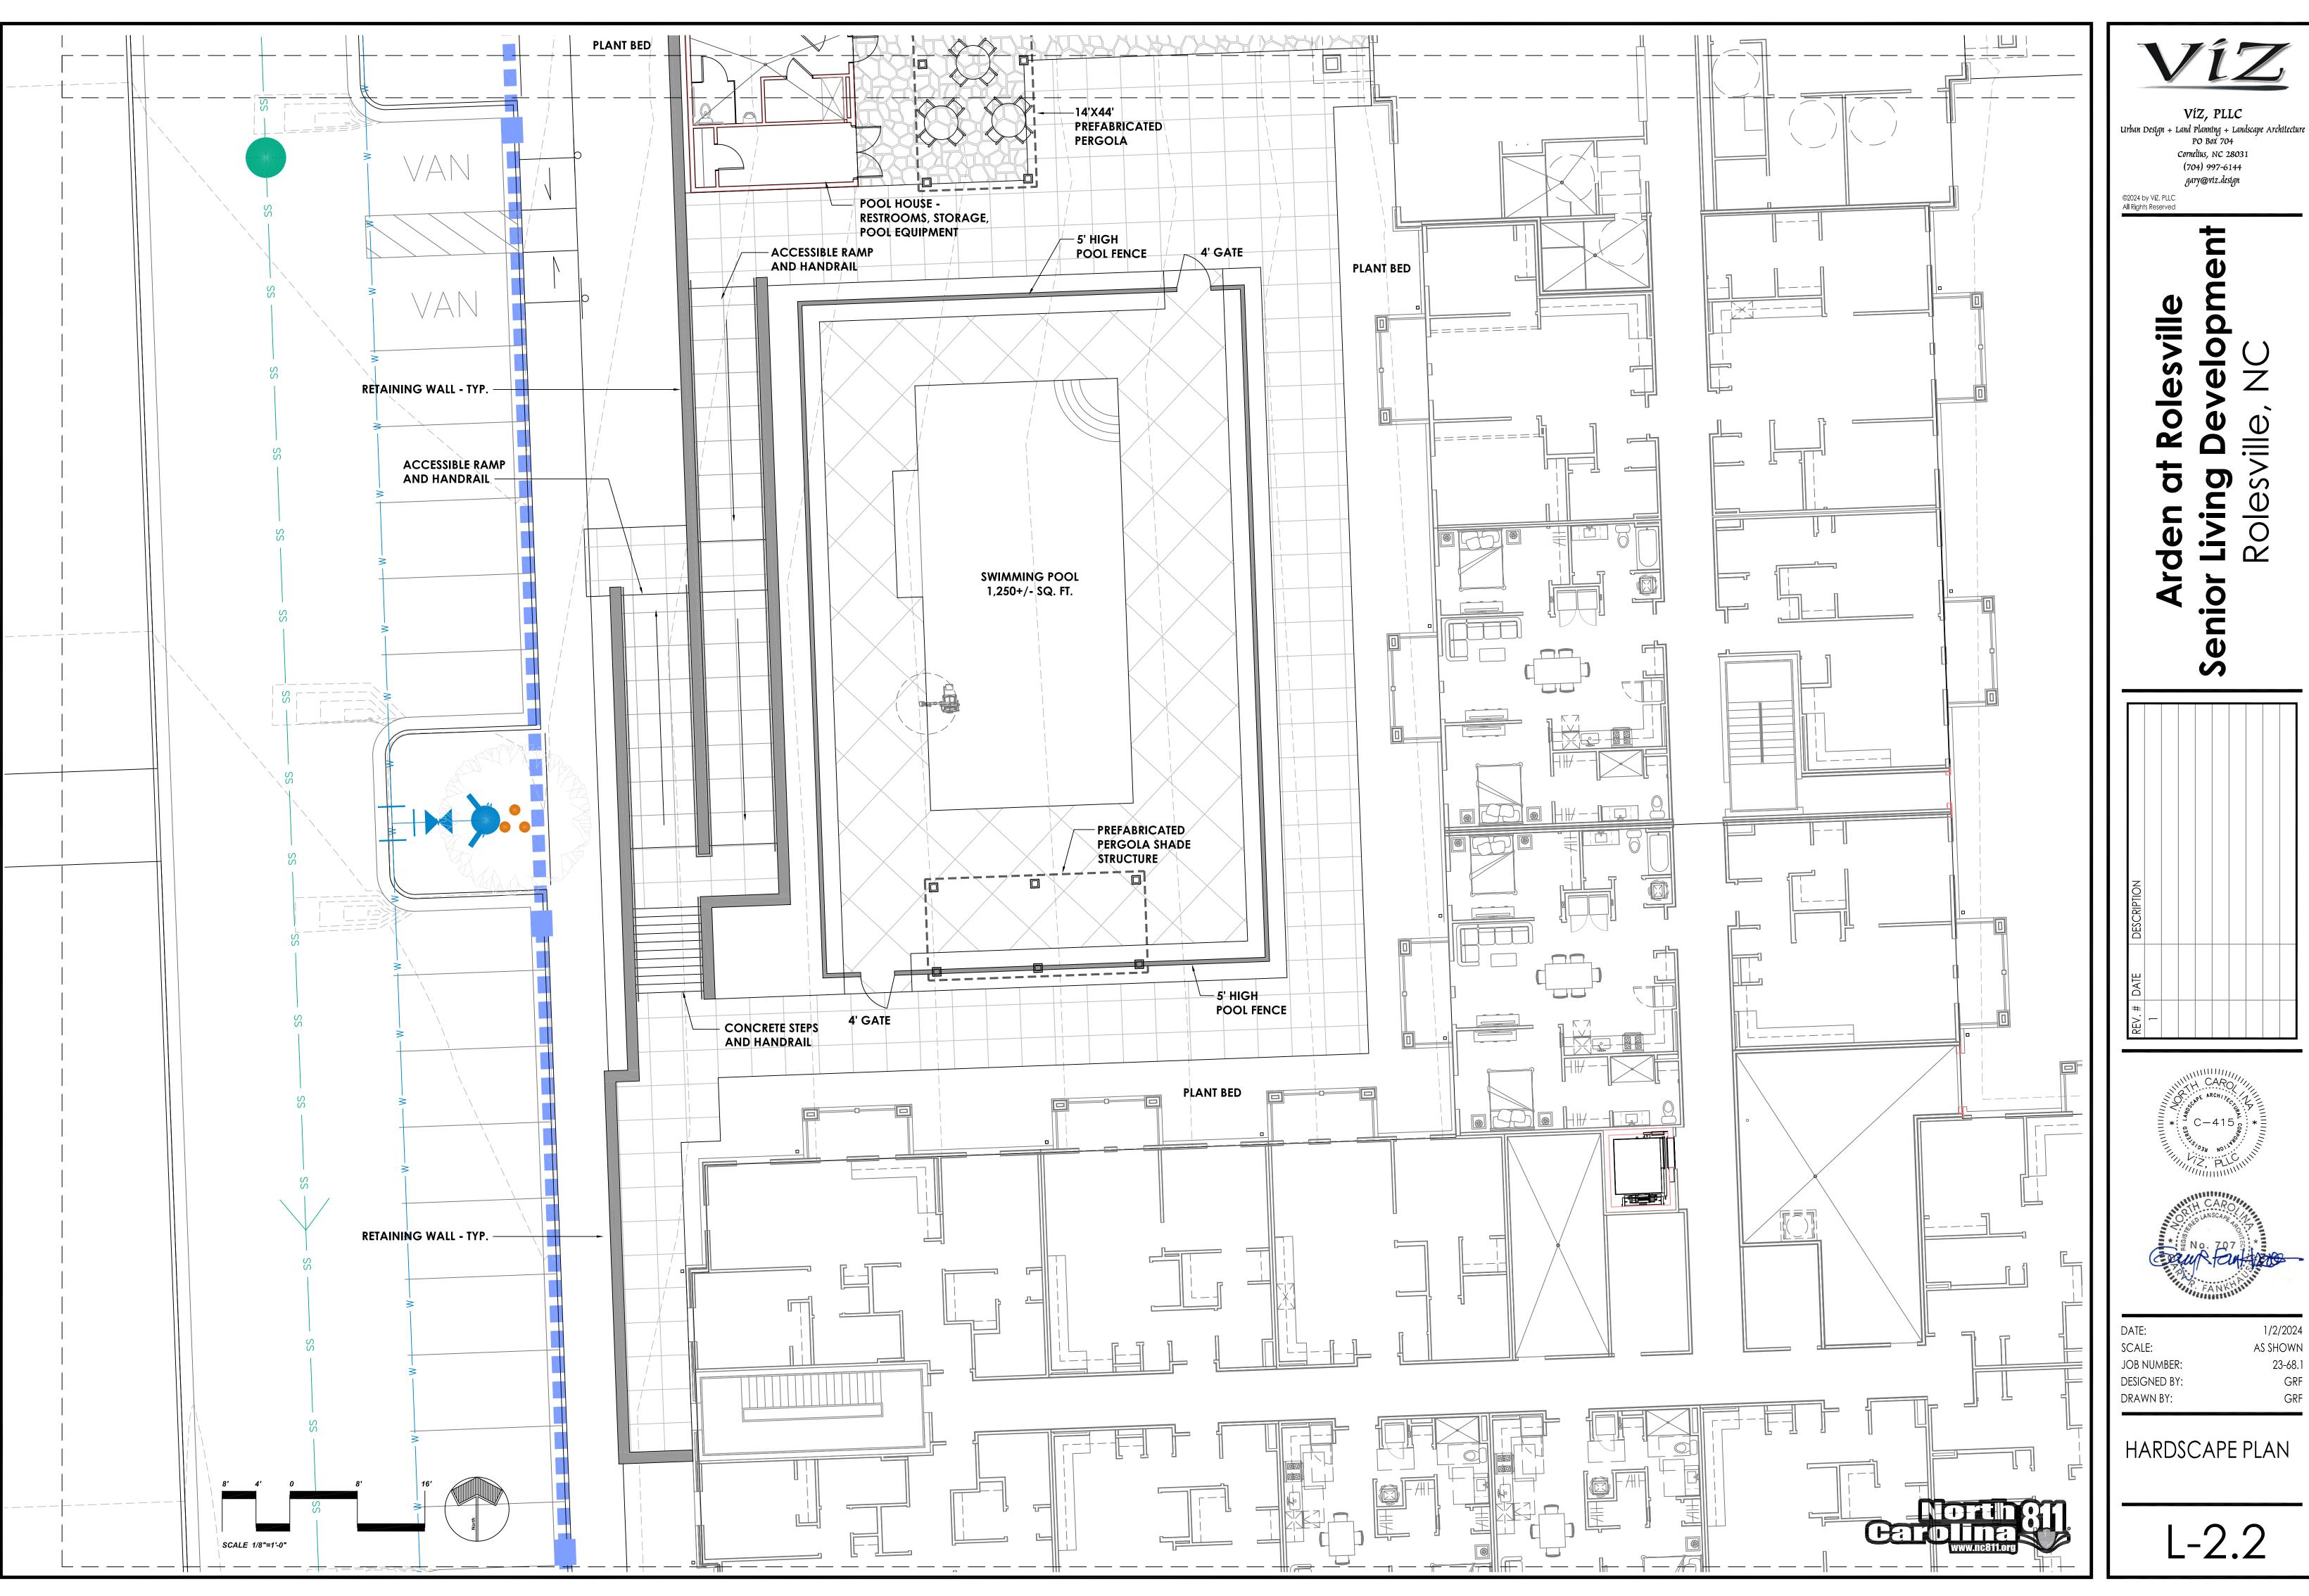




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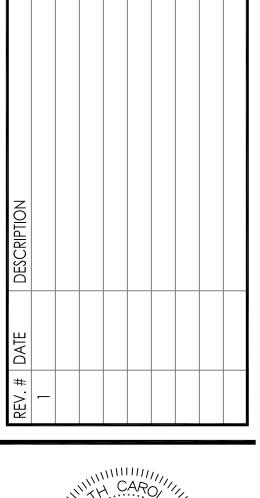
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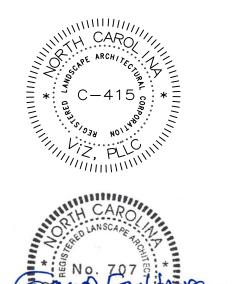
HARDSCAPE PLAN



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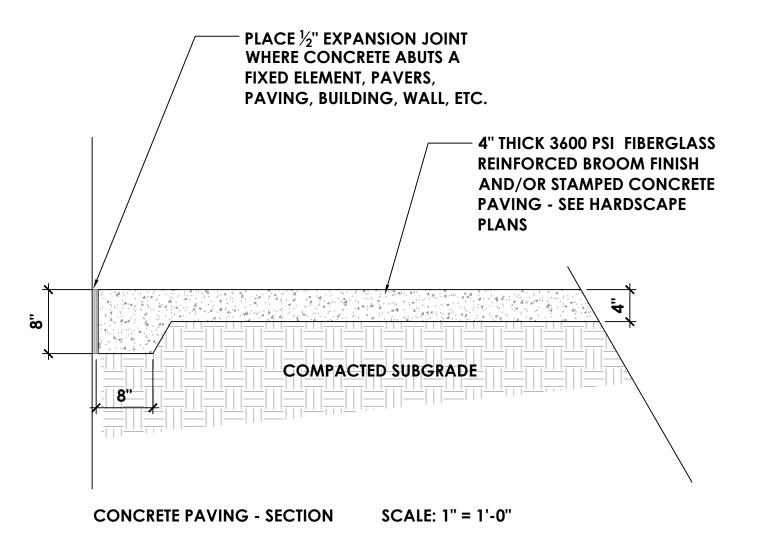
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HARDSCAPE PLAN



NOTES:

- 1. CONCRETE CONTRACTOR SHALL BE EXPERIENCED IN PLACING AND FINISHING CONCRETE.
- 2. EXPANSION JOINTS SHALL BE INCORPORATED WITHIN PATTERN AS DETERMINED BY CODE OR STANDARD PRACTICE.
- 3. SCORE JOINTS AND/OR EXPANSION JOINTS SHALL BE WITH PATTERN INDICATED ON THE HARDSCAPE PLANS.
- 4. CONCRETE PAVING SHALL COMPLY WITH IBC 1104, A117.1, SECTIONS 301 AND 302.

$-2\frac{1}{2}$ " POST AND CAP - SEE HARDWARE SPECS.-- $\frac{1}{2}$ " ALUM. MESH ON POSTS TO BE EMBED GATE AND BOTH SIDES **MOUNT UNLESS** OTHERWISE DIRECTED -'SURECLOSE' SELF **CLOSING HINGES -**TOP AND BOTTOM $-1\frac{1}{2}$ " BOTTOM POST FOOTINGS T.B.D. BY FENCE MANUFACTURER - 3,500 PSI CONC. POOL ENCLOSURE FENCE AND GATES SCALE: 1/2" = 1'-0" **FOOTING** NOTE: POOL ENCLOSURE FENCE AND ALL GATES (PEDESTRIAN AND MAINTENANCE) SHALL BE SECURED AND MEET ALL APPLICABLE CODES, INCLUDING I.B.C. 3109, SWIMMING POOL ENCLOSURES, FOR POOLS AND SPA. MAINTENANCE GATE SHALL WASHED STONE FOR CONTAIN PERMANENT LOCKING DEVICES AND HAVE A LOCKABLE, REMOVABLE, CENTER DRAINAGE POST. CONTRACTOR SHALL SUBMIT SHOP DRAWINGS FOR FENCE, GATES, HARDWARE, LOCKING DEVICES, ETC. FOR REVIEW/APPROVAL.

 $-1\frac{1}{2}$ " TOP RAILS

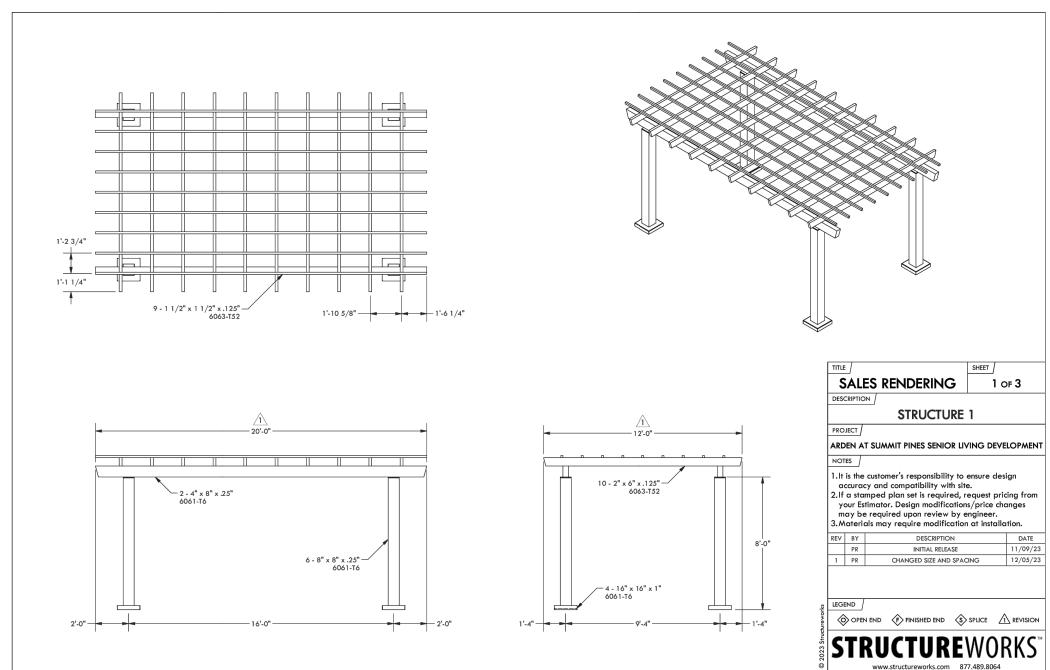
5/8" PICKETS @

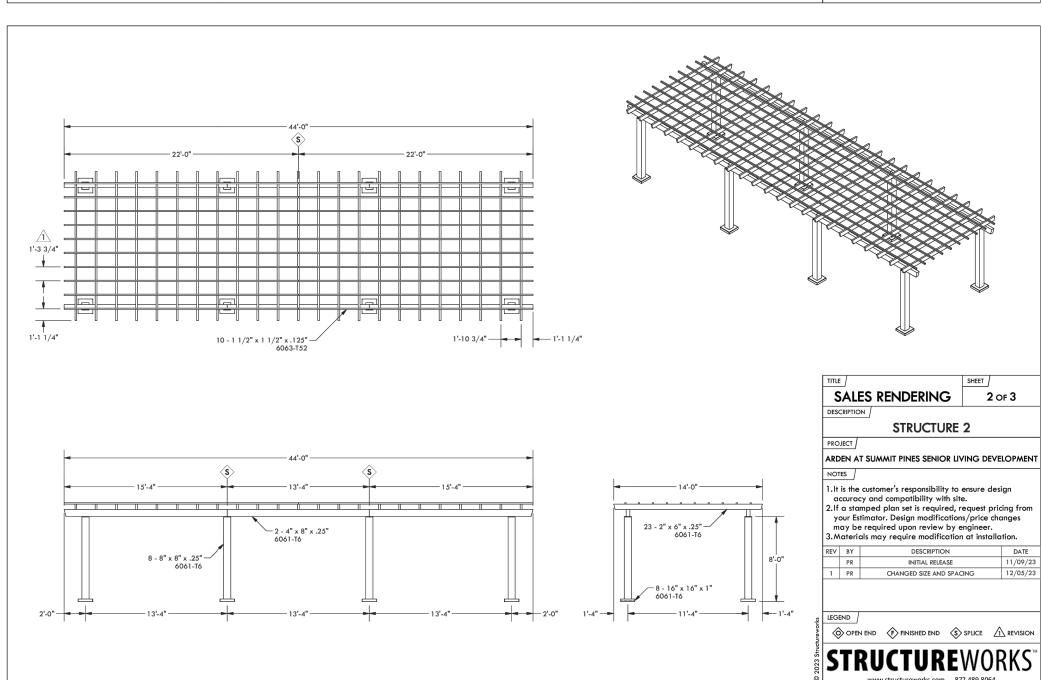
4" O.C.

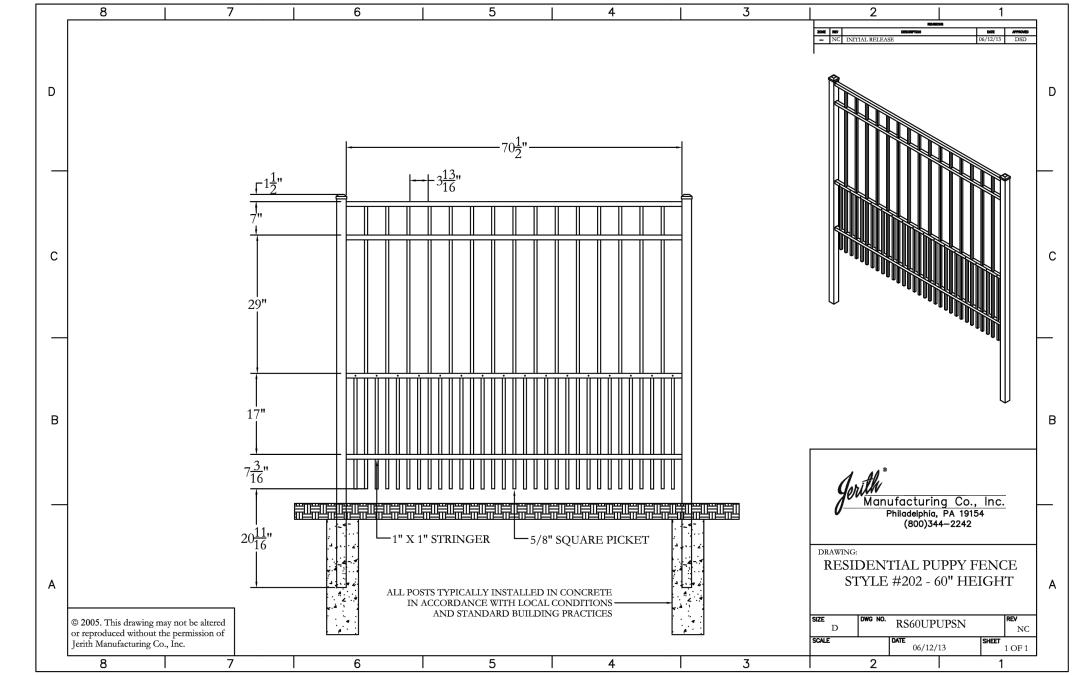
5' HIGH POOL FENCE AND GATES

ALL FENCING TO BE BLACK ALUMINUM

SCORED AND STAMPED CONCRETE SECTION DETAIL





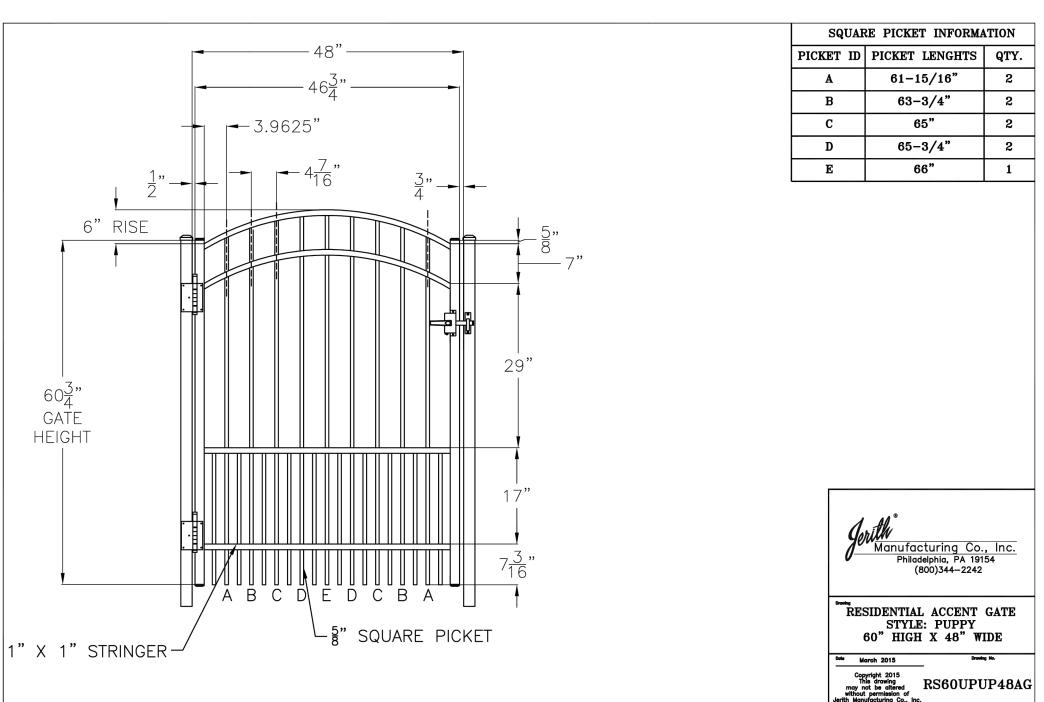


LOCKABLE KEY PAD OR

KEY-FOB ENTRY LATCH -

— EXIT PANIC BAR PER

CODE ON POOL SIDE



DOG PARK FENCING N.T.S.
ALL FENCING TO BE BLACK ALUMINUM





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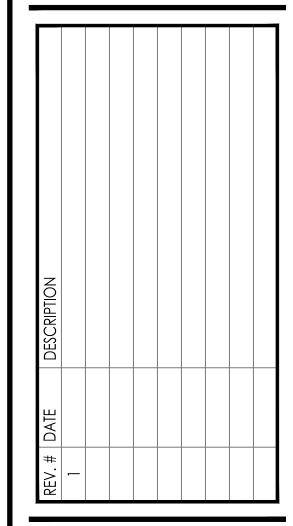
(704) 997-6144

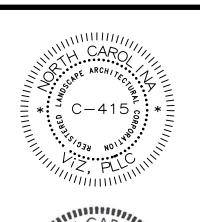
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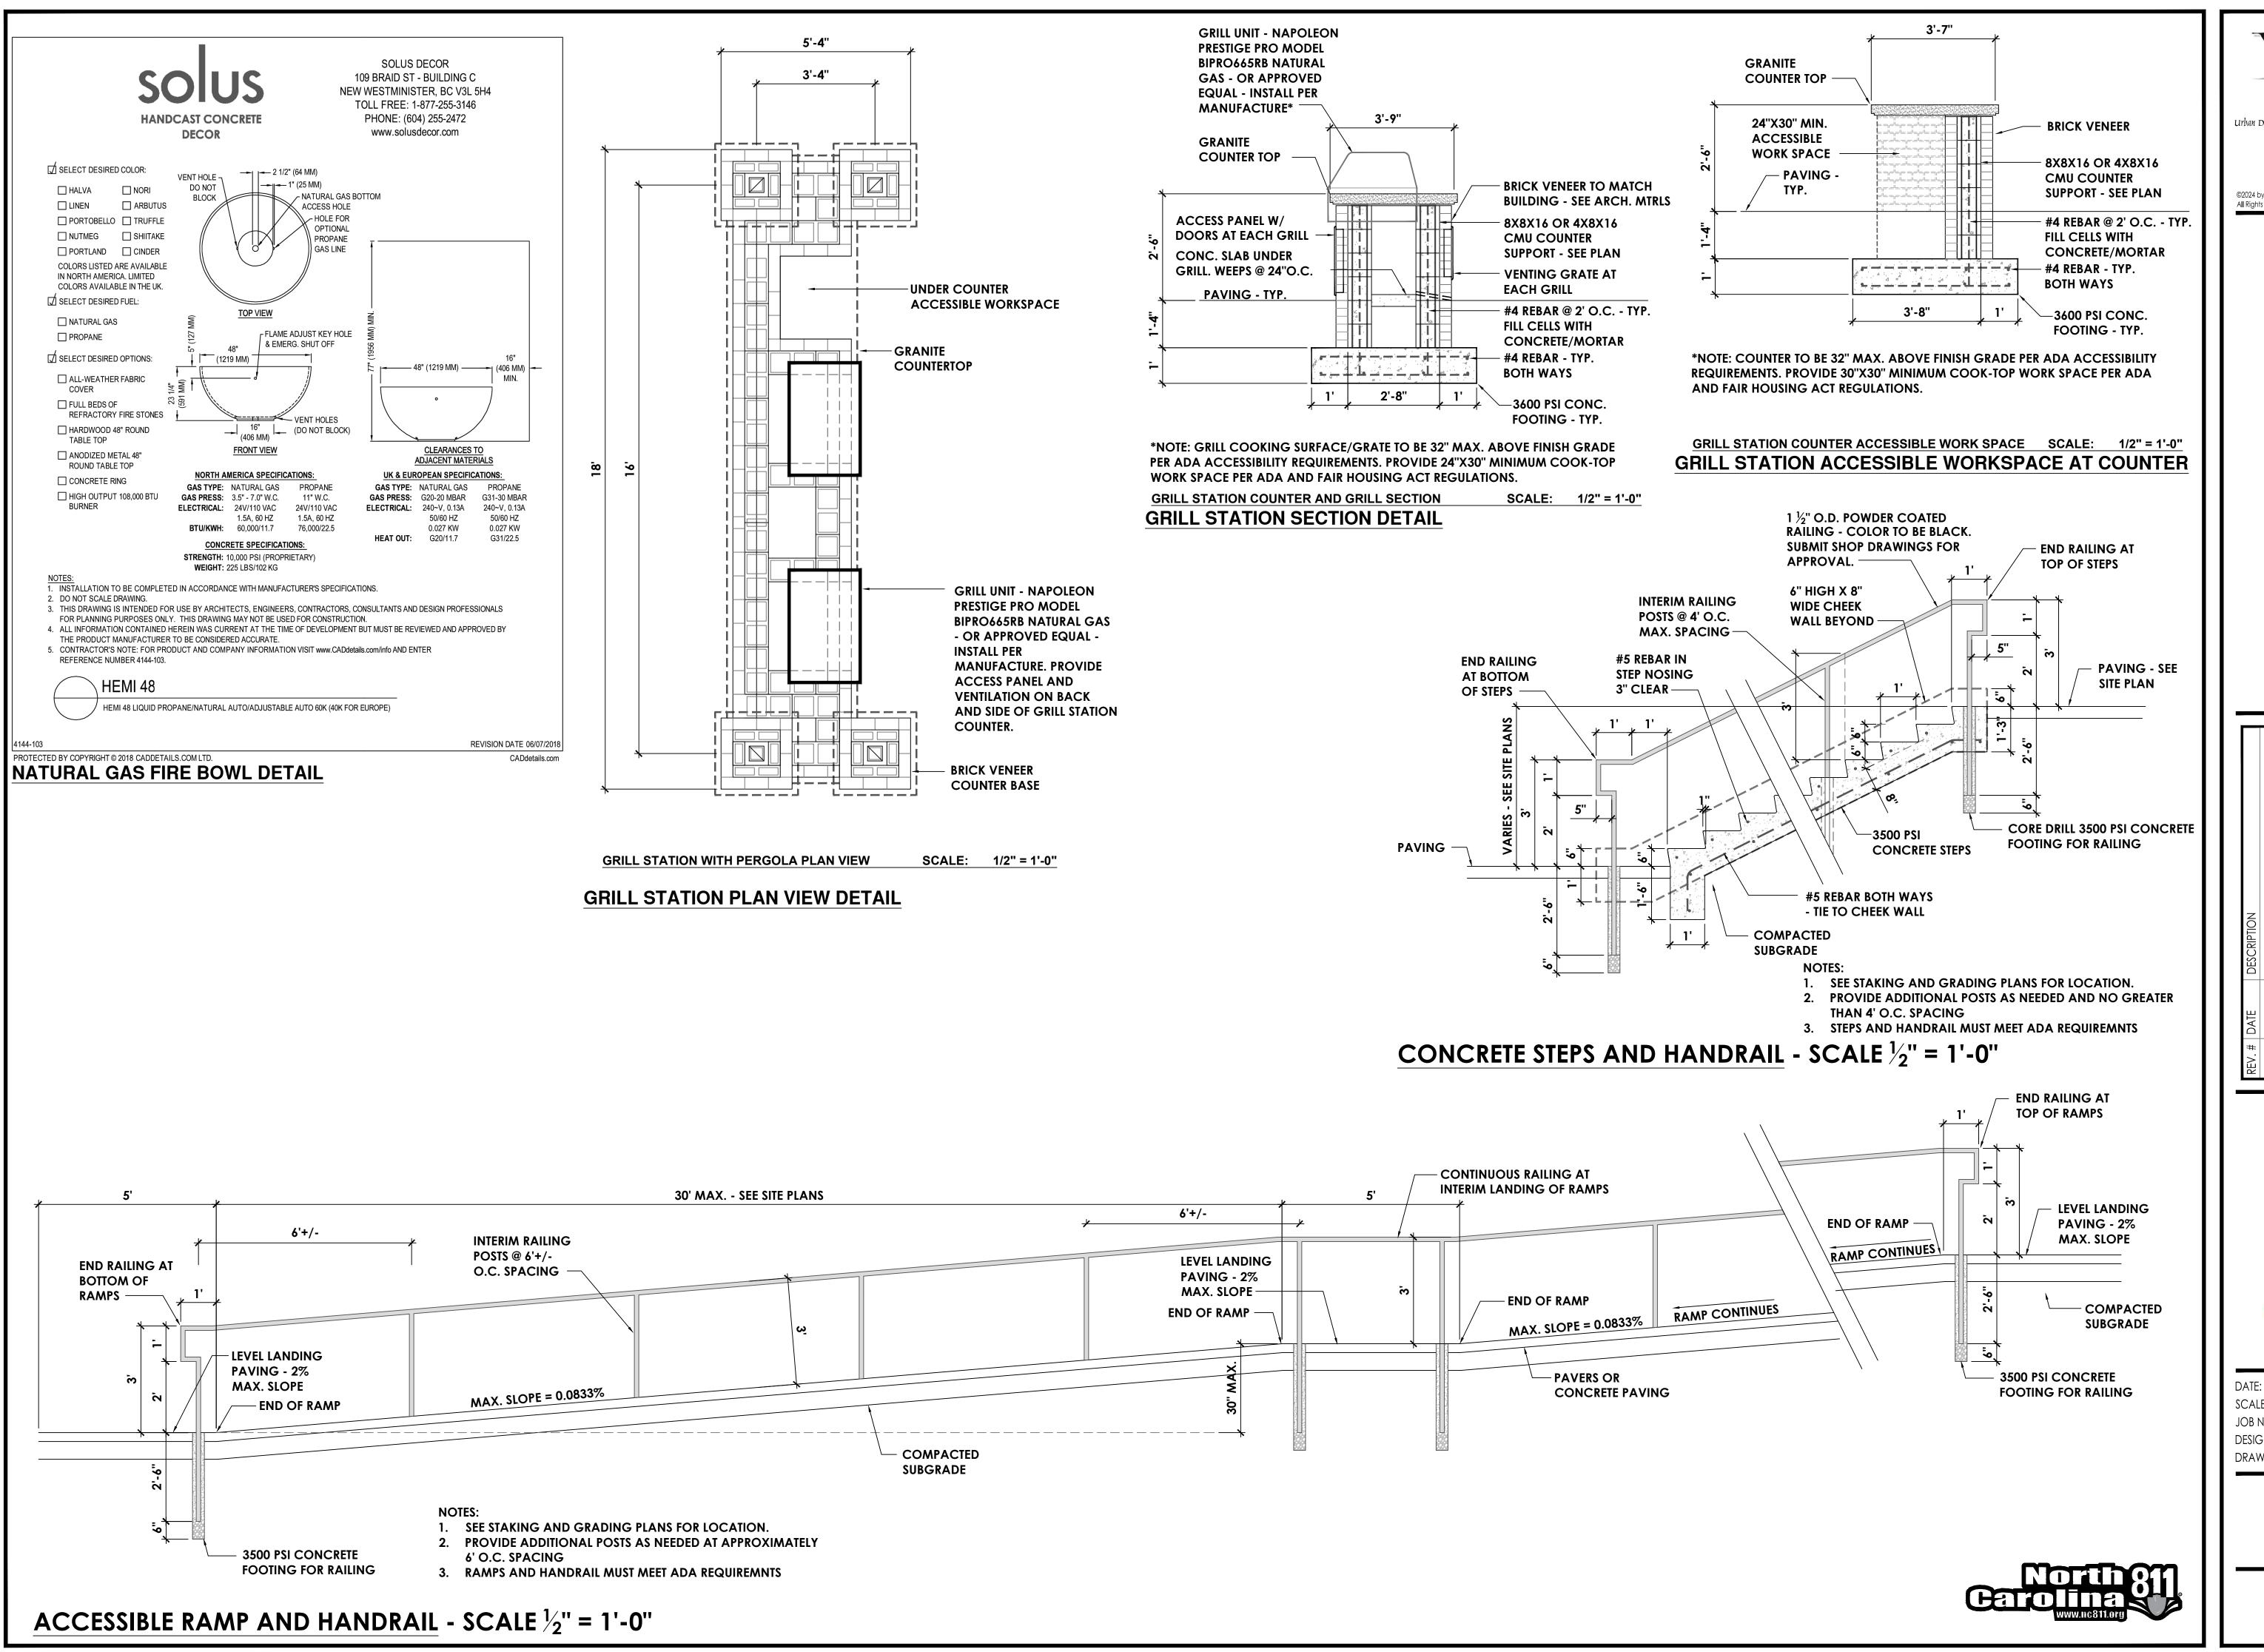
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DETAILS

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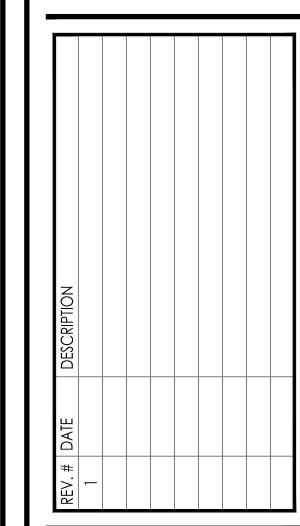


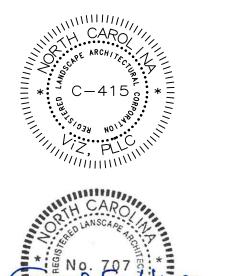
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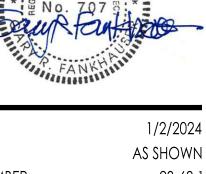
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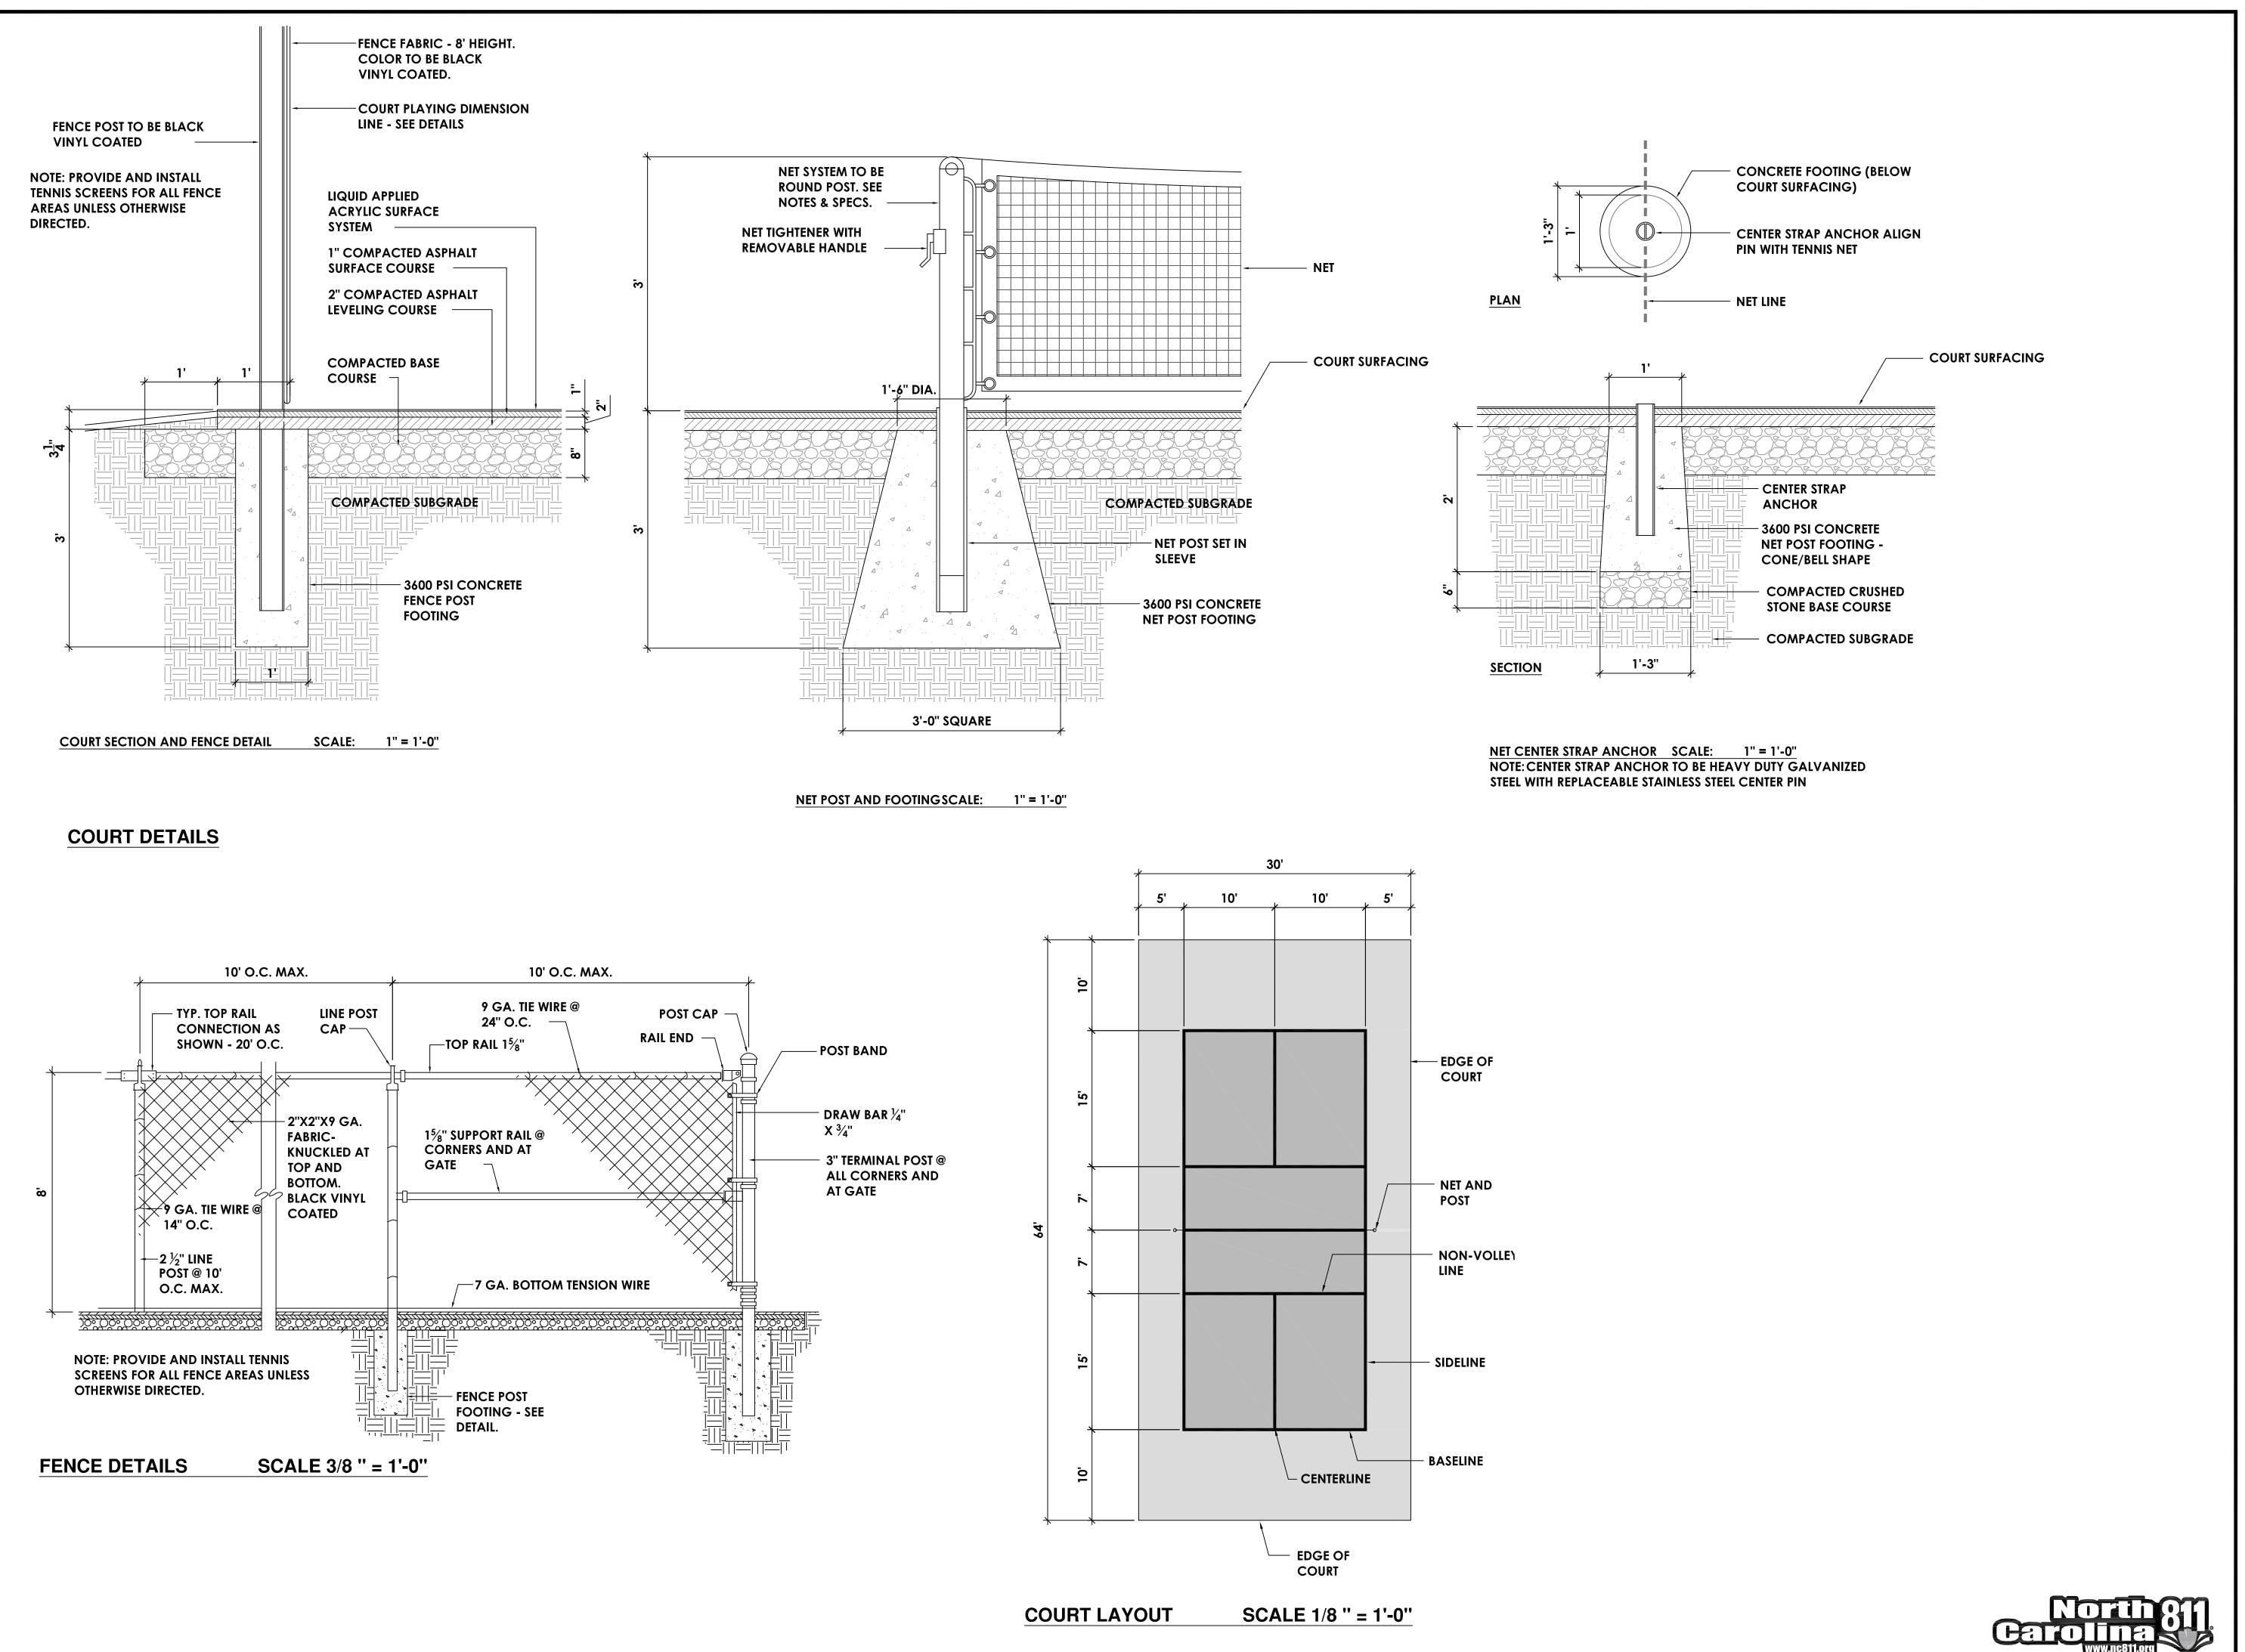
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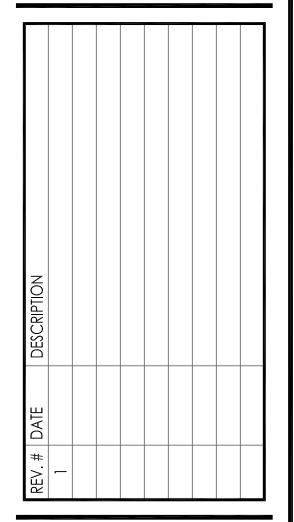
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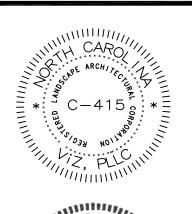
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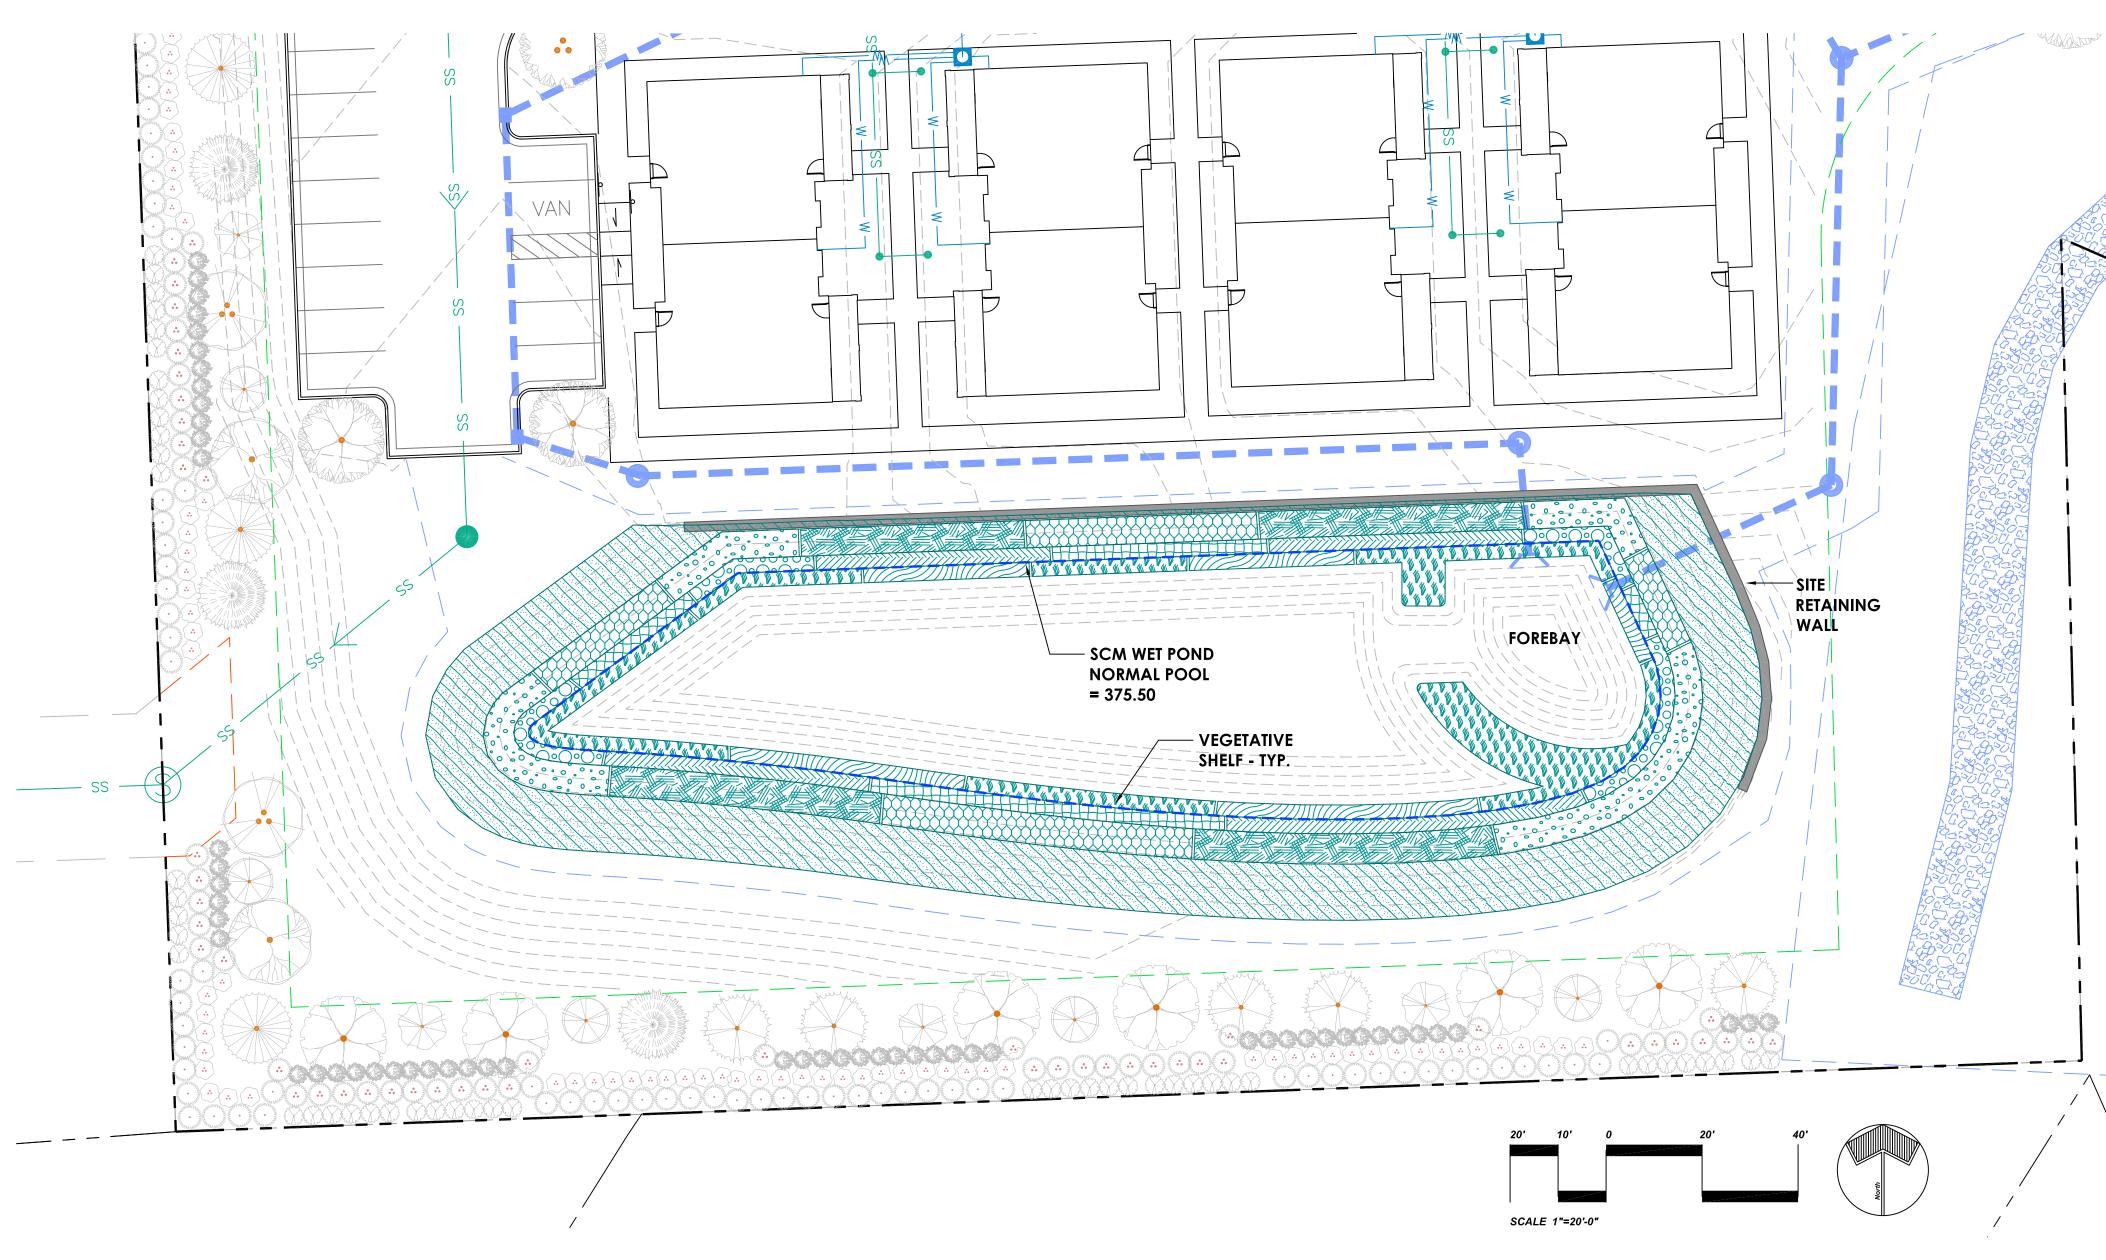
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WET POND BMP PLANTING NOTES

- 1. ALL PLANTING SHALL BE IN ACCORDANCE WITH THE NCDEQ STORMWATER BMP MANUAL.
- 2. NO PLANTING SHALL OCCUR UNTIL SOIL PREPARATION HAS OCCURRED.
- 3. TREES, SHRUBS, AND WOODY VEGETATION ARE NOT ALLOWED ON ANY EMBANKMENT IMPOUNDING WATER.
- SOIL TESTING: CONTRACTOR SHALL PROVIDE SOIL TESTING FOR EXISTING SOILS AND PREPARED SOILS TO BE USED FOR PLANTING IN ORDER TO DETERMINE TYPES OF SOIL AMENDMENTS REQUIRED TO BRING THE
 SOIL WITHIN THE CORRECT RANGES FOR OPTIMUM PLANT GROWTH. SOIL TESTING IS REQUIRED. IF SOILS ARE AMENDED, A SECOND SOIL TEST IS NEEDED PRIOR TO PLANTING. IF IMPORTED SOIL IS USED A
 MANUFACTURER CERTIFICATION IS REQUIRED.
- SOIL AMENDMENT: TOPSOIL SHALL BE SPREAD TO A DEPTH OF EIGHT TO TWELVE INCHES (DEEPER FOR BALLED AND BURLAP TREES SEE DETAIL) AND LIGHTLY COMPACTED TO MINIMUM THICKNESS OF SIX INCHES. IF TOPSOIL HAS BEEN STOCKPILED FOR A LONG PERIOD OF TIME, IT MAY BE NECESSARY TO RE-ADJUST THE SOIL PH, AND SUPPLEMENT MAJOR SOIL NUTRIENTS TO ACHIEVE THE MINIMUM ACCEPTABLE STANDARDS.
- SOIL AMENDMENTS AS REQUIRED FROM SOILS REPORT/TESTING AND AS ACCEPTABLE STANDARDS FOR GROWING OF SPECIFIC PLANT SPECIES.
- FERTILIZERS: ONLY AS GROWERS INDUSTRY RECOMMENDATIONS BASED ON SPECIFIC PLANT SPECIES
- PLANTING MIX:

PLANTING MIX: SHALL BE NATURAL, FERTILE, AGRICULTURAL TOPSOIL, CAPABLE OF SUSTAINING VIGOROUS PLANT GROWTH, WITH PH RANGE OF 5.5 TO 7. IT MAY BE DEVELOPED BY AMENDING THE EXISTING SOIL, OR REMOVING THE EXISTING SOIL AND REPLACING WITH NEW SOIL. IT SHALL BE FREE OF ROOTS, PLANTS, SOD, STONES, CLODS, CLAY LUMPS, POCKETS OF COARSE SAND, CONCRETE SLURRY, CONCRETE LAYERS OR CHUNKS, CEMENT, PLASTER, BUILDING DEBRIS, AND OTHER EXTRANEOUS MATERIALS HARMFUL TO PLANT GROWTH. PLANTING MIX SHALL NOT BE USED WHILE IN A FROZEN OR MUDDY CONDITION.

5. PLANTING SEASONS

FOR PLANTING SEASONS, CONFORM TO THE FOLLOWING GENERAL GUIDELINES:

SEEDING GRASSES AND MEADOWS: FALL SEASON

INSTALLING PLUGS AND QUART POTS - WET POND PLANTS (HERBACEOUS EMERGENTS): SPRING, SUMMER

INSTALLING CONTAINER GROWN PLANTS: DORMANT SEASON

INSTALLING BALLED-IN-BURLAP PLANTS DORMANT SEASON

6. NEW PLANT PROCUREMENT:

ALL PLANTS SHOULD BE WELL GROWN AND HEALTHY, AND FREE FROM DISEASE AND INFESTATION BY INVASIVE SPECIES. ALL PLANTS, WHETHER SUPPLIED IN NURSERY CONTAINER, BALLED-IN-BURLAP, SMALL PLANT CONTAINER OR PLUG, SHALL CONFORM TO THE SPECIFICATIONS IN THE AMERICAN STANDARDS FOR NURSERY STOCK, ANSI Z60.1 - 2014, OR LATEST EDITION.

7. PLANTING PROCEDURES

CONFORM TO ALL APPLICABLE SPECIFICATIONS FOR PLANTINGS OF TREES AND SHRUBS, AS DETAILED IN THE NCDEQ STORMWATER BMP MANUAL. LAY OUT ALL PLANTS AS INDICATED ON THE PLANTING PLAN AND ACCORDING TO SPECIES MIXES, AND AT SPECIFIED SPACING AND DENSITIES.

8. WATERING

THE CONTRACTOR IS RESPONSIBLE FOR WATERING ALL PLANTS AT A RATE OF A MINIMUM OF ONE INCH OF WATER PER WEEK OR GREATER AS NEEDED AND DETERMINED BY STANDARD HORTICULTURAL PRACTICES. THE CONTRACTOR SHALL BE RESPONSIBLE FOR WATERING UNTIL FINAL ACCEPTANCE BY THE OWNER. ALL WATER SHALL BE POTABLE AND FROM SOURCES GUARANTEED SAFE FROM IMPURITIES AND SALINITIES. TEMPORARY IRRIGATION: PER THE DIRECTION AND OWNER APPROVAL, THE CONTRACTOR MAY INSTALL A TEMPORARY AUTOMATIC IRRIGATION SYSTEM TO SUSTAIN PLANT MOISTURE.

9. HERBIVORE CONTROL

THE CONTRACTOR SHALL BE RESPONSIBLE FOR ENSURING PROTECTION OF PLANT MATERIAL BY LOCAL WILDLIFE (GEESE, MUSKRATS, BEAVERS, DEER, ETC.) UNTIL FINAL ACCEPTANCE BY THE OWNER. RECOMMENDED CONTROL MEASURES ARE LISTED IN THE BMP MANUAL. THE OWNER MAY ELECT TO KEEP HERBIVORE CONTROL MEASURES IN PLACE AFTER PROJECT FINAL ACCEPTANCE.

PLANT SCHEDULE

	SYMBOL	CODE	BOTANICAL NAME	COMMON NAME	SIZE	CONTAINER	SPACING	QTY
	GROUND (COVERS						
IE A		Aa2	Acorus americanus	Sweet Flag	Quart	Pot	18" o.c.	631
S.	, 0 0 0	Ag	Andropogon glomeratus	Bushy Bluestem	Quart	Pot	18" o.c.	461
.E		Da	Dulichium arundinaceum	Threeway Sedge	Quart	Pot	18" o.c.	322
		lv	Iris virginica	Blue Flag Iris	Quart	Pot	18" o.c.	223
G		Pv	Panicum virgatum	Switch Grass	Quart	Pot	18" o.c.	616
ΓΕ	0.0.0.0	Рр	Pontederia cordata `Pink`	Pink Pickerel Weed	Quart	Pot	18" o.c.	184
		Sa	Sagittaria latifolia	Lance-Leafed Arrowhead	Quart	Pot	18" o.c.	266
		SI	Schizachyrium scoparium	Little Bluestem	Quart	Pot	18" o.c.	458
		Tm	Turfgrass Non-Clumpi bermuda `Tifton 328`	Non-Clumping Bermudagrass	seed		8" o.c.	11,842



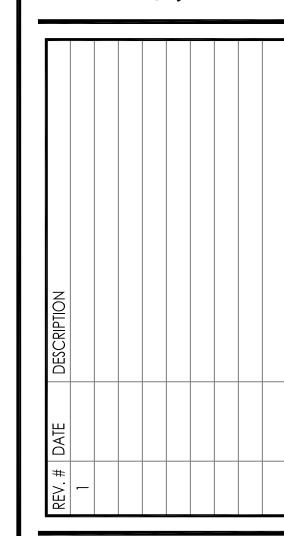


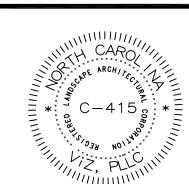
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WET POND SCM PLANTING PLAN

L-4.