# V3 - SDP-23-09

SITE DATA TABLE

# SCOOTER'S ROLESVILLE

306 SOUTH MAIN STREET ROLESVILLE, NC 27571

A DEVELOPMENT BY: S&S JAVA ENTERPRISES

PROJECT NO.: SDP-23-09 DATE: OCTOBER 31, 2023

ates, Ir	PIN:	1759806076
on this document without written authorization and adaptation by Kimley-Horn and Associates,	TOTAL SITE AREA:	0.70 AC
/ and r	EXISTING ZONING:	GENERAL COMMERCIAL (GC)
y-Horr	BUFFERS:	30' STREETSCAPE BUFFER
Kimle	}	25' TYPE 3 PERIMETER BUFFER (REAR)
on by	PROPERTY SETBACKS:	FRONT: 20
laptati		SIDE: 15'
and ad		REAR: 35'
ation a	WATERSHED:	SANFORD CREEK
thoriza	RIVER BASIN:	NEUSE
ten au	CURRENT USE:	VACANT
ut writt	PROPOSED USE:	COMMERCIAL
withou	CURRENT IMPERVIOUS:	144 SF
ment	PROPOSED IMPERVIOUS:	18,700 SF
s docr	PARKING:	MIN. REQUIRED: (2.5 SPACES/1,000 SF)
on this		$\frac{X 700 \text{ SF}}{= 2.5 \text{ SPACES}}$
iance		— 2.3 31 ACL3
oer re		MAX. ALLOWED: (10 SPACES/1,000 SF)
mpro		<u>X 700 SF</u>
fandi		= 7 SPACES
it was prepared. Reuse of and		PROVIDED: 7 SPACES
ed. Re	ACCESSIBLE PARKING:	REQUIRED: 1 SPACE
repar		PROVIDED: 1 SPACE
was p	LOADING SPACES:	REQUIRED: 1 SPACE
or which it	BICYCLE PARKING:	PROVIDED: 1 SPACE
4	DICTULE PARKING.	MIN. REQUIRED: (1 SPACE/5,000 SF) X 700 SF
l client		$\begin{array}{c} \frac{\times 700 \text{ SI}}{\text{= 1 SPACES}} \end{array}$
se anc		
sod_nd		PROVIDED: 2 SPACES
ecific	OPEN SPACE:	REQUIRED:
the sp		TOTAL REQUIRED:
ly for t		$0.70 \text{ AC } \times 5\% = 0.035 \text{ AC } (1,525 \text{ SF})$
ntended only for the specific purpose and client		
intend		ACTIVE OPEN SPACE REQUIRED:
service, is i		$0.035 \text{ AC } \times 50\% = 0.018 \text{ AC } (784 \text{ SF})$
		PROVIDED:
it of		

ACTIVE OPEN SPACE PROVIDED:

PASSIVE OPEN SPACE PROVIDED:

TOTAL OPEN SPACE PROVIDED:

0.031 AC (1,358 SF)

0.050 AC (2,192 SF)


0.081 AC (3,550 SF)

SEE SHEET L1.0

TREE COVERAGE DATA:

BUILDING SQUARE FOOTAGE: 700 SF (APPROX.)

BUILDING HEIGHT:

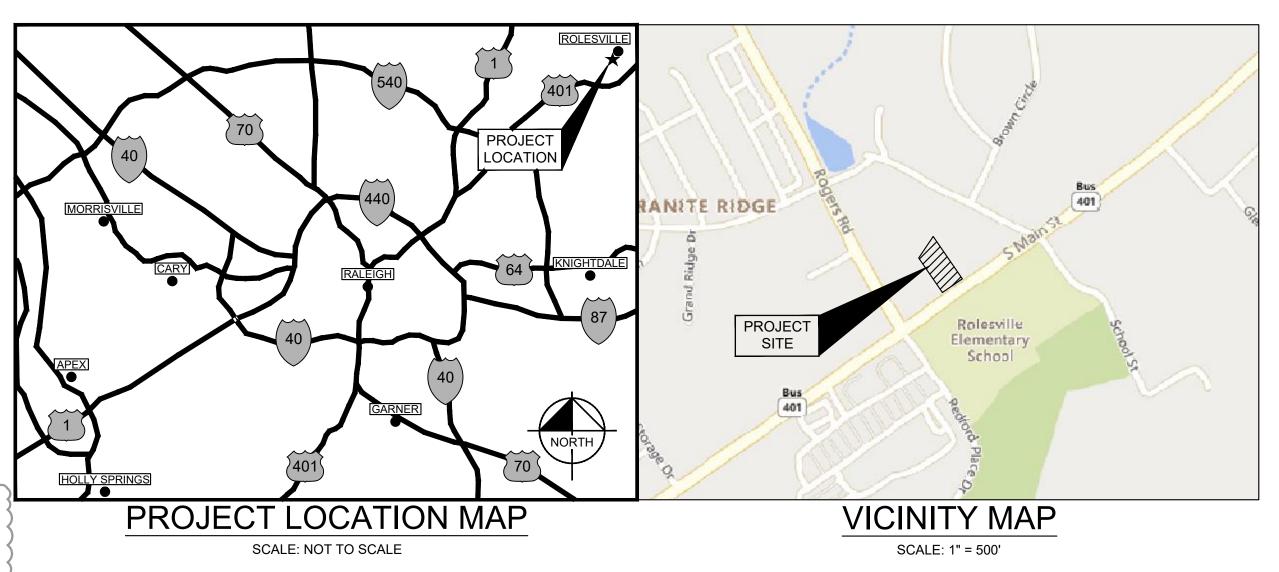

# PROJECT OWNERS & CONSULTANTS

OWNER	
ROLESVILLE, LLC	

EMAIL: b2driver@earthlink.net

11016 RUSHMORE DRIVE, SUITE 160 CHARLOTTE, NORTH CAROLINA 28277 CONTACT: MARLANE KLINTWORTH PHONE: (919) 868-4472 EMAIL: mvkcommercial@gmail.com

DEVELOPER S&S JAVA ENTERPRISES - ROLESVILLE, LLC 13 LAFOY DRIVE CLAYTON, NORTH CAROLINA 27527 CONTACT: ROBERT SOUTHERLAND PHONE: (919) 426-7670

**CIVIL ENGINEER** KIMLEY-HORN AND ASSOCIATES, INC. 421 FAYETTEVILLE ST., SUITE 600 RALEIGH, NORTH CAROLINA 27601 CONTACT: CHRIS BOSTIC, P.E. PHONE: (919) 653-2927 EMAIL: chris.bostic@kimley-horn.com

LANDSCAPE ARCHITECT KIMLEY-HORN AND ASSOCIATES, INC. 421 FAYETTEVILLE ST., SUITE 600 RALEIGH, NORTH CAROLINA 27601 CONTACT: ADAM FULLERTON, MLA, ASLA PHONE: (919) 653-2937

EMAIL: adam.fullerton@kimley-horn.com

SURVEYOR CMP PROFESSIONAL LAND SURVEYORS, PC 333 S. WHITE ST WAKE FOREST, NORTH CAROLINA 27587 CONTACT: MICHAEL A. MOSS, PLS PHONE: (919) 556-3148 EMAIL: mike@cmppls.com

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# SITE PERMITTING APPROVAL

## Water and Sewer Permits (If applicable)

The City of Raleigh consents to the connection and extension of the City's Public Sewer System as shown on this plan. The material and Construction methods used for this project shall conform to the standards and specifications of the City's Public Utilities Handbook. City of Raleigh Public Utilities Department Permit #

The City of Raleigh consents to the connection and extension of the City's Public Water System as shown on this plan. The material and Construction methods used for this project shall conform to the standards and specifications of the City's Public Utilities Handbook. City of Raleigh Public Utilities Department Permit #

The City of Raleigh consents to the connection to its public sewer system and extension of the private sewer collection system as shown on this plan. The material and constructions methods used for this project shall conform to the standards and specifications of the City's Public Utilities Handbook.

City of Raleigh Public Utilities Department Permit #

## CITY OF RALEIGH - PLANS AUTHORIZED FOR CONSTRUCTION

Electronic Approval: This approval is being issued electronically. This approval is valid only upon the signature of a City of Raleigh Review Officer below. The City will retain a copy of the approved plans. Any work authorized by this approval must proceed in accordance with the plans kept on file with the City. This electronic approval may not be edited once issued. Any modification to this approval once issued will invalidate this approval.

City of Raleigh Development Approval

Raleigh Water Review Officer

SURVEY NOTE: EXISTING TOPOGRAPHICAL INFORMATION IS BASED ON A TOPOGRAPHIC SURVEY OBTAINED ON 02/23/2023 BY CMP PROFESSIONAL LAND SURVEYORS, 333 S. WHITE STREET, WAKE FOREST, NC, 27588, PHONE: (919) 556-3148. CONTRACTOR SHALL BE RESPONSIBLE FOR VERIFYING ALL EXISTING INFORMATION, DEPICTED OR NOT, PRIOR TO CONSTRUCTION AND REPORT POTENTIAL CONFLICTS TO OWNER AND ENGINEER.



SHE OVE

SHEET NUMBER C0.0

SDP-23-09

## GENERAL NOTES:

- WORK IN THIS PROJECT SHALL CONFORM TO THESE PLANS, THE LATEST EDITIONS OF THE NORTH CAROLINA DEPARTMENT OF TRANSPORTATION (NCDOT) ROAD AND BRIDGE SPECIFICATIONS, THE NCDOT ROAD AND BRIDGE STANDARDS, THE NORTH CAROLINA EROSION AND SEDIMENT CONTROL HANDBOOK, THE NORTH CAROLINA EROSION AND SEDIMENT CONTROL REGULATIONS, THE ROLESVILLE DESIGN AND CONSTRUCTION STANDARDS AND SPECIFICATIONS. THE FINAL GEOTECHNICAL REPORT. AND GENERAL DESIGN STANDARDS. IN THE EVENT OF CONFLICT BETWEEN ANY OF THESE STANDARDS, SPECIFICATIONS, OR PLANS, THE MOST STRINGENT SHALL GOVERN. ALL UTILITIES TO BE DEDICATED TO THE CITY OF RALEIGH MUNICIPAL WATER AND/OR SANITARY SEWER SYSTEM SHALL BE CONSTRUCTED AND TESTED TO CONFORM TO STATE OF NORTH CAROLINA/STATE BOARD OF HEALTH WATERWORKS AND/OR SEWAGE REGULATIONS AND THE CITY OF RALEIGH DESIGN AND CONSTRUCTION STANDARDS AND SPECIFICATIONS
- 2. THE TERM "CONTRACTOR" AS REFERENCED HERE-IN SHALL ALSO INCLUDE THE SUBCONTRACTOR OR PRINCIPAL TRADE CONTRACTOR, UNDER CONTRACT TO THE GENERAL CONTRACTOR TO PROVIDE LABOR, MATERIALS, AND/OR SERVICES TO THE PROJECT.
- . THE CONTRACTOR SHALL BE SOLELY RESPONSIBLE FOR ALL JOBSITE SAFETY, INCLUDING BUT NOT LIMITED TO TRENCH SAFETY, DURING ALL PHASES OF CONSTRUCTION.
- 4. THE LOCATION AND SIZE OF EXISTING UTILITIES AS SHOWN IS APPROXIMATE ONLY. THE CONTRACTOR IS RESPONSIBLE FOR HORIZONTALLY AND VERTICALLY LOCATING AND PROTECTING ALL PUBLIC OR PRIVATE UTILITIES (SHOWN OR NOT SHOWN) WHICH LIE IN OR ADJACENT TO THE CONSTRUCTION SITE. AT LEAST 48 HOURS PRIOR TO ANY DEMOLITION, GRADING, OR CONSTRUCTION ACTIVITY, THE CONTRACTOR SHALL NOTIFY THE NORTH CAROLINA 811 UTILITIES LOCATION SERVICE (NC811) AT 1-800-632-4949 FOR PROPER IDENTIFICATION OF EXISTING UTILITIES WITHIN THE SITE.
- THE CONTRACTOR SHALL SALVAGE AND PROTECT ALL EXISTING POWER POLES, SIGNS, MANHOLES, TELEPHONE RISERS, WATER VALVES, ETC. DURING ALL CONSTRUCTION PHASES. THE CONTRACTOR SHALL REPAIR, AT HIS OWN EXPENSE, ANY EXISTING UTILITIES DAMAGED DURING CONSTRUCTION.
- 6. TRAFFIC CONTROL WITHIN ALL VEHICULAR AREAS IS THE RESPONSIBILITY OF THE CONTRACTOR, SHALL BE IN CONFORMANCE WITH THE "MANUAL OF UNIFORM TRAFFIC CONTROL DEVICES," AND AS FURTHER DIRECTED BY CITY AND STATE INSPECTORS.
- ANY DISCREPANCIES FOUND BETWEEN THE DRAWINGS, SPECIFICATIONS, AND SITE CONDITIONS OR ANY INCONSISTENCIES OR AMBIGUITIES IN DRAWINGS OR SPECIFICATIONS SHALL BE IMMEDIATELY REPORTED TO THE ENGINEER, IN WRITING, WHO SHALL PROMPTLY ADDRESS SUCH INCONSISTENCIES OR AMBIGUITIES. WORK DONE BY THE CONTRACTOR AFTER HIS DISCOVERY OF SUCH DISCREPANCIES, INCONSISTENCIES, OR AMBIGUITIES SHALL BE DONE AT THE CONTRACTOR'S RISK.
- CONSTRUCTION STAKEOUT FOR THIS PROJECT SHALL BE PER A DIGITAL (CAD) FILE PROVIDED BY THE ENGINEER THE CONTRACTOR SHALL NOTIFY THE LEAD ARCHITECT IMMEDIATELY OF ANY DISCREPANCIES FOUND BETWEEN THE DIGITAL FILE AND THE CRITICAL STAKING DIMENSIONS SHOWN ON THIS PLAN. ANY MODIFICATIONS MADE BY OTHERS TO THE DIGITAL FILE PROVIDED BY THE ENGINEER SHALL RENDER IT VOID.
- 9. A PRE-CONSTRUCTION CONFERENCE SHALL BE HELD PRIOR TO THE START OF CONSTRUCTION. THE CONTRACTOR SHALL ARRANGE THE MEETING WITH THE ROLESVILLE ENGINEERING DIVISION AND THE OWNER.
- 10. CONTRACTOR IS RESPONSIBLE FOR VERIFYING OR OBTAINING ALL REQUIRED PERMITS AND APPROVALS PRIOR TO COMMENCING CONSTRUCTION.
- 11. THE FRAMES AND COVERS OF ALL EXISTING AND PROPOSED DRAINAGE, SANITARY SEWER, WATER MAIN, GAS, AND WIRE UTILITY STRUCTURES SHALL BE ADJUSTED TO MATCH PROPOSED FINISHED ELEVATIONS AND SLOPES.
- 12. ROADWAYS AND BUILDINGS MUST BE CAPABLE OF SUPPORTING FIRE APPARATUS DURING CONSTRUCTION.
- 13. EXISTING INFORMATION SHOWN TAKEN FROM A TOPOGRAPHIC SURVEY DATED FEBRUARY 23, 2023 AND PROVIDED BY CMP PROFESSIONAL LAND SURVEYORS C-1525, 333 S. WHITE STREET, P.O. BOX 1253, WAKE FOREST, N.C. 27588, PHONE: (919) 556-3148.
- 14. ALL CONSTRUCTION SHALL BE IN ACCORDANCE WITH THE NC DOT AND ROLESVILLE STANDARDS, SPECIFICATIONS, & DETAILS IF APPLICABLE.

## GRADING

- 1. OBTAIN AND POST THE WAKE COUNTY LAND DISTURBANCE PERMIT ONSITE PRIOR TO COMMENCING WORK ON SITE.
- 2. REFER TO FINAL CONSTRUCTION PLANS FOR CLEARING LIMITS AND TEMPORARY EROSION CONTROL DEVICES TO BE INSTALLED PRIOR TO COMMENCING CONSTRUCTION.
- 3. CONTRACTOR SHALL ADHERE TO THE LIMITS OF TREE PROTECTION FENCE.
- 4. EROSION AND SEDIMENT CONTROL MEASURES SHALL BE MAINTAINED CONTINUOUSLY, RELOCATED WHEN AND AS NECESSARY, AND SHALL BE CHECKED AFTER EVERY RAINFALL. SEEDED AREAS SHALL BE CHECKED REGULARLY AND SHALL BE WATERED, FERTILIZED, RESEEDED, AND MULCHED AS NECESSARY TO OBTAIN A DENSE STAND OF
- 5. ALL AREAS SHALL BE GRADED FOR POSITIVE DRAINAGE, AND AS SHOWN ON THESE PLANS. THE CONTRACTOR SHALL MAINTAIN ADEQUATE SITE DRAINAGE DURING ALL PHASES OF CONSTRUCTION. THE CONTRACTOR SHALL USE SILT FENCES (OR OTHER METHODS APPROVED BY THE ENGINEER, WAKE COUNTY, AND NCDENR). AS REQUIRED TO PREVENT SILT AND CONSTRUCTION DEBRIS FROM FLOWING ONTO ADJACENT PROPERTIES. CONTRACTOR SHALL COMPLY WITH ALL APPLICABLE FEDERAL, STATE, OR LOCAL EROSION, CONSERVATION, AND SILTATION ORDINANCES. CONTRACTOR SHALL REMOVE ALL TEMPORARY FROSION CONTROL DEVICES LIPON COMPLETION OF PERMANENT DRAINAGE FACILITIES AND THE ESTABLISHMENT OF A STAND OF GRASS OR OTHER GROWTH TO PREVENT EROSION.
- 6. THE CONTRACTOR SHALL CLEAR AND GRUB THE SITE AND PLACE, COMPACT, AND MOISTURE CONDITION ALL FILL PER THE PROJECT GEOTECHNICAL ENGINEER'S SPECIFICATIONS AND REPORT. THE FILL MATERIAL TO BE USED SHALL BE APPROVED BY THE CERTIFIED MATERIAL TESTING AGENCY PRIOR TO PLACEMENT.
- GRADING CONTRACTOR SHALL COORDINATE WITH THE UTILITY COMPANIES FOR ANY REQUIRED UTILITY ADJUSTMENTS
- AND/OR RELOCATIONS. ALL MATERIALS USED FOR BACKFILL SHALL BE FREE OF WOOD, ROOTS, ROCKS, BOULDERS, OR ANY OTHER NON-COMPATIBLE SOIL TYPE MATERIAL. UNSATISFACTORY MATERIALS ALSO INCLUDE MAN-MADE FILLS AND
- 9. MATERIALS USED TO CONSTRUCT EMBANKMENTS FOR ANY PURPOSE, BACKFILL AROUND DRAINAGE STRUCTURES, OR IN UTILITY TRENCHES FOR ANY OTHER DEPRESSION REQUIRING FILL OR BACKFILL SHALL BE COMPACTED TO 95% OF MAXIMUM DENSITY AS DETERMINED BY THE STANDARD PROCTOR TEST AS SET OUT IN ASTM STANDARD D-698. THE CONTRACTOR SHALL, PRIOR TO ANY OPERATIONS INVOLVING FILLING OR BACKFILLING, SUBMIT THE RESULTS OF THE PROCTOR TEST TOGETHER WITH A CERTIFICATION THAT THE SOIL TESTED IS REPRESENTATIVE OF THE MATERIALS TO BE USED ON THE PROJECT. TESTS SHALL BE CONDUCTED BY A CERTIFIED MATERIALS TESTING LABORATORY AND THE CERTIFICATIONS MADE BY A LICENSED PROFESSIONAL ENGINEER REPRESENTING THE
- 10. ALL DEMOLITION, DEBRIS, AND OTHER EXCESS MATERIAL SHALL BE HAULED OFF-SITE AND LEGALLY DISPOSED OF AT THE CONTRACTOR'S EXPENSE.
- 11. NO TREE WITHIN THE TREE PROTECTION AREA SHALL BE REMOVED OR DAMAGED.
- 12. THE TREE PROTECTION FENCE SHALL BE MAINTAINED ON THE SITE UNTIL ALL SITE WORK IS COMPLETED AND THE FINAL SITE INSPECTION PRIOR TO THE PROJECT ACCEPTANCE IS SCHEDULED. FENCING SHALL BE REMOVED PRIOR TO FINAL SITE INSPECTION FOR THE CO.
- 13. REFERENCE GEOTECHNICAL REPORT FOR PAVING SUB GRADE INFORMATION.

REFUSE DEBRIS DERIVED FROM ANY SOURCE.

- 14. ALL SPOT GRADE ELEVATIONS IN CURB AND GUTTER REPRESENT GUTTER FLOWLINE ELEVATION AT FACE OF CURB UNLESS OTHERWISE NOTED (ADD 6" FOR TOP OF CURB).
- 15. PROPOSED CONTOURS AND GUTTER GRADIENTS ARE APPROXIMATE. PROPOSED SPOT ELEVATIONS AND ROADWAY PROFILES/SUPERELEVATIONS ARE TO BE USED IN CASE OF DISCREPANCY.
- 16. REFER TO SITE PLAN AND FINAL PLAT FOR HORIZONTAL DIMENSIONS.
- 17. WHERE FILL IS TO BE PLACED ON EXISTING SLOPES STEEPER THAN 4:1, CONTRACTOR SHALL EXCAVATE BENCHES WITH A MAXIMUM DEPTH OF 3'.
- 18. THE CONTRACTOR SHALL COORDINATE WITH THE GEOTECHNICAL ENGINEER FOR APPROPRIATE SLOPE STABILIZATION ON ALL SLOPES STEEPER THAN 3:1.
- 19. CONTRACTOR SHALL OBTAIN ALL PERMITS REQUIRED FOR BLASTING ROCK IF BLAST ROCK IS ENCOUNTERED. CONTRACTOR SHALL BE SOLELY RESPONSIBLE FOR COMPLYING WITH ALL BLASTING AND SAFETY REQUIREMENTS.
- 20. SILT FENCE SHALL BE PLACED AROUND ALL TEMPORARY SOIL STOCKPILES A MINIMUM OF 3' FROM TOE OF SLOPE.
- 21. VERTICAL DATUM IS BASED ON NAVD 88.

# Sanitary sewer

- 1. SANITARY SEWER SERVICES SHALL BE SCHEDULE 40 PVC.
- 2. CLEANOUT SYMBOLS SHOWN ON THESE PLANS REPRESENT LOCATION OF SURFACE ACCESS POINT. CONTRACTOR SHALL LOCATE WYE APPROPRIATELY BASED ON PIPE DEPTH.
- 3. SANITARY SEWER CLEAN-OUTS LOCATED IN PAVEMENT AREAS SHALL BE HEAVY-DUTY TRAFFIC BEARING CASTINGS.

- 1. WATERLINES, LARGER THAN 2" SHALL BE DUCTILE IRON PIPE MEETING THE REQUIREMENTS OF ANSI-AWWA C151 PRESSURE CLASS 350. WATERLINES 3/4" TO 2" SHALL BE TYPE "K" SOFT COPPER.
- 2. ALL UNDERGROUND UTILITIES AND FIRE HYDRANTS MUST BE FUNCTIONALLY APPROVED PRIOR TO STRUCTURAL
- 3. NATIONAL STANDARD THREADS SHALL BE INSTALLED ON FIRE HYDRANTS.
- 4. ALL FIRE HYDRANTS AND FDC CONNECTIONS TO HAVE STORZ TYPE CONNECTION PER CITY OF RALEIGH FIRE DEPARTMENT STANDARDS.

# BACKFLOW PREVENTION:

- THERE SHALL BE NO TAPS, PIPING BRANCHES, UNAPPROVED BYPASS PIPING, HYDRANTS, FIRE DEPARTMENT CONNECTION POINTS OR OTHER WATER-USING APPURTENANCES CONNECTED TO THE SUPPLY LINE BETWEEN ANY WATER METER AND ITS REQUIRED BACKFLOW PREVENTER.
- 2. EACH BACKFLOW PREVENTER ASSEMBLY IS REQUIRED TO BE TESTED BY AN APPROVED CERTIFIED TESTER PRIOR TO PLACING THE WATER SYSTEM INTO SERVICE. CONTRACTOR SHALL PERFORM TESTING IN ACCORDANCE WITH THE CITY OF RALEIGH ENGINEERING DEPARTMENT.

# CONSTRUCTION NOTES

EASEMENTS ON THE JOB SITE AT ALL TIMES.

- 1. THE CONTRACTOR SHALL CONDUCT THE WORK IN A SAFE MANNER AND WITH A MINIMUM AMOUNT OF INCONVENIENCE TO TRAFFIC.
- 2. THE CONTRACTOR SHALL BE RESPONSIBLE FOR ALL TRAFFIC CONTROL AND SHALL ADHERE TO THE PROVISIONS OF THE MUTCD (MOST CURRENT EDITION).
- 3. PRIOR TO CONSTRUCTION BEGINNING, ALL SIGNAGE AND TRAFFIC CONTROL SHALL BE IN PLACE.
- 4. THE CONTRACTOR SHALL HAVE A COMPLETE SET OF CONTRACT DOCUMENTS AS WELL AS ALL APPROVALS AND
- 5. THE CONTRACTOR SHALL REPAIR ALL DRIVEWAYS. DRIVEWAY PIPES. CURB AND GUTTER. SIDEWALKS AND STREET TO EXISTING CONDITION OR BETTER.

## PAVING/CURBING

- WHERE PROPOSED CURB AND GUTTER TIES TO EXISTING CURB OR CURB AND GUTTER, A TRANSITION OF 10' SHALL BE MADE TO CONFORM TO THE EXISTING HEIGHTS AND SHAPES.
- 2. BEFORE ANY EARTHWORK IS DONE. THE CONTRACTOR SHALL STAKE OUT AND MARK THE LIMITS OF PAVEMENT AND OTHER ITEMS ESTABLISHED IN THE PLANS. THE CONTRACTOR SHALL PROVIDE ALL NECESSARY ENGINEERING AND SURVEYING FOR LINE AND GRADE CONTROL POINTS RELATED TO EARTHWORK.
- 3. ALL PAVEMENT SUB GRADES (EVEN WHEN ROCK IS ENCOUNTERED) SHALL BE SCARIFIED TO A DEPTH OF 8 INCHES AND COMPACTED TO A MINIMUM DENSITY OF 98 PERCENT OF ASTM D-698 DENSITY AT OPTIMUM MOISTURE CONTENT UNLESS OTHERWISE SHOWN IN THE CONSTRUCTION DOCUMENTS OR AS DIRECTED BY THE CERTIFIED MATERIALS TESTING AGENT. FILL SHALL BE PLACED AND COMPACTED IN MAXIMUM 8" LIFTS.
- 4. CONTRACTOR SHALL FURNISH AND INSTALL ALL PAVEMENT MARKINGS AND MISCELLANEOUS STRIPING AS SHOWN ON THE PLANS. ALL ROADWAY PAVEMENT MARKINGS SHALL BE THERMOPLASTIC AND ADHERE TO NCDOT STANDARDS.
- 5. THE CONTRACTOR SHALL CLEAR AND GRUB THE SITE AND PLACE, COMPACT, AND MOISTURE CONDITION ALL FILL PER THE PROJECT GEOTECHNICAL ENGINEER'S SPECIFICATIONS. THE FILL MATERIAL TO BE USED SHALL BE APPROVED BY THE GEOTECHNICAL ENGINEER PRIOR TO PLACEMENT.
- 6. ALL CURB JOINTS SHALL EXTEND THROUGH THE CURB. MINIMUM LENGTH OF OFFSET JOINTS AT RADIUS POINTS IS 1.5 FEET. ALL JOINTS SHALL BE SEALED WITH JOINT SEALANT.
- TESTING OF MATERIALS REQUIRED FOR THE CONSTRUCTION OF THE PAVING IMPROVEMENTS SHALL BE PERFORMED BY AN APPROVED AGENCY FOR TESTING MATERIALS. THE TESTING LABORATORY AND THE PAYMENT OF SUCH TESTING SERVICES SHALL BE MADE BY THE OWNER. IT SHALL BE THE CONTRACTOR'S RESPONSIBILITY THAT THE CERTIFIED MATERIAL TESTING AGENT HAS PERFORMED THE WORK AND THAT THE WORK CONSTRUCTED DOES MEET THE REQUIREMENTS OF THE CITY'S SPECIFICATIONS AND/OR THE PROJECT SPECIFICATIONS, WHICHEVER IS MORE
- 8. ALL SIGNS, PAVEMENT MARKINGS, AND OTHER TRAFFIC CONTROL DEVICES ON PUBLIC STREETS SHALL CONFORM TO MUTCD, NCDOT, AND ROLESVILLE STANDARDS.

## STORM DRAINAGE

- 1. THE CONTRACTOR SHALL VERIFY AND COORDINATE ALL DIMENSIONS SHOWN, INCLUDING THE HORIZONTAL AND VERTICAL LOCATION OF CURB INLETS AND GRATE INLETS AND ALL UTILITIES CROSSING THE STORM SEWER.
- 2. THE SITE UTILITY CONTRACTOR SHALL PROVIDE ALL MATERIALS AND APPURTENANCES NECESSARY FOR COMPLETE INSTALLATION OF THE STORM SEWER.
- THE ROLESVILLE INSPECTOR SHALL INSPECT ALL "PUBLIC" CONSTRUCTION. THE CONTRACTOR'S PRICE SHALL INCLUDE ALL INSPECTION FEES.
- 4. ALL RCP STORM SEWER MAINS AND LATERALS SHALL BE MINIMUM CLASS III REINFORCED CONCRETE PIPE.
- 5. ALL PVC PIPE USED IN DRAINAGE SYSTEM SHALL BE MINIMUM SDR-35 OR APPROVED EQUAL.

6. ALL PVC TO RCP CONNECTIONS SHALL BE CONSTRUCTED WITH CONCRETE COLLARS.

- 7. THE LOCATIONS OF STORM SEWER STRUCTURES SHOWN ON THESE PLANS (AND PROVIDED IN ASSOCIATED CAD FILES) ARE APPROXIMATE. THE CONTRACTOR SHALL STAKE ALL CURB INLET STRUCTURES SUCH THAT INLET TOPS ALIGN HORIZONTALLY WITH PROPOSED CURB LOCATIONS (PER DETAIL, IF PROVIDED). WHERE PROPOSED STORM SEWERS TIE TO EXISTING STRUCTURES, PIPES, ETC., THE CONTRACTOR SHALL FIELD ADJUST PROPOSED STORM
- SEWERS TO MATCH THE LOCATIONS OF THESE EXISTING FEATURES. 8. RIM ELEVATIONS FOR STORM CATCH BASINS ARE MEASURED TO THE GUTTER FLOW LINE.

# TRAFFIC CONTROL NOTES

- 1. WITHIN THE SIGHT TRIANGLES AND SIGHT EASEMENTS SHOWN ON THESE PLANS, NO OBSTRUCTION SHALL BE LOCATED IN WHOLE OR PART BETWEEN (2) FEET AND (8) FEET IN HEIGHT ABOVE THE CURB LINE ELEVATION OR THE NEAREST TRAVELED WAY, IF NO CURBING EXISTS. OBSTRUCTIONS INCLUDE, BUT ARE NOT LIMITED TO, ANY BERM, FOLIAGE, FENCE, WALL, SIGN, PARKED VEHICLE OR OTHER OBJECT.
- 2. ALL CONSTRUCTION SHALL BE IN ACCORDANCE WITH ALL ROLESVILLE AND/OR N.C.D.O.T. STANDARDS AND
- 3. REFER TO MANUAL ON UNIFORM TRAFFIC CONTROL DEVICES (LATEST EDITION) FOR DETAILS OF STANDARD TRAFFIC CONTROL SIGNS AND STANDARDS.

## SEEDBED PREPARATION

- 1. CHISEL COMPACTED AREAS AND SPREAD TOPSOIL THREE INCHES DEEP OVER ADVERSE SOIL CONDITIONS, IF
- 2. RIP THE ENTIRE AREA TO SIX INCHES DEEP. 3. REMOVE ALL LOOSE ROCK, ROOTS AND OTHER OBSTRUCTIONS, LEAVING SURFACE REASONABLY SMOOTH AND
- 4. APPLY AGRICULTURAL LIME, FERTILIZER AND SUPERPHOSPHATE UNIFORMLY AND MIX WITH SOIL (SEE MIXTURE
- BELOW).\* 5. CONTINUE TILLAGE UNTIL A WELL-PULVERIZED, FIRM, REASONABLY UNIFORM SEEDBED IS PREPARED FOUR TO SIX
- INCHES DEEP. 6. SEED ON A FRESHLY PREPARED SEEDBED AND COVER SEED LIGHTLY WITH SEEDING EQUIPMENT OR CULTIPACK
- AFTER SEEDING. 7. MULCH IMMEDIATELY AFTER SEEDING AND ANCHOR MULCH.
- 8. INSPECT ALL SEEDED AREAS AND MAKE NECESSARY REPAIRS OR RESEEDINGS WITHIN THE PLANTING SEASON, IF POSSIBLE. IF STAND SHOULD BE MORE THAN 60% DAMAGED, RE-ESTABLISH FOLLOWING THE ORIGINAL LIME, FERTILIZER AND SEEDING RATES.
- 9. CONSULT S&EC ENVIRONMENTAL ENGINEERS ON MAINTENANCE TREATMENT AND FERTILIZATION AFTER PERMANENT COVER IS ESTABLISHED.
- 10. \*AGRICULTURAL LIMESTONE 2 TONS/ ACRES (3 TONS/ACRE IN CLAY SOILS) FERTILIZER 1,000 LBS. / ACRE -10-10-10 SUPERPHOSPHATE- 500 LBS> / ACRE -20% ANALYSIS MULCH -2 TONS / ACRE - SMALL GRAIN STRAW ANOTHER - ASPHALT EMULSION @ 300 GALS./ ACRE

PLANTING RATE

25 LBS/ACRE

) GROW OVER 12" IN HEIGHT BEFORE

## SEEDING SCHEDULE

(NOV 1 - MAR 1)

LANDSCAPE PLAN FOR FINAL SEEDING.

AUG 15 - NOV 1 NOV 1 - MAR 1	TALL FESCUE TALL FESCUE & ABRUZZI RYE	300 LBS/ACRE 300 LBS/ACRE 25 LBS/ACRE	
MAR 1 - APR 15 APR 15 - JUN 30 JUL 1 - AUG 15	TALL FESCUE HULLED COMMON BERMUDAGRASS TALL FESCUE AND ***BROWNTOP MILLET ***OR SORGHUM-SUDAN HYBRIDS	300 LBS/ACRE 25 LBS/ACRE 120 LBS/ACRE 35 LBS/ACRE 30 LBS/ACRE	
SLOPES (3	3:1 TO 2:1)		
MAR 1 - JUN 1 (MAR 1 - APR 15)	SERICEA LESPEDEZA (SCARIFIED) AND ADD TALL FESCUE	50 LBS/ACRE 120 LBS/ACRE	
(MAR 1 - JUN 30) (MAR 1 - JUN 30)	OR ADD WEEPING LOVEGRASS OR ADD HULLED COMMON BERMUDAGRASS	10 LBS/ACRE 25 LBS/ACRE	
JUN 1 - SEP 1	***TALL FESCUE AND ***BROWNTOP MILLET	120 LBS/ACRE 35 LBS/ACRE	
SEP 1 - MAR 1	***OR SORGHUM-SUDAN HYBRIDS SERICEA LESPEDEZA (UNHULLED- UNSCARIFED) AND TALL FESCUE	30 LBS/ACRE 70 LBS/ACRE 120 LBS/ACRE	

SHOULDERS, SIDE DITCHES, SLOPES (MAX 3:1)

CONSULT CONSERVATION ENGINEER OR SOIL CONSERVATION SERVICE FOR ADDITIONAL INFORMATION CONCERNING OTHER ALTERNATIVES FOR VEGETATION OF DENLIDED AREAS THE ABOVE VEGETATION RATES ARE THOSE WHICH DO WELL UNDER LOCAL CONDITIONS; OTHER SEEDING RATE COMBINATIONS ARE POSSIBLE

ADD ABRUZZI RYE

MOWING, OTHERWISE FESCUE MAY BE SHADED OUT. \*NOTE: THIS SEEDING SCHEDULE IS FOR EROSION AND SEDIMENT CONTROL ONLY. SEE

\*\*\*TEMPORARY - RESEED ACCORDING TO OPTIMUM SEASON FOR DESIRED. PERMANENT

THE CONTRACTOR SHALL PROVIDE GROUND COVER ON DESIGNATED AREAS AND SLOPES GREATER THAN 3:1 WITHIN 7 DAYS FOLLOWING COMPLETION OF ANY PHASE OF GRADING CONTRACTOR SHALL PROVIDE GROUND COVER IN 14 DAYS ON ALL OTHER AREAS FOLLOWING COMPLETION OF ANY PHASE OF GRADING. PERMANENT GROUND COVER FOR

ALL DISTURBED AREAS SHALL BE PROVIDED WITHIN 15 WORKING DAYS OR 90 CALENDAR

NURSE CROP: WHEN SEEDING BERMUDA GRASS SEED CONTRACTOR SHALL ADD 25 LB/AC OF ANNUAL RYE GRASS AS NURSE CROP UNTIL PERMANENT ESTABLISHMENT OF BERMUDA GRASS

DAYS (WHICHEVER IS SHORTER) FOLLOWING COMPLETION OF CONSTRUCTION.

- 1. UNLESS OTHERWISE INDICATED, ALL VEGETATIVE AND STRUCTURAL EROSION AND SEDIMENT CONTROL MEASURES SHALL BE CONSTRUCTED AND MAINTAINED IN ACCORDANCE WITH THE MINIMUM STANDARDS AND SPECIFICATIONS OF THE NORTH CAROLINA EROSION AND SEDIMENT CONTROL HANDBOOK.
- 2. THE CONTRACTOR SHALL INSTALL AND MAINTAIN THROUGHOUT THE PROJECT CONSTRUCTION ALL EROSION CONTROL MEASURES SHOWN WITHIN THESE PLANS IN ACCORDANCE WITH APPLICABLE NORTH CAROLINA DEPARTMENT OF ENVIRONMENTAL QUALITY (NCDEQ) AND WAKE COUNTY EROSION AND SEDIMENT CONTROL
- 3. ALL CONSTRUCTION WORK SHALL BE IN COMPLIANCE WITH REGULATIONS OF THE NATIONAL POLLUTANT
- 4. ALL EROSION AND SEDIMENT CONTROL MEASURES ARE TO BE PLACED PRIOR TO CLEARING AND/OR LAND
- SITE AT ALL TIMES.
- 6. THE CONTRACTOR SHALL DILIGENTLY AND CONTINUOUSLY MAINTAIN ALL EROSION CONTROL DEVICES AND STRUCTURES TO MINIMIZE EROSION. THE CONTRACTOR SHALL MAINTAIN CLOSE CONTACT WITH THE NCDENR EROSION CONTROL INSPECTOR SO THAT PERIODIC INSPECTIONS CAN BE PERFORMED AT APPROPRIATE STAGES OF CONSTRUCTION.
- 7. APPROVAL OF THIS PLAN IS NOT AN AUTHORIZATION TO GRADE ADJACENT PROPERTIES. WHEN FIELD CONDITIONS WARRANT OFF-SITE GRADING, PERMISSION MUST BE OBTAINED FROM THE AFFECTED PROPERTY OWNERS. CONTACT PROJECT ENGINEER AND PROJECT EROSION CONTROL INSPECTOR TO ENSURE ADDITIONAL
- 8. PRIOR TO COMMENCING LAND DISTURBING ACTIVITIES IN AREAS OTHER THAN INDICATED ON THESE PLANS (INCLUDING, BUT NOT LIMITED TO OFF-SITE BORROW OR WASTE AREAS, STAGING OR STORAGE AREAS), THE CONTRACTOR SHALL PREPARE AND SUBMIT A SUPPLEMENTARY EROSION CONTROL PLAN TO THE OWNER FOR REVIEW AND TO THE WAKE COUNTY FOR APPROVAL. CONTRACTOR SHALL PAY ALL FEES REQUIRED AND SHALL INSTALL NECESSARY MEASURES AT NO SEPARATE PAYMENT. THE CONTRACTOR SHALL PROVIDE THE OWNER
- 9. EROSION AND SEDIMENT CONTROL MEASURES SHALL BE MAINTAINED CONTINUOUSLY, RELOCATED WHEN AND AS
- 10. STABILIZATION IS THE BEST FORM OF EROSION CONTROL. ALL DISTURBED AREAS WHICH ARE NOT OTHERWISE STABILIZED SHALL BE TOP SOILED AND SEEDED, TEMPORARILY OR PERMANENTLY IN ACCORDANCE WITH THE
- 11. CONTRACTOR TO ENSURE THAT SEDIMENT LADEN RUNOFF DOES NOT LEAVE SITE LIMITS OR ENTER PROTECTED
- 12. ROLLED EROSION CONTROL PRODUCTS (RECP'S) SHOULD BE USED TO AID PERMANENT VEGETATED STABILIZATION OF SLOPES 2:1 OR GREATER AND WITH MORE THAN 10' OF VERTICAL RELIEF. RECP'S SHOULD ALSO BE USED WHEN MULCH CANNOT BE ADEQUATELY TACKED AND WHERE IMMEDIATE GROUND COVER IS REQUIRED TO PREVENT EROSION DAMAGE.
- 14. WHERE SEDIMENT IS TRANSPORTED ONTO A PAVED OR PUBLIC ROAD SURFACE, THE ROAD SURFACE SHALL BE CLEANED THOROUGHLY AT THE END OF EACH DAY. SEDIMENT SHALL BE REMOVED FROM THE ROADS BY BE ALLOWED ONLY AFTER SEDIMENT IS REMOVED IN THIS MANNER.
- 15. WHEN A CRUSHED STONE CONSTRUCTION ENTRANCE HAS BEEN COVERED WITH SOIL OR HAS BEEN PUSHED INTO THE SOIL BY CONSTRUCTION TRAFFIC, IT SHALL BE REPLACED WITH A DEPTH OF STONE EQUAL TO THAT OF THE
- AND ALL CONSTRUCTION ACCESS LOCATIONS INTO NON-PAVED AREAS. TWO TO THREE INCH STONE SHALL BE USED FOR THE TEMPORARY GRAVEL CONSTRUCTION ENTRANCE.
- IMMEDIATELY REPLACED AND THE INLET CLEANED. FLUSHING IS NOT AN ACCEPTABLE METHOD OF CLEANING. 18. DURING CONSTRUCTION OF THE PROJECT, SOIL STOCKPILES SHALL BE STABILIZED OR PROTECTED WITH SEDIMENT
- TRAPPING MEASURES. THE APPLICANT IS RESPONSIBLE FOR THE TEMPORARY PROTECTION AND PERMANENT STABILIZATION OF ALL SOIL STOCKPILES ON SITE AS WELL AS SOIL INTENTIONALLY TRANSPORTED FROM THE
- SEDIMENT SHALL BE CONSTRUCTED AS A FIRST STEP IN ANY LAND-DISTURBING ACTIVITY AND SHALL BE MADE FUNCTIONAL BEFORE UPSLOPE LAND DISTURBANCE TAKES PLACE.
- DISTURBING ACTIVITIES AND DURING SITE DEVELOPMENT UNTIL FINAL STABILIZATION IS ACHIEVED.
- DISCHARGE TO RECEIVING OUTLET. 22. THE CONTRACTOR SHALL INSPECT ALL EROSION CONTROL MEASURES PERIODICALLY AND AFTER EACH RUNOFF-PRODUCING EVENT. ANY NECESSARY REPAIRS OR CLEANUP TO MAINTAIN THE EFFECTIVENESS OF THE
- 23. ALL TEMPORARY EROSION CONTROL MEASURES SHALL BE REMOVED BY CONTRACTOR ONCE STABILIZATION OR A

- 26. LIMITS OF GRADING SHOWN ON THE PLAN ARE MAXIMUM LIMITS FOR EROSION CONTROL PURPOSES ONLY. SURVEYOR TO DETERMINE ACTUAL LIMIT.
- EROSION CONTROL ORDINANCE, AND IS SUBJECT TO A FINE.
- 28. GRADING MORE THAN 12,000 SF WITHOUT AN APPROVED EROSION CONTROL PLAN IS A VIOLATION OF THE WAKE COUNTY EROSION CONTROL ORDINANCE AND IS SUBJECT TO A FINE.

# **ABBREVIATIONS**

- \*NOT ALL ABBREVIATIONS MAY BE USED FOR THIS PROJECT
- CB CATCH BASIN
- YI YARD INLET CO - CLEAN OUT

TYP. – TYPICAL

EX — EXISTING FES - FLARED-END-SECTION

> EXISTING TOPOGRAPHICAL INFORMATION IS BASED ON A TOPOGRAPHIC SURVEY OBTAINED ON 02/23/2023 BY CMP PROFESSIONAL LAND SURVEYORS. 333 S. WHITE STREET. WAKE FOREST, NC, 27588, PHONE: (919) 556-3148. CONTRACTOR SHALL BE RESPONSIBLE FOR VERIFYING ALL EXISTING INFORMATION,



EROSION CONTROL NOTES

DISCHARGE ELIMINATION SYSTEM (NPDES) STORM WATER GENERAL PERMIT.

DISTURBANCE. 5. A COPY OF THE APPROVED EROSION AND SEDIMENT CONTROL PLAN AND PERMIT SHALL BE MAINTAINED ON THE

EROSION CONTROL MEASURES ARE INSTALLED PRIOR TO OFF-SITE GRADING.

AND THE ENGINEER A COPY OF THE AMENDED PERMIT.

NECESSARY, AND SHALL BE CHECKED AFTER EVERY RAINFALL. SEEDED AREAS SHALL BE CHECKED REGULARLY AND SHALL BE WATERED, FERTILIZED, RESEEDED AND MULCHED AS NECESSARY TO OBTAIN A DENSE STAND OF

NORTH CAROLINA SEDIMENT CONTROL REGULATIONS. PERMANENT SEEDING AND GRASS ESTABLISHMENT IS REQUIRED PRIOR TO PROJECT COMPLETION AND ACCEPTANCE.

AREAS. ANY SEDIMENT DEPOSITED BEYOND DISTURBED AREA WITHIN SITE LIMITS SHALL BE REMOVED.

13. ALL TEMPORARY EROSION AND SEDIMENT CONTROL MEASURES SHALL BE REMOVED WITHIN 21 DAYS AFTER FINAL SITE STABILIZATION OR AFTER THE TEMPORARY MEASURES ARE NO LONGER NEEDED. TRAPPED SEDIMENT AND THE DISTURBED SOIL AREAS RESULTING FROM THE DISPOSITION OF TEMPORARY MEASURES SHALL BE PERMANENTLY STABILIZED TO PREVENT FURTHER EROSION AND SEDIMENTATION.

SHOVELING OR SWEEPING AND TRANSPORTED TO A SEDIMENT CONTROL DISPOSAL AREA. STREET WASHING SHALL

ORIGINAL APPLICATION. 16. TEMPORARY CONSTRUCTION ENTRANCES SHALL BE REQUIRED AT ALL CONSTRUCTION STAGING AREA ENTRANCES

17. ALL DRAINAGE INLETS SHALL BE PROTECTED FROM SILTATION. INEFFECTIVE PROTECTION DEVICES SHALL BE

19. SEDIMENT BASINS AND TRAPS, PERIMETER DIKES, SEDIMENT BARRIERS AND OTHER MEASURES INTENDED TO TRAP

20. ALL DISTURBED AREAS ARE TO DRAIN TO APPROVED SEDIMENT CONTROL MEASURES AT ALL TIMES DURING LAND

21. DURING DEWATERING OPERATIONS, WATER SHALL BE PUMPED INTO AN APPROVED FILTERING DEVICE PRIOR TO

EROSION CONTROL DEVICES SHALL BE MADE IMMEDIATELY. SUFFICIENT GROUND COVER HAS BEEN ESTABLISHED OR AS DIRECTED BY THE ENGINEER. WAKE COUNTY

INSPECTOR'S FINAL APPROVAL IS REQUIRED. 24. STABILIZATION MEASURES SHALL BE APPLIED TO STRUCTURES SUCH AS DAMS, DIKES AND DIVERSIONS

25. ADDITIONAL EROSION CONTROL MEASURES MAY BE REQUIRED DEPENDING UPON FIELD CONDITIONS.

27. ANY GRADING BEYOND THE DENUDED LIMITS SHOWN ON THE PLAN IS A VIOLATION OF THE WAKE COUNTY

IMMEDIATELY AFTER INSTALLATION.


DI - DROP INLET

RCP - REINFORCED CONCRETE PIPE

JB - JUNCTION BOX LOD - LIMITS OF DISTURBANCE PVC - POLYVINYL CHLORIDE

> DEPICTED OR NOT PRIOR TO CONSTRUCTION AND REPORT POTENTIAL CONFLICTS TO OWNER AND ENGINEER.

(a) (4) (a) (c) (c)

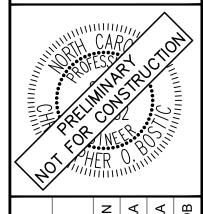


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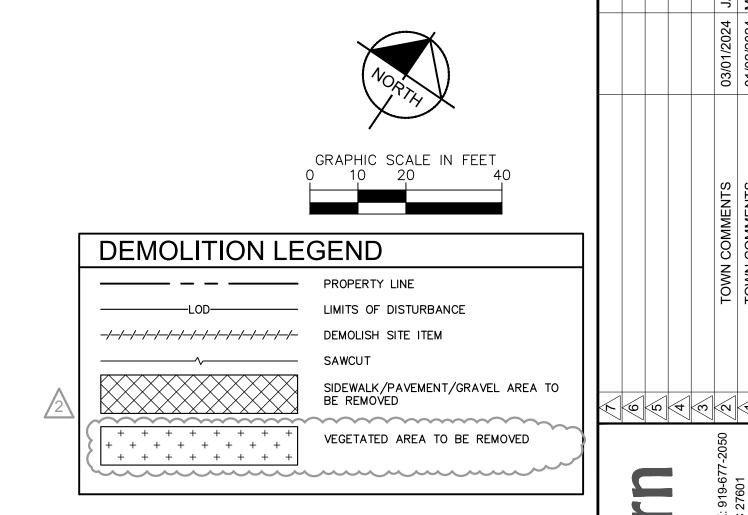
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SHEET NUMBER

SDP-23-09

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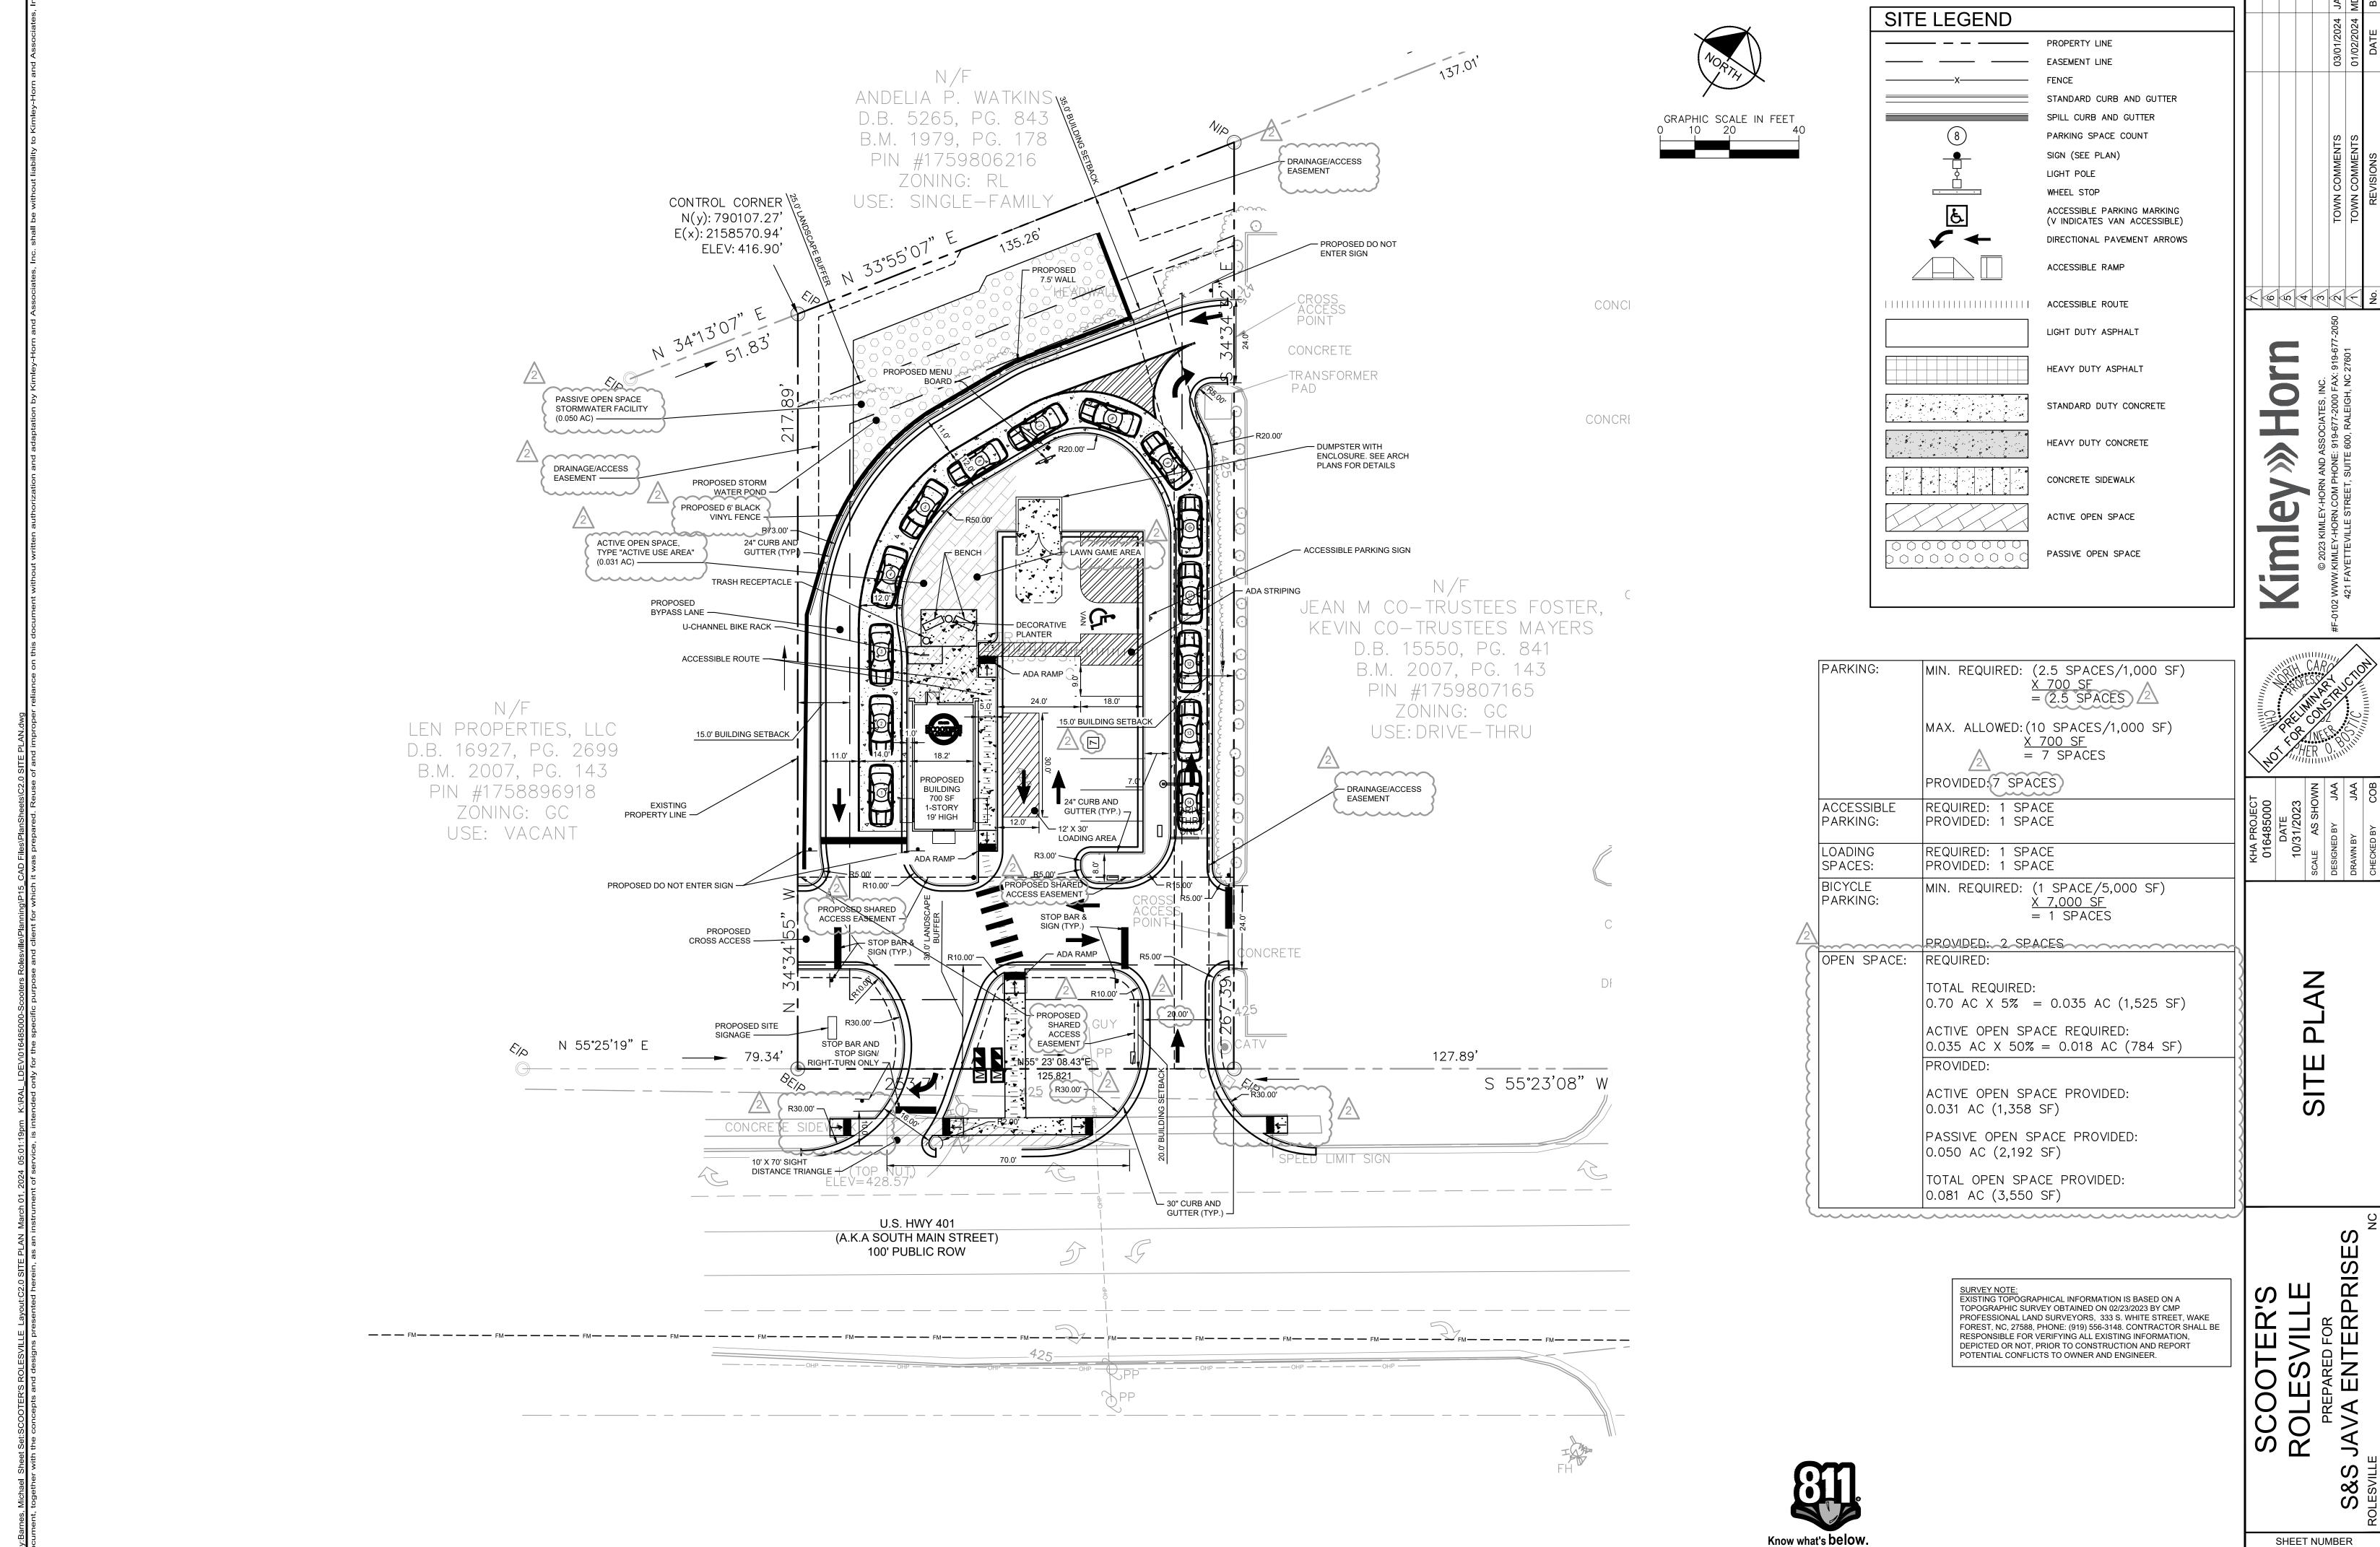





SHEET NUMBER C1.0
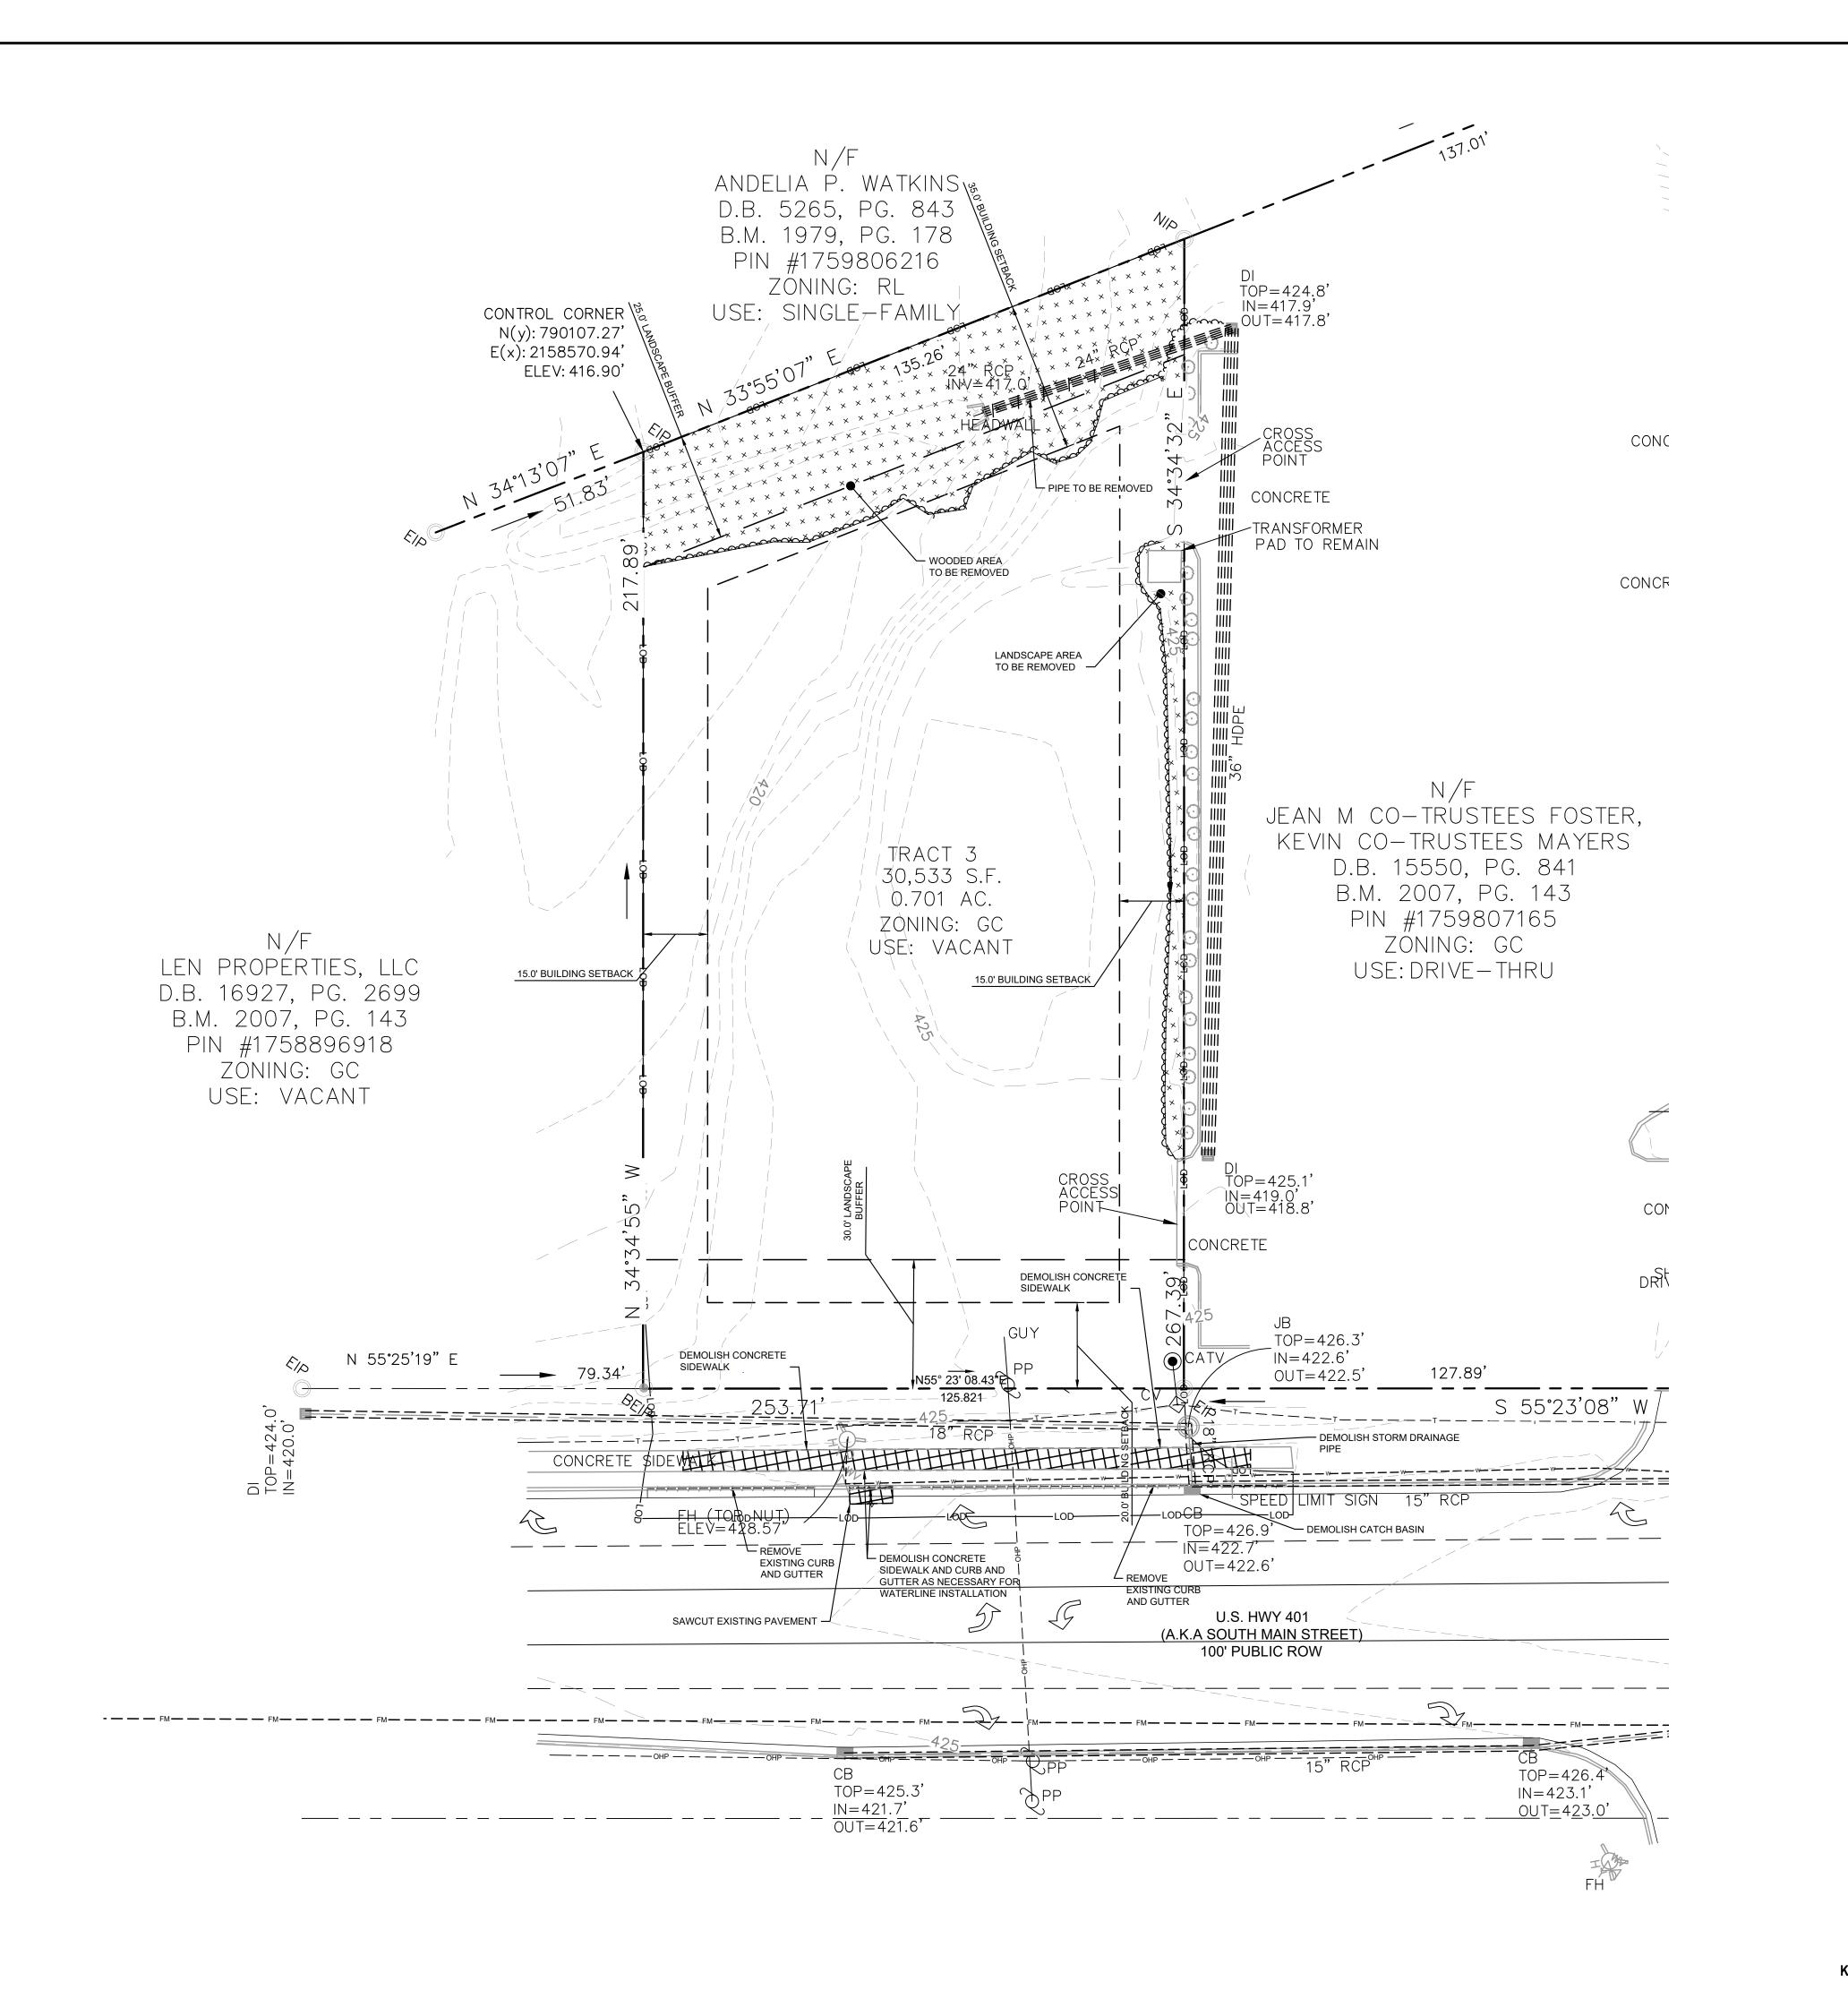
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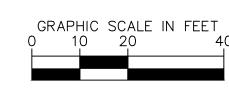
FOREST, NC, 27588, PHONE: (919) 556-3148. CONTRACTOR SHALL BE RESPONSIBLE FOR VERIFYING ALL EXISTING INFORMATION, DEPICTED OR NOT, PRIOR TO CONSTRUCTION AND REPORT POTENTIAL CONFLICTS TO OWNER AND ENGINEER.



SDP-23-09



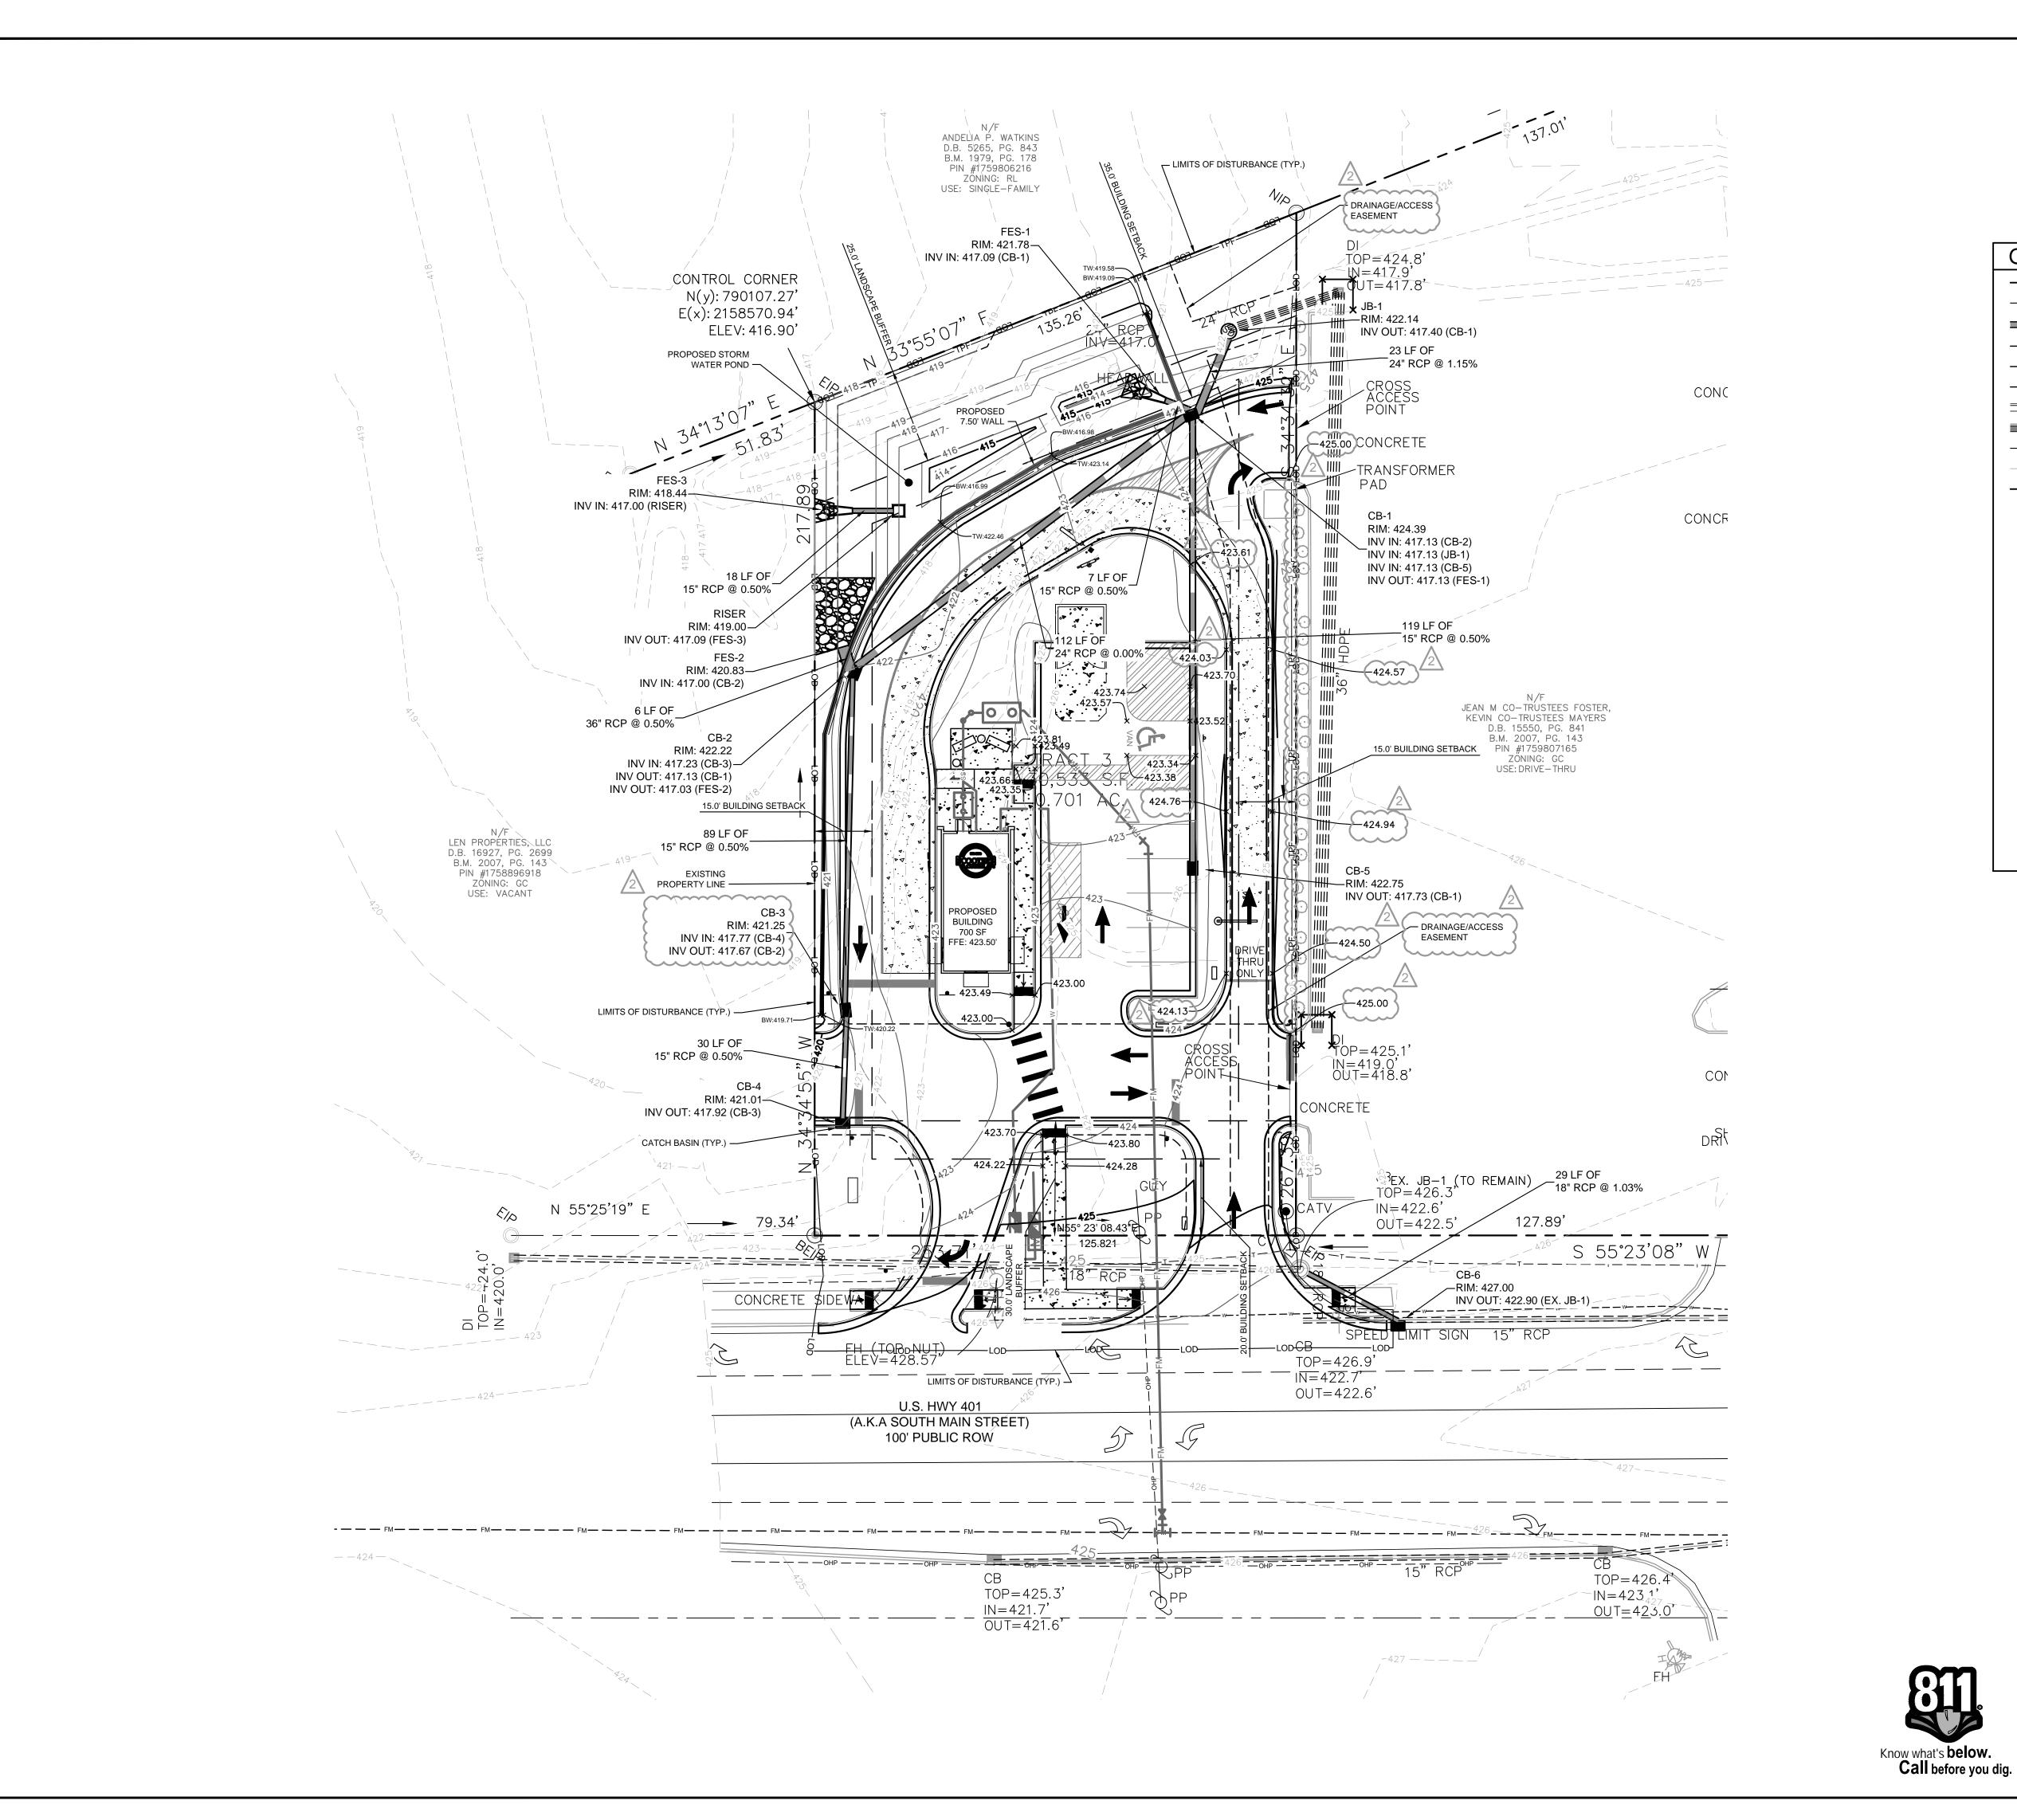




GRADING AND	DRAINAGE LEGEND
	PROPERTY LINE
TCE-	TEMPORARY CONSTRUCTION EASEMENT
	■ STORM DRAIN (≥ 12 INCH)
SD	- STORM DRAIN (< 12 INCH)
RD	ROOF DRAIN
UD	UNDER DRAIN
	CURB AND GUTTER
	SPILL CURB AND GUTTER
CL	- CLEARING LIMITS
— — — — — 805— — — — —	EXISTING CONTOUR
805	- PROPOSED CONTOUR
*—826.00	SPOT ELEVATION
	CATCH BASIN (CB)
(SD)	MANHOLE (SDMH)
•	CLEANOUT (SDCO)
•	DROP INLET (DI)
	AREA DRAIN (AD)
	CONTROL STRUCTURE (CS)
	FLARED END SECTION (FES)
	CONCRETE HEADWALL (HW)
	RIP-RAP APRON
~~ <del>-</del>	FLOW ARROW
TW	TOP OF WALL (GRADE ELEV.)
BW	BOTTOM OF WALL (GRADE ELEV.)
TP	TOP OF PAVEMENT (GRADE ELEV.)
TC	TOP OF CURB (GRADE ELEV.)
TC/TP	FLUSH CURB (GRADE ELEV.)
WT	WATER TIGHT JOINTS (WT)

SHEET NUMBER C3.0


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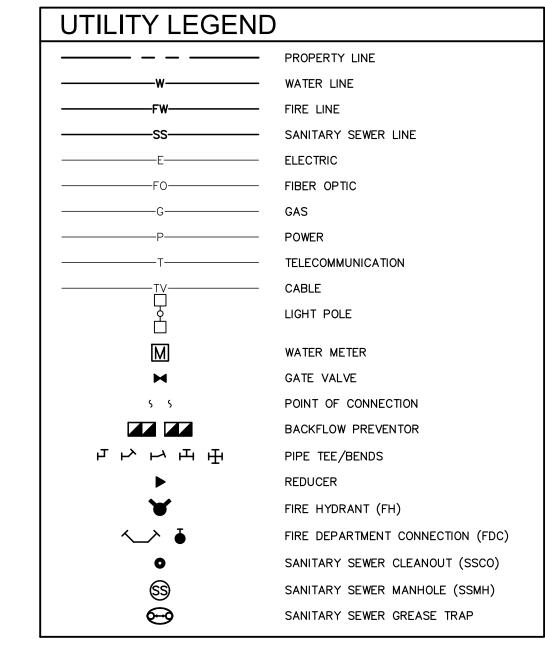
FOREST, NC, 27588, PHONE: (919) 556-3148. CONTRACTOR SHALL BE RESPONSIBLE FOR VERIFYING ALL EXISTING INFORMATION, DEPICTED OR NOT, PRIOR TO CONSTRUCTION AND REPORT


POTENTIAL CONFLICTS TO OWNER AND ENGINEER.



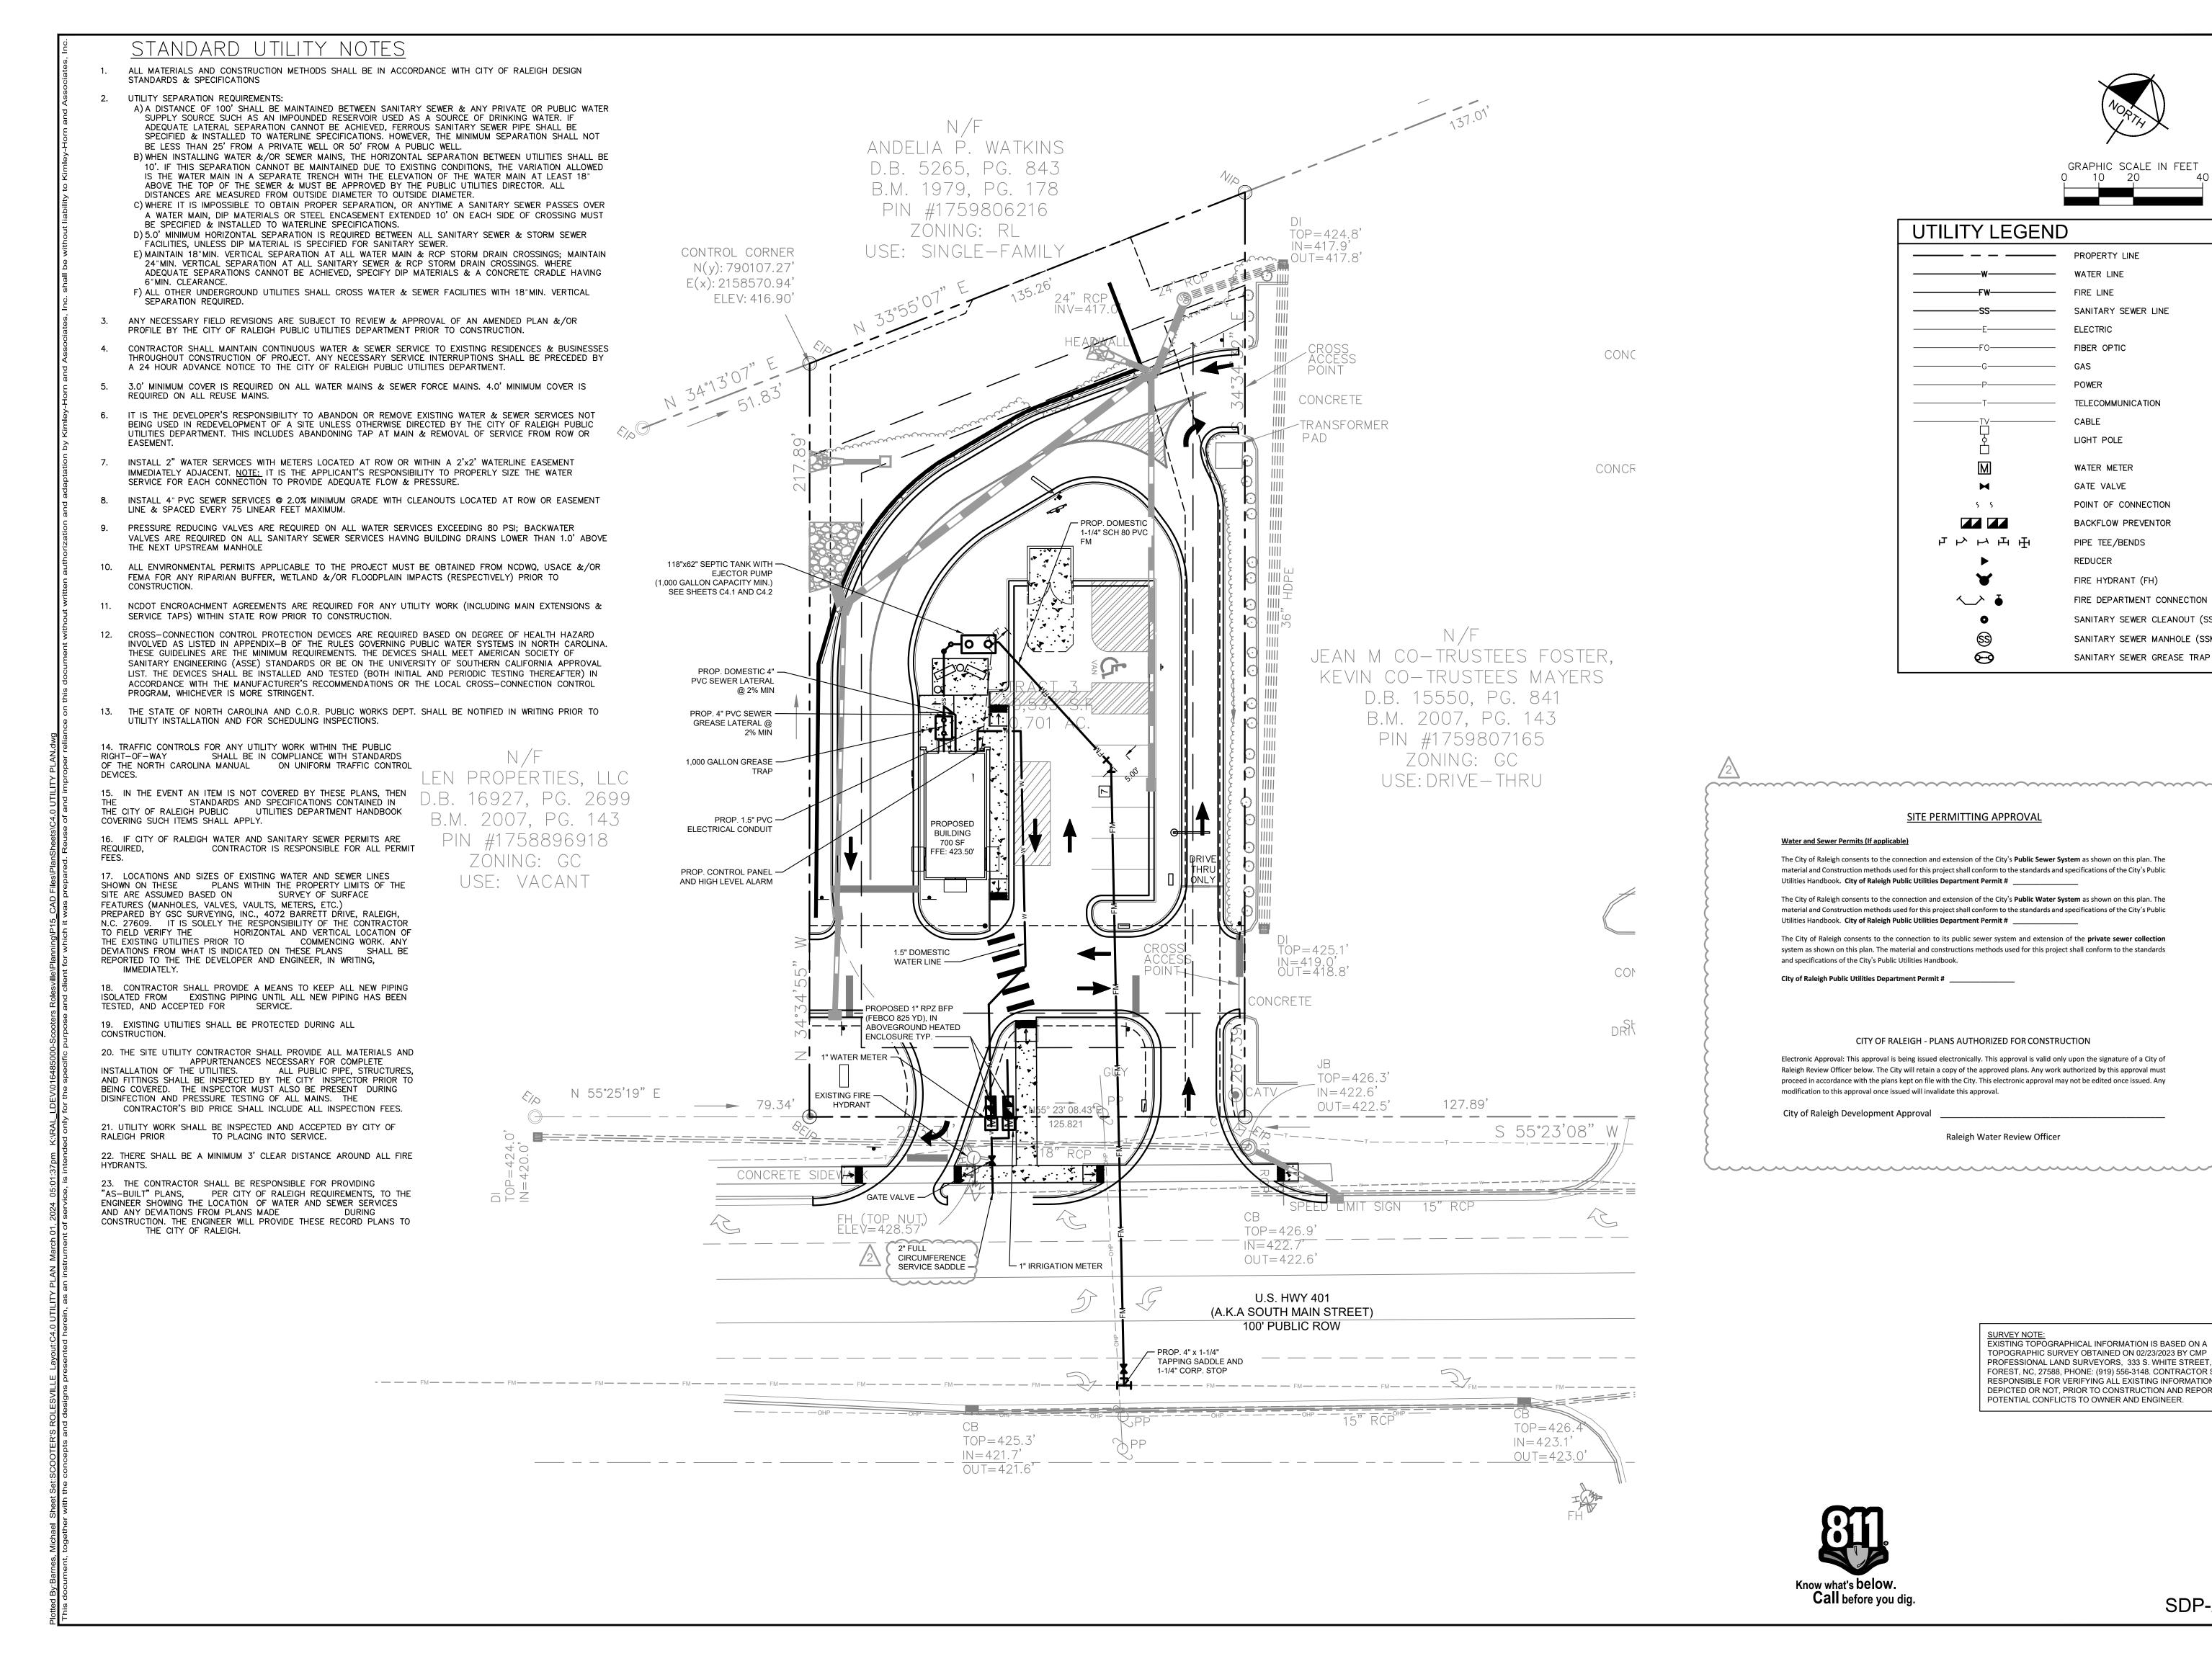



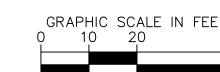

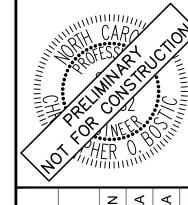

CITY OF RALEIGH - PLANS AUTHORIZED FOR CONSTRUCTION

Electronic Approval: This approval is being issued electronically. This approval is valid only upon the signature of a City of Raleigh Review Officer below. The City will retain a copy of the approved plans. Any work authorized by this approval must proceed in accordance with the plans kept on file with the City. This electronic approval may not be edited once issued. Any modification to this approval once issued will invalidate this approval.

SITE PERMITTING APPROVAL

The City of Raleigh consents to the connection and extension of the City's Public Sewer System as shown on this plan. The

material and Construction methods used for this project shall conform to the standards and specifications of the City's Public

The City of Raleigh consents to the connection and extension of the City's **Public Water System** as shown on this plan. The

material and Construction methods used for this project shall conform to the standards and specifications of the City's Public

The City of Raleigh consents to the connection to its public sewer system and extension of the **private sewer collection** 

system as shown on this plan. The material and constructions methods used for this project shall conform to the standards

Utilities Handbook. City of Raleigh Public Utilities Department Permit #

Utilities Handbook. City of Raleigh Public Utilities Department Permit #

City of Raleigh Public Utilities Department Permit #

and specifications of the City's Public Utilities Handbook.

City of Raleigh Development Approval

Water and Sewer Permits (If applicable)

Raleigh Water Review Officer

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SHEET NUMBER C4.0

SPLICE BOX (NEMA 4X)

- SPLICE BOX (NEMA 4X)

MECHANICAL PLAN VIEW

— SANITARY TEE

ROTH 1000 GAL MODEL RMT-1000E

C4.1

4" SCH 40 PVC — SUPPORTS

MECHANICAL SECTION VIEW

CONDUIT SEAL -(TO CONTROL PANEL)

FLOAT SWITCH —

┌─ 48" BIOTUBE PUMP VAULT - LEVEL CONTROL FLOAT ASSEMBLY

SCALE: NTS

SCALE: NTS

EFFLUENT DISCHARGE (1.25" SCH 80)

— HANGING DISCHARGE ASSEMBLY

EFFLUENT DISCHARGE (1.25" SCH 80)

- HIGH PRESSURE

LEVEL CONTROL FLOAT ASSEMBLY

- BRASS CHECK VALVE

— VAULT INLET PORTS

- FILTER CARTRIDGE

— 48" BIOTUBE PUMP

FLEX HOSE

24" DIA. GASKETED -FIBERGLASS LID (TYP.)

C4.1

24" DIA. PVC RISER WITH 24" -GASKETED FIBERGLASS LID

SLOPE GRADE AWAY — FROM RISERS (TYP.)

24" DIA. FRTA24-RVF — PVC RISER ADAPTER


4" INLET WITH —


**BOOTED OPENING** 

4" INLET WITH -BOOTED OPENING

NTROL	SEPTIC TA	NK GENERAL INFORMATION
IS.	AVERAGE DAILY FLOW	306 GPD
	TANK	1000 GAL ROTH TANK
	TANK DIMENSIONS	118"x62"x52"
	DISCHARGE PIPING	1.25"Ø SCH 80 PVC
	CONTROL PANEL	ORENCO S1
	HORSEPOWER	1 HP (NON-OVERLOADING OVER ENTIRE PUMP CURVE)
	VOLTAGE/PHASE/CYCLES	240 V / 1 PHASE / 60 HZ
	PUMP	ORENCO PF100511
	PRIMARY LEVEL SENSING METHOD	FLOATS (3)
	FLOAT SETTINGS	9", 12" (FROM TOP OF TANK)
	FLOAT FUNCTIONS	HIGH LEVEL, ON/OFF

# **Pump Curves**

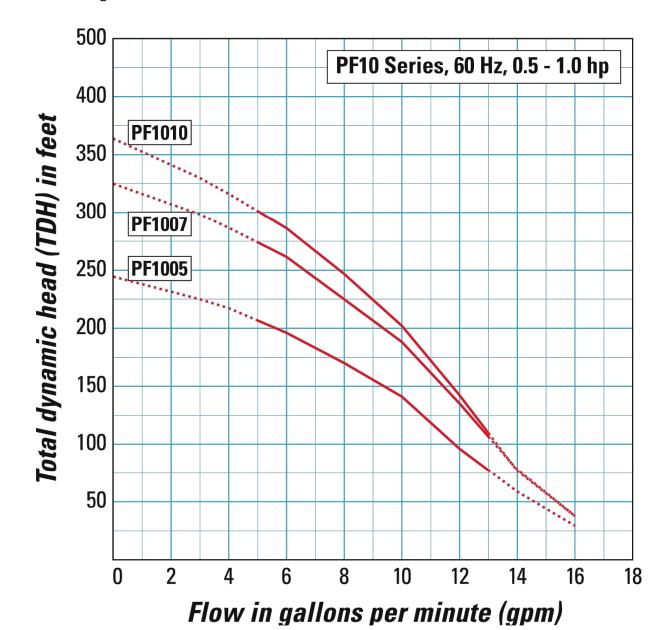

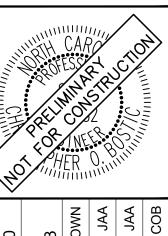

MECHANICAL

S&S


SHEET NUMBER C4.1

Know what's below.
Call before you dig.

SDP-23-09

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NILET PORT

OUTLET PORT

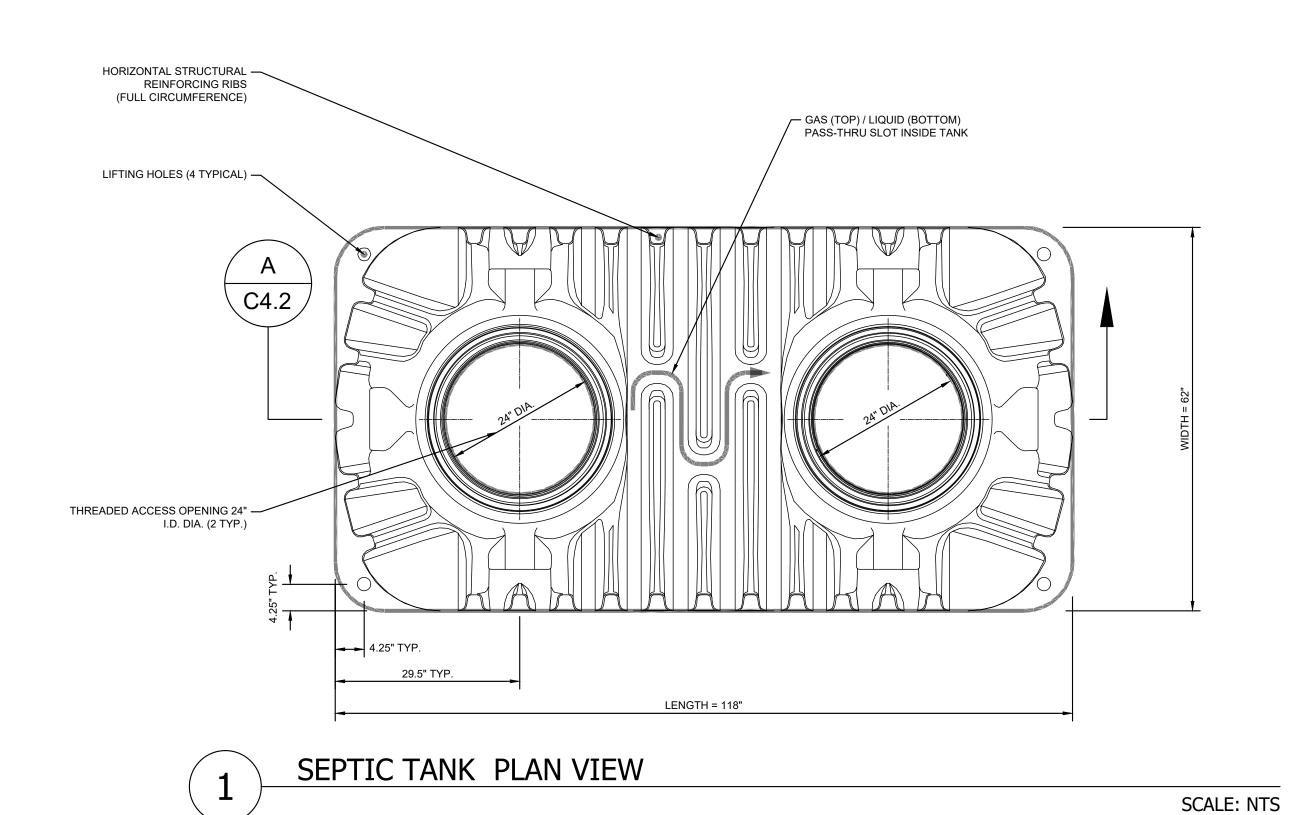LENGTH = 118°

THREADED ACCESS
OPENING
24\*I.D. DIA.

40' LIOUID LEVEL

HORIZONTAL STRUCTURAL
REINFORCING RIBS (FULL
CIRCUMFERENCE)

2/3 TANK LENGTH

1/3 TANK LENGTH

A C4.2

SEPTIC TANK SECTION VIEW

SCALE: NTS

2 SEPTIC TANK ELEVATION VIEW

SCALE: NTS

SCALE AS SHOWN
DESIGNED BY JAA

CHECKED BY COB

SEPTIC TANK DETAILS


SCOOTER'S
ROLESVILLE
PREPARED FOR
3 JAVA ENTERPRISES
LE

AND SASS
SHEET NUMBER
C4.2

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## EROSION CONTROL LEGEND TEMPORARY CONSTRUCTION EASEMENT CLEARING LIMITS TREE PROTECTION FENCE COMBINATION TREE PROTECTION/ $\longrightarrow$ TD $\longrightarrow$ TD $\longrightarrow$ TEMPORARY DIVERSION DITCH CLEAN WATER DIVERSION DITCH SEDIMENT BASIN POROUS BAFFLES >>>> PUMP DISCHARGE HOSE EXISTING CONTOUR PROPOSED CONTOUR DRAINAGE AREA BOUNDARY CONSTRUCTION ENTRANCE $\geq$ SILT FENCE OUTLET CONCRETE WASHOUT STATION ROCK CHECK DAM INLET PROTECTION ROCK PIPE INLET PROTECTION TEMPORARY SLOPE DRAIN RIP-RAP OUTLET PROTECTION SILT BAG DESIGNATED AREAS TO BE STABILIZED WITHIN 7 DAYS TEMPORARY EROSION CONTROL MATTING

## PHASE 1 CONSTRUCTION SEQUENCE:

- 1. THE FOLLOWING PHASE 1 CONSTRUCTION SEQUENCE IS FURNISHED AS A GENERAL GUIDE FOR PREPARATION OF A SEQUENCE OF CONSTRUCTION EVENTS.
- 2. SCHEDULE AN ON-SITE PRE-CONSTRUCTION CONFERENCE WITH WAKE COUNTY ENVIRONMENTAL CONSULTANT TO DISCUSS EROSION CONTROL MEASURES.
- 3. OBTAIN LAND-DISTURBING PERMIT FROM WAKE COUNTY.
- 4. INSTALL TEMPORARY CONSTRUCTION ENTRANCE, SILT FENCE, INLET PROTECTION, , TREE PROTECTION, AND OTHER MEASURES AS SHOWN ON PLANS, CLEARING ONLY AS NECESSARY TO INSTALL THESE DEVICES (SEE LOD FOR INITIAL CLEARING LIMITS). SEED, MAT, MULCH, AND ANCHOR DIVERSION DITCHES AND BASIN IMMEDIATELY AFTER CONSTRUCTION AS APPROPRIATE.
- 5. CALL FOR ON—SITE INSPECTION BY WAKE COUNTY ENVIRONMENTAL CONSULTANT ONCE ALL EROSION CONTROL MEASURES ARE INSTALLED. OBTAIN CERTIFICATE OF COMPLIANCE FROM WAKE COUNTY
- 6. ONCE CERTIFICATE OF COMPLIANCE HAS BEEN OBTAINED, APPLY FOR NCDEQ eNOI ON NCDEO WERSITE
- UPON APPROVAL, CLEARING AND DEMOLITION MAY BEGIN. MAINTAIN ALL EROSION CONTROL MEASURES AS NECESSARY. EROSION CONTROL MEASURES SHALL BE RESTORED TO ORIGINAL DIMENSIONS WHEN SEDIMENT ACCUMULATES TO 50% OF DESIGN DEPTH.
- 8. INSPECT AND REPAIR EROSION CONTROL MEASURES AFTER EVERY RAINFALL EVENT OF 1/2" OR GREATER OR EVERY SEVEN (7) CALENDAR DAYS.
- 9. FOR PHASED EROSION CONTROL PLANS, CONTRACTOR SHALL MEET WITH EROSION CONTROL INSPECTOR PRIOR TO COMMENCING EACH PHASE OF EROSION CONTROL MEASURES. SEED AND MULCH DENUDED AREA WITHIN 15 CALENDAR DAYS AFTER ANY PHASE OF GRADING. MAINTAIN SOIL EROSION CONTROL MEASURES UNTIL PERMANENT GROUND COVER IS ESTABLISHED.
- 10. ALL EROSION CONTROL MEASURES SHALL BE CONSTRUCTED IN ACCORDANCE WITH THE NCDENR EROSION AND SEDIMENT CONTROL PLANNING AND DESIGN MANUAL, U.S. DEPARTMENT OF AGRICULTURE, AND TOWN OF CARY EROSION CONTROL ORDINANCE.
- 11. REFER TO SHEET CO.1 GENERAL NOTES FOR GENERAL EROSION CONTROL NOTES AND MAINTENANCE.

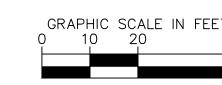LIMITS OF DISTURBANCE: 0.77 AC

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POTENTIAL CONFLICTS TO OWNER AND ENGINEER.



19-677-2050 2 TOWN COMMENTS
7601 10. REVISIONS

© 2023 KIMLEY-HORN AND ASSOCIATES, INC 02 WWW.KIMLEY-HORN.COM PHONE: 919-677-2000 FA 421 FAYETTEVILLE STREET, SUITE 600, RALEIGH, N

OWN JAA JAHAN JAHA

SCALE AS SHOWN
DESIGNED BY JAA
DRAWN BY JAA


OSION CONTRC LAN - PHASE 1

ROLESVILLE
PREPARED FOR
AVA ENTERPRISES

SHEET NUMBER

∞



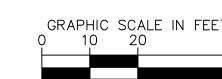

## **EROSION CONTROL LEGEND** — — — PROPERTY LINE TEMPORARY CONSTRUCTION EASEMENT CLEARING LIMITS -TPF-----TREE PROTECTION FENCE COMBINATION TREE PROTECTION/ $\longrightarrow$ TD $\longrightarrow$ TD $\longrightarrow$ TEMPORARY DIVERSION DITCH CLEAN WATER DIVERSION DITCH SEDIMENT BASIN POROUS BAFFLES PUMP DISCHARGE HOSE EXISTING CONTOUR PROPOSED CONTOUR DRAINAGE AREA BOUNDARY CONSTRUCTION ENTRANCE $\geq$ SILT FENCE OUTLET CONCRETE WASHOUT STATION ROCK CHECK DAM INLET PROTECTION ROCK PIPE INLET PROTECTION TEMPORARY SLOPE DRAIN RIP-RAP OUTLET PROTECTION SILT BAG DESIGNATED AREAS TO BE STABILIZED WITHIN 7 DAYS TEMPORARY EROSION CONTROL MATTING

## PHASE 2 CONSTRUCTION SEQUENCE:

- 1. THE FOLLOWING PHASE 2 CONSTRUCTION SEQUENCE IS FURNISHED AS A GENERAL GUIDE FOR PREPARATION OF A SEQUENCE OF CONSTRUCTION EVENTS.
- 2. MAINTAIN CONSTRUCTION ENTRANCE AND SILT FENCE.
- 3. CALL FOR ON-SITE INSPECTION BY INSPECTOR ONCE ALL PHASE 2 EROSION CONTROL MEASURES ARE INSTALLED. OBTAIN CERTIFICATE OF COMPLIANCE FROM WAKE COUNTY.
- 4. CONTRACTOR IS TO CUT AND/OR FILL AREAS TO BRING THE SITE TO THE PROPOSED GRADES SHOWN ON THE GRADING AND DRAINAGE PLANS. GRADING ACTIVITY SHALL BE LIMITED TO WITHIN THE CLEARING LIMITS. MAINTAIN ALL EROSION CONTROL MEASURES AS NECESSARY.
- 5. PROVIDE GROUND COVER ON SLOPES GREATER THAN 3:1 WITHIN 7 DAYS FOLLOWING COMPLETION OF ANY PHASE OF GRADING. PROVIDE GROUND COVER TO ALL OTHER AREAS WITHIN 14 DAYS FOLLOWING COMPLETION OF ANY PHASE OF GRADING OR INACTIVITY.
- 6. INSTALL STORM DRAINAGE AND PROTECT INLETS WITH BLOCK AND GRAVEL INLET CONTROLS, SEDIMENT TRAPS, OR OTHER APPROVED MEASURES AS SHOWN ON THE PLAN.
- 7. STABILIZE SITE AS AREAS ARE BROUGHT UP TO FINISH GRADE WITH VEGETATION, PAVING, DITCH LININGS, ETC. SEED AND MULCH DENUDED AREAS PER GROUND STABILIZATION TIME
- 8. INSPECT AND REPAIR EROSION CONTROL MEASURES AFTER EVERY RAINFALL EVENT OF 1/2" OR
- GREATER OR EVERY SEVEN (7) CALENDAR DAYS.
- 9. ALL EROSION CONTROL MEASURES SHALL BE CONSTRUCTED IN ACCORDANCE WITH THE NCDENR EROSION AND SEDIMENT CONTROL PLANNING AND DESIGN MANUAL, U.S. DEPARTMENT OF AGRICULTURE, AND CITY OF GREENVILLE EROSION CONTROL ORDINANCE.
- 10. REFER TO SHEET CO.1 GENERAL NOTES FOR GENERAL EROSION CONTROL NOTES AND MAINTENANCE.
- 11. ALL EROSION CONTROL MEASURES TO REMAIN IN PLACE UNTIL +/- 80% STABILIZATION IS ACHIEVED.
- 12. ONCE CONSTRUCTION IS COMPLETE AND ENTIRE SITE IS STABILIZED, CALL FOR FINAL INSPECTION BY WAKE COUNTY ENVIRONMENTAL CONSULTANT. IF APPROVED, REMOVE REMAINING EROSION CONTROL MEASURES. ALL REMAINING PERMANENT EROSION CONTROL DEVICES SHOULD NOW BE INSTALLED.
- 13. WHEN VEGETATION HAS BECOME ESTABLISHED, CALL FOR A FINAL INSPECTION BY WAKE COUNTY ENVIRONMENTAL CONSULTANT. OBTAIN A CERTIFICATE OF COMPLETION.

LIMITS OF DISTURBANCE: 0.77 AC


SURVEY NOTE:
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PROFESSIONAL LAND SURVEYORS, 333 S. WHITE STREET, WAKE
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DEPICTED OR NOT, PRIOR TO CONSTRUCTION AND REPORT
POTENTIAL CONFLICTS TO OWNER AND ENGINEER.



919-677-2050
27601
10. REVISIONS

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WWW.KIMLEY-HORN.COM PHONE: 919-677-2000 FAX
421 FAYETTEVILLE STREET, SUITE 600, RALEIGH, NC

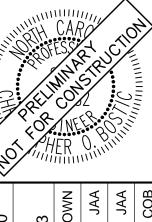


10/31/2023
SCALE AS SHOWN
DESIGNED BY JAA
DRAWN BY JAA

OSION CONTRC

OLESVILLE
PREPARED FOR
VA ENTERPRISES

SHEET NUMBER

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	DATE	TYPE	PLANTING RATE	REGION	SEEDBED PREPARATION:
	JAN. 1 - MAY 1	RYE (GRAIN)	120 LBS/ACRE	PIEDMONT	<ol> <li>TILL OR DISK THE PREPARED AREAS TO BE SEEDED TO A MINIMUM DEPTH OF FOUR INCHES.</li> </ol>
	JAN. 1 - MAY 1	ANNUAL LESPEDEZA (KOBE)	50 LBS/ACRE	PIEDMONT	2. REMOVE STONES LARGER THAN THREE INCHES ON ANY SIDE, STICKS, ROOTS AND OTHER
	MAY 1 - AUG. 15	GERMAN MILLET	40 LBS/ACRE	PIEDMONT	EXTRANEOUS MATERIALS THAT SURFACE.  3. IF NOT INCORPORATED DURING THE SOIL PREPARATION PROCESS, ADD pH MODIFIER AND
	MAY 1 - AUG. 15	SMALL-STEMMED SUDANGRASS	50 LBS/ACRE	PIEDMONT	FERTILIZERS AT THE RATE SPECIFIED IN THE SOIL TEST REPORT. IF THERE IS NO SOIL
G	AUG. 15 - DEC. 30	RYE (GRAIN)	120 LBS/ACRE	PIEDMONT	TEST REPORT, FOLLOW SOIL AMENDMENTS BELOW.  4. RE—COMPACT THE AREA UTILIZING A CULTIPACKER ROLLER. THE FINISHED GRADE SHALL
	DEC. 1 - APR. 15	RYE (GRAIN)	120 LBS/ACRE	COASTAL PLAIN	BE A SMOOTH EVEN SOIL SURFACE WITH A LOOSE, UNIFORMLY FINE TEXTURE.
	DEC. 1 - APR. 15	ANNUAL LESPEDEZA (KOBE)	50 LBS/ACRE	COASTAL PLAIN	5. EVENLY APPLY SEED USING A CYCLONE SEEDER (BROADCAST), DRILL, CULTIPACKER SEEDER, OR HYDROSEEDER. SMALL GRAINS SHOULD BE PLANTED NO MORE THAN 1 INCH
	APR. 15 - AUG. 15	GERMAN MILLET	40 LBS/ACRE	COASTAL PLAIN	DEEP, AND GRASSES AND LEGUMES NO MORE THAN 1/2 INCH. BROADCAST SEED MUST BE
	AUG. 15 - DEC. 30	RYE (GRAIN)	120 LBS/ACRE	COASTAL PLAIN	COVERED BY RAKING OR CHAIN DRAGGING, AND THEN LIGHTLY FIRMED WITH A ROLLER OR CULTIPACKER. HYDROSEEDED MIXTURES SHOULD INCLUDE A WOOD FIBER (CELLULOSE)
	FEB. 15 - MAY 15	RYE (GRAIN)	120 LBS/ACRE	MOUNTAINS - ABOVE 2500 FEET	MULCH.
	FEB. 1 — MAY 1	RYE (GRAIN)	120 LBS/ACRE	MOUNTAINS - BELOW 2500 FEET	NOTES:
T ICE	FEB. 15 - MAY 15	ANNUAL LESPEDEZA (KOREAN)	50 LBS/ACRE	MOUNTAINS - ABOVE 2500 FEET	
	FEB. 1 — MAY 1	ANNUAL LESPEDEZA (KOREAN)	50 LBS/ACRE	MOUNTAINS - BELOW 2500 FEET	<ol> <li>CONSULT CONSERVATION ENGINEER OR SOIL CONSERVATION SERVICE FOR ADDITIONAL INFORMATION CONCERNING OTHER ALTERNATIVES FOR VEGETATION OF DENUDED AREAS.</li> </ol>
_	MAY 15 - AUG. 15	GERMAN MILLET	40 LBS/ACRE	MOUNTAINS	THE ABOVE VEGETATION RATES ARE THOSE WHICH DO WELL UNDER LOCAL CONDITIONS; OTHER SEEDING RATE COMBINATIONS ARE POSSIBLE.
	MAY 15 - AUG. 15	SMALL-STEMMED SUDANGRASS	50 LBS/ACRE	MOUNTAINS	2. THIS SEEDING SCHEDULE IS FOR EROSION AND SEDIMENT CONTROL ONLY. SEE
C	AUG. 15 - DEC. 15	RYE (GRAIN)	120 LBS/ACRE	MOUNTAINS	LANDSCAPE PLAN FOR FINAL SEEDING.
, Č					<ol><li>THE CONTRACTOR SHALL PROVIDE GROUND COVER ON DESIGNATED AREAS AND SLOPES GREATER THAN 3:1 WITHIN 7 DAYS FOLLOWING COMPLETION OF ANY PHASE OF GRADING.</li></ol>

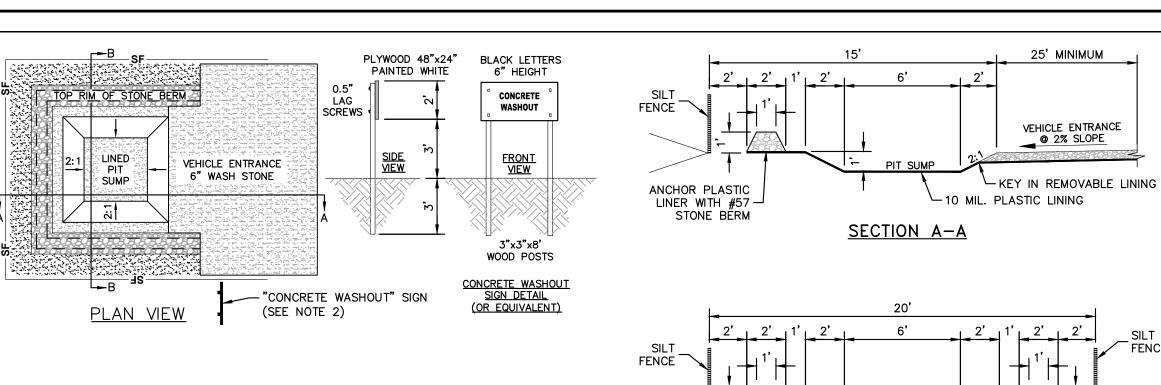EEDBED PREPARATION: TILL OR DISK THE PREPARED AREAS TO BE SEEDED TO A MINIMUM DEPTH OF FOUR 6. COMPLETE GRADING BEFORE PREPARING SEEDBEDS, AND INSTALL ALL NECESSARY EROSION CONTROL PRACTICES SUCH AS, DIKES, WATERWAYS, AND BASINS.

2. REMOVE STONES LARGER THAN THREE INCHES ON ANY SIDE, STICKS, ROOTS AND OTHER EXTRANEOUS MATERIALS THAT SURFACE.

4. CONTRACTOR SHALL PROVIDE GROUND COVER IN 14 DAYS ON ALL OTHER AREAS

WORKING DAYS OR 90 CALENDAR DAYS (WHICHEVER IS SHORTER) FOLLOWING

5. PERMANENT GROUND COVER FOR ALL DISTURBED AREAS SHALL BE PROVIDED WITHIN 15

FOLLOWING COMPLETION OF ANY PHASE OF GRADING.

COMPLETION OF CONSTRUCTION.

1. INLET MAINTENANCE SHALL BE

INSTALLATION.

THE ENGINEER.

DOCUMENTED IN PROJECT LOG BOOK.

2. FILTER TYPES SHALL BE APPROVED BY

3. FILTER BAGS MAY BE REMOVED WHEN

4. FILTER BAGS SHALL BE REMOVED PRIOR

BE MORE THAN HALF FULL AT ANY

SITE IS STABILIZED AT THE DIRECTION OF

THE CITY INSPECTOR PRIOR TO

7. IF SOILS BECOME COMPACTED DURING GRADING, LOOSEN THEM TO A DEPTH OF 6-8 3. IF NOT INCORPORATED DURING THE SOIL PREPARATION PROCESS, ADD pH MODIFIER AND

INCHES USING A RIPPER, HARROW, OR CHISEL PLOW. 8. THE USE OF AN APPROPRIATE MULCH WILL HELP ENSURE ESTABLISHMENT UNDER NORMAL CONDITIONS, AND IS ESSENTIAL TO SEEDING SUCCESS UNDER HARSH SITE CONDITIONS.

**SOIL AMENDMENTS:** 

LATE WINTER THROUGH SUMMER: FOLLOW RECOMMENDATIONS OF SOIL TESTS OR APPLY 2000 LB/ACRE GROUND AGRICULTURAL LIMESTONE AND 750 LB/ACRE 10-10-10 FERTILIZER.

FALL: FOLLOW RECOMMENDATIONS OF SOIL TESTS OR APPLY 2000 LB/ACRE GROUND AGRICULTURAL LIMESTONE AND 1000 LB/ACRE 10-10-10 FERTILIZER.

APPLY 4000 LB/ACRE STRAW. ANCHOR STRAW BY TACKING WITH ASPHALT, NETTING, OR A MULCH ANCHORING TOOL. A DISK WITH BLADES SET NEARLY STRAIGHT CAN BE USED INFORMATION CONCERNING OTHER ALTERNATIVES FOR VEGETATION OF DENUDED AREAS. AS A MULCH ANCHORING TOOL. THE ABOVE VEGETATION RATES ARE THOSE WHICH DO WELL UNDER LOCAL CONDITIONS;

LATE WINTER THROUGH SUMMER: REFERTILIZE IF GROWTH IS NOT FULLY ADEQUATE. RESEED, FERTILIZE AND MULCH IMMEDIATELY FOLLOWING EROSION OR OTHER DAMAGE. GREATER THAN 3:1 WITHIN 7 DAYS FOLLOWING COMPLETION OF ANY PHASE OF GRADING. FALL: REPAIR AND REFERTILIZE DAMAGED AREAS IMMEDIATELY. TOPDRESS WITH 50 LB/ACRE OF NITROGEN IN MARCH. IF IT IS NECESSARY TO EXTEND TEMPORARY COVER

BEYOND JUNE 15, OVERSEED WITH 50 LB/ACRE KOBE (PIEDMONT AND COASTAL PLAIN) OR KOREAN (MOUNTAINS) LESPEDEZA IN LATE FEBRUARY OR EARLY MARCH.

KHA DETAIL NO: 01.104.R0

- DEFLECTOR

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SHEET NUMBER

**CONCRETE WASHOUT STATION** N.T.S.

WASHOUT" SIGN

SECTION B-B

3. MATERIALS USED TO CONSTRUCT TEMPORARY CONCRETE WASHOUT FACILITIES SHALL BE

TEMPORARY CONCRETE WASHOUT FACILITIES SHALL BE BACKFILLED, REPAIRED, AND

4. HOLES, DEPRESSIONS OR OTHER GROUND DISTURBANCE CAUSED BY THE REMOVAL OF THE

KHA DETAIL NO: 01.102.R01

-STANDARD METAL

GALVANIZED HARDWARE WIRE

(19 GAUGE, 1/4" MESH

EXTENDS TO THE TOP OF BOX.

POSTS 2'-0" IN

GROUND

OPENINGS.)

- #57 WASHED STONE PLACED TO A

HEIGHT OF 16" MIN. ABOVE TOP OF BOX

2. A CONCRETE WASHOUT SIGN SHALL BE INSTALLED WITHIN 30' OF THE TEMPORARY

5. PIT CAPACITY IS MINIMUM OF 6 CUBIC FEET PER 10 CUBIC YARDS OF CONCRETE.

SANDBAGS (TYP.)

(SEE NOTE 2)

PLYWOOD 48"x24" BLACK LETTERS

CONCRETE WASHOUT

SIGN DETAIL

6" HEIGHT CONCRETE

WASHOUT

FRONT VIEW

WOOD POSTS

PAINTED WHITE

2. A CONCRETE WASHOUT SIGN SHALL BE INSTALLED WITHIN 30' OF THE TEMPORARY

3. MATERIALS USED TO CONSTRUCT TEMPORARY CONCRETE WASHOUT FACILITIES SHALL BE

TEMPORARY CONCRETE WASHOUT FACILITIES SHALL BE BACKFILLED, REPAIRED, AND

5. PIT CAPACITY IS MINIMUM OF 6 CUBIC FEET PER 10 CUBIC YARDS OF CONCRETE.

4. HOLES, DEPRESSIONS OR OTHER GROUND DISTURBANCE CAUSED BY THE REMOVAL OF THE

1. ACTUAL LAYOUT TO BE DETERMINED IN THE FIELD.

REMOVED FROM THE SITE AND DISPOSED OF OR RECYCLED.

CONCRETE WASHOUT FACILITY.

STABILIZED TO PREVENT EROSION.

LINED

SUMP

PLAN VIEW

PLASTIC LINING

CONCRETE WASHOUT FACILITY.

N.T.S.

NCDOT #57

WASHED STÖNE -

**MAINTENANCE** 

STONE AS NEEDED.

N.T.S.

STABILIZED TO PREVENT EROSION

1. ACTUAL LAYOUT TO BE DETERMINED IN THE FIELD.

**CONCRETE WASHOUT STATION** 

REMOVED FROM THE SITE AND DISPOSED OF OR RECYCLED.

KHA DETAIL NO: 01.102.R01

10 MIL. PLASTIC LINING

36" MIN. SPACING TYP.\*

TEMPORARY MATTING

N.T.S.

#57 WASHED

OF BOX-

CONSTRUCTION SPECIFICATIONS

STONE PLACED TO

A HEIGHT OF 16"

MIN. ABOVE TOP

SECTION B-B

12" MIN. SPACING TYP.\*

TEMPORARY SEEDING SCHEDULE AND SEEDBED PREPARATION

ANCHOR PLASTIC

6" OVERLAP IN SLICE

- NON-WOVEN GEOTEXTILE FILTER CLOTH FABRIC

4' ABOVE SOURCE WATER, IF REQUIRED

KEY/ANCHOR TO TOE OF SLOPE.

- 19-GAUGE

DRAINAGE AREA MAY NOT

EXCEED 1 ACRE.

HARDWARE CLOTH

(1 MESH OPENINGS)

-LINER WITH #57

STONE BERM

APPROVED EQUIVALENT.


-KEY/ANCHOR MATERIAL AT


TOP OF SLOPE.

- 1. LAY BLANKETS LOOSELY AND STAKE OR STAPLE TO MAINTAIN DIRECT CONTACT WITH THE SOIL. DO NOT STRETCH.
- 2. \* DIMENSIONS SHOWN ARE MINIMUM, MANUFACTURED PRODUCTS MAY HAVE ADDITIONAL REQUIREMENTS THAT MUST BE MET.
- 3. SLOPE SURFACE SHALL BE FREE OF ROCKS, SOIL CLODS, STICKS, GRASS. MAT/BLANKETS SHALL HAVE GOOD SOIL CONTACT.

KHA DETAIL NO: 01.105.R0

- TO STREET ACCEPTANCE. 4. THE DETAIL SHOWN IS FOR SLOPE MATTING. FOR CHANNEL OR PIPE OUTFALL MATTING SPECIFICATIONS, PLEASE REFER TO NCESCPDM STANDARD 5. FILTER BAGS SHALL BE CLEANED OR #6.17 AND MANUFACTURER'S GUIDELINES. REPLACED ON A REGULAR BASIS (NOT
- 5. ALL MATTING TO BE ERONET™ S150® EROSION CONTROL BLANKET OR

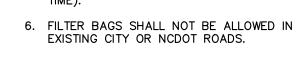

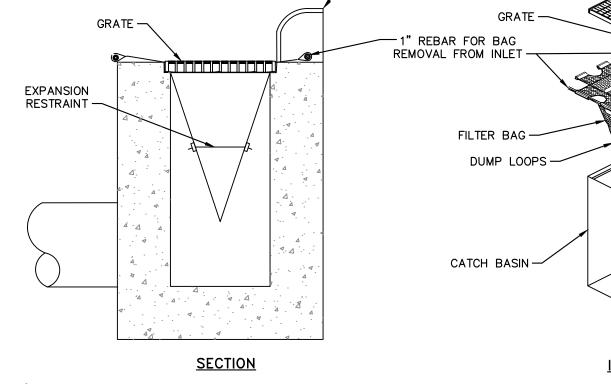

<u>INSTALLATION</u>

KHA DETAIL NO: 01.201.R0

EXISTING TOPOGRAPHICAL INFORMATION IS BASED ON A

DEPICTED OR NOT, PRIOR TO CONSTRUCTION AND REPORT

POTENTIAL CONFLICTS TO OWNER AND ENGINEER.

PROFESSIONAL LAND SURVEYORS, 333 S. WHITE STREET, WAKE

FOREST, NC, 27588, PHONE: (919) 556-3148. CONTRACTOR SHALL BE RESPONSIBLE FOR VERIFYING ALL EXISTING INFORMATION,

TOPOGRAPHIC SURVEY OBTAINED ON 02/23/2023 BY CMP

OUTLET END: CONNECTION TO OUTLET PIPE OR RISER

STANDARD SKIMMER DETAIL

CATCH BASIN INLET PROTECTION

- 1. CATCH BASIN INSERTS ARE AVAILABLE IN SIZES TO FIT MOST INDUSTRY-STANDARD CATCH BASINS (SEE CAPACITY CHART). CUSTOM SIZES ARE AVAILABLE. 2. FILTER SUPPORT FLANGES SHALL BE CONSTRUCTED
- (FLUME) SHALL BE CONSTRUCTED FROM EITHER 3. FILTER LINER SUPPORT BASKET SHALL BE
- CONSTRUCTED FROM A BIAXIAL GEOGRID WITH A MINIMUM ULTIMATE TENSILE STRENGTH OF 900 X 1400, AS TESTED IN ACCORDANCE WITH ASTM D-4595.
- OF 12", 24" OR 36" (REFER TO CAPACITY CHART). CUSTOM LINER DEPTH'S MAY BE SPECIFIED.

INSPECT THE PROTECTION INSERT AND REMOVE ALL ACCUMULATED SEDIMENT AND DEBRIS FROM VICINITY OF MORE THAN 1/3 FULL OF SEDIMENT, EMPTY THE PROTECTION INSERT BY LIFTING THE UNIT OUT OF THE INLET AND REPLACING.

## FILTER BAG WITH DEBRIS TRAP AND BYPASS CATCH BASIN -- REMOVABLE FLUME (TRAP) (HDPE PLASTIC SUPPORT FRAME -OR FIBERGLASS) TOP VIEW (GRATE NOT SHOWN)

		CAPACIT	TY CHART	
MODEL NO.	INLET SIZE	LINER DEPTH	STORAGE CAPACITY*	CLEAN FLOW RATE**
FF-2424HC	24" X 24"	12"	1.67 CU. FT.	470 GPM
29 29	24" X 24"	24"	4.18 CU. FT.	914 GPM
" "	24" X 24"	36"	6.69 CU. FT.	1,357 GPM
FF-2436HC	24" X 36"	12"	2.55 CU. FT.	641 GPM
"	24" X 36"	24"	6.38 CU. FT.	1,201 GPM
"	24" X 36"	36"	10.20 CU. FT.	1,761 GPM
FF-3636HC-GO	36" X 36"	12"	3.36 CU. FT.	772 GPM
27	36" X 36"	24"	8.39 CU. FT.	1,402 GPM
27 29	36" X 36"	36"	13.43 CU. FT.	2,032 GPM
* STORACE CAR	ACITY DEELEC	TO MAVIMILIA OF	NIDS COLLECTION DRICE	TO IMPEDING BYDASS

\* STORAGE CAPACITY REFLECTS MAXIMUM SOLIDS COLLECTION PRIOR TO IMPEDING BYPASS. \*\* FLOW RATES ARE "CALCULATED CLEAN FLOW RATES" BASED ON LINER MATERIAL FLOW RATE OF 70 GPM/SQ. FT. (RECOMMEND APPLYING FACTOR OF .25 TO .50 TO FLOW RATES TO ALLOW FOR SEDIMENT AND DEBRIS)

16 INCHES AROUND THE WIRE, AND SMOOTH TO AN EVEN GRADE. 5. ONCE THE CONTRIBUTING DRAINAGE AREA HAS BEEN STABILIZED, REMOVE ACCUMULATED SEDIMENT, AND ESTABLISH FINAL GRADING ELEVATIONS.

FILTERED .

\WATFR

2. DRIVE 5-FOOT STEEL POSTS 2 FEET INTO THE GROUND SURROUNDING THE INLET. SPACE

4. PLACE CLEAN GRAVEL (NC DOT #5 OR #57 STONE) ON A 2:1 SLOPE WITH A HEIGHT OF

POSTS EVENLY AROUND THE PERIMETER OF THE INLET, A MAXIMUM OF 4 FEET APART.

SURROUND THE POSTS WITH WIRE MESH HARDWARE CLOTH. SECURE THE WIRE MESH TO

THE STEEL POSTS AT THE TOP, MIDDLE, AND BOTTOM. PLACING A 2-FOOT FLAP OF THE

6. COMPACT THE AREA PROPERLY AND STABILIZE IT WITH GROUNDCOVER.

WIRE MESH UNDER THE GRAVEL FOR ANCHORING IS RECOMMENDED.

1. UNIFORMLY GRADE A SHALLOW DEPRESSION APPROACHING THE INLET.

CATCH BASIN AND YARD INLET PROTECTION

INSPECT INLETS AT LEAST WEEKLY AND AFTER EACH SIGNIFICANT

(1/2 INCH OR GREATER) RAINFALL EVENT. CLEAR THE MESH WIRE

FOR SUBSEQUENT RAINS. TAKE CARE NOT TO DAMAGE OR

OF ANY DEBRIS OR OTHER OBJECTS TO PROVIDE ADEQUATE FLOW

UNDERCUT THE WIRE MESH DURING SEDIMENT REMOVAL. REPLACE

KHA DETAIL NO: 01.202.R0

CATCH BASIN SILT PROTECTION INSERT N.T.S.

## - REMOVABLE FLUME (TRAP) (HDPE PLASTIC SUPPORT FRAME -OR FIBERGLASS) (4 SIDED) — FILTER LINER SUPPORT BASKE 3" мі<mark>л. | 🔠 🏗</mark> (SEE NOTE 3) 4" MIN. (SEE NOTE 4) CATCH BASIN-2" MIN. -FILTER LINER -SIDE VIEW

- FROM STAINLESS STEEL (TYPE 304) DEBRIS TRAP PETROLEUM RESISTANT FIBERGLASS OR HDPE PLASTIC.
- 4. INSERT LINERS ARE AVAILABLE IN STANDARD DEPTHS
- MAINTENANCE SPECIFICATIONS

UNIT AFTER EACH STORM EVENT. IF THE CONTAINMENT IS


Know what's below.

COUNTY

EFFECTIVE: 01/31/0


Call before you dig.

SDP-23-09

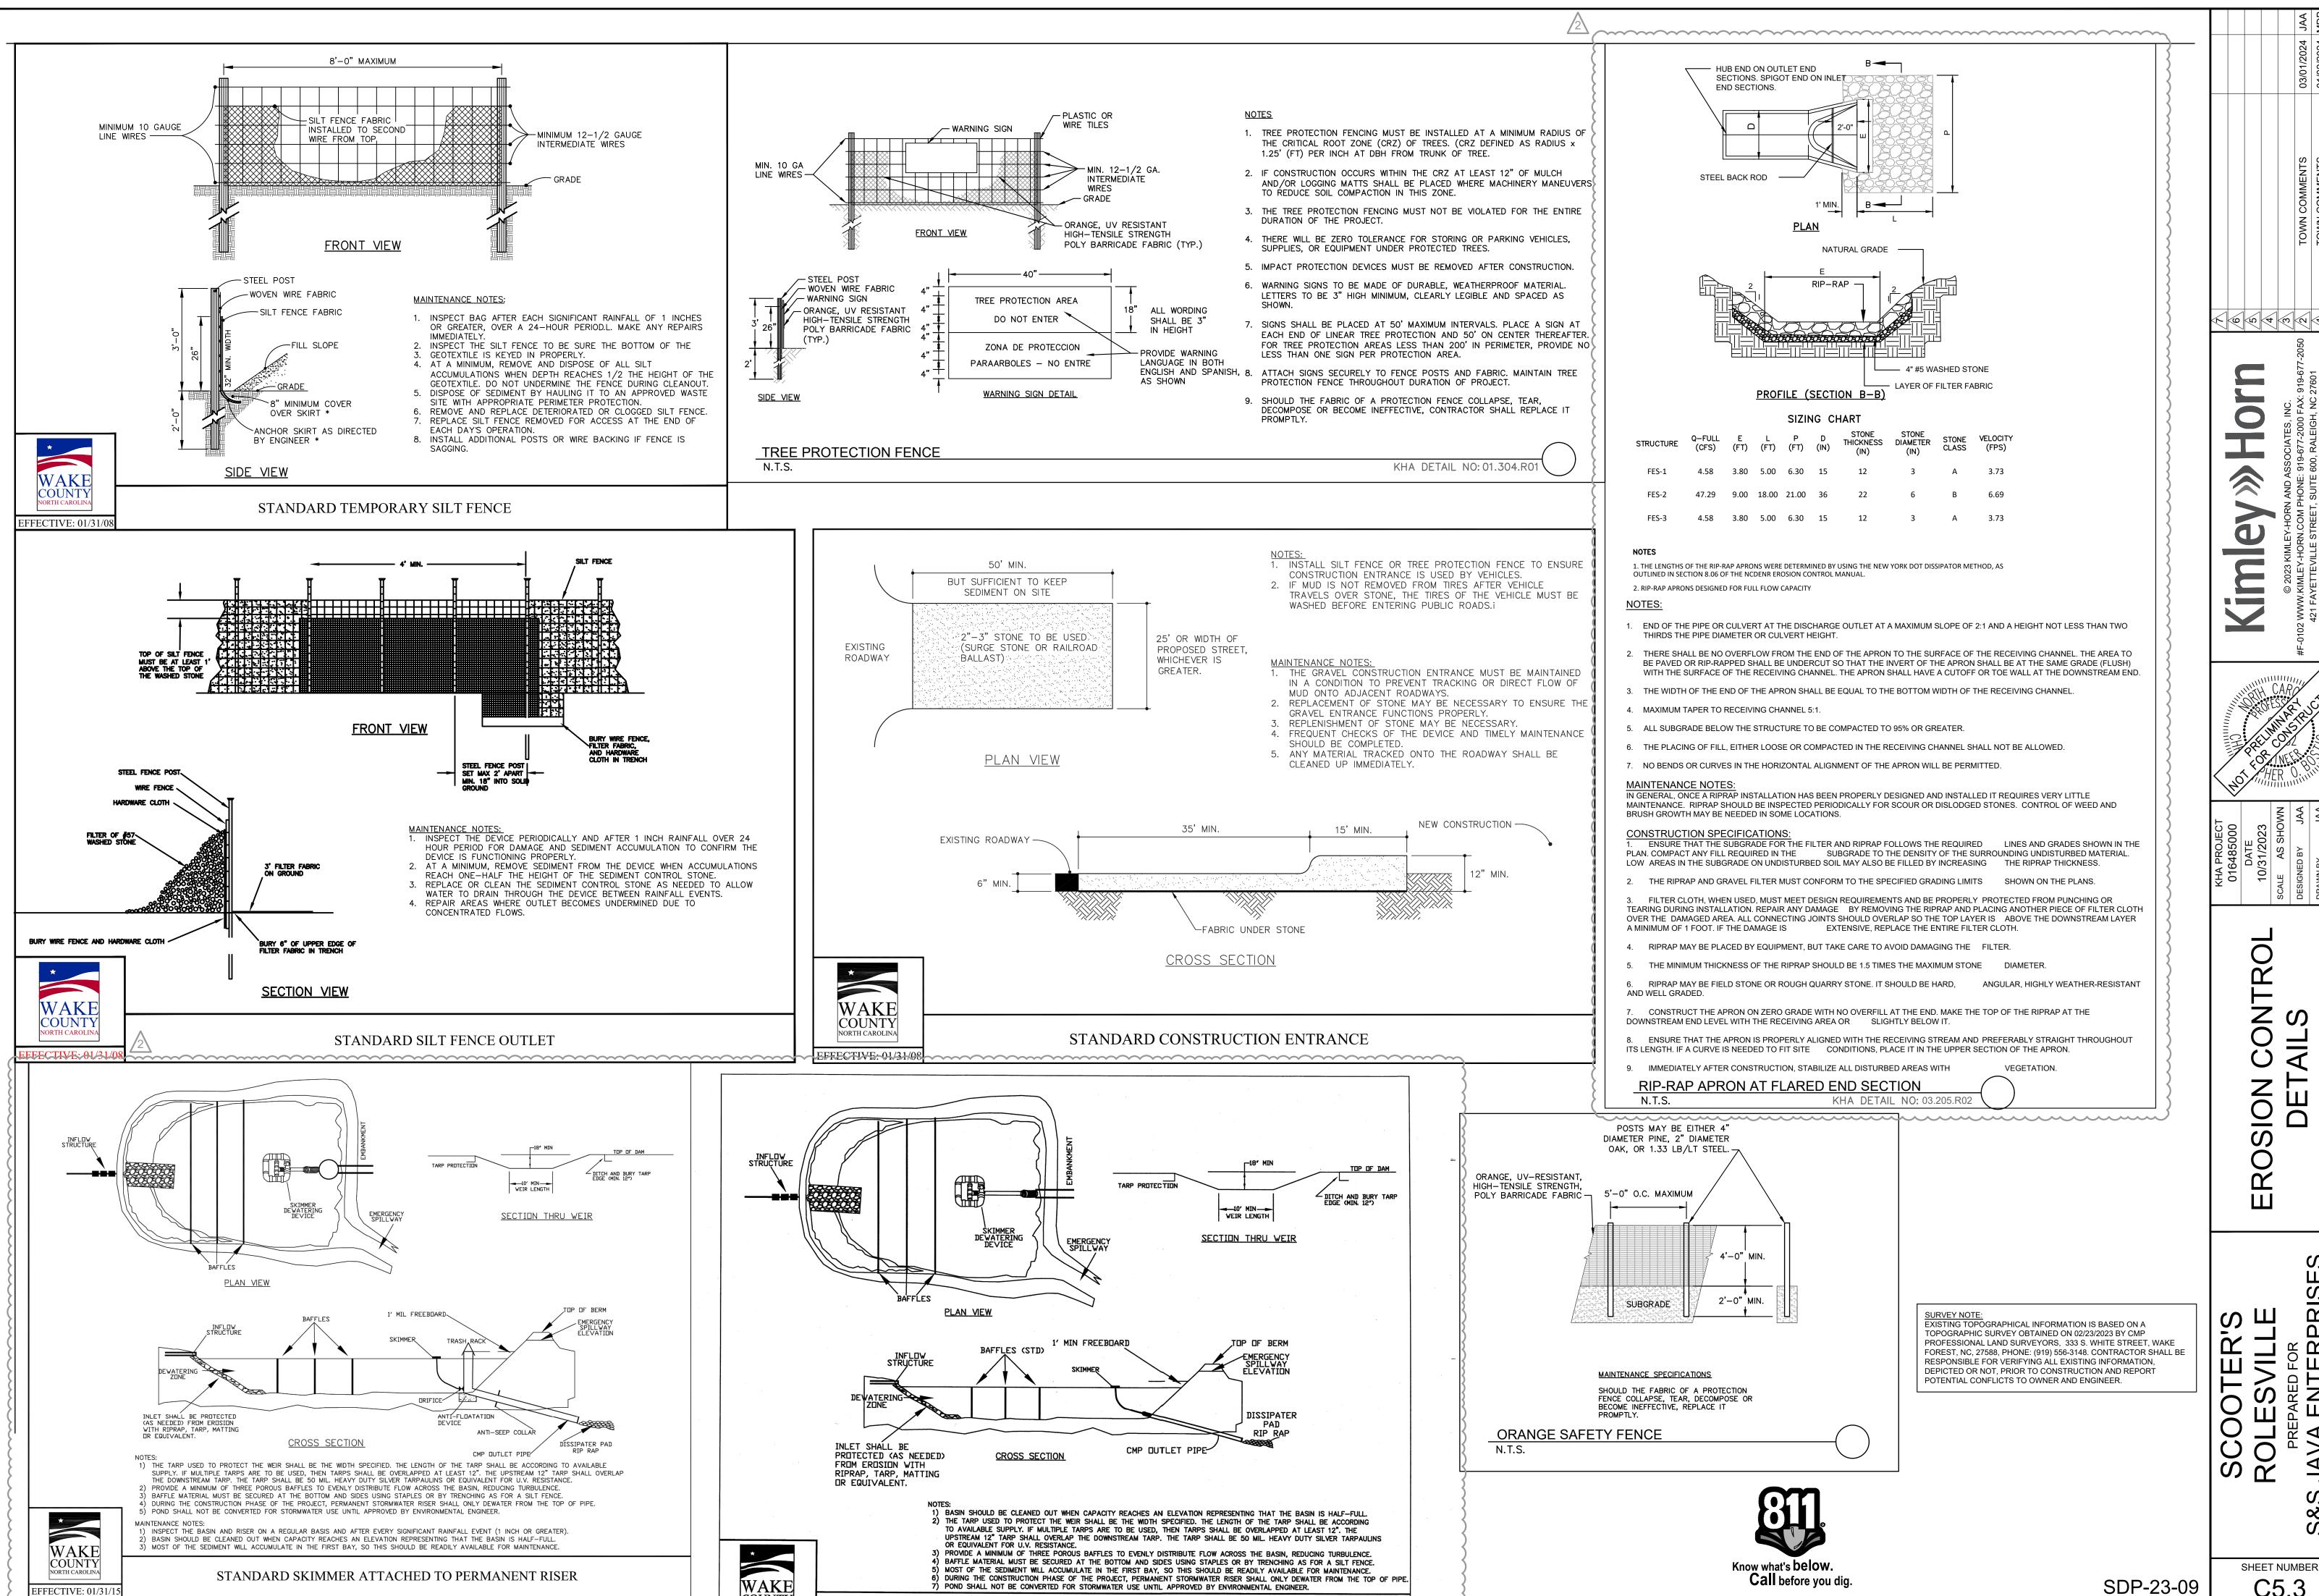

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SHEET NUMBER

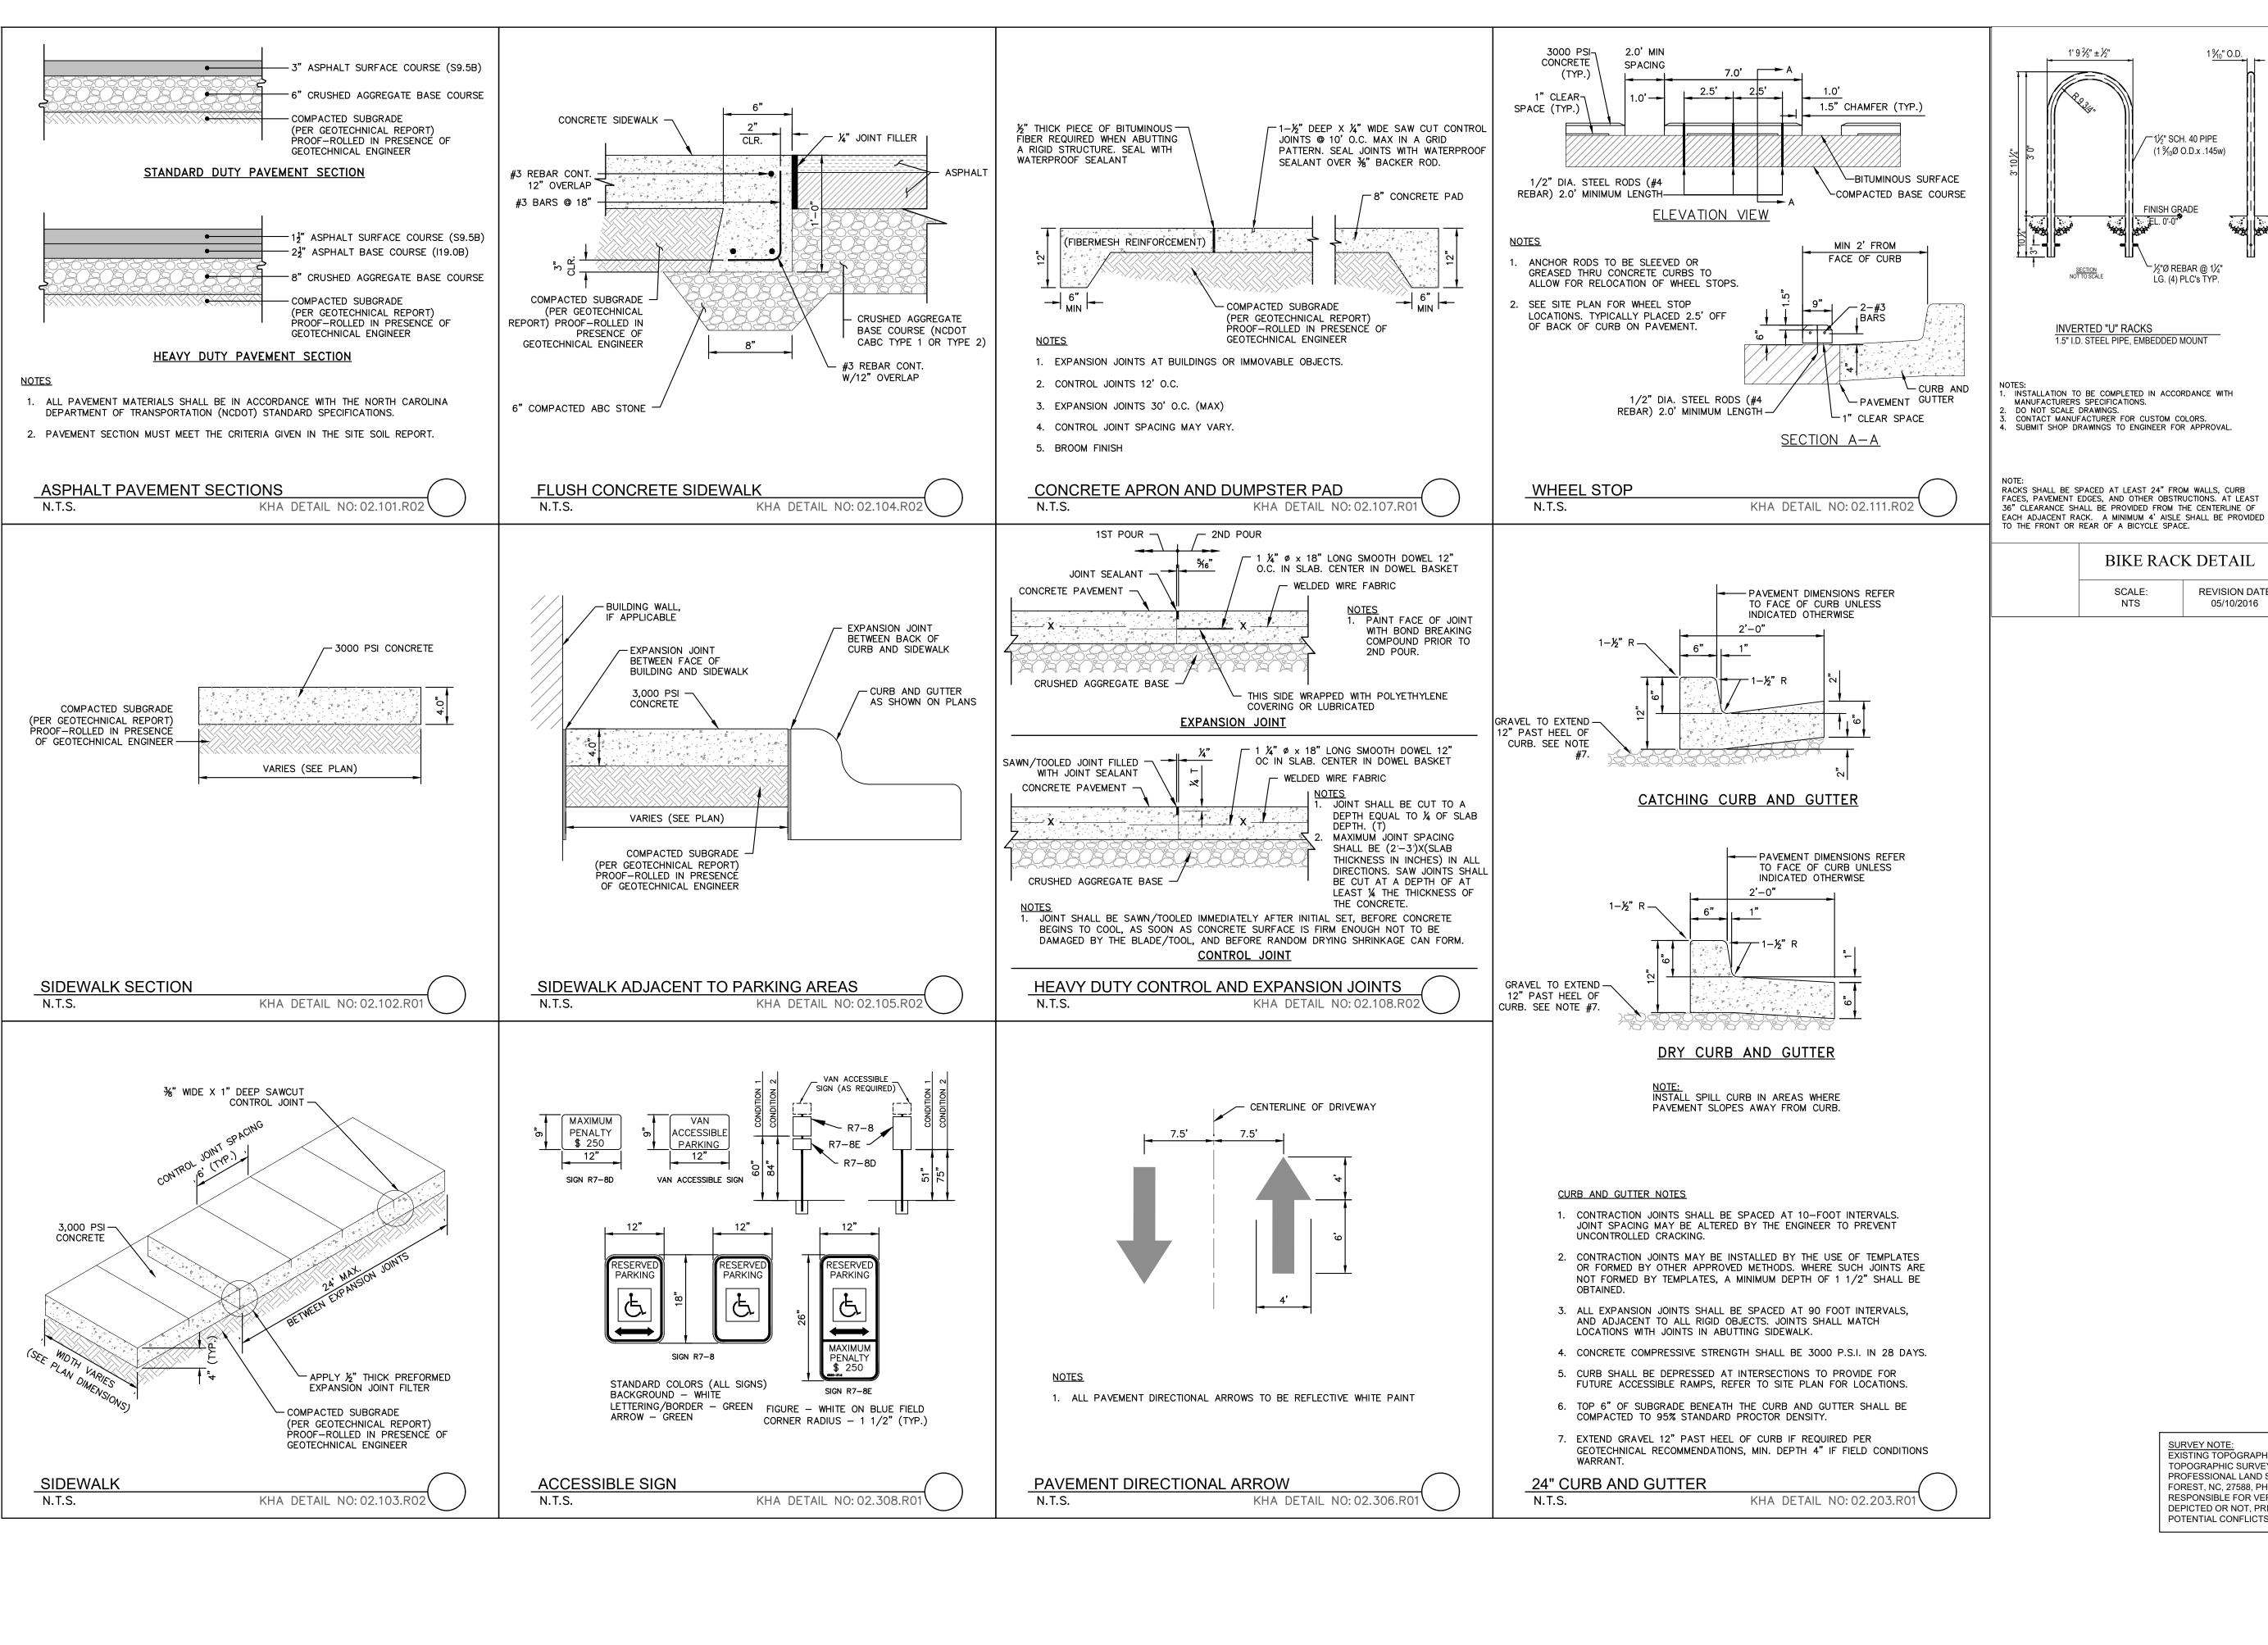

Know what's below. Call before you dig. SURVEY NOTE:
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1 <sup>9</sup>⁄₁₀" O.D.

**REVISION DATE:** 

05/10/2016

1½" SCH. 40 PIPE

−½"Ø REBAR @ 1¼"

LG. (4) PLC's TYP.

FINISH GRADE

(1 \%10\O O.D.x .145w)


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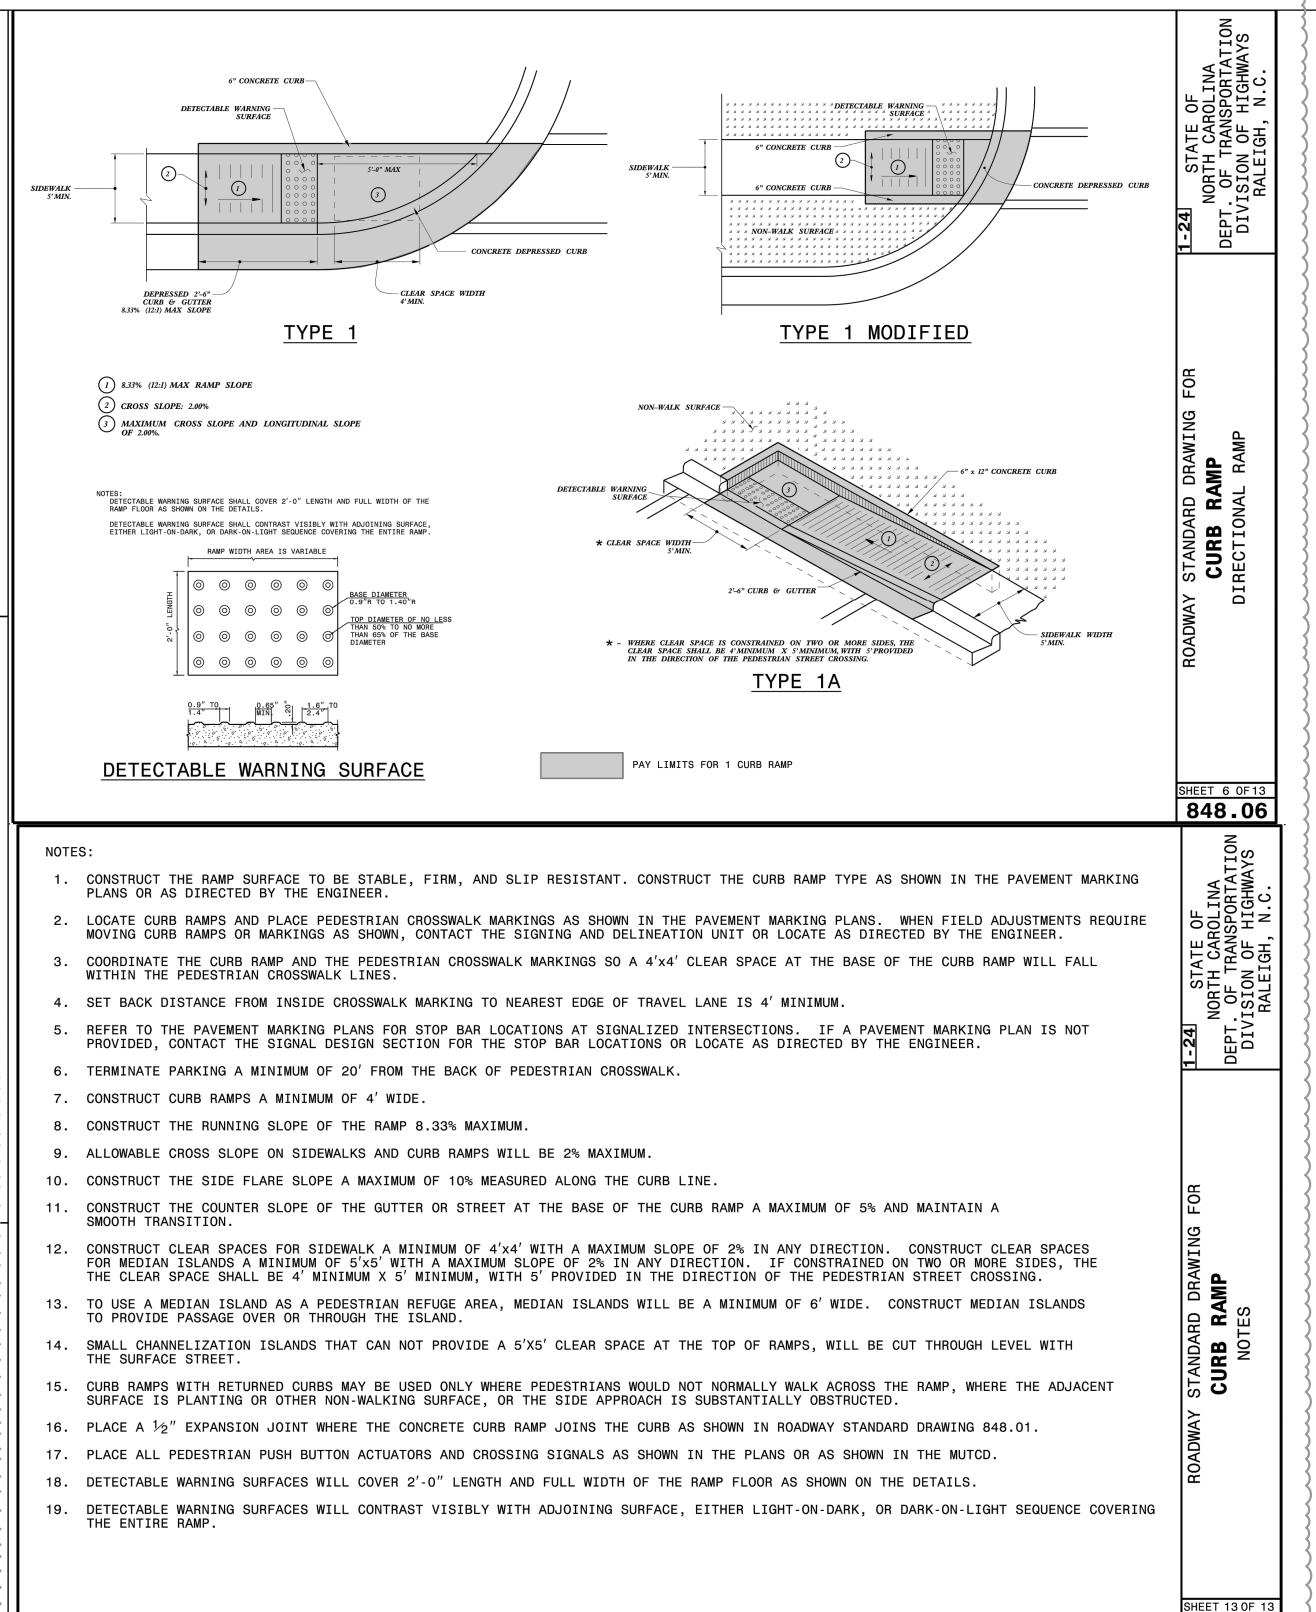
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SDP-23-07

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SURVEY NOTE:
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Know what's below. Call before you dig.

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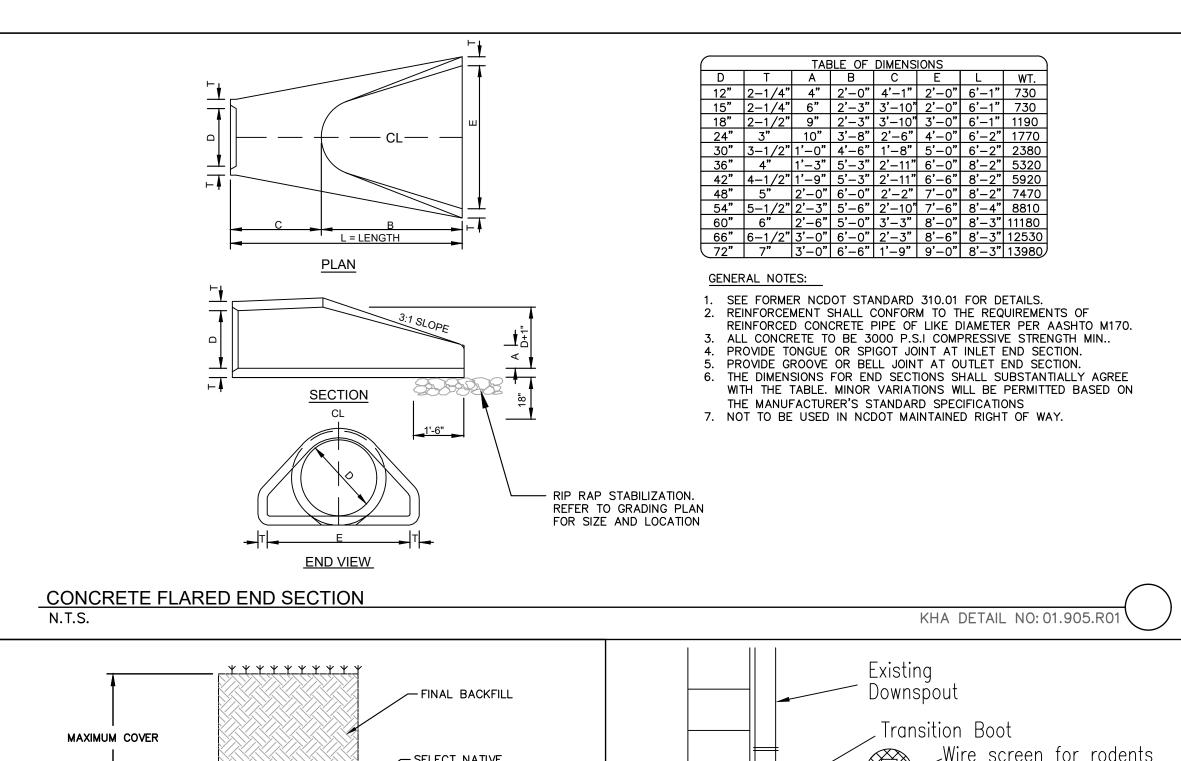
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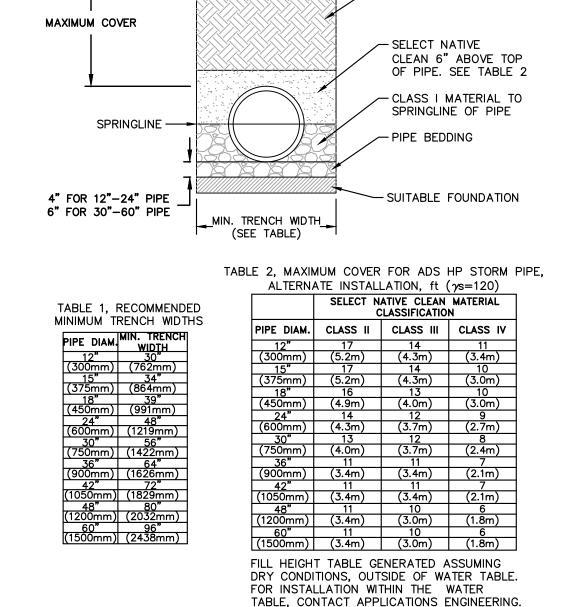
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SHEET NUMBER



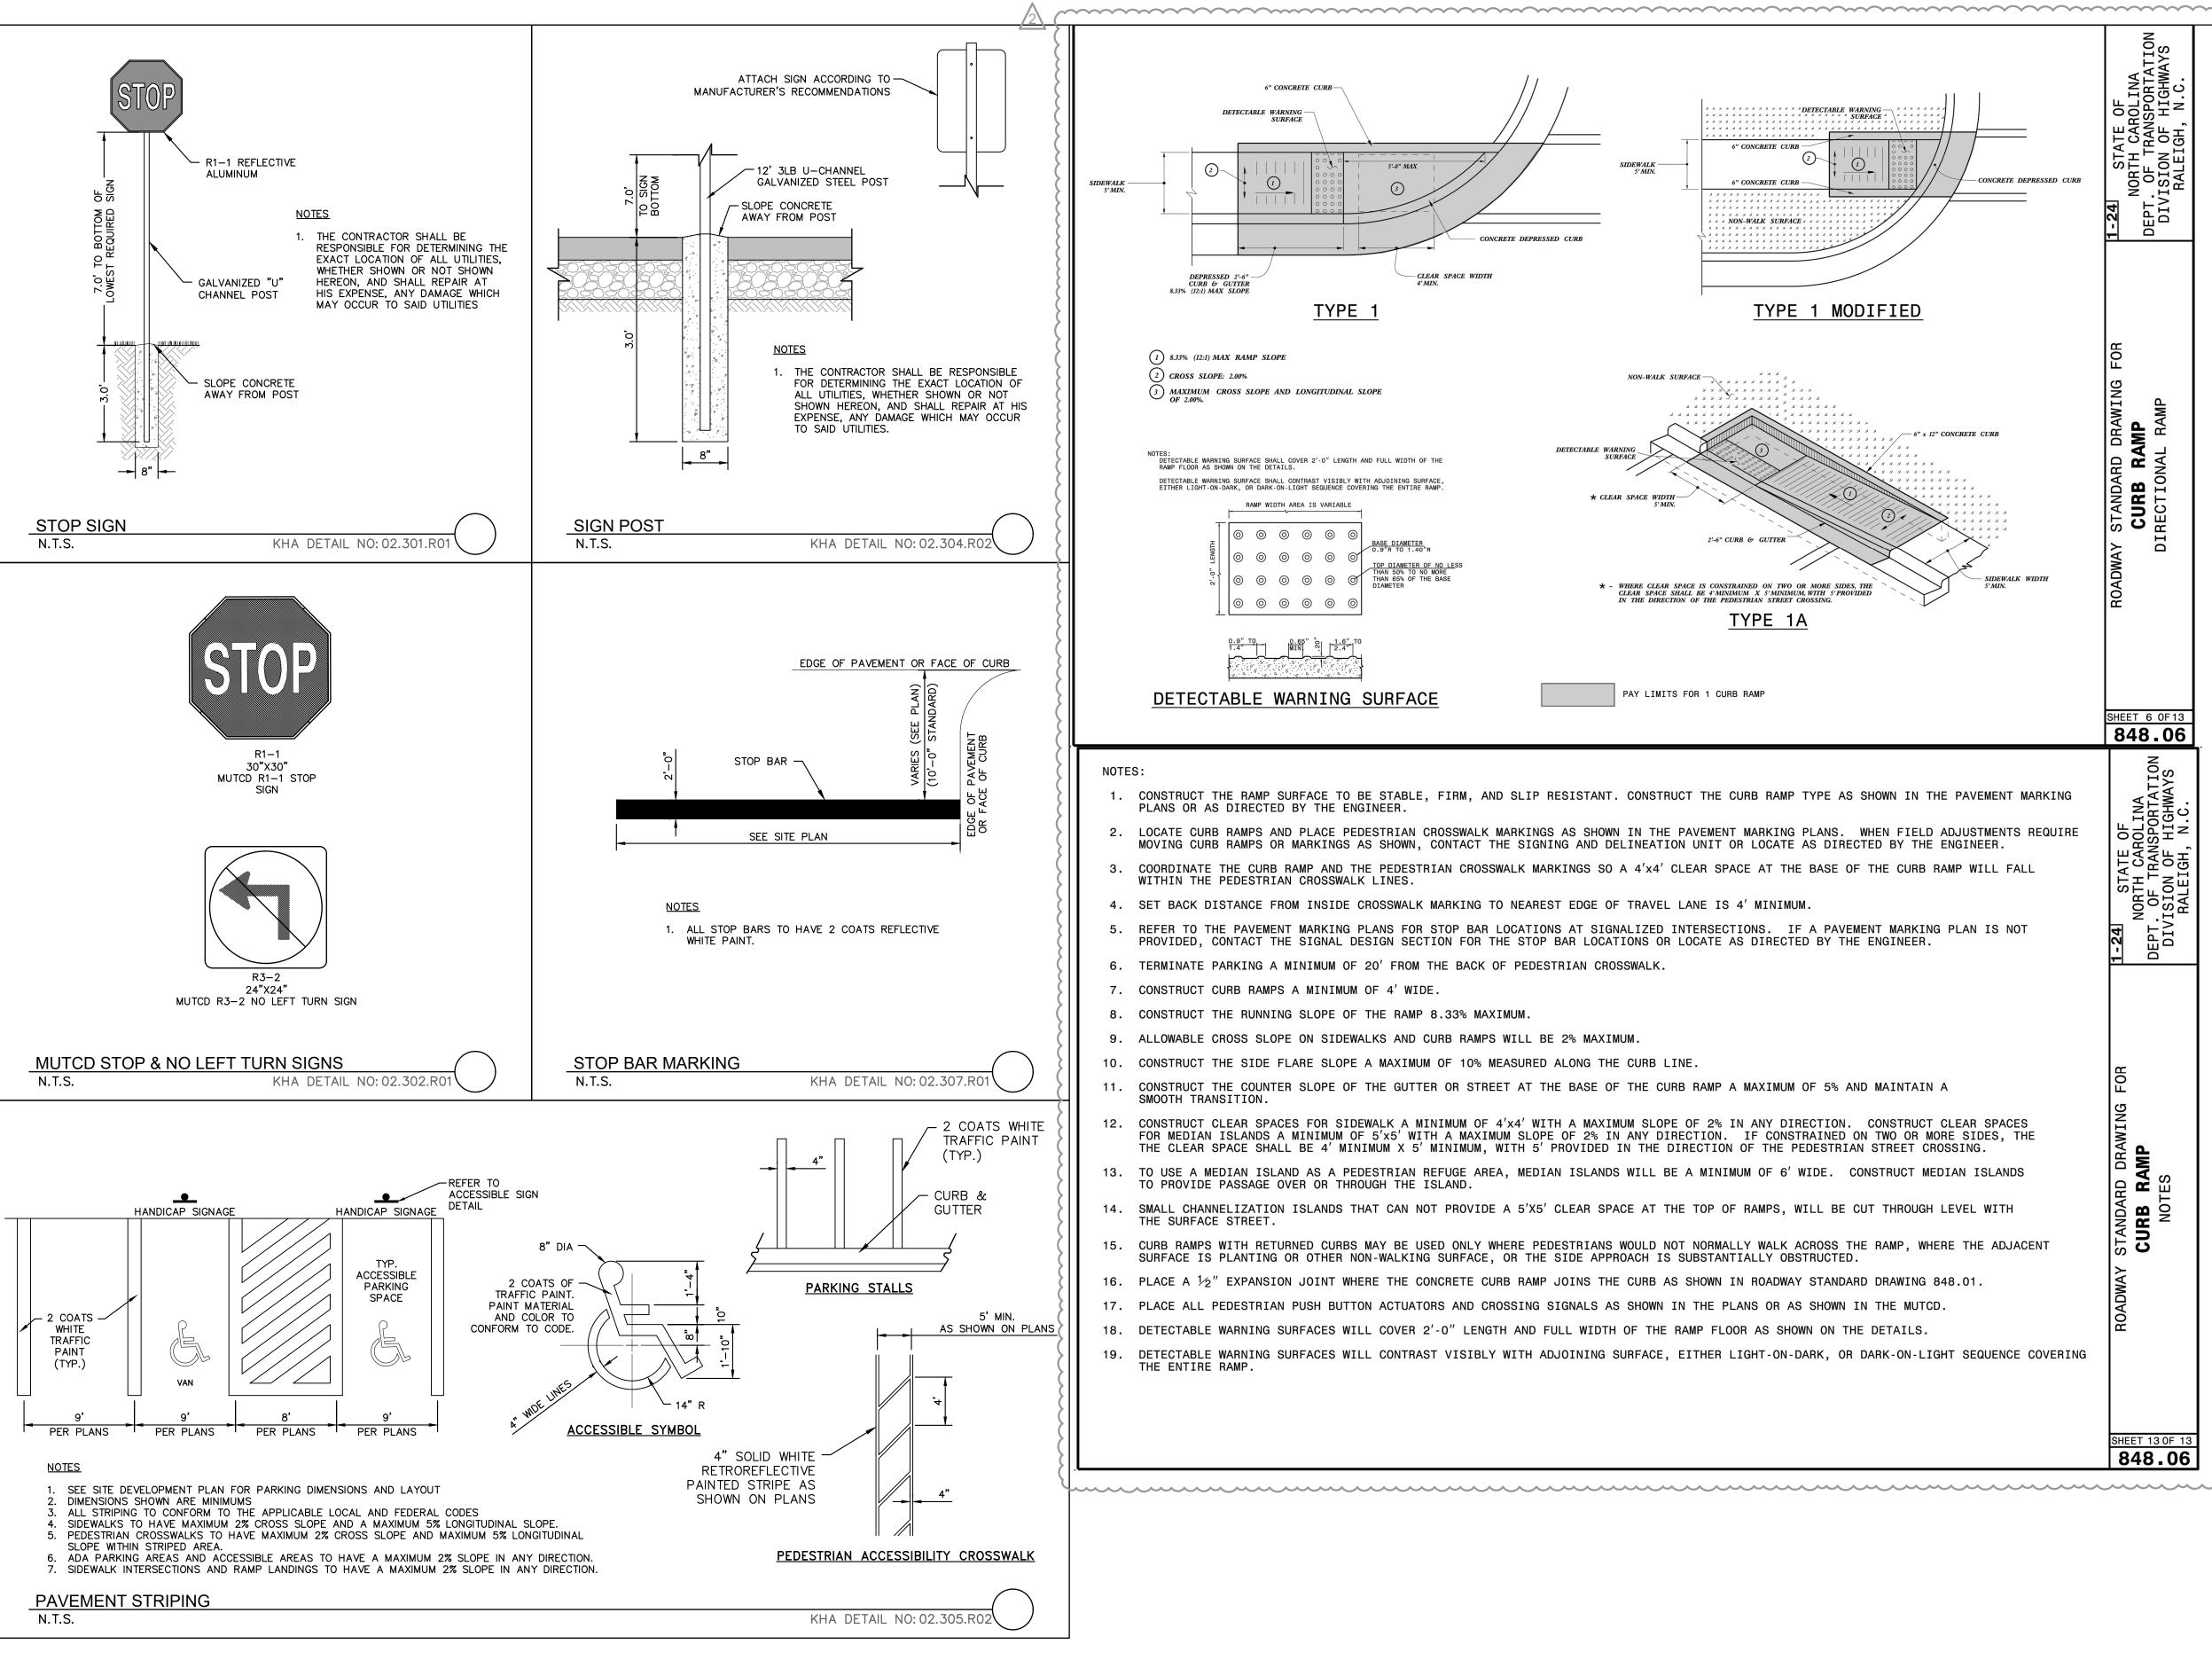

# 1. MEASURES SHOULD BE TAKEN TO PREVENT MIGRATION OF NATIVE FINES INTO BACKFILL MATERIAL, WHEN REQUIRED.

- 2. SOIL CLASSIFICATIONS ARE PER THE LATEST VERSION OF ASTM D2321. CLASS IVB MATERIALS (MH, CH) AS DEFINED IN PREVIOUS VERSIONS OF ASTM D2321 ARE NOT APPROPRIATE BACKFILL MATERIALS.
- 3. FOUNDATION WHERE THE TRENCH BOTTOM IS UNSTABLE, THE CONTRACTOR SHALL EXCAVATE TO A DEPTH REQUIRED BY THE ENGINEER AND REPLACE WITH SUITABLE MATERIAL AS SPECIFIED BY THE REGINEER. AS AN ALTERNATIVE AND AT THE DISCRETION OF THE DESIGN ENGINEER THE TRENCH BOTTOM MAY BE STABILIZED USING A CENTENTILE MATERIAL.
- AS SPECIFIED BY THE ENGINEER. AS AN ALTERNATIVE AND AT THE DISCRETION OF THE DESIGN ENGINEER, THE TRENCH BOTTOM MAY BE STABILIZED USING A GEOTEXTILE MATERIAL.

  BEDDING SUITABLE MATERIAL SHALL BE CLASS I. THE CONTRACTOR SHALL PROVIDE DOCUMENTATION FOR MATERIAL SPECIFICATION TO ENGINEER. UNLESS OTHERWISE NOTED BY
- (100mm-600mm); 6" (150mm) FOR 30"-60" (750mm-1500mm).

  5. BACKFILL FOR PIPES OUTSIDE OF PAVEMENT CLASS I MATERIAL TO BE USED FOR BACKFILL UP TO THE SPRINGLINE OF PIPE. THE CONTRACTOR SHALL PROVIDE DOCUMENTATION FOR MATERIAL SPECIFICATION TO ENGINEER. UNLESS OTHERWISE NOTED BY THE ENGINEER.

THE ENGINEER MINIMUM BEDDING THICKNESS SHALL BE 4" (100mm) FOR 4"-24"

- CLASS I MATERIAL MUST BE COMPACTED IN 6" (200mm) LIFTS.

  6. MINIMUM COVER MINIMUM COVER, H, IN NON-TRAFFIC APPLICATIONS (GRASS OR LANDSCAPE AREAS IS 12" (300mm) FROM THE TOP OF PIPE TO GROUND SURFACE. ADDITIONAL COVER
- MAY BE REQUIRED TO PREVENT FLOTATION.

  7. SELECT NATIVE CLEAN BACKFILL SHALL BE WELL PLACED, MODERATELY COMPACTED (85% SPD) CLASS IV OR BETTER PER ASTM D2321 WITH NO FOREIGN DEBRIS INCLUDING ROCKS,
- 8. HP STORM ALTERNATE TRENCH DETAIL ONLY APPLIES TO BACKFILL INSTALLATIONS IN NON-TRAFFIC APPLICATIONS PER TN 2.04A. ALTERNATE TRENCH USE MUST BE APPROVED


LARGE CLUMPS ORGANIC MATERIAL, OR FROZEN MATERIAL.


N.T.S.

BY DESIGN ENGINEER. DETAIL DOES NOT SUPERSEDE ADS STANDARD DETAIL STD-108.

HP STORM TRENCH INSTALLATION DETAIL

KHA DETAIL NO: 03.101.R01

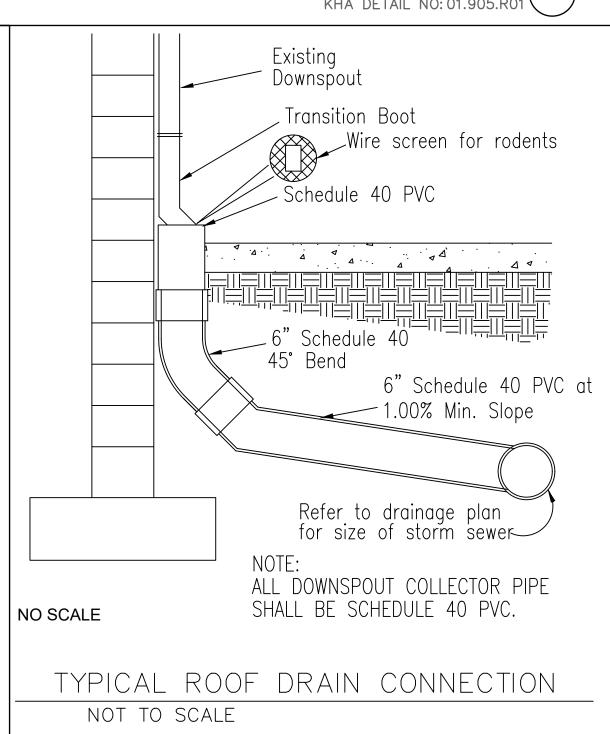

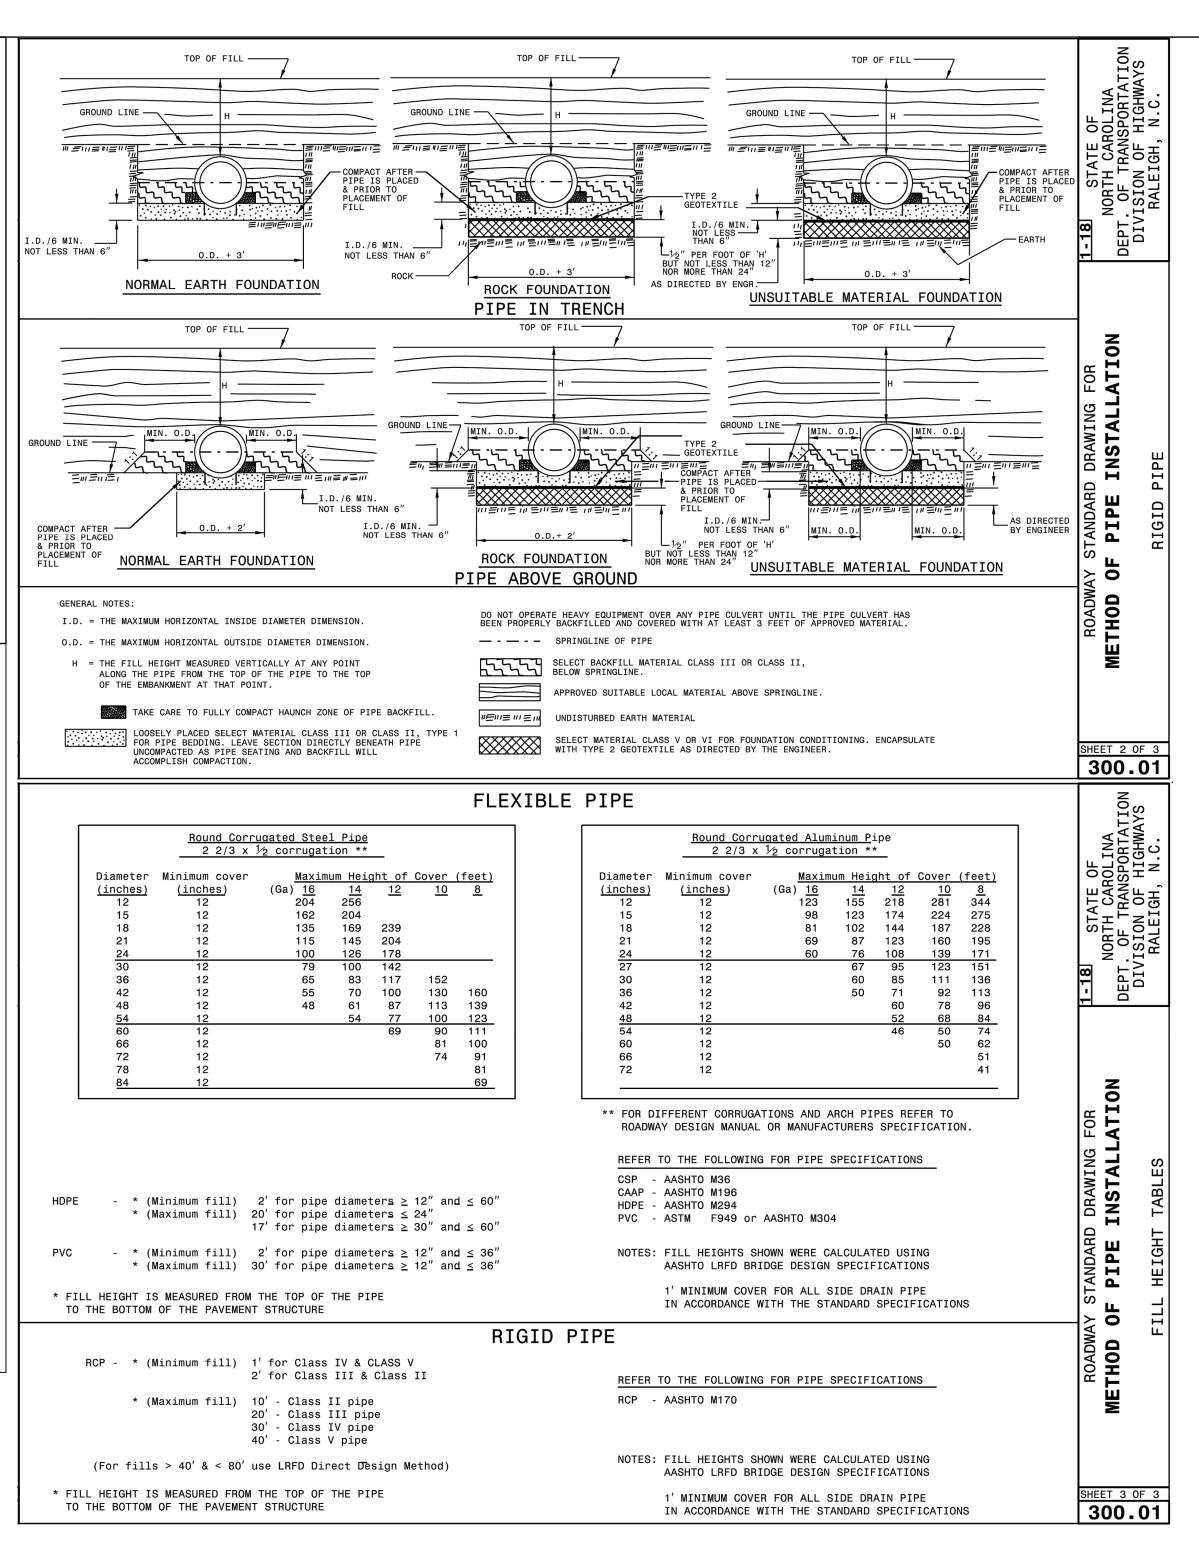

SURVEY NOTE:
EXISTING TOPOGRAPHICAL INFORMATION IS BASED ON A
TOPOGRAPHIC SURVEY OBTAINED ON 02/23/2023 BY CMP
PROFESSIONAL LAND SURVEYORS, 333 S. WHITE STREET, WAKE
FOREST, NC, 27588, PHONE: (919) 556-3148. CONTRACTOR SHALL BE
RESPONSIBLE FOR VERIFYING ALL EXISTING INFORMATION,
DEPICTED OR NOT, PRIOR TO CONSTRUCTION AND REPORT
POTENTIAL CONFLICTS TO OWNER AND ENGINEER.




SCOOTER'S
ROLESVILLE
PREPARED FOR
S&S JAVA ENTERPRISE

0

66466

SHEET NUMBER

C9.0

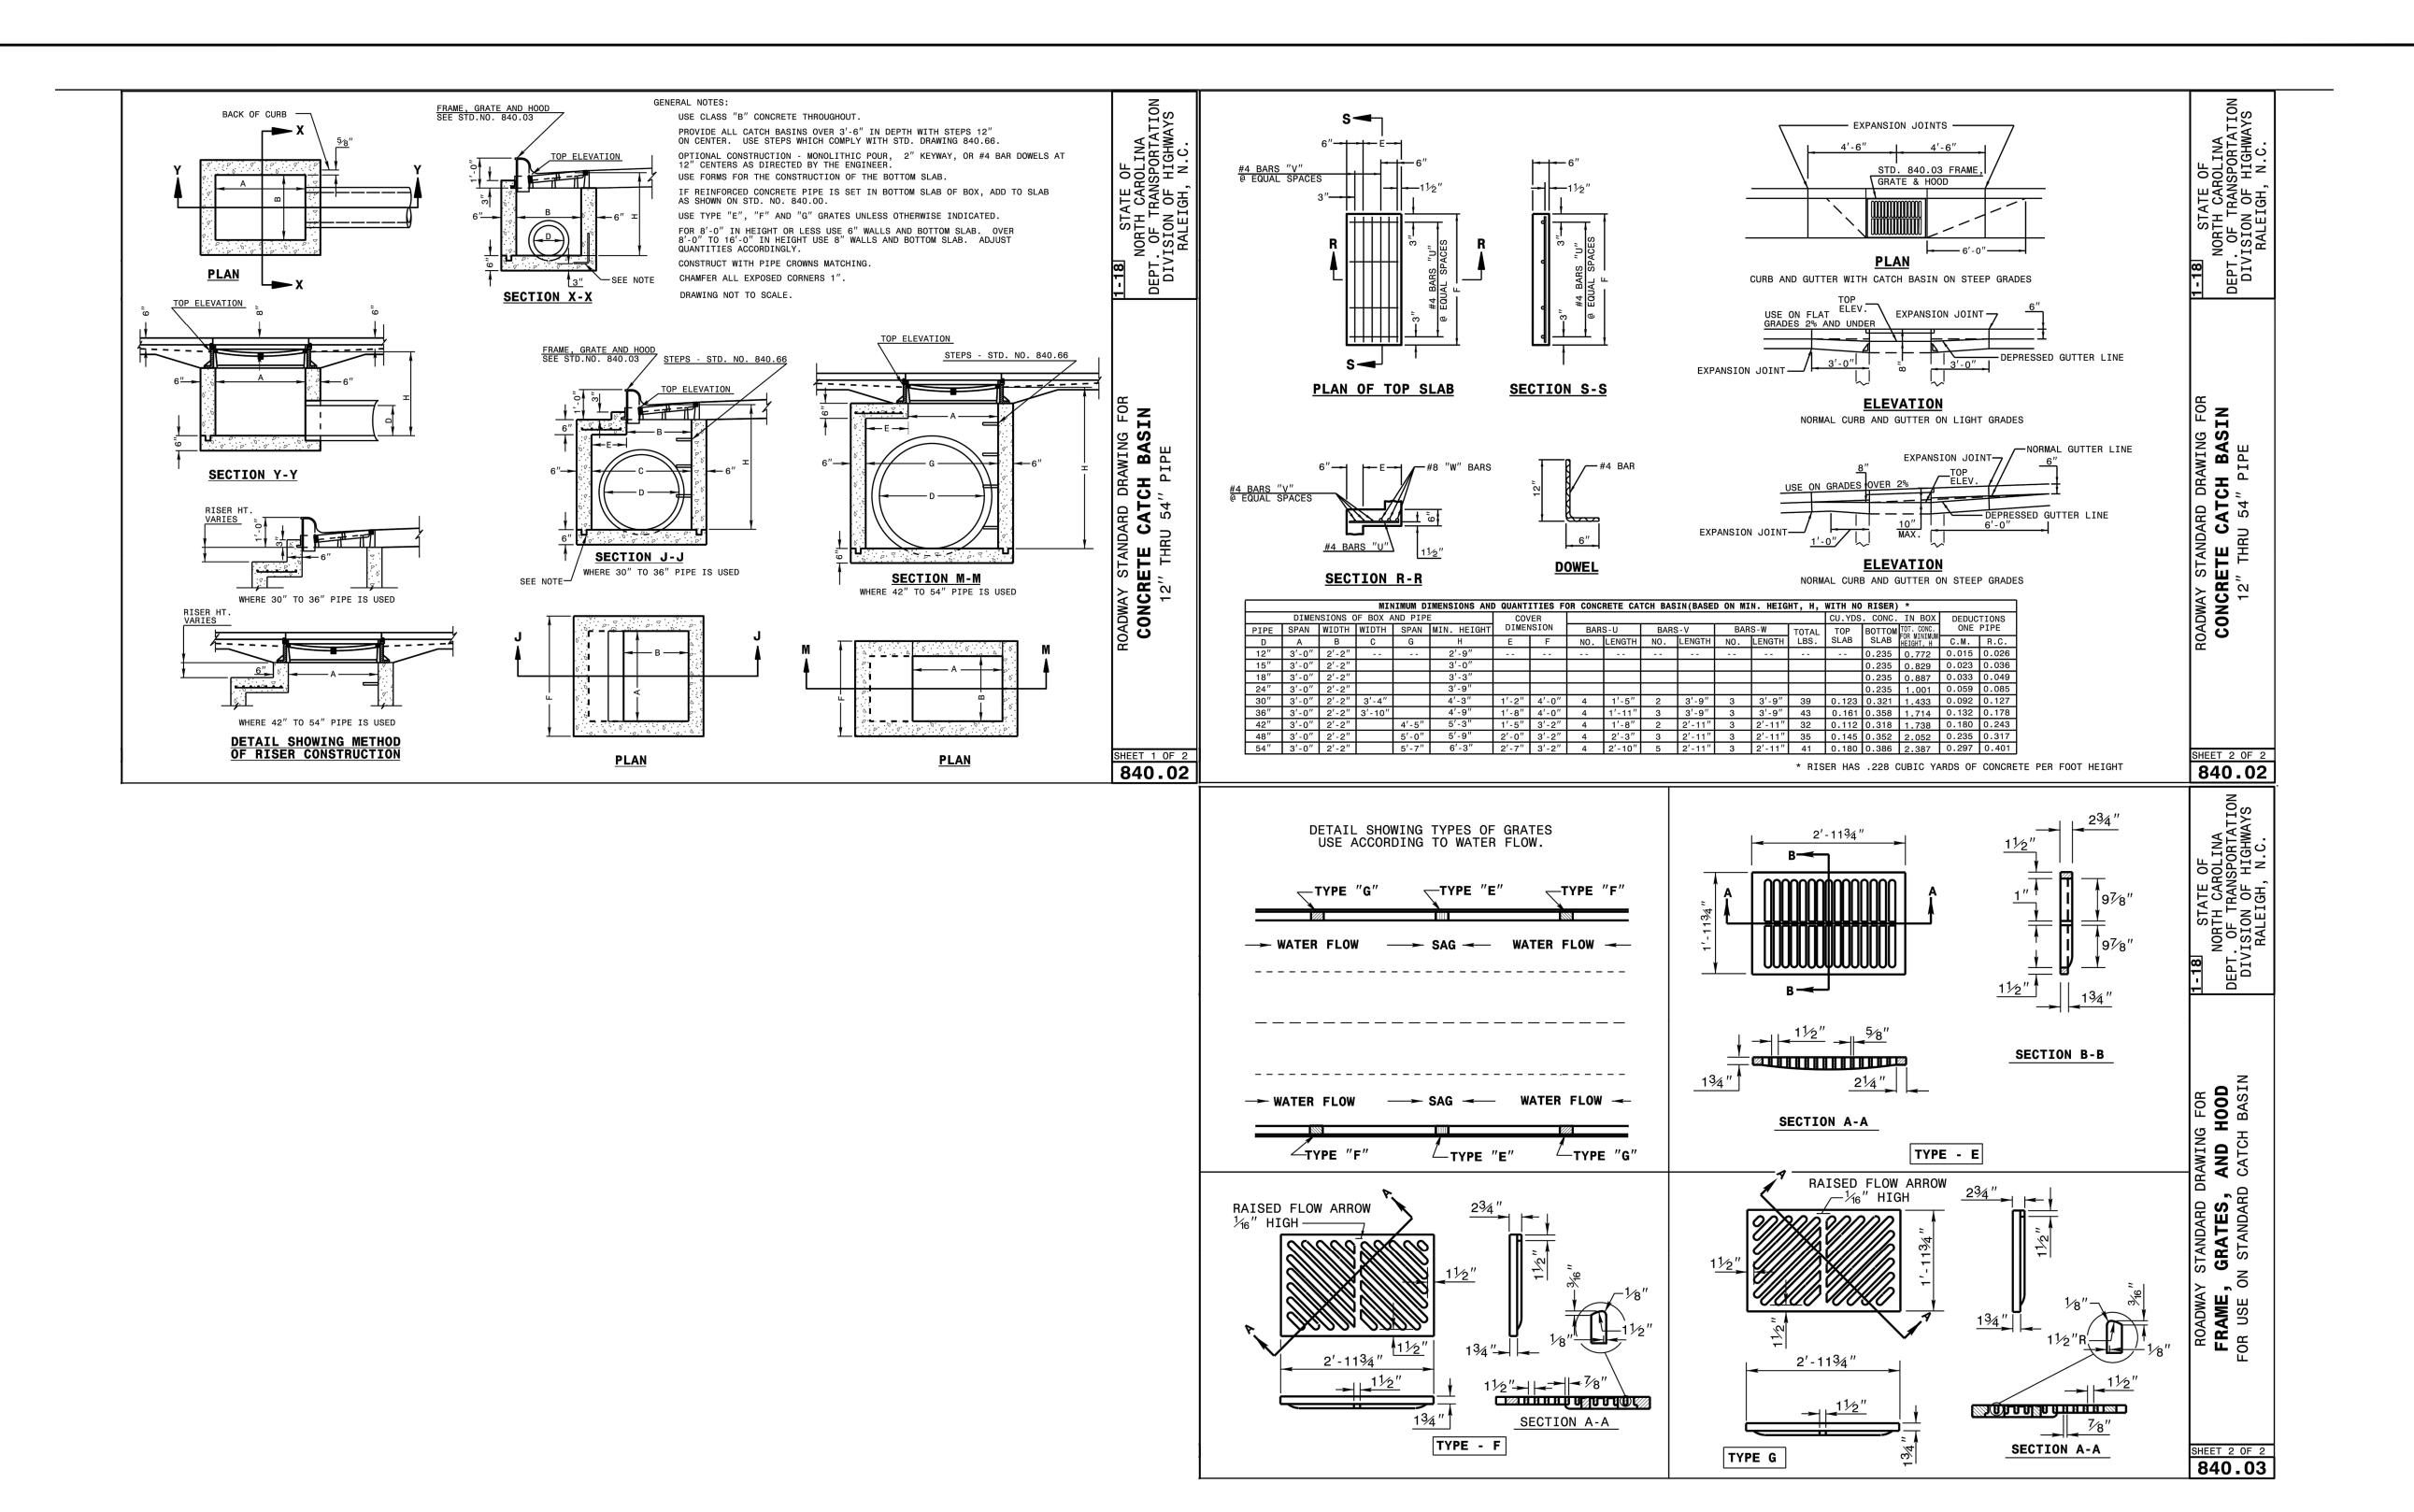

SURVEY NOTE:
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SCOOTER'S
ROLESVILLE


DETAIL

STORM

F @ @ 4 @ 0/4

C9.1

S&S

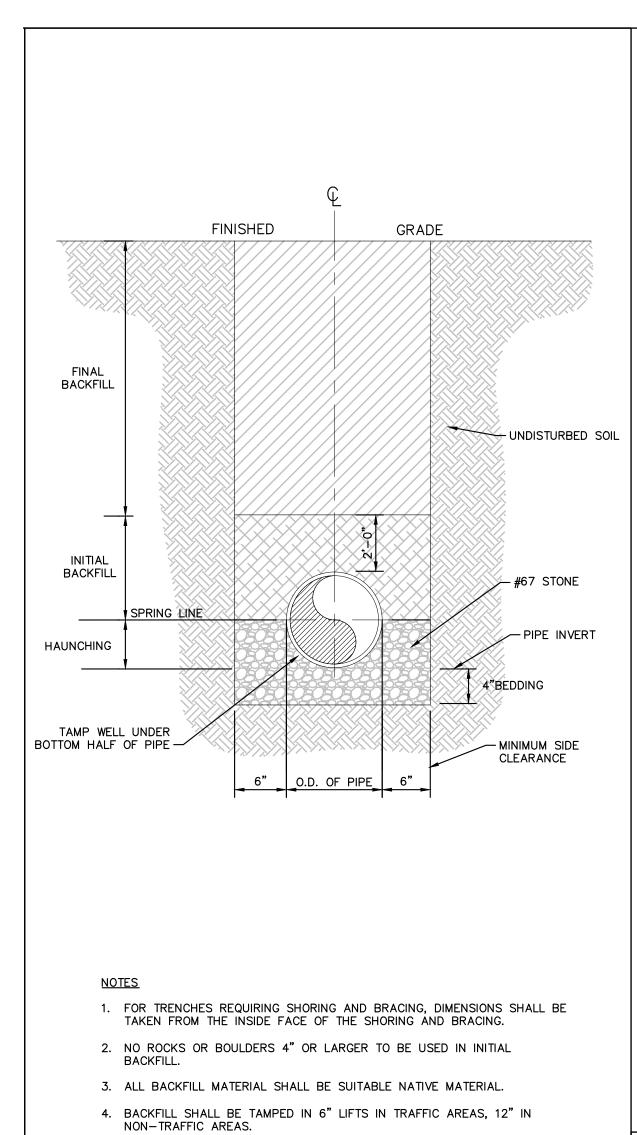

KHA DETAIL NO: 04.101.R01

KHA DETAIL NO: 04.102.R01

- COMPACTED

BACKFILL

MATERIAL (NO MATERIAL

SELECT BACKFILL

LARGER THAN 2")

BEDDING AND TRENCH


WIDTH VARIES

TYPE B

**BACKFILL SECTION** 

N.T.S.

N.T.S.

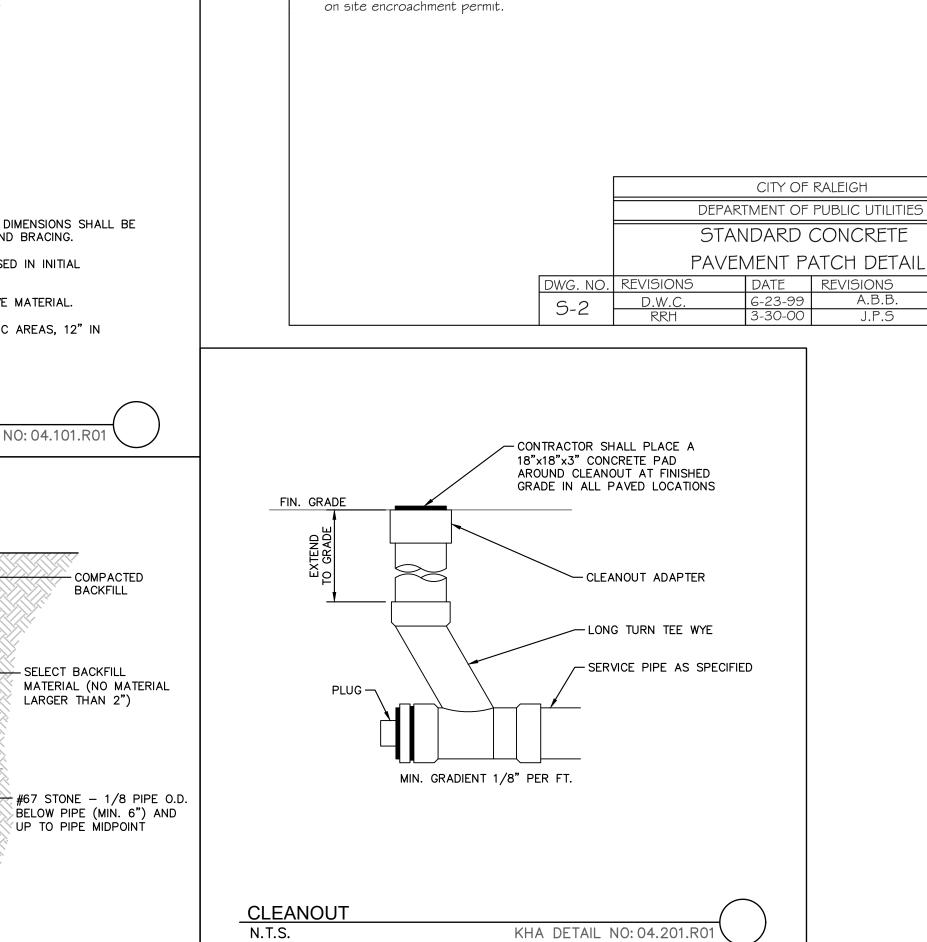

KHA DETAIL NO: 04.201.R01

NEW CONC. TO BE 3000 PSI -

SEE S-4 \$ S-5

I. See City of Raleigh standards for trenches and pipe bedding (

2. Pavement cuts over 5'-0" in width shall be reinforced to

3. Pavement cuts shall be made with an appropriate saw cut

4. Pavement cuts within NCDOT ROW shall conform to the approved

EXISTING CONC.

6" COMPACTED -

BACKFILL, TAMPED

S-4 \$ S-5) for additional details.

N.C.D.O.T. standards.

NO. 67 STONE

IN 6" LIFTS

—— SAW CUT AND REMOVE

EXISTING PAVEMENT

- BORE | 1/8" DIA., 1'-0" ON CENTER ALONG CUT

# DOWEL W/ #4 BAR

-EXPANSION JOINT


MATERIAL, MASTIC


NUNDISTURBED SOIL

SEALANT, AND DOWEL

ADHESIVE AS REQUIRED BY NCDOT STANDARD SPECS.

SPECS.

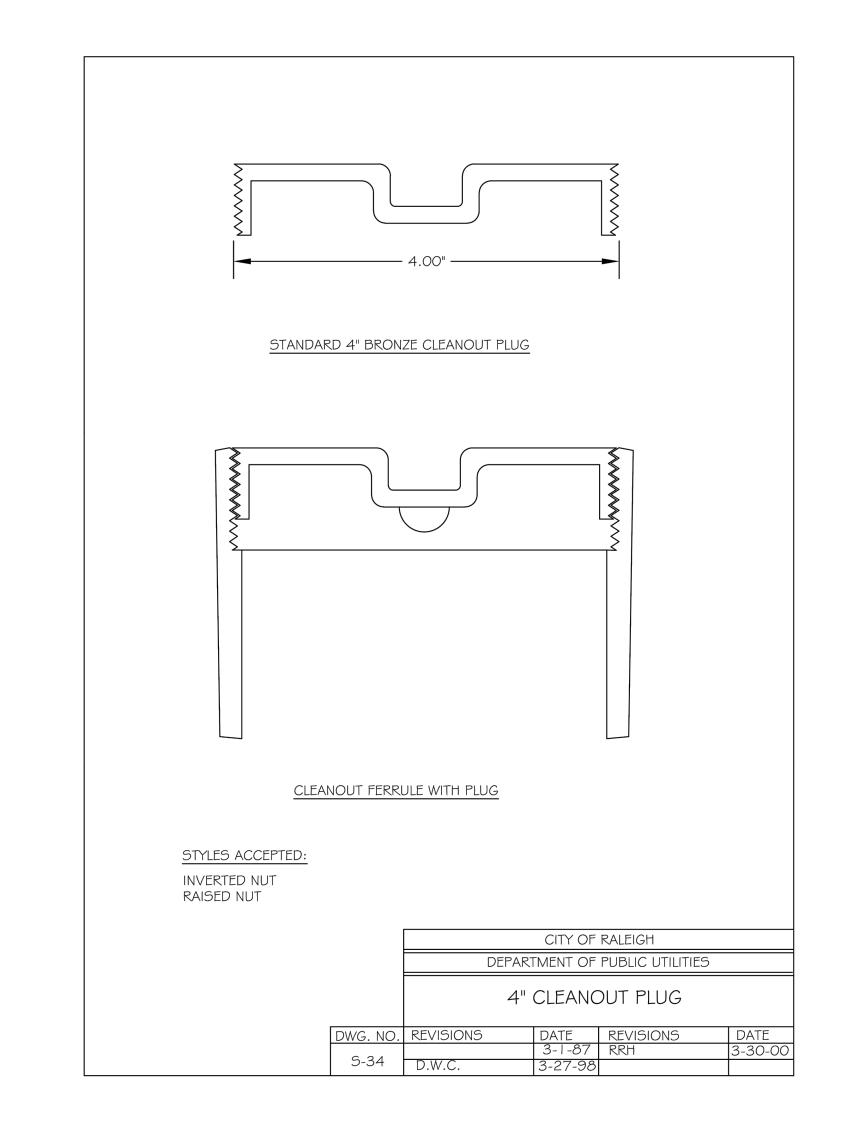

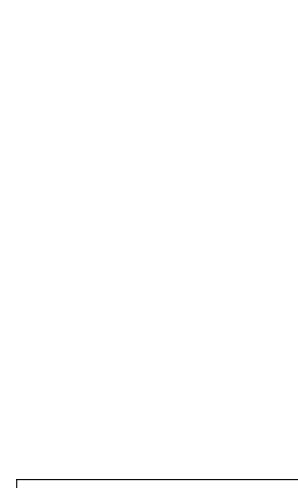

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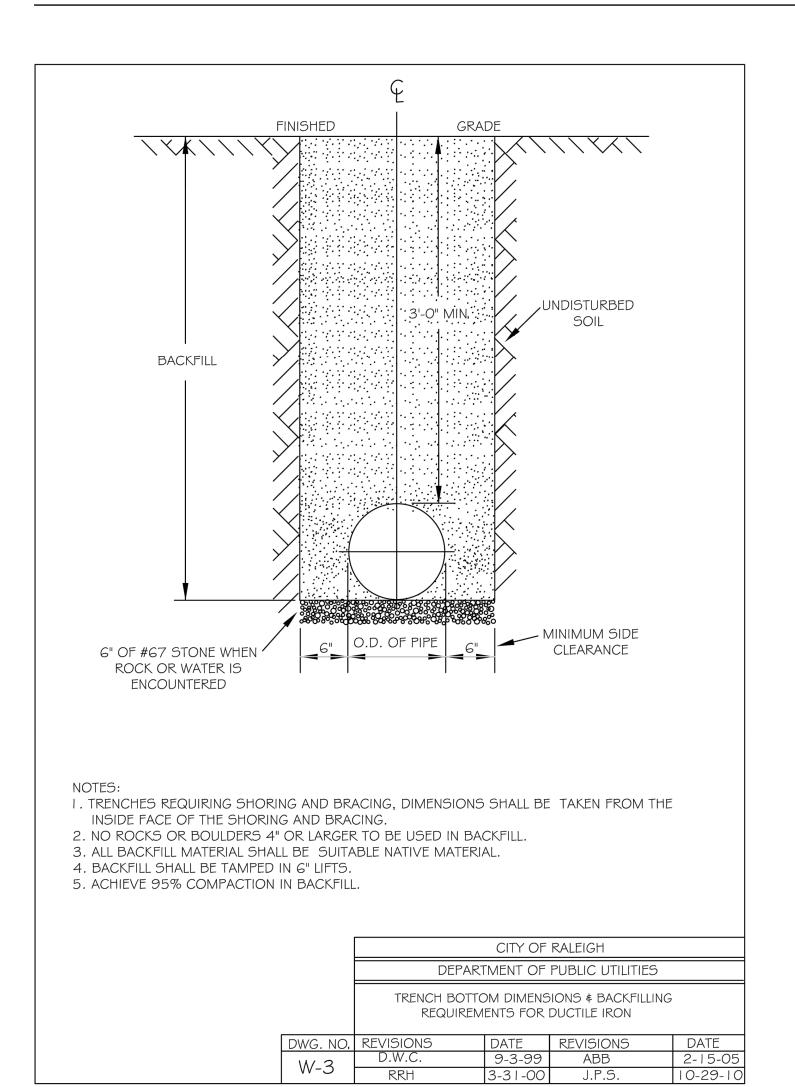



SE


ANITARY DET


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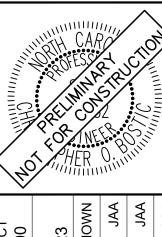
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421 FAYETTEVILLE STREET, SUITE 600, RALEIGH, NC 27601




SCALE AS SHOWN
DESIGNED BY JAA
DRAWN BY JAA

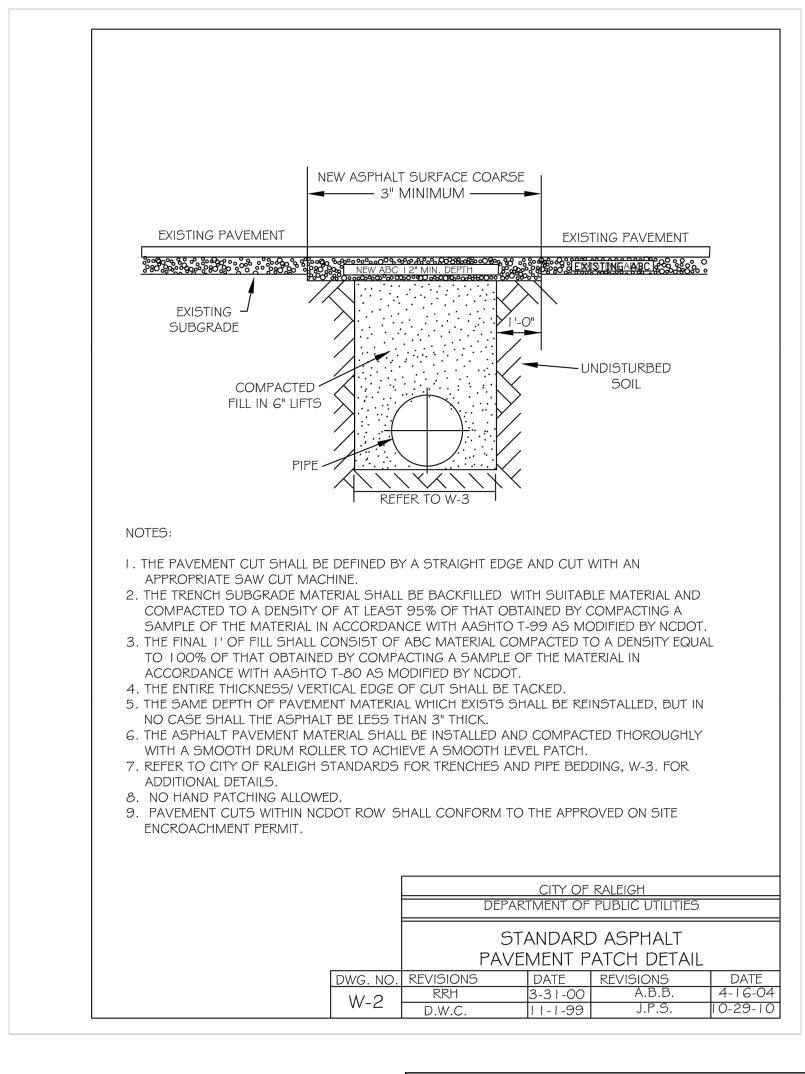
WATER DETAILS

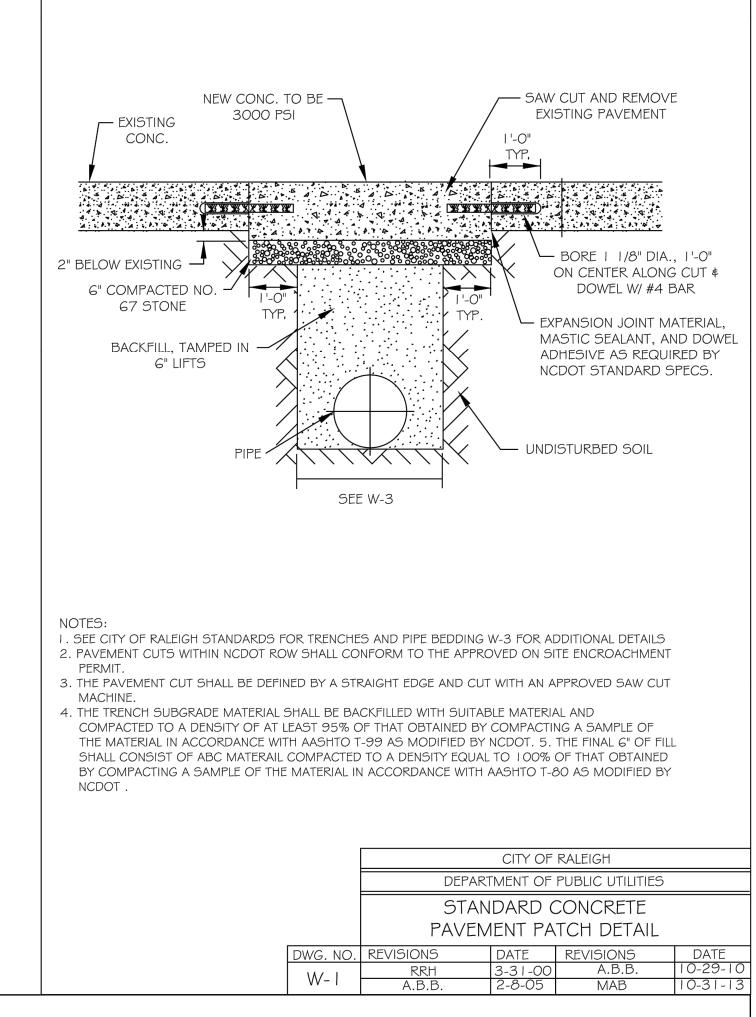
OLESVILLE
PREPARED FOR
AVA ENTERPRISES

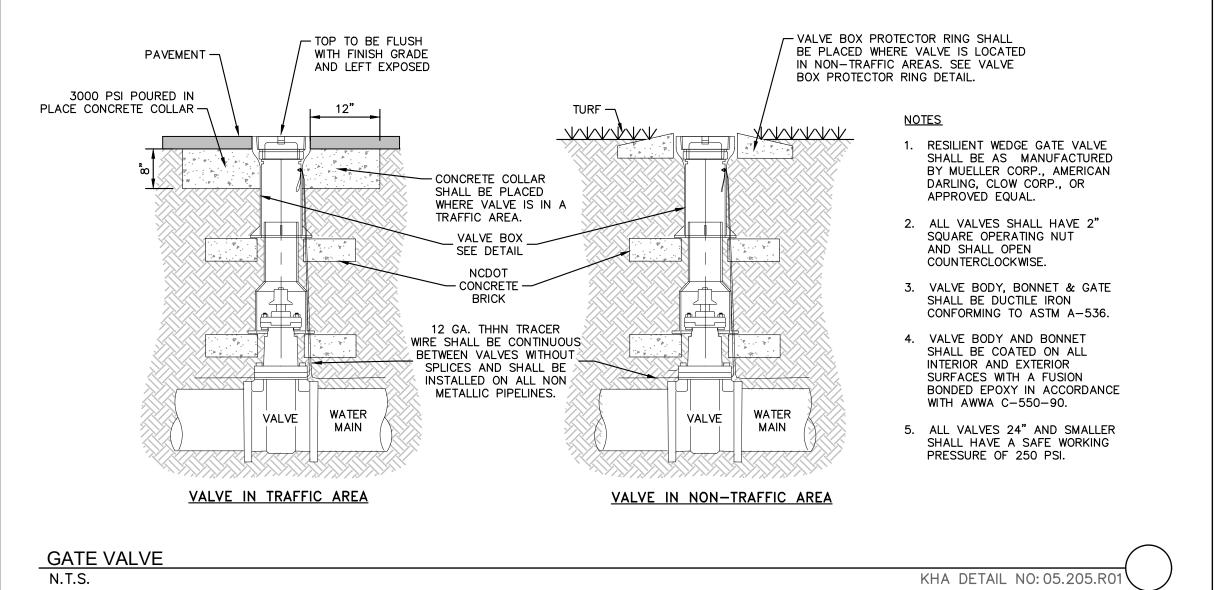
SHEET NUMBER
C11.0


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SHEET NUMBER C11.1

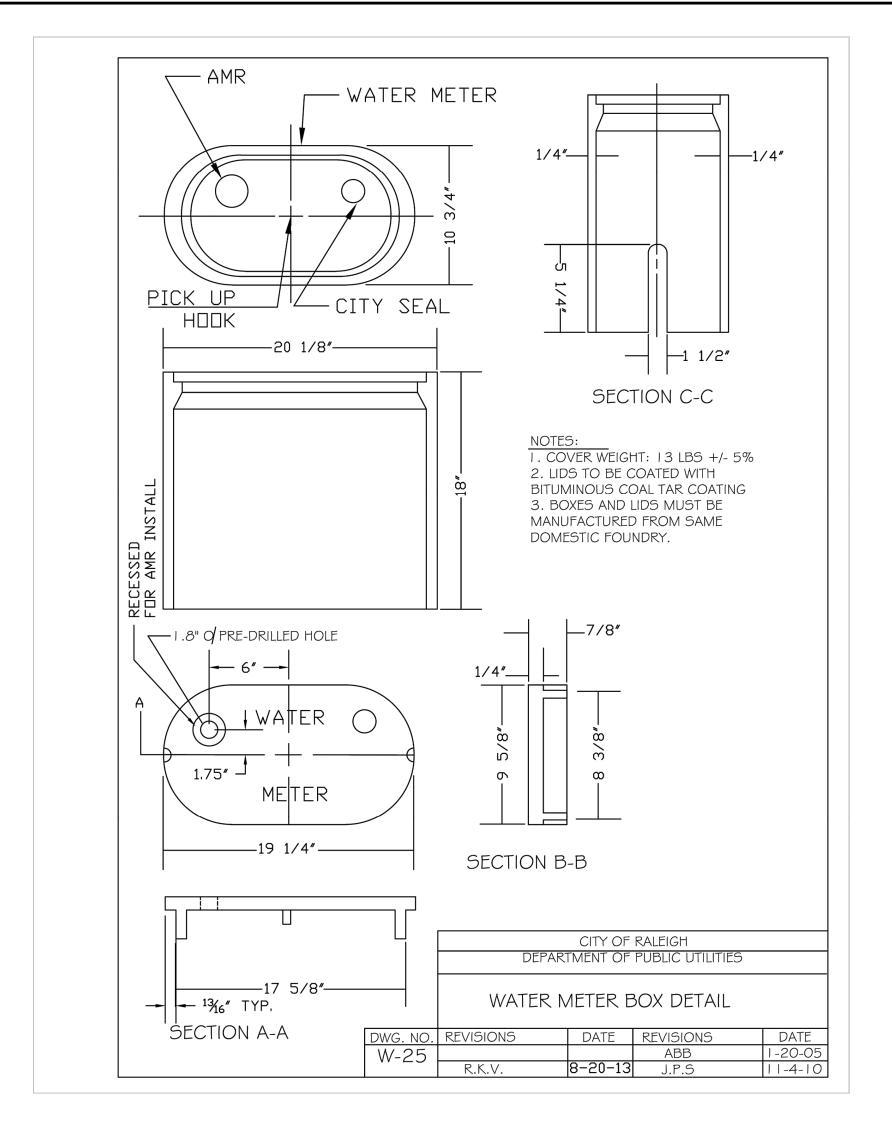**WATER** 

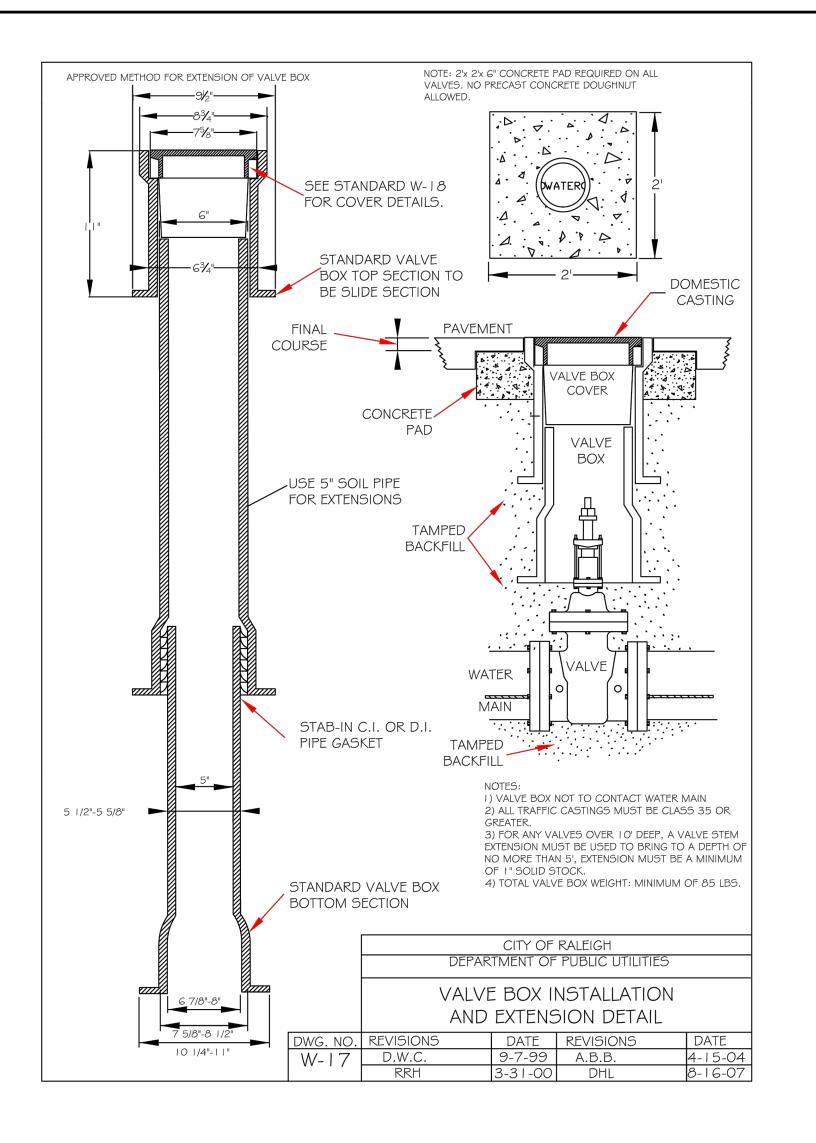VED FOR VIERPRISES

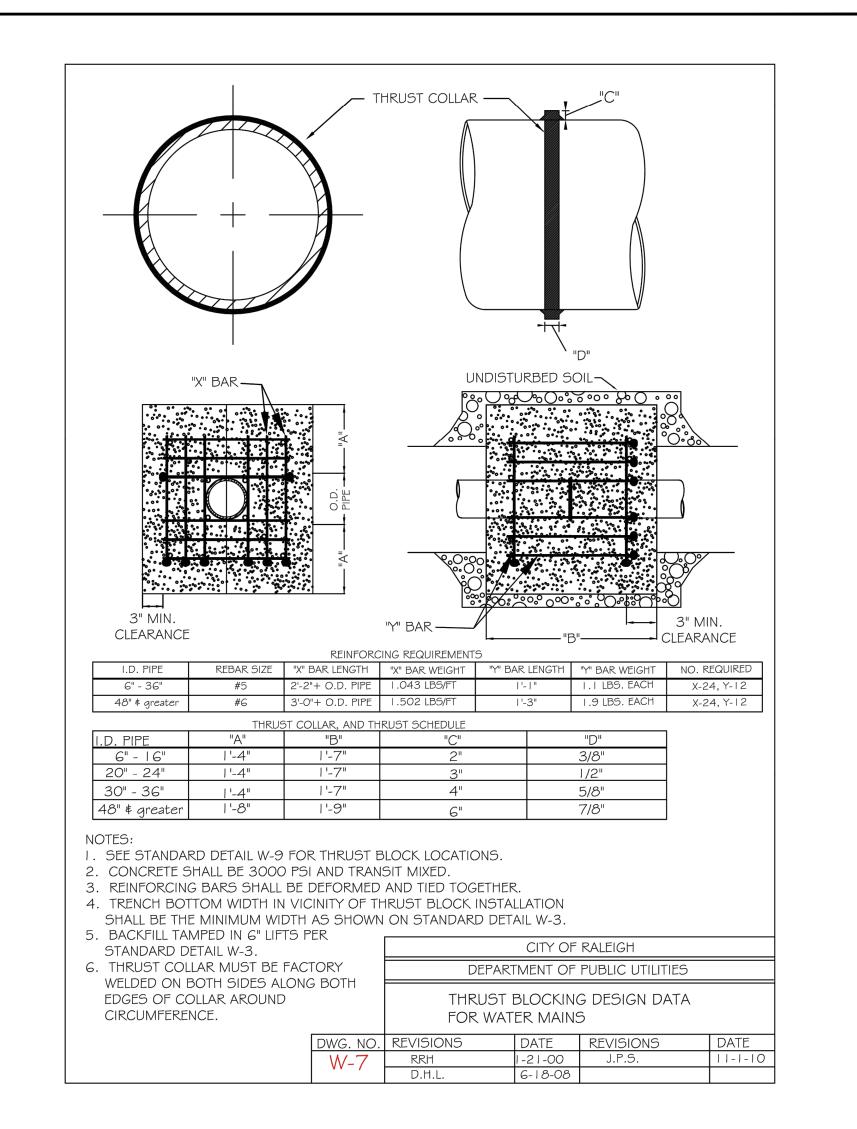S&S

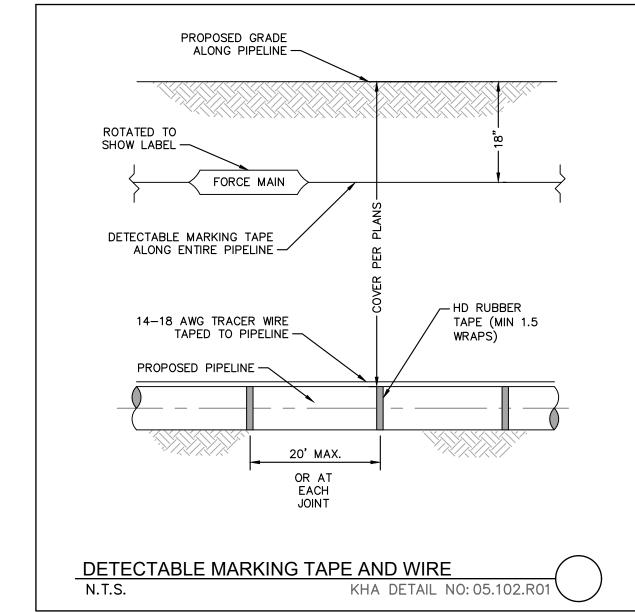(0) (4) (6) (4)

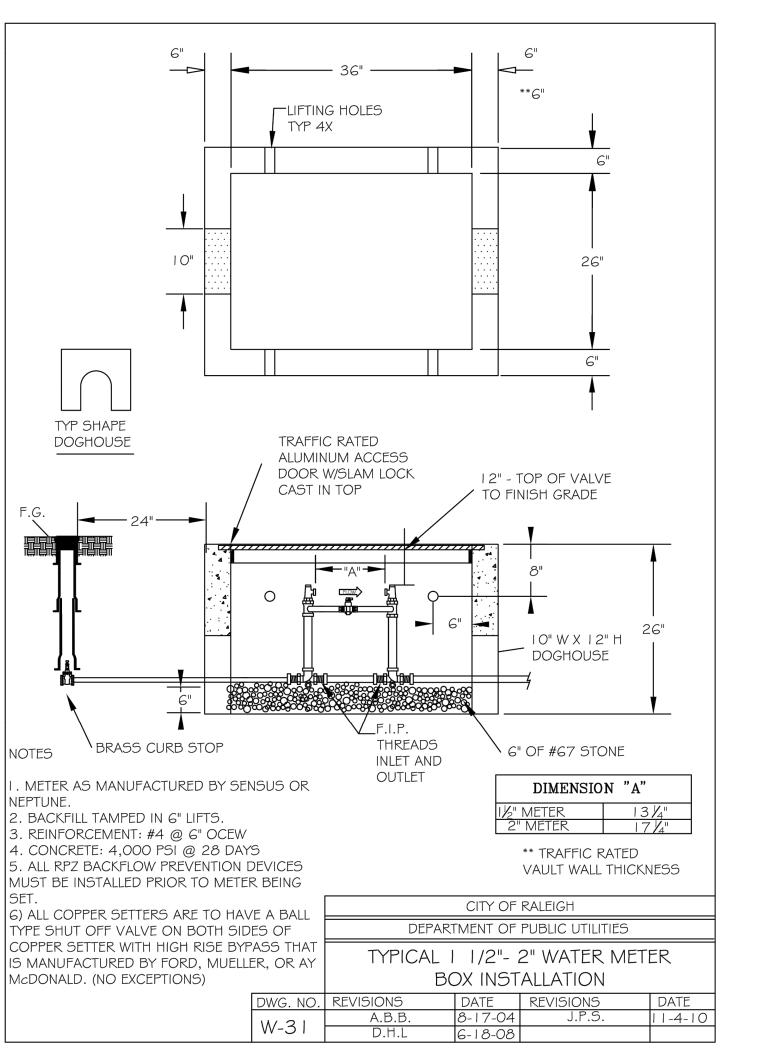SDP-23-09

## LANDSCAPE NOTES:

- 1. ALL LANDSCAPED AREAS ARE TO RECEIVE A MINIMUM OF 3" OF TOPSOIL. DO NOT MOUND MULCH AGAINST ROOT FLARES.
- 2. ALL PLANT MATERIAL SHALL BE HEALTHY, VIGOROUS, AND FREE OF PESTS AND DISEASE.
- 3. ALL MATERIALS ARE SUBJECT TO THE APPROVAL OF THE LANDSCAPE ARCHITECT BEFORE, DURING, AND AFTER INSTALLATION.
- 4. ALL TREES MUST BE GUYED OR STAKED AS SHOWN IN THE DETAILS.
- 5. ALL PLANTING AREAS SHALL BE COMPLETELY MULCHED AS SPECIFIED.
- 6. ANY DISTURBED GRASS AREA IS TO BE REPLANTED. ALL SLOPES 3:1 OR GREATER SHALL BE SEEDED WITH SLOPE MASTER NO-MOW MIX OR OWNER
- 7. PRIOR TO CONSTRUCTION, THE CONTRACTOR SHALL BE RESPONSIBLE FOR LOCATING ALL UNDERGROUND UTILITIES AND SHALL AVOID DAMAGE TO ALL UTILITIES DURING THE COURSE OF THE WORK. LOCATIONS OF EXISTING BURIED UTILITY LINES SHOWN ON THE PLANS ARE BASED UPON BEST AVAILABLE INFORMATION AND ARE TO BE CONSIDERED APPROXIMATE. IT SHALL BE THE RESPONSIBILITY OF THE CONTRACTOR 1) TO VERIFY THE LOCATIONS OF UTILITY LINES AND ADJACENT TO THE WORK AREA 2) TO PROTECT OF ALL UTILITY LINES DURING THE CONSTRUCTION PERIOD 3) TO REPAIR ANY AND ALL DAMAGE TO UTILITIES, STRUCTURES, SITE APPURTENANCES, ETC. WHICH OCCURS AS A RESULT OF THE CONSTRUCTION.
- 8. THE CONTRACTOR SHALL BE RESPONSIBLE FOR VERIFYING ALL QUANTITIES SHOWN ON THESE PLANS BEFORE PRICING THE WORK.
- 9. CONTRACTOR SHALL BE RESPONSIBLE FOR DELIVERY SCHEDULE AND PROTECTION BETWEEN DELIVERY AND PLANTING TO MAINTAIN HEALTHY PLANT
- 10. THE CONTRACTOR SHALL BE RESPONSIBLE FOR FULLY MAINTAINING (INCLUDING BUT NOT LIMITED TO: WATERING, SPRAYING, MULCHING, FERTILIZING, ETC.) ALL OF THE PLANT MATERIALS AND LAWN FOR THE WARRANTY PERIOD.
- 11. ANY PLANT MATERIAL WHICH IS DISEASED, DISTRESSED, DEAD, OR REJECTED (PRIOR TO SUBSTANTIAL COMPLETION) SHALL BE PROMPTLY REMOVED FROM THE SITE AND REPLACED WITH MATERIAL OF THE SAME SPECIES, QUANTITY, AND SIZE AND MEETING ALL PLANT LIST SPECIFICATIONS.
- 12. THE CONTRACTOR SHALL COMPLETELY GUARANTEE ALL PLANT MATERIAL FOR WARRANTY PERIOD. THE CONTRACTOR SHALL PROMPTLY MAKE ALL REPLACEMENTS DURING THE NORMAL PLANTING SEASON.
- 13. STANDARDS SET FORTH IN "AMERICAN STANDARD FOR NURSERY STOCK" REPRESENT GUIDELINE SPECIFICATIONS ONLY AND SHALL CONSTITUTE MINIMUM QUALITY REQUIREMENTS FOR PLANT MATERIAL.
- 14. ALL LANDSCAPING SHALL BE INSTALLED ACCORDING TO SOUND NURSERY PRACTICES, AND SHALL BE STATE STANDARD OR BETTER
- 15. ALL INVASIVE / EXOTIC SPECIES AND PROHIBITED TREE SPECIES SHALL BE REMOVED FROM SITE, INCLUDING ROOT BALLS TO THE EXTENT POSSIBLE WITH NO DAMAGE TO ADJACENT EXISTING TREES.
- 16. CONTRACTOR TO DESIGN BUILD SYSTEM AND VERIFY ALL PRODUCTS WITH LANDSCAPE ARCHITECT.
- 17. TREE SUPPORT MATERIALS ARE TO BE REMOVED FROM EACH TREE ONCE IT IS "ESTABLISHED" (AS APPROVED BY THE LANDSCAPE ARCHITECT).
- 18. CONTRACTOR SHALL BE RESPONSIBLE FOR ENSURING ALL UTILITIES ARE ADEQUATELY SCREENED WITH THE REQUIRED PLANTING MATERIAL AND
- 19. ALL PLANT SPECIFICATIONS IN THE PLANT SCHEDULE SHALL BE CONSIDERED THE MINIMUM ALLOWABLE SPECIFICATIONS. CONTRACTOR SHALL PROCURE PLANT MATERIALS AND UPSIZE AS NECESSARY TO MEET THE MOST STRINGENT SPECIFICATION.

PERIMETER BUFFER REQUIREMENTS 6.2.2.1							
Type 3 Perimeter Buffer: 136 lf	Required	Provided					
Width	25 feet	Provided					
Canopy Trees	4 canopy trees per 100 linear feet = 6 canopy trees	6 Canopy Trees					
Understory Trees	2 understory trees per 100 linear feet = 3 understory trees	3 Understory Trees					
Shrubs	60 shrubs per 100 linear feet = 82 shrubs	83 shrubs					
STREET BUFFER 6.2.2.2							
Street Buffer: 126 lf	Required	Provided					
Width	30 feet	Provided					
Street Tree	1 per 40 linear feet = 4 street trees	4 Street Trees					
PARKING LANDSCAPING 6.2.4.4	-						
Parking Perimeter	Required	Provided					
Shrubs	Continious row of shrubs within 5 feet of the parking lot edge	Provided					

- 1. ESTABLISH SOD IN ALL DISTURBED AREAS. SEE
- SPECIFICATIONS FOR MORE INFORMATION. 2. ALL AREAS WITH PROPOSED LANDSCAPE MATERIAL SHALL RECEIVE A MINIMUM THREE (3) INCHES OF SHREDDED HARDWOOD MULCH. SEE LANDSCAPE PLAN FOR MULCH BOUNDARY LINES. SEE LANDSCAPE DETAILS FOR TYPICAL MULCH AREA DIMENSIONS.

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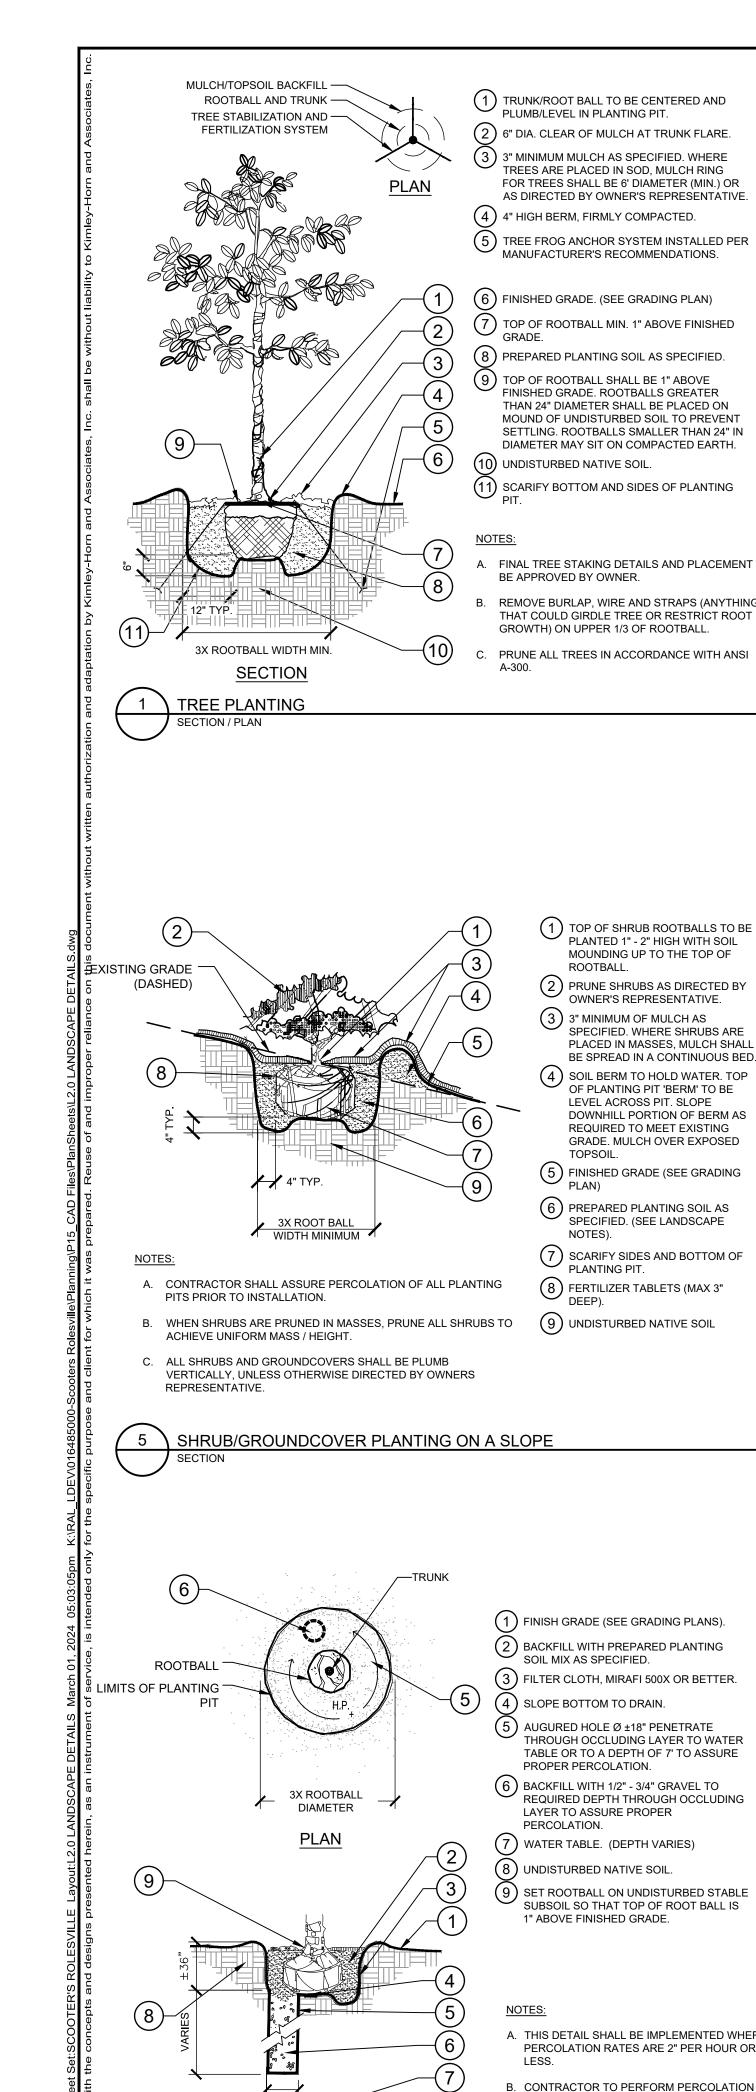
CORNUS FLORIDA FLOWERING DOGWOOD 5 GAL 2" CAL. MIN 8' MIN. MAGNOLIA GRANDIFLORA SOUTHERN MAGNOLIA | 5 GAL 3" CAL. 10-12` MIN STREET BUFFER TREES ACER RUBRUM RED MAPLE 5 GAL 3" CAL. 10-12` MIN SYMBOL CODE QTY BOTANICAL NAME COMMON NAME CONT. HEIGHT PERIMETER BUFFER SHRUBS DROOPING LEUCOTHOE 5 GAL 24" HT. LEUCOTHOE FONTANESIANA RHODODENDRON CATAWBIENSE | MOUNTAIN ROSEBAY 24" HT. VIRGINIA SWEETSPIRE | 5 GAL | 24" HT. ITEA VIRGINICA PARKING PERIMETER SHRUBS

COMMON BOXWOOD

BUXUS SEMPERVIRENS


SYMBOL CODE QTY BOTANICAL NAME

PERIMETER BUFFER TREES




**SECTION** 

9 \ POOR DRAINAGE CONDITION

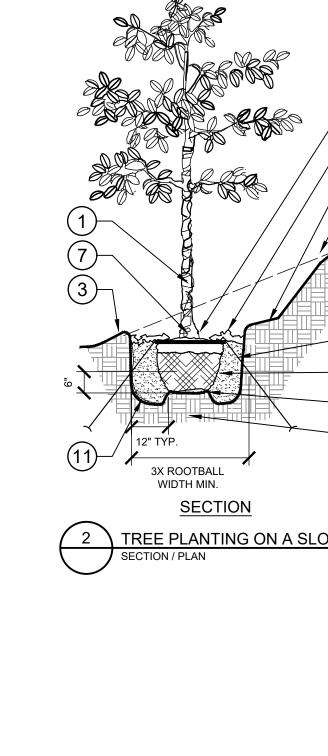

MULCH/TOPSOIL BACKFILL —


ROOTBALL AND TRUNK —

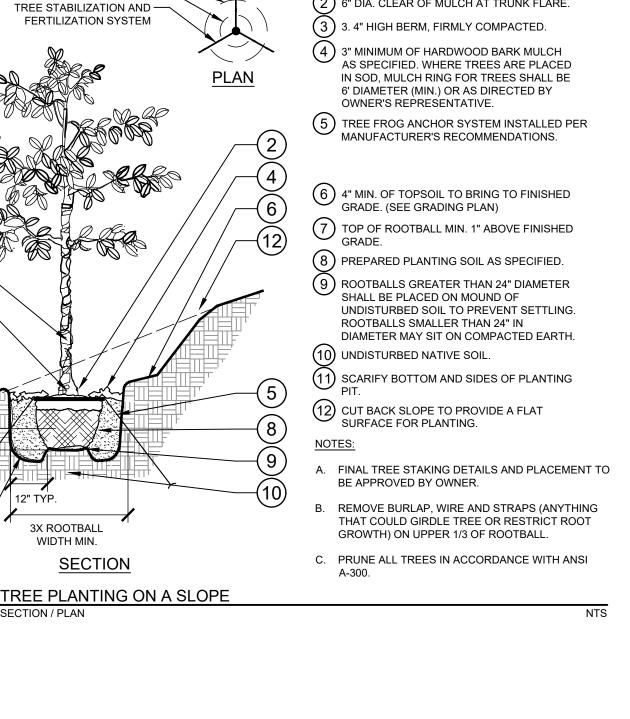



(1) TRUNK/ROOT BALL TO BE CENTERED AND

(2) 6" DIA. CLEAR OF MULCH AT TRUNK FLARE.

PLUMB/LEVEL IN PLANTING PIT.

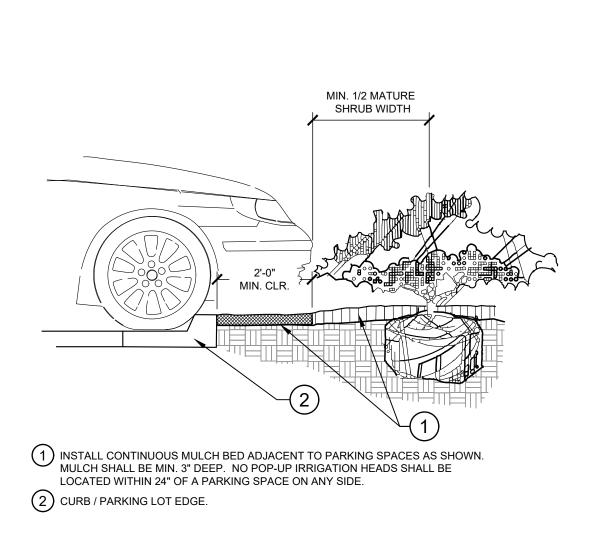

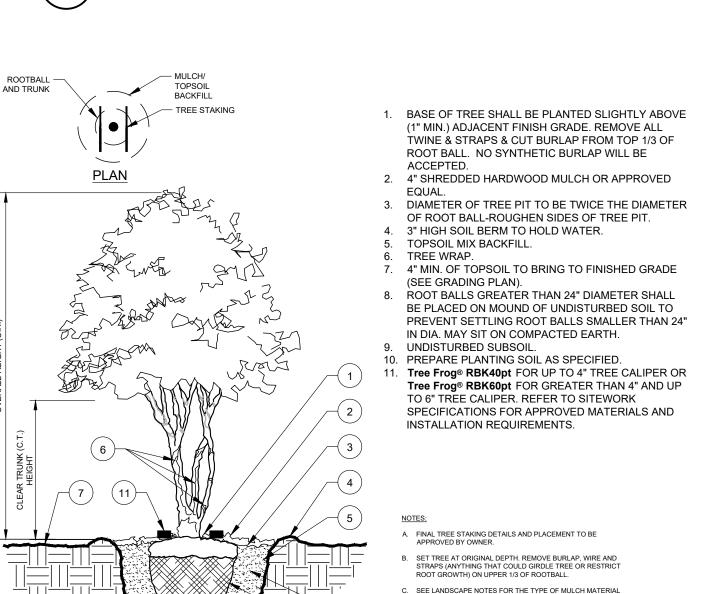

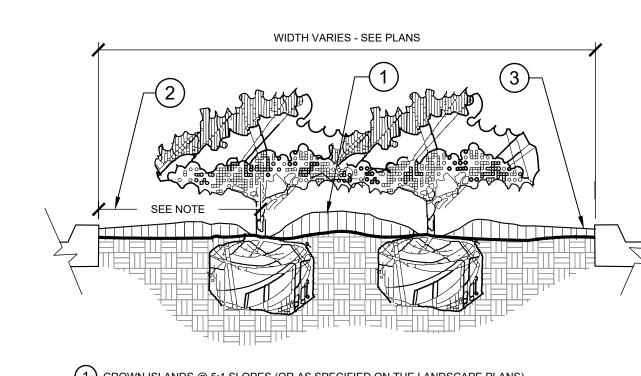



(1) CROWN ISLANDS @ 5:1 SLOPES (OR AS SPECIFIED ON THE LANDSCAPE PLANS).

2 ) CLEAR ZONE: 36" MIN. FROM BACK OF CURB TO CENTER OF NEAREST SHRUB. CLEAR ZONE SHALL CONTAIN 3" CONTINUOUS MULCH OR TURF, SEE PLANS. (3) 2" MIN VERTICAL CLEARANCE, TOP OF CURB TO TOP OF MULCH.


- A. EXCAVATE A CONTINUOUS 24" DEEP PIT (FROM TOP OF CURB) FOR ENTIRE LENGTH AND WIDTH OF ISLAND & BACKFILL WITH APPROVED PLANTING MIX.
- B. PROTECT AND RETAIN ALL CURBS AND BASE. COMPACTED SUBGRADE TO REMAIN FOR STRUCTURAL SUPPORT OF CURB SYSTEM (TYP).
- C. ALL ISLANDS SHALL UTILIZE POOR DRAINAGE DETAIL WHEN PERCOLATION RATES ARE 2" PER HOUR



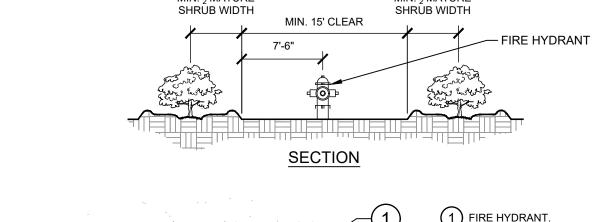


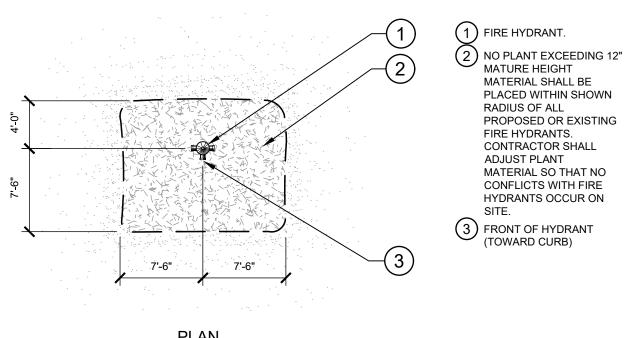

SHRUB PLANTING AT FIRE HYDRANT

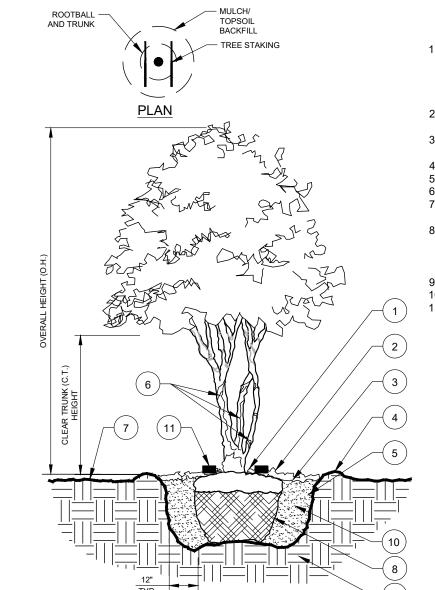


PARKING SPACE/CURB PLANTING

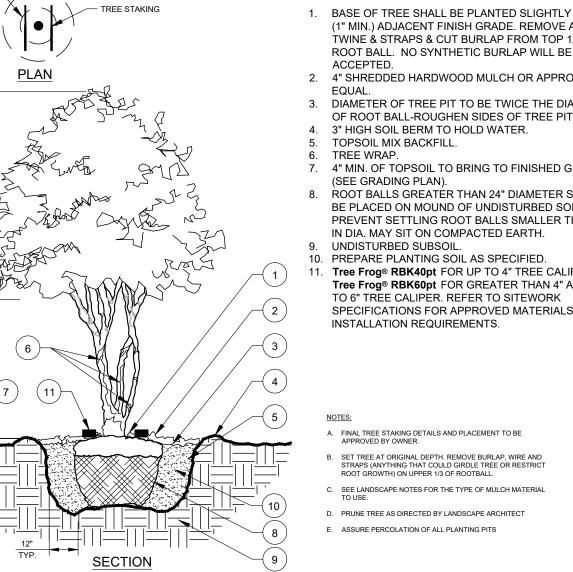

Know what's below. Call before you dig.

66466


A. CONTRACTOR SHALL ASSURE PERCOLATION OF ALL PLANTING PITS PRIOR TO INSTALLATION. B. WHEN SHRUBS ARE PRUNED IN MASSES, PRUNE ALL SHRUBS TO ACHIEVE UNIFORM MASS / HEIGHT C. ALL SHRUBS AND GROUNDCOVERS SHALL BE PLUMB VERTICALLY, UNLESS OTHERWISE DIRECTED BY OWNERS REPRESENTATIVE. SHRUB/GROUNDCOVER PLANTING MATURE SHRUB WIDTH 24" MIN. CLEAR

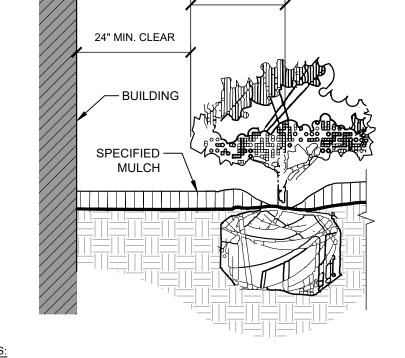

1. CLEAR ZONE: 36" MIN. FROM BUILDING TO CENTER OF NEAREST SHRUB.


2. INSTALL SPECIFIED MULCH: 24" MIN. FROM BUILDING. SPECIFIED MULCH TO BE INSTALLED AT



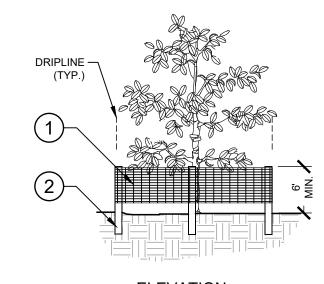

A DEPTH OF 3" (MIN.)

**INSTALLATION NOTES:** A. POST SELECTION SHOULD BE BASED ON EXPECTED STRENGTH NEEDS AND THE LENGTH OF TIME FENCE WILL BE IN PLACE. FLEXIBLE FIBERGLASS ROD POSTS ARE RECOMMENDED FOR PARKS, ATHLETIC EVENTS AND CROWD CONTROL INSTALLATIONS. METAL "T" POSTS OR TREATED WOOD POSTS ARE TYPICALLY USED FOR

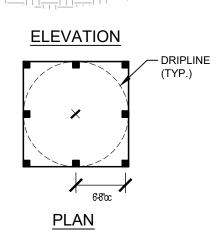

CONNECTION

CONSTRUCTION AND OTHER APPLICATIONS. B. POSTS SHOULD BE DRIVEN INTO THE GROUND TO A DEPTH OF 1/3 OF THE HEIGHT OF THE POST. FOR EXAMPLE, A 6' POST SHOULD BE SET AT LEAST 2' INTO THE GROUND. C. SPACE POSTS EVERY 6' (MIN.) TO 8' (MAX.).

(1) 6'H "PERIMETER PLUS" CONSTRUCTION FENCE BY CONWED PLASTICS OR OWNER'S

REPRESENTATIVE APPROVED EQUAL.

SUBMIT PRODUCT INFORMATION FOR

2) 8' TALL METAL "T" POSTS OR 2" x 2" X 8' PRESSURE TREATED WOOD POSTS WITH 24"


APPROVAL PRIOR TO INSTALLATION.

BURIAL BELOW GRADE.

D. SECURE FENCING TO POST WITH NYLON CABLE TIES (AVAILABLE FROM CONWED PLASTICS). WOOD STRIPS MAY BE ALSO BE USED TO PROVIDE ADDITIONAL SUPPORT AND PROTECTION BETWEEN TIES AND POSTS.

NOTE: IF WIRE TIES ARE USED, AVOID DIRECT CONTACT WITH FENCE. WIRE MAY DAMAGE FENCE OVER TIME.

TREE PROTECTION FENCING

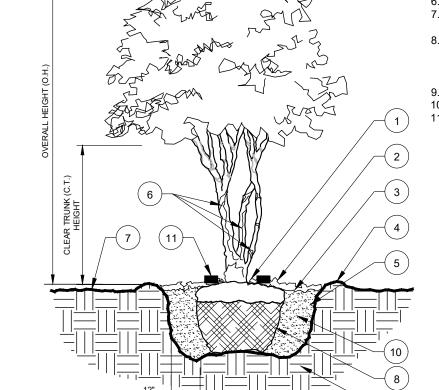

MULTI-TRUNK TREE PLANTING



3X ROOT BALL WIDTH MINIMUM

REFER TO PLANT

MAINTAIN 12" DEAD ZONE AT BED EDGE.

BEST FACE OF SHRUB/

**GROUNDCOVER TO FACE** 

FRONT OF PLANTING BED.

SCHEDULE FOR SPACING.

2) PRUNE ALL SHRUBS TO ACHIEVE A UNIFORM MASS/HEIGHT. (3) 3" MULCH LAYER AS SPECIFIED. (4) EXCAVATE ENTIRE BED SPECIFIED FOR GROUNDCOVER

5 FINISHED GRADE (SEE GRADING PLAN). (6) PREPARED PLANTING SOIL AS SPECIFIED. (SEE LANDSCAPE NOTES) NOTE: WHEN GROUND-COVERS AND SHRUBS USED IN

1) TOP OF SHRUB ROOTBALLS TO

OF ROOTBALL.

BE PLANTED 1" - 2" HIGH WITH


SOIL MOUNDING UP TO THE TOP

MASSES, ENTIRE BED TO BE AMENDED WITH PLANTING SOIL MIX AS SPECIFIED.

(7) SCARIFY OF PLANTING PIT SIDES AND BOTTOM.

(8) 4" HIGH BERM FIRMLY COMPACTED. (9) UNDISTURBED NATIVE SOIL. (10) FERTILIZER TABLETS (MAX 3"

MIN. 3 MATURE MIN. 3 MATURE

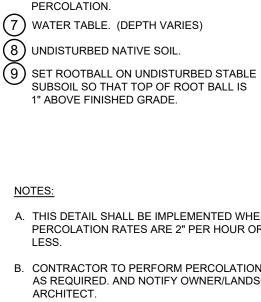

PLUMB/LEVEL IN PLANTING PIT.

TREES ARE PLACED IN SOD, MULCH RING

MANUFACTURER'S RECOMMENDATIONS.

FINISHED GRADE. ROOTBALLS GREATER

THAN 24" DIAMETER SHALL BE PLACED ON

MOUND OF UNDISTURBED SOIL TO PREVENT

SETTLING. ROOTBALLS SMALLER THAN 24" IN

DIAMETER MAY SIT ON COMPACTED EARTH.

FINAL TREE STAKING DETAILS AND PLACEMENT TO

REMOVE BURLAP, WIRE AND STRAPS (ANYTHING

1) TOP OF SHRUB ROOTBALLS TO BE PLANTED 1" - 2" HIGH WITH SOIL

MOUNDING UP TO THE TOP OF

PRUNE SHRUBS AS DIRECTED BY OWNER'S REPRESENTATIVE.

SPECIFIED. WHERE SHRUBS ARE PLACED IN MASSES, MULCH SHALL BE SPREAD IN A CONTINUOUS BED. 1) SOIL BERM TO HOLD WATER. TOP

OF PLANTING PIT 'BERM' TO BE

DOWNHILL PORTION OF BERM AS

LEVEL ACROSS PIT. SLOPE

REQUIRED TO MEET EXISTING

(5) FINISHED GRADE (SEE GRADING

SPECIFIED. (SEE LANDSCAPE

7 SCARIFY SIDES AND BOTTOM OF

8 FERTILIZER TABLETS (MAX 3" DEEP).

9 UNDISTURBED NATIVE SOIL

FINISH GRADE (SEE GRADING PLANS).

(2) BACKFILL WITH PREPARED PLANTING

(5) AUGURED HOLE Ø ±18" PENETRATE

(6) BACKFILL WITH 1/2" - 3/4" GRAVEL TO

LAYER TO ASSURE PROPER

(3) FILTER CLOTH, MIRAFI 500X OR BETTER.

THROUGH OCCLUDING LAYER TO WATER

TABLE OR TO A DEPTH OF 7' TO ASSURE

REQUIRED DEPTH THROUGH OCCLUDING

SOIL MIX AS SPECIFIED.

(4) SLOPE BOTTOM TO DRAIN.

PROPER PERCOLATION.

6 PREPARED PLANTING SOIL AS

GRADE. MULCH OVER EXPOSED

3) 3" MINIMUM OF MULCH AS

ROOTBALL.

TOPSOIL.

PLANTING PIT.

THAT COULD GIRDLE TREE OR RESTRICT ROOT

GROWTH) ON UPPER 1/3 OF ROOTBALL.

BE APPROVED BY OWNER.

FOR TREES SHALL BE 6' DIAMETER (MIN.) OR

AS DIRECTED BY OWNER'S REPRESENTATIVE.

A. THIS DETAIL SHALL BE IMPLEMENTED WHERE PERCOLATION RATES ARE 2" PER HOUR OR

. CONTRACTOR TO PERFORM PERCOLATION TEST AS REQUIRED. AND NOTIFY OWNER/LANDSCAPE

C. SEE TYPICAL TREE PLANTING DETAIL THIS SHEET FOR PLANT STAKING.

SDP-23-09

SHEET NUMBER

## A. SCOPE OF WORK

- THE WORK CONSISTS OF: FURNISHING ALL LABOR, MATERIALS, EQUIPMENT, TOOLS, TRANSPORTATION, AND ANY OTHER APPURTENANCES NECESSARY FOR THE COMPLETION OF THIS PROJECT AS SHOWN ON THE DRAWINGS, AS INCLUDED IN THE PLANT LIST, AND AS SPECIFIED
- WORK SHALL INCLUDE MAINTENANCE AND WATERING OF ALL CONTRACT PLANTING AREAS UNTIL CERTIFICATION OF ACCEPTANCE BY THE

## B. PROTECTION OF EXISTING STRUCTURES

- ALL EXISTING BUILDINGS, WALKS, WALLS, PAVING, PIPING, OTHER SITE CONSTRUCTION ITEMS, AND PLANTING ALREADY COMPLETED OR ESTABLISHED AND DESIGNATED TO REMAIN SHALL BE PROTECTED FROM DAMAGE BY THE CONTRACTOR UNLESS OTHERWISE SPECIFIED. ALL DAMAGE RESULTING FROM NEGLIGENCE SHALL BE REPAIRED OR REPLACED TO THE SATISFACTION OF THE OWNER, AT NO COST TO THE
- THE CONTRACTOR SHALL BE RESPONSIBLE FOR MAINTAINING ALL NECESSARY BMP DEVICES ACCORDING TO ALL REGULATORY AGENCY'S STANDARDS THROUGH THE DURATION OF ALL CONSTRUCTION ACTIVITIES.
- THE CONTRACTOR SHALL SUBMIT A DETAILED PROJECT SPECIFIC WORK ZONE TRAFFIC CONTROL PLAN UNLESS THE WORK REQUIRES NOTHING MORE THAN A DIRECT APPLICATION OF DOT DESIGN STANDARDS, INDEX 600. IF A DIRECT APPLICATION OF INDEX 600 IS PROPOSED, THE CONTRACTOR SHALL SUBMIT IN WRITING A STATEMENT INDICATING THE STANDARD INDEX AND PAGE NUMBER NO LESS THAN 10 BUSINESS DAYS PRIOR TO START OF CONSTRUCTION. WHEN A DIRECT APPLICATION OF DOT STANDARD INDEX 600 IS NOT ACCEPTABLE A PROJECT SPECIFIC WORK ZONE TRAFFIC CONTROL PLAN SHALL BE PREPARED BY A PROFESSIONAL ENGINEER WHO HAS SUCCESSFULLY COMPLETED ADVANCED TRAINING IN MAINTENANCE OF TRAFFIC, AS DEFINED BY DOT FOR APPROVAL BY THE COUNTY ENGINEER'S REPRESENTATIVE.
- 4. THE CONTRACTOR SHALL BE RESPONSIBLE FOR LOCATING ALL UTILITIES, WHETHER PUBLIC OR PRIVATE, PRIOR TO EXCAVATION. THE INFORMATION AND DATA SHOWN WITH RESPECT TO EXISTING UNDERGROUND FACILITIES AT OR CONTIGUOUS TO THE SITE IS APPROXIMATE AND BASED ON INFORMATION FURNISHED BY THE OWNER OF SUCH UNDERGROUND FACILITIES OR ON PHYSICAL APPURTENANCES OBSERVED IN THE FIELD. THE OWNER AND DESIGN PROFESSIONAL SHALL NOT BE RESPONSIBLE FOR THE ACCURACY AND COMPLETENESS OF ANY SUCH INFORMATION OR DATA. THE CONTRACTOR SHALL HAVE FULL RESPONSIBILITY FOR; REVIEWING AND CHECKING ALL SUCH INFORMATION AND DATA; LOCATING ALL UNDERGROUND FACILITIES DURING CONSTRUCTION; THE SAFETY AND PROTECTION THEREOF; REPAIRING ANY DAMAGE THERETO RESULTING FROM THE WORK. THE COST OF ALL WILL BE CONSIDERED AS HAVING BEEN INCLUDED IN THE CONTRACT PRICE. THE CONTRACTOR SHALL NOTIFY ANY AFFECTED UTILITY COMPANIES OR AGENCIES IN WRITING AT LEAST 48 HOURS PRIOR TO BEGINNING

## C. PROTECTION OF EXISTING PLANT MATERIALS

THE CONTRACTOR SHALL BE RESPONSIBLE FOR ALL UNAUTHORIZED CUTTING OR DAMAGE TO TREES AND SHRUBS EXISTING OR OTHERWISE CAUSED BY CARELESS EQUIPMENT OPERATION, MATERIAL STOCKPILING, ETC... THIS SHALL INCLUDE COMPACTION BY DRIVING OR PARKING INSIDE THE DRIP-LINE AND SPILLING OIL, GASOLINE, OR OTHER DELETERIOUS MATERIALS WITHIN THE DRIP-LINE, NO MATERIALS SHALL BE BURNED ON SITE. EXISTING TREES KILLED OR DAMAGED SO THAT THEY ARE MISSHAPEN AND/OR UNSIGHTLY SHALL BE REPLACED AT THE COST TO THE CONTRACTOR OF THREE HUNDRED DOLLARS (\$300) PER CALIPER INCH ON AN ESCALATING SCALE WHICH ADDS AN ADDITIONAL TWENTY (20) PERCENT PER INCH OVER FOUR (4) INCHES CALIPER AS FIXED AND AGREED LIQUIDATED DAMAGES. CALIPER SHALL BE MEASURED SIX (6) INCHES ABOVE GROUND LEVEL FOR TREES UP TO AND INCLUDING FOUR (4) INCHES IN CALIPER AND TWELVE (12) INCHES ABOVE GROUND LEVEL FOR TREES OVER FOUR (4) INCHES IN CALIPER.

2. SEE TREE MITIGATION PLAN AND NOTES, IF APPLICABLE

# D. MATERIALS

## GENERAL

MATERIAL SAMPLES LISTED BELOW SHALL BE SUBMITTED FOR APPROVAL, ON SITE OR AS DETERMINED BY THE OWNER. UPON APPROVAL DELIVERY OF MATERIALS MAY COMMENCE

ONE (1) CUBIC FOOT TOPSOIL MIX PLANTS ONE (1) OF EACH VARIETY (OR TAGGED IN NURSERY)

## 2. PLANT MATERIALS

- a. PLANT SPECIES AND SIZE SHALL CONFORM TO THOSE INDICATED ON THE DRAWINGS. ALL PLANTS SHALL BE DETERMINED BY THE STATE DIVISION OF PLANT INDUSTRY. ALL PLANTS SHALL BE HEALTHY, VIGOROUS, SOUND, WELL-BRANCHED, AND FREE OF DISEASE AND INSECTS INSECT EGGS AND LARVAE AND SHALL HAVE ADEQUATE ROOT SYSTEMS. TREES FOR PLANTING IN ROWS SHALL BE UNIFORM IN SIZE AND SHAPE. ALL MATERIALS SHALL BE SUBJECT TO APPROVAL BY THE OWNER. WHERE ANY REQUIREMENTS ARE OMITTED FROM THE PLANT LIST, THE PLANTS FURNISHED SHALL BE NORMAL FOR THE VARIETY. PLANTS SHALL BE PRUNED PRIOR TO DELIVERY ONLY WITH APPROVAL FROM OWNER OR OWNER'S REPRESENTATIVE. NO SUBSTITUTIONS SHALL BE MADE WITHOUT WRITTEN PERMISSION FROM THE OWNER'S
- b. MEASUREMENTS: THE HEIGHT AND/OR WIDTH OF TREES SHALL BE MEASURED FROM THE GROUND OR ACROSS THE NORMAL SPREAD OF BRANCHES WITH THE PLANTS IN THEIR NORMAL POSITION. THIS MEASUREMENT SHALL NOT INCLUDE THE IMMEDIATE TERMINAL GROWTH. PLANTS LARGER IN SIZE THAN THOSE SPECIFIED IN THE PLANT LIST MAY BE USED IF APPROVED BY THE OWNER. IF THE USE OF LARGER PLANTS IS APPROVED, THE BALL OF EARTH OR SPREAD OF ROOTS SHALL BE INCREASED IN PROPORTION TO THE SIZE OF THE PLANT.
- c. INSPECTION: PLANTS SHALL BE SUBJECT TO INSPECTION AND APPROVAL AT THE PLACE OF GROWTH, OR UPON DELIVERY TO THE SITE, AS DETERMINED BY THE OWNER, FOR QUALITY, SIZE, AND VARIETY. SUCH APPROVAL SHALL NOT IMPAIR THE RIGHT OF INSPECTION AND REJECTION AT THE SITE DURING PROGRESS OF THE WORK OR AFTER COMPLETION FOR SIZE AND CONDITION OF ROOT BALLS OR ROOTS, LATENT DEFECTS OR INJURIES. REJECTED PLANTS SHALL BE REMOVED IMMEDIATELY FROM THE SITE. NOTICE REQUESTING INSPECTION SHALL BE SUBMITTED IN WRITING BY THE CONTRACTOR AT LEAST ONE (1) WEEK PRIOR TO ANTICIPATED DATE.

## E. SOIL MIXTURE (PLANTING MEDIUM, PLANTING MIX, TOPSOIL MIX)

- 1. CONTRACTOR SHALL TEST EXISTING SOIL AND AMEND AS NECESSARY IN ACCORDANCE WITH THE GUIDELINES BELOW:
- 2. SOIL MIXTURE (PLANTING MEDIUM FOR PLANT PITS) SHALL CONSIST OF TWO PARTS OF TOPSOIL AND ONE PART SAND, AS DESCRIBED BELOW. CONTRACTOR TO SUBMIT SAMPLES AND PH TESTING RESULTS OF SOIL MIXTURE FOR OWNER'S REPRESENTATIVE APPROVAL PRIOR TO PLANT
- a. TOPSOIL FOR USE IN PREPARING SOIL MIXTURE FOR BACKFILLING PLANT PITS SHALL BE FERTILE, FRIABLE, AND OF A LOAMY CHARACTER; REASONABLY FREE OF SUBSOIL, CLAY LUMPS, BRUSH WEEDS AND OTHER LITTER; FREE OF ROOTS, STUMPS, STONES LARGER THAN 2" IN ANY DIRECTION, AND OTHER EXTRANEOUS OR TOXIC MATTER HARMFUL TO PLANT GROWTH. IT SHALL CONTAIN THREE (3) TO FIVE (5) PERCENT DECOMPOSED ORGANIC MATTER AND HAVE A PH BETWEEN 5.5 AND 7.0.
- b. <u>SAND</u> SHALL BE COARSE, CLEAN, WELL-DRAINING, NATIVE SAND.
- TREES SHALL BE PLANTED IN THE EXISTING NATIVE SOIL ON SITE, UNLESS DETERMINED TO BE UNSUITABLE AT WHICH POINT THE CONTRACTOR SHALL CONTACT OWNER'S REPRESENTATIVE TO DISCUSS ALTERNATE RECOMMENDATION PRIOR TO PLANTING.

1. WATER NECESSARY FOR PLANTING AND MAINTENANCE SHALL BE OF SATISFACTORY QUALITY TO SUSTAIN ADEQUATE PLANT GROWTH AND SHALL NOT CONTAIN HARMFUL, NATURAL OR MAN-MADE ELEMENTS DETRIMENTAL TO PLANTS. WATER MEETING THE ABOVE STANDARD SHALL BE OBTAINED ON THE SITE FROM THE OWNER, IF AVAILABLE, AND THE CONTRACTOR SHALL BE RESPONSIBLE TO MAKE ARRANGEMENTS FOR ITS USE BY HIS TANKS, HOSES, SPRINKLERS, ETC.... IF SUCH WATER IS NOT AVAILABLE AT THE SITE, THE CONTRACTOR SHALL PROVIDE SATISFACTORY WATER FROM SOURCES OFF THE SITE AT NO ADDITIONAL COST TO THE OWNER.

\* WATERING/IRRIGATION RESTRICTIONS MAY APPLY - REFER TO PROPERTY'S JURISDICTIONAL AUTHORITY.

## G. FERTILIZER

CONTRACTOR SHALL PROVIDE FERTILIZER APPLICATION SCHEDULE TO OWNER, AS APPLICABLE TO SOIL TYPE, PLANT INSTALLATION TYPE, AND SITE'S PROPOSED USE. SUGGESTED FERTILIZER TYPES SHALL BE ORGANIC OR OTHERWISE NATURALLY-DERIVED.

## \* FERTILIZER RESTRICTIONS MAY APPLY - REFER TO PROPERTY'S JURISDICTIONAL AUTHORITY.

- MULCH MATERIAL SHALL BE MOISTENED AT THE TIME OF APPLICATION TO PREVENT WIND DISPLACEMENT, AND APPLIED AT A DEPTH OF THREE (3) INCHES. CLEAR MULCH FROM EACH PLANT'S CROWN (BASE). MULCH SHALL BE "FLORIMULCH," EUCALYPTUS MULCH, OR SIMILAR SUSTAINABLY HARVESTED MULCH UNLESS SPECIFIED OTHERWISE.
- PROVIDE A THREE (3) INCH MINIMUM LAYER OF SPECIFIED MULCH OVER THE ENTIRE AREA OF EACH SHRUB BED, GROUND COVER, VINE BED, AND TREE PIT (6' MINIMUM) PLANTED UNDER THIS CONTRACT.

## DIGGING AND HANDLING

- PROTECT ROOTS OR ROOT BALLS OF PLANTS AT ALL TIMES FROM SUN, DRYING WINDS, WATER AND FREEZING, AS NECESSARY UNTIL PLANTING. PLANT MATERIALS SHALL BE ADEQUATELY PACKED TO PREVENT DAMAGE DURING TRANSIT. TREES TRANSPORTED MORE THAN TEN (10) MILES OR WHICH ARE NOT PLANTED WITHIN THREE (3) DAYS OF DELIVERY TO THE SITE SHALL BE SPRAYED WITH AN ANTITRANSPIRANT PRODUCT ("WILTPRUF" OR EQUAL) TO MINIMIZE TRANSPIRATIONAL WATER LOSS.
- 2. BALLED AND BURLAPPED (B&B), AND FIELD GROWN (FG) PLANTS SHALL BE DUG WITH FIRM, NATURAL BALLS OF SOIL OF SUFFICIENT SIZE TO ENCOMPASS THE FIBROUS AND FEEDING ROOTS OF THE PLANTS. NO PLANTS MOVED WITH A ROOT BALL SHALL BE PLANTED IF THE BALL IS

## CRACKED OR BROKEN. PLANTS SHALL NOT BE HANDLED BY STEMS.

- PLANTS MARKED "BR" IN THE PLANT LIST SHALL BE DUG WITH BARE ROOTS. CARE SHALL BE EXERCISED THAT THE ROOTS DO NOT DRY OUT DURING TRANSPORTATION AND PRIOR TO PLANTING.
- 4. PROTECTION OF PALMS: ONLY A MINIMUM OF FRONDS SHALL BE REMOVED FROM THE CROWN OF THE PALM TREES TO FACILITATE MOVING AND HANDLING. CLEAR TRUNK (CT) SHALL BE AS SPECIFIED AFTER THE MINIMUM OF FRONDS HAVE BEEN REMOVED. ALL PALMS SHALL BE BRACED
- 5. EXCAVATION OF TREE PITS SHALL BE PERFORMED USING EXTREME CARE TO AVOID DAMAGE TO SURFACE AND SUBSURFACE ELEMENTS SUCH AS UTILITIES OR HARDSCAPE ELEMENTS, FOOTERS AND PREPARED SUB-BASES.

- ALL CONTAINER GROWN MATERIAL SHALL BE HEALTHY, VIGOROUS, WELL-ROOTED PLANTS ESTABLISHED IN THE CONTAINER IN WHICH THEY ARE SOLD. THE PLANTS SHALL HAVE TOPS WHICH ARE OF GOOD QUALITY AND ARE IN A HEALTHY GROWING CONDITION.
- AN ESTABLISHED CONTAINER GROWN PLANT SHALL BE TRANSPLANTED INTO A CONTAINER AND GROWN IN THAT CONTAINER SUFFICIENTLY LONG ENOUGH FOR THE NEW FIBROUS ROOTS TO HAVE DEVELOPED SO THAT THE ROOT MASS WILL RETAIN ITS SHAPE AND HOLD TOGETHER WHEN REMOVED FROM THE CONTAINER. CONTAINER GROWN STOCK SHALL NOT BE HANDLED BY THEIR STEMS.
- 3. ROOT BOUND PLANTS ARE NOT ACCEPTABLE AND WILL BE REJECTED.
- 4. RPG= "ROOTS PLUS GROWER" CONTAINER PRODUCTS SHALL BE USED WHERE SPECIFIED.

WHEN THE USE OF COLLECTED STOCK IS PERMITTED AS INDICATED BY THE OWNER OR OWNER'S REPRESENTATIVE. THE MINIMUM SIZES OF ROOTBALLS SHALL BE EQUAL TO THAT SPECIFIED FOR THE NEXT LARGER SIZE OF NURSERY GROWN STOCK OF THE SAME VARIETY.

PLANTS COLLECTED FROM WILD OR NATIVE STANDS SHALL BE CONSIDERED NURSERY GROWN WHEN THEY HAVE BEEN SUCCESSFULLY RE-ESTABLISHED IN A NURSERY ROW AND GROWN UNDER REGULAR NURSERY CULTURAL PRACTICES FOR A MINIMUM OF TWO (2) GROWING SEASONS AND HAVE ATTAINED ADEQUATE ROOT AND TOP GROWTH TO INDICATE FULL RECOVERY FROM TRANSPLANTING INTO THE NURSERY ROW.

## M MATERIALS LIST

QUANTITIES NECESSARY TO COMPLETE THE WORK ON THE DRAWINGS SHALL BE FURNISHED BY THE CONTRACTOR. QUANTITY ESTIMATES HAVE BEEN MADE CAREFULLY, BUT THE LANDSCAPE ARCHITECT OR OWNER ASSUMES NO LIABILITY FOR OMISSIONS OR ERRORS. SHOULD A DISCREPANCY OCCUR BETWEEN THE PLANS AND THE PLANT LIST QUANTITY, THE OWNER'S REPRESENTATIVE SHALL BE NOTIFIED FOR CLARIFICATION PRIOR TO BIDDING OR INSTALLATION. ALL DIMENSIONS AND/OR SIZES SPECIFIED SHALL BE THE MINIMUM ACCEPTABLE SIZE.

- FINE GRADING UNDER THIS CONTRACT SHALL CONSIST OF FINAL FINISHED GRADING OF LAWN AND PLANTING AREAS THAT HAVE BEEN ROUGH GRADED BY OTHERS. BERMING AS SHOWN ON THE DRAWINGS SHALL BE THE RESPONSIBILITY OF THE CONTRACTOR, UNLESS OTHERWISE
- THE CONTRACTOR SHALL FINE GRADE THE LAWN AND PLANTING AREAS TO BRING THE ROUGH GRADE UP TO FINAL FINISHED GRADE ALLOWING FOR THICKNESS OF SOD AND/OR MULCH DEPTH. CONTRACTOR SHALL FINE GRADE BY HAND AND/OR WITH ALL EQUIPMENT NECESSARY

INCLUDING A GRADING TRACTOR WITH FRONT-END LOADER FOR TRANSPORTING SOIL WITHIN THE SITE.

ALL PLANTING AREAS SHALL BE GRADED AND MAINTAINED FOR POSITIVE DRAINAGE TO SURFACE/SUBSURFACE STORM DRAIN SYSTEMS. AREAS ADJACENT TO BUILDINGS SHALL SLOPE AWAY FROM THE BUILDINGS. REFER TO CIVIL ENGINEER'S PLANS FOR FINAL GRADES, IF APPLICABLE.

## O. PLANTING PROCEDURES

- CLEANING UP BEFORE COMMENCING WORK: THE CONTRACTOR SHALL CLEAN WORK AND SURROUNDING AREAS OF ALL RUBBISH OR OBJECTIONABLE MATTER DAILY, ALL MORTAR, CEMENT, AND TOXIC MATERIAL SHALL BE REMOVED FROM THE SURFACE OF ALL PLANT BEDS THESE MATERIALS SHALL NOT BE MIXED WITH THE SOIL. SHOULD THE CONTRACTOR FIND SUCH SOIL CONDITIONS BENEATH THE SOIL WHICH WILL IN ANY WAY ADVERSELY AFFECT THE PLANT GROWTH, HE SHALL IMMEDIATELY CALL IT TO THE ATTENTION OF THE OWNER'S REPRESENTATIVE. FAILURE TO DO SO BEFORE PLANTING SHALL MAKE THE CORRECTIVE MEASURES THE RESPONSIBILITY OF THE CONTRACTOR.
- VERIFY LOCATIONS OF ALL UTILITIES, CONDUITS, SUPPLY LINES AND CABLES, INCLUDING BUT NOT LIMITED TO: ELECTRIC, GAS (LINES AND TANKS), WATER, SANITARY SEWER, STORMWATER SYSTEMS, CABLE, AND TELEPHONE. PROPERLY MAINTAIN AND PROTECT EXISTING UTILITIES. CALL STATE OFFICIAL (811) TO LOCATE UTILITIES AT LEAST 48 HOURS PRIOR TO CONSTRUCTION.
- SUBGRADE EXCAVATION: CONTRACTOR IS RESPONSIBLE TO REMOVE ALL EXISTING AND IMPORTED LIMEROCK AND LIMEROCK SUB-BASE FROM ALL LANDSCAPE PLANTING AREAS TO A MINIMUM DEPTH OF 36" OR TO NATIVE SOIL. CONTRACTOR IS RESPONSIBLE TO BACKFILL THESE PLANTING AREAS TO ROUGH FINISHED GRADE WITH CLEAN TOPSOIL FROM AN ON-SITE SOURCE OR AN IMPORTED SOURCE. IF LIMEROCK OR OTHER ADVERSE CONDITIONS OCCUR IN PLANTED AREAS AFTER 36" DEEP EXCAVATION BY THE CONTRACTOR, AND POSITIVE DRAINAGE CAN NOT BE ACHIEVED, CONTRACTOR SHALL UTILIZE POOR DRAINAGE CONDITION PLANTING DETAIL.
- FURNISH NURSERY'S CERTIFICATE OF COMPLIANCE WITH ALL REQUIREMENTS AS SPECIFIED HEREIN. INSPECT AND SELECT PLANT MATERIALS BEFORE PLANTS ARE DUG AT NURSERY OR GROWING SITE.
- COMPLY WITH APPLICABLE FEDERAL, STATE, COUNTY, AND LOCAL REGULATIONS GOVERNING LANDSCAPE MATERIALS AND WORK. CONFORM TO ACCEPTED HORTICULTURAL PRACTICES AS USED IN THE TRADE. UPON ARRIVAL AT THE SITE, PLANTS SHALL BE THOROUGHLY WATERED AND PROPERLY MAINTAINED UNTIL PLANTED. PLANTS STORED ONSITE SHALL NOT REMAIN UNPLANTED OR APPRO PERIOD EXCEEDING TWENTY-FOUR (24) HOURS. AT ALL TIMES WORKMANLIKE METHODS CUSTOMARY IN GOOD HORTICULTURAL PRACTICES
- 6. THE WORK SHALL BE COORDINATED WITH OTHER TRADES TO PREVENT CONFLICTS. COORDINATE PLANTING WITH IRRIGATION WORK TO ASSURE AVAILABILITY OF WATER AND PROPER LOCATION OF IRRIGATION APPURTENANCES AND PLANTS.
- ALL PLANTING PITS SHALL BE EXCAVATED TO SIZE AND DEPTH IN ACCORDANCE WITH THE USA STANDARD FOR NURSERY STOCK 260.1, UNLESS SHOWN OTHERWISE ON THE DRAWINGS. AND BACK FILLED WITH THE PREPARED PLANTING SOIL MIXTURE AS SPECIFIED IN SECTION E. TEST ALL TREE PITS WITH WATER BEFORE PLANTING TO ASSURE PROPER DRAINAGE PERCOLATION IS AVAILABLE. NO ALLOWANCE WILL BE MADE FOR LOST PLANTS DUE TO IMPROPER DRAINAGE. IF POOR DRAINAGE EXISTS, UTILIZE "POOR DRAINAGE CONDITION" PLANTING DETAIL. TREES SHALL BE SET PLUMB AND HELD IN POSITION UNTIL THE PLANTING MIXTURE HAS BEEN FLUSHED INTO PLACE WITH A SLOW, FULL HOSE STREAM. ALL PLANTING SHALL BE PERFORMED BY PERSONNEL FAMILIAR WITH PLANTING PROCEDURES AND UNDER THE SUPERVISION OF A QUALIFIED LANDSCAPE FOREMAN. PROPER "JETTING IN" SHALL BE ASSURED TO ELIMINATE AIR POCKETS AROUND THE ROOTS. "JET STICK" OR EQUAL IS
- 8. TAKE ALL NECESSARY PRECAUTIONS TO AVOID DAMAGE TO BUILDINGS AND BUILDING STRUCTURES WHILE INSTALLING TREES.
- 9. SOIL MIXTURE SHALL BE AS SPECIFIED IN SECTION E OF THESE SPECIFICATIONS.
- 10. TREES AND SHRUBS SHALL BE SET STRAIGHT AT AN ELEVATION THAT, AFTER SETTLEMENT, THE PLANT CROWN WILL STAND ONE (1) TO TWO (2) INCHES ABOVE GRADE. EACH PLANT SHALL BE SET IN THE CENTER OF THE PIT. PLANTING SOIL MIXTURE SHALL BE BACK FILLED, THOROUGHLY TAMPED AROUND THE BALL, AND SETTLED BY WATER (AFTER TAMPING).
- 11. AMEND PINE AND OAK PLANT PITS WITH ECTOMYCORRHIZAL SOIL APPLICATION PER MANUFACTURER'S RECOMMENDATION. ALL OTHER PLANT PITS SHALL BE AMENDED WITH ENDOMYCORRHIZAL SOIL APPLICATION PER MANUFACTURER'S RECOMMENDATION. PROVIDE PRODUCT INFORMATION SUBMITTAL PRIOR TO INOCULATION.
- 12. FILL HOLE WITH SOIL MIXTURE, MAKING CERTAIN ALL SOIL IS SATURATED. TO DO THIS, FILL HOLE WITH WATER AND ALLOW TO SOAK MINIMUM TWENTY (20) MINUTES, STIRRING IF NECESSARY TO GET SOIL THOROUGHLY WET. PACK LIGHTLY WITH FEET, ADD MORE WET SOIL MIXTURE. DO NOT COVER TOP OF BALL WITH SOIL MIXTURE. ALL BURLAP, ROPE, WIRES, BASKETS, ETC.., SHALL BE REMOVED FROM THE SIDES AND TOPS OF BALLS. BUT NO BURLAP SHALL BE PULLED FROM UNDERNEATH.
- PLANT. ALL SOFT WOOD OR SUCKER GROWTH AND ALL BROKEN OR BADLY DAMAGED BRANCHES SHALL BE REMOVED WITH A CLEAN CUT. ALL PRUNING TO BE PERFORMED BY CERTIFIED ARBORIST, IN ACCORDANCE WITH ANSI A-300. 14. SHRUBS AND GROUND COVER PLANTS SHALL BE EVENLY SPACED IN ACCORDANCE WITH THE DRAWINGS AND AS INDICATED ON THE PLANT LIST

13. TREES SHALL BE PRUNED, AT THE DIRECTION OF THE OWNER OR OWNER'S REPRESENTATIVE, TO PRESERVE THE NATURAL CHARACTER OF THE

- MATERIALS INSTALLED SHALL MEET MINIMUM SPECIMEN REQUIREMENTS OR QUANTITIES SHOW ON PLANS, WHICHEVER IS GREATER. CULTIVATE ALL PLANTING AREAS TO A MINIMUM DEPTH OF 6", REMOVE AND DISPOSE ALL DEBRIS. MIX TOP 4" THE PLANTING SOIL MIXTURE AS SPECIFIED IN SECTION E. THOROUGHLY WATER ALL PLANTS AFTER INSTALLATION. 15. TREE GUYING AND BRACING SHALL BE INSTALLED BY THE CONTRACTOR IN ACCORDANCE WITH THE PLANS TO INSURE STABILITY AND MAINTAIN
- TREES IN AN UPRIGHT POSITION. IF THE CONTRACTOR AND OWNER DECIDE TO WAIVE THE TREE GUYING AND BRACING, THE OWNER SHALL NOTIFY THE PROJECT LANDSCAPE ARCHITECT IN WRITING AND AGREE TO INDEMNIFY AND HOLD HARMLESS THE PROJECT LANDSCAPE ARCHITECT IN THE EVENT UNSUPPORTED TREES PLANTED UNDER THIS CONTRACT FALL AND DAMAGE PERSON OR PROPERTY

PRECAUTIONS AND SPECIFICATIONS. PRIOR TO FINAL INSPECTION, TREAT ALL PLANTING BEDS WITH AN APPROVED PRE-EMERGENT HERBICIDE

16. ALL PLANT BEDS SHALL BE KEPT FREE OF NOXIOUS WEEDS UNTIL FINAL ACCEPTANCE OF WORK. IF DIRECTED BY THE OWNER, "ROUND-UP" SHALL BE APPLIED FOR WEED CONTROL BY QUALIFIED PERSONNEL TO ALL PLANTING AREAS IN SPOT APPLICATIONS PER MANUFACTURER'S

- AT AN APPLICATION RATE RECOMMENDED BY THE MANUFACTURER. (AS ALLOWED BY JURISDICTIONAL AUTHORITY) P. LAWN SODDING
- 1. THE WORK CONSISTS OF LAWN BED PREPARATION, SOIL PREPARATION, AND SODDING COMPLETE, IN STRICT ACCORDANCE WITH THE SPECIFICATIONS AND THE APPLICABLE DRAWINGS TO PRODUCE A TURF GRASS LAWN ACCEPTABLE TO THE OWNER.

- ALL AREAS THAT ARE TO BE SODDED SHALL BE CLEARED OF ANY ROUGH GRASS, WEEDS, AND DEBRIS BY MEANS OF A SOD CUTTER TO A DEPTH OF THREE (3) INCHES, AND THE GROUND BROUGHT TO AN EVEN GRADE. THE ENTIRE SURFACE SHALL BE ROLLED WITH A ROLLER WEIGHING NOT MORE THAN ONE-HUNDRED (100) POUNDS PER FOOT OF WIDTH. DURING THE ROLLING, ALL DEPRESSIONS CAUSED BY SETTLEMENT SHALL BE FILLED WITH ADDITIONAL SOIL, AND THE SURFACE SHALL BE REGRADED AND ROLLED UNTIL PRESENTING A SMOOTH AND EVEN FINISH TO THE
- PREPARE LOOSE BED FOUR (4) INCHES DEEP. HAND RAKE UNTIL ALL BUMPS AND DEPRESSIONS ARE REMOVED. WET PREPARED AREA

- a. THE CONTRACTOR SHALL SOD ALL AREAS THAT ARE NOT PAVED OR PLANTED AS DESIGNATED ON THE DRAWINGS WITHIN THE CONTRACT LIMITS, UNLESS SPECIFICALLY NOTED OTHERWISE.
- b. THE SOD SHALL BE CERTIFIED TO MEET STATE REQUIREMENTS & SPECIFICATIONS, ABSOLUTELY TRUE TO VARIETAL TYPE, AND FREE FROM
- c. SOD PANELS SHALL BE LAID TIGHTLY TOGETHER SO AS TO MAKE A SOLID SODDED LAWN AREA. SOD SHALL BE LAID UNIFORMLY AGAINST THE EDGES OF ALL CURBS AND OTHER HARDSCAPE ELEMENTS, PAVED AND PLANTED AREAS. ADJACENT TO BUILDINGS, A 24 INCH STONE MULCH STRIP SHALL BE PROVIDED. IMMEDIATELY FOLLOWING SOD LAYING, THE LAWN AREAS SHALL BE ROLLED WITH A LAWN ROLLER CUSTOMARILY USED FOR SUCH PURPOSES, AND THEN THOROUGHLY IRRIGATED. IF, IN THE OPINION OF THE OWNER, TOP-DRESSING IS NECESSARY AFTER ROLLING TO FILL THE VOIDS BETWEEN THE SOD PANELS AND TO EVEN OUT INCONSISTENCIES IN THE SOD, CLEAN SAND, AS APPROVED BY THE OWNER'S REPRESENTATIVE, SHALL BE UNIFORMLY SPREAD OVER THE ENTIRE SURFACE OF THE SOD AND THOROUGHLY WATERED IN. FERTILIZE INSTALLED SOD AS ALLOWED BY PROPERTY'S JURISDICTIONAL AUTHORITY.
- DURING DELIVERY, PRIOR TO, AND DURING THE PLANTING OF THE LAWN AREAS, THE SOD PANELS SHALL AT ALL TIMES BE PROTECTED FROM EXCESSIVE DRYING AND UNNECESSARY EXPOSURE OF THE ROOTS TO THE SUN. ALL SOD SHALL BE STACKED SO AS NOT TO BE DAMAGED BY SWEATING OR EXCESSIVE HEAT AND MOISTURE.

WEEDS, FUNGUS, INSECTS AND DISEASE OF ANY KIND.

- a. WITHIN THE CONTRACT LIMITS. THE CONTRACTOR SHALL PRODUCE A DENSE, WELL ESTABLISHED LAWN, THE CONTRACTOR SHALL BE RESPONSIBLE FOR THE REPAIR AND RE-SODDING OF ALL ERODED, SUNKEN OR BARE SPOTS (LARGER THAN 12"X12") UNTIL CERTIFICATION OF ACCEPTANCE BY THE OWNER'S REPRESENTATIVE. REPAIRED SODDING SHALL BE ACCOMPLISHED AS IN THE ORIGINAL WORK (INCLUDING
- b. CONTRACTOR RESPONSIBLE FOR ESTABLISHING AND MAINTAINING SOD/LAWN UNTIL ACCEPTANCE BY THE OWNER'S REPRESENTATIVE. PRIOR TO AND UPON ACCEPTANCE, CONTRACTOR TO PROVIDE WATERING/IRRIGATION SCHEDULE TO OWNER. OBSERVE ALL APPLICABLE WATERING RESTRICTIONS AS SET FORTH BY THE PROPERTY'S JURISDICTIONAL AUTHORITY.
- Q. CLEANUP

UPON COMPLETION OF ALL PLANTING WORK AND BEFORE FINAL ACCEPTANCE, THE CONTRACTOR SHALL REMOVE ALL MATERIAL, EQUIPMENT, AND DEBRIS RESULTING FROM HIS WORK. ALL PAVED AREAS SHALL BE CLEANED AND THE SITE LEFT IN A NEAT AND ACCEPTABLE CONDITION AS APPROVED BY THE OWNER'S REPRESENTATIVE.


R. PLANT MATERIAL MAINTENANCE

ALL PLANTS AND PLANTING INCLUDED UNDER THIS CONTRACT SHALL BE MAINTAINED BY WATERING, CULTIVATING, SPRAYING, AND ALL OTHER OPERATIONS (SUCH AS RE-STAKING OR REPAIRING GUY SUPPORTS) NECESSARY TO INSURE A HEALTHY PLANT CONDITION BY THE CONTRACTOR UNTIL CERTIFICATION OF ACCEPTANCE BY THE OWNER'S REPRESENTATIVE.

S. FINAL INSPECTION AND ACCEPTANCE OF WORK

FINAL INSPECTION AT THE END OF THE WARRANTY PERIOD SHALL BE ON PLANTING, CONSTRUCTION AND ALL OTHER INCIDENTAL WORK PERTAINING TO THIS CONTRACT. ANY REPLACEMENT AT THIS TIME SHALL BE SUBJECT TO THE SAME ONE (1) YEAR WARRANTY (OR AS SPECIFIED BY THE LANDSCAPE ARCHITECT OR OWNER IN WRITING) BEGINNING WITH THE TIME OF REPLACEMENT AND ENDING WITH THE SAME INSPECTION AND ACCEPTANCE HEREIN DESCRIBED.

- THE LIFE AND SATISFACTORY CONDITION OF ALL PLANT MATERIAL INSTALLED (INCLUDING SOD) BY THE LANDSCAPE CONTRACTOR SHALL BE WARRANTED BY THE CONTRACTOR FOR A MINIMUM OF ONE (1) CALENDAR YEAR COMMENCING AT THE TIME OF CERTIFICATION OF ACCEPTANCE BY THE OWNER'S REPRESENTATIVE.
- ANY PLANT NOT FOUND IN A HEALTHY GROWING CONDITION AT THE END OF THE WARRANTY PERIOD SHALL BE REMOVED FROM THE SITE AND REPLACED AS SOON AS WEATHER CONDITIONS PERMIT. ALL REPLACEMENTS SHALL BE PLANTS OF THE SAME KIND AND SIZE AS SPECIFIED IN THE PLANT LIST. THEY SHALL BE FURNISHED PLANTED AND MULCHED AS SPECIFIED AT NO ADDITIONAL COST TO THE OWNER.
- IN THE EVENT THE OWNER DOES NOT CONTRACT WITH THE CONTRACTOR FOR LANDSCAPE AND IRRIGATION MAINTENANCE, THE CONTRACTOR SHOULD VISIT THE PROJECT SITE PERIODICALLY DURING THE ONE (1) YEAR WARRANTY PERIOD TO EVALUATE MAINTENANCE PROCEDURES BEING PERFORMED BY THE OWNER. CONTRACTOR SHALL NOTIFY THE OWNER IN WRITING OF MAINTENANCE PROCEDURES OR CONDITIONS WHICH THREATEN VIGOROUS AND HEALTHY PLANT GROWTH. SITE VISITS SHALL BE CONDUCTED A MINIMUM OF ONCE PER MONTH FOR A PERIOD OF TWELVE (12) MONTHS FROM THE DATE OF ACCEPTANCE.

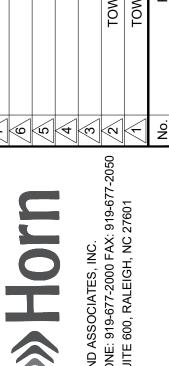




SHEET NUMBER

SDP-23-09

TYPICAL LANDSCAPE SPECIFICATIONS

Schedule								
Symbol	Label	QTY	Manufacturer	Catalog	Number Lamps	Lamp Output	LLF	Input Power
	Α	7	RAB LIGHTING INC.	SLIM12Y/D10	1	2006	0.75	15
	В	130		NF/SP-PROW-120-24V- 3000K	1	180	0.8	2.89861

Statistics							
Description	Symbol	Avg	Max	Min	Max/Min	Avg/Min	
Calc Zone #1	+	0.3 fc	15.3 fc	0.0 fc	N/A	N/A	

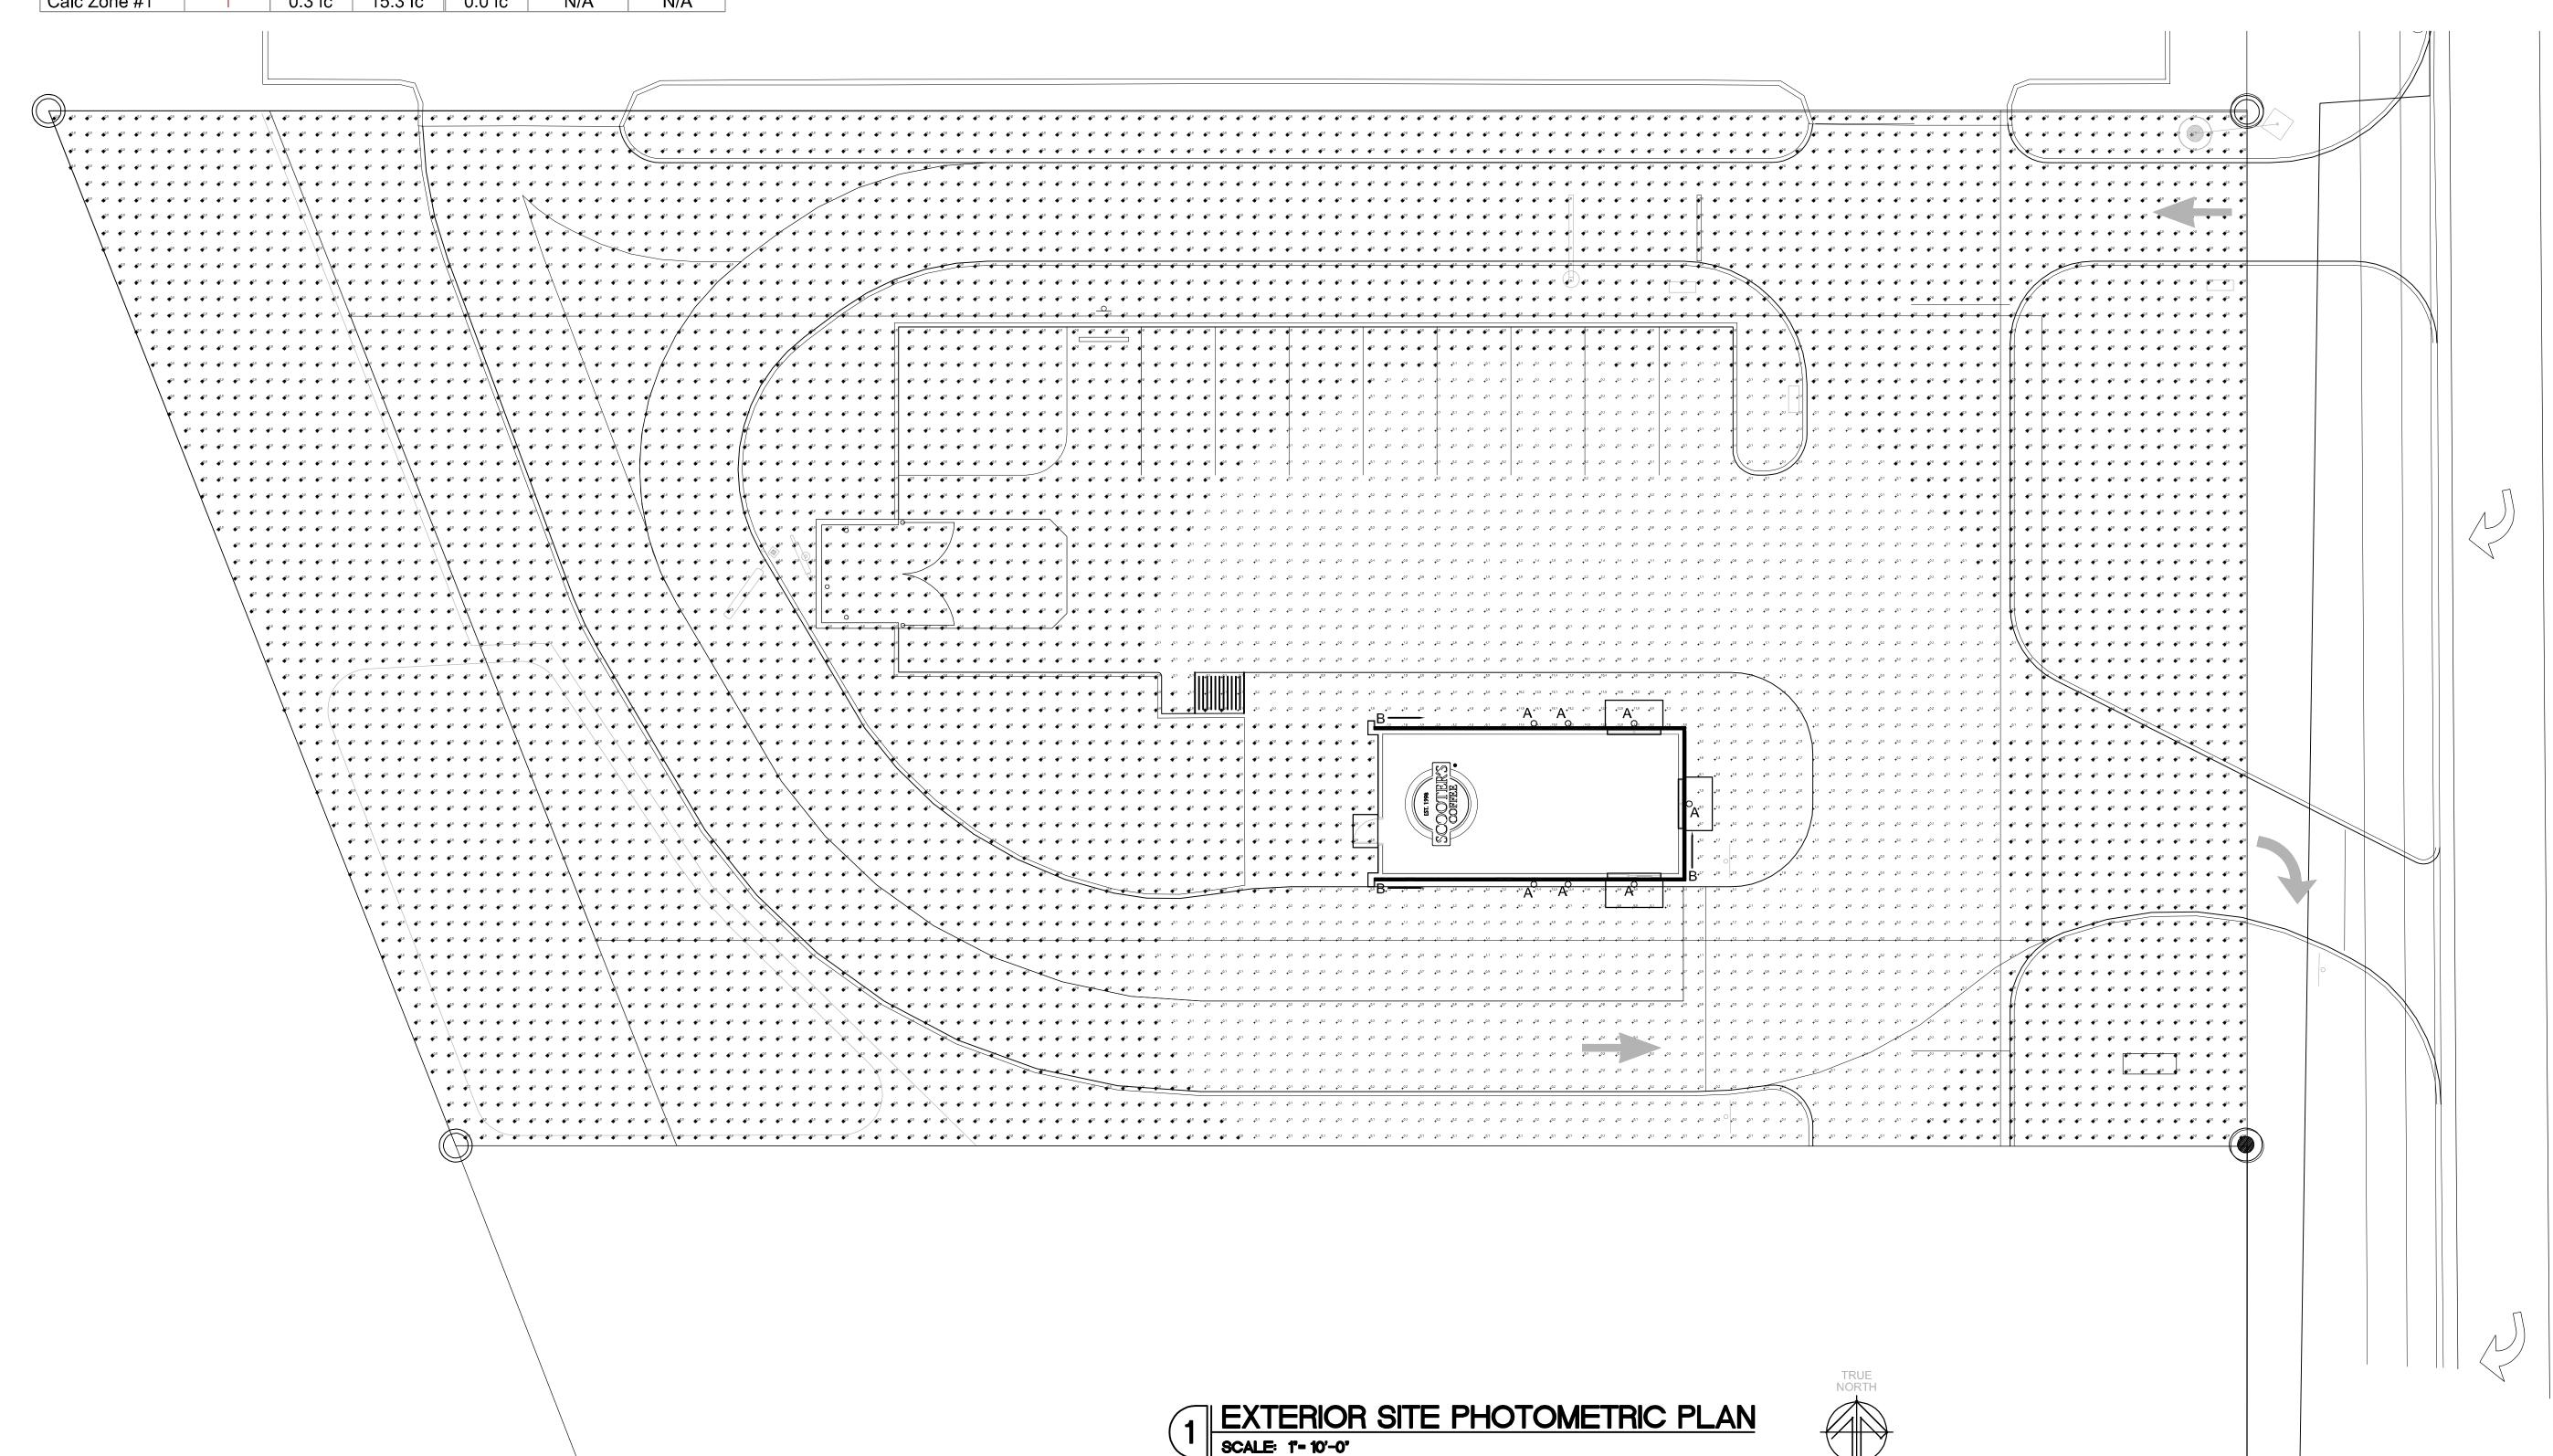

|<del>-</del>|2|8|4|5|9|<del>-</del>|8|0 **EXTERIOR SITE PHOTOMETRIC** PLAN

KIOSK PROTOTYPE: 4.1 PROTOTYPE MAY 2022 **ISSUE DATE:** 08/14/2023 PROJECT NO. 230522 DRAWN BY: CHECKED BY:

			SCOC	TER'S COFFEE LIGHT	ING SCHE	DULE					
			FIXTURE INFORMATION		•		LAMP(S)	ELECTRI	CAL CHARACTE	RISTICS	
TAG	QTY.	MANUFACTURE	DESCRIPTION	MODEL NUMBER	MOUNTIN G	QTY.	VOLTS	WATTS	LAMP BASE TYPE	DIMMER/ TYPE	NOTES
А	7	RAB	EXTERIOR WALL SCONCE	SLIM12Y	WALL	1	120	12	INTEGRATED	0-10V (120V/277V)	
A2	0	RAB	EXTERIOR WALL SCONCE	SLIM18Y	WALL	1	120	18	INTEGRATED	0-10V (120V/277V)	
В	131'	NOVA FLEX	LED STRIP LIGHT	NF/SP-PROW-120-24V- 3000K	SURFACE	1	120	2.9W/FT	INTEGRATED	0-10V	MOUNT IN CHANNEL WITH SOLID LENS FOR 50% LIGHT TRANSMISSION
EM1	4	BEST LIGHTING	MR-16 SEMI-RECESSED THERMOPLASTIC EMERGENCY UNIT.	RMR-16-LED	WALL	1	120	(2) 3.3W	MR-16	N/A	90min: EMERGENCY BATTERY BACKUP MINIMUM
EM2	1	BEST LIGHTING	LED DECORATIVE OUTDOOR DIE-CAST AC/EMERGENCY UNIT.	DBEL-ACEM-HL-B-SDI-CW-PC	WALL	1	120	3	INTEGRATED	N/A	90min. EMERGENCY BATTERY BACKUP MINIMUM
T1	8	AEL	LED 2x4	CB2435MM	RECESSED	1	120/277	40	INTEGRATED	N/A	
EX1	1	BEST LIGHTING	LED EXIT SIGN/EMERGENCY UNIT COMBO	LEDCXTEU-2-R-W	CEILING	1	120/277	3	INTEGRATED	N/A	90min. EMERGENCY BATTERY BACKUP MINIMUM
FL	2	KITCHLER	GROUND MOUNT LED FLAG POLE LIGHT FIXTURE	NSP 10 TO 15 - 16209	STANCHIO N GROUND	1	120/277	3	INTEGRATED	N/A	
PL	SEE NOTE	LITHONIA LIGHTING	LED POLE LIGHT FIXTURE W/FULL CUT-OFF SHIELDING	KAD LED 60C 700 40K R4 MVOLT	POLE	1	120/277	-	INTEGRATED	N/A	COORDINATE WITH CIVIL AND SITE WORK FOR LOT LIGHTING
NOTES:											
			'H LIGHTING MANUFACTURE TO PROVIDE U.L. LABELING D IN AN INSULATED CEILING SHALL BE I.C. RATED	G TO REFLECT ACTUAL LAMP V	VATTAGE USE	D, NOT	MAXIML	JM FIXTU	RE WATTAGE		

LIC	GHTIN	NG CONTRO	DEVICE	SCHE	DULE		
CALLOUT	SYMBOL	MANUFACTURE MODEL NUMBER	UNOBSTRUCTED RATED COVERAGE	MOUNTING	WATTAGE VOLTAGE	TIME DELAY	<u>DESCRIPTION</u>
OCCUPANCY SENSOR SWITCH	\$ <sup>os</sup>	nLIGHT WSX-PDT		WALL	LINE		LINE VOLTAGE SWITCH DUAL TECHNOLOGY SENSOR

WALL

WALL

LINE

LOW

DIMMER SWITCH

TOGGLE SWITCH

1. SENSOR REQUIRES POWER PACK (INSTALL IN ACCESSIBLE LOCATION)

2. SWIVEL MOUNTING BRACKET INCLUDED

"EXIST" DENOTES EXISTING TO REMAIN


3. ELECTRICAL CONTRACTOR SHALL COORDINATE COMPATIBILITY OF LIGHT FIXTURES AND LIGHTING CONTROL DEVICES/ SYSTEM WITH CONTROL SYSTEM SUPPLIER PRIOR TO ORDERING/ROUGH-IN

4. VERIFY POWER REQUIREMENT FOR CEILING SENSOR. IF IT REQUIRES CONTINUOUS HOT, PULL UNDIMMED WIRE FROM

**ACUITY CONTROLS** 

HUBBEL #1221

AHEAD OF DIMMER SWITCH TO CEILING SENSOR FOR SENSOR OPERATING, AND RUN DIMMED LINE THROUGH SENSOR FOR ON/OFF CONTROL. CONFIRM WITH VENDOR PRIOR TO ORDERING SENSOR TO ENSURE COMPATIBILITY.

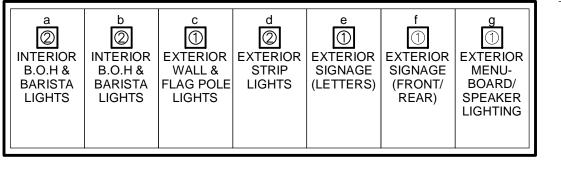

(1) SINGLE POLE SWITCH. ② SINGLE POLE DIMMER SWITCH

SWITCH POD ON/OFF

LINE VOLTAGE PUSH BUTTON

# 3 SWITCH BANK DETAIL SCALE: N.T.S.

SWITCH

DIMMER

DIMMER

SWITCH 'b'

SWITCH 'a'

## – 24 HR/7 DAY ASTRONOMICAL TIME CLOCK INTRAMATIC: ET90815CR - PROVIDE LOCAL DISCONNECTING MEANS AS REQUIRED PER N.E.C. ➤ EXTERIOR SIGNS - FRONT/REAR 0-2 HR ➤ EXTERIOR SIGNS - LETTERS OR → MONUMENT SIGN SWITCH' EXTERIOR WALL AND FLAG LIGHTS EXTERIOR LED STRIP LIGHTS → SHOW WINDOW → DIRECTIONAL SIGN (RESERVED) NORMALLY OPEN (ELECTRONICALLY HELD) LIGHTING CONTACTORS IN APPROVED ENCLOSURE 20A MINIMUM RATED

→ RESTROOM

■ B.O.H & BARISTA

→ B.O.H & BARISTA

2 TIME CLOCK DIAGRAM
SCALE: NOT TO SCALE

## TIMECLOCK SEQUENCE OF OPERATION

IN LOADING AREAS.

MPAIR THE INTENDED ILLUMINATION.

JURISDICTIONAL NOTE

BUILDING FACADE AND ACCENT LIGHTING SHALL BE SELECTED,

THE BUILDING FACADE AND SPILLOVER LIGHT IS NEGLIGIBLE.


PER LDO SECTION 6.6.G.10, FULL CUT-OFF LIGHTING SHALL BE PROVIDED

LOCATED, AIMED AND SHIELDED SO THAT LIGHT IS DIRECTED ONLY ONTO

IGHTING DESIGN SHALL BE COORDINATED WITH THE LANDSCAPE PLAN

O ENSURE THAT VEGETATION GROWTH WILL NOT SUBSTANTIALLY

- EXTERIOR SIGN SHALL TURN ON AT 4:30AM.
- 2. TOILET EXHAUST SHALL TURN ON AT 5AM. EXTERIOR SIGN SHALL TURN OFF 30- MINUTES AFTER SUNRISE. 4. EXTERIOR SIGNAGE SHALL TURN ON 30-MINUTES BEFORE SUNSET.
- 5. TOILET EXHAUST SHALL SHUT OFF AT 10PM.
- 6. EXTERIOR SIGNAGE SHALL TURN OFF AT 10:30PM.
- ALL TIMES ARE ADJUSTABLE.

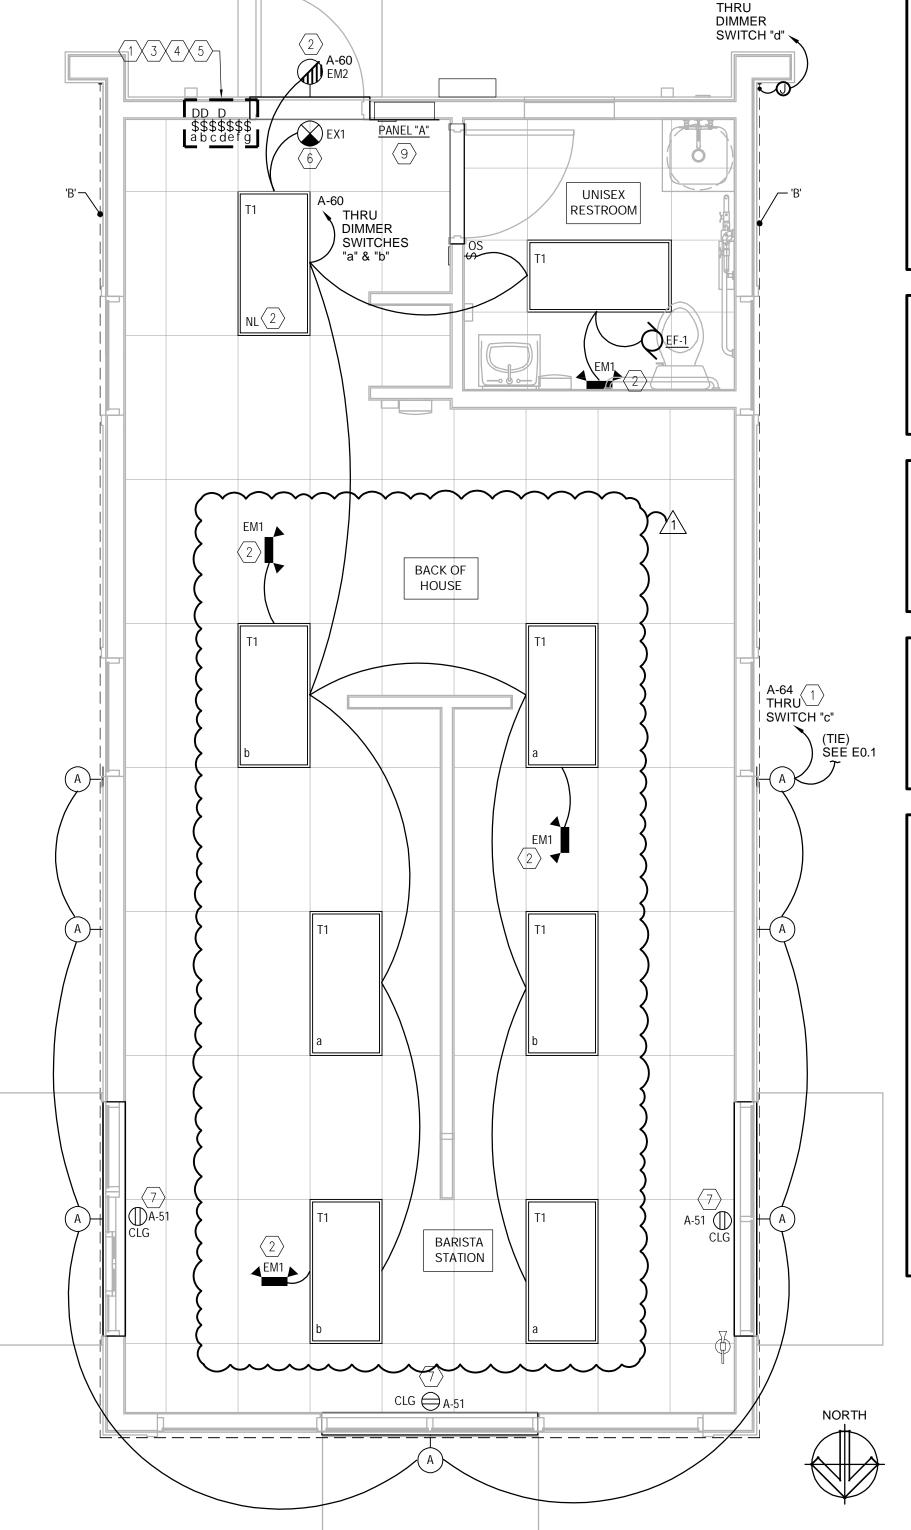

SCALE: 3/8' - 1'-0'

## LIGHTING GENERAL NOTES

- ELECTRICAL CONTRACTOR SHALL FIELD VERIFY ALL EXISTING CONDITIONS PRIOR TO BASE BID. IN CASE OF ANY DISCREPANCIES WITH EXISTING FIELD CONDITIONS, ELECTRICAL CONTRACTOR SHALL VERIFY THE EXACT DIFFERENCE FOR POSSIBLE REVISIONS TO THIS
  - INSTALL RECESSED LUMINAIRES USING ACCESSORIES AND FIRE STOPPING MATERIALS TO MEET REGULATORY REQUIREMENTS FOR FIRE RATING.
- COORDINATE ALL EXTERIOR BUILDING MOUNTED LIGHT FIXTURES WITH ARCHITECTURAL BUILDING ELEVATIONS FOR HEIGHTS AND LOCATIONS.
- PROVIDE EXIT SIGNS FOR ALL EXISTS DESIGNATED BY THE CODE STUDY PLAN. REFER TO ARCHITECTURAL CODE PLANS FOR LOCATIONS AND REQUIREMENTS.
- CONDUIT AND WIRING SHOWN FOR REFERENCE ONLY. IT IS THE RESPONSIBILITY OF THE ELECTRICAL CONTRACTOR TO PROVIDE THE NUMBER OF CONDUCTOR REQUIRED FOR HOT-LEGS, NEUTRAL AND GROUNDING AT EACH DEVICE FOR PROPER BRANCH CIRCUITING SHOWN FOR EACH AREA OR ROOM.
- ALL EMERGENCY/EXIT FIXTURES AND ARE TO BE PROVIDED WITH MINIMUM 90 MIN EMERGENCY BATTERY BACK-UP. BYPASS ENERGY MANAGEMENT SYSTEM WHERE REQUIRED.
- WHEN REQUIRED, IT IS THE OWNER'S RESPONSIBILITY TO CONTRACT WITH A COMMISSIONING AUTHORITY TO COMPLY WITH LOCAL
- THIS DRAWING IS TO BE READ IN CONJUNCTION WITH ALL OTHER DISCIPLINES DRAWINGS. ANY DISCREPANCIES ARE TO BE BROUGHT TO THE ATTENTION OF THE ARCHITECTS AND ENGINEERS PRIOR TO FINAL BID CLOSING.

## **GENERAL NOTE**

PROVIDE STRUCTURE ENGINEERING LETTER OF APPROVAL FOR SEISMIC INSTALLATION SUPPORT PRIOR TO INSTALLATION AND AT COMMISSIONING STAGE. ALL EQUIPMENT SEISMIC SUPPORT AND INSTALLATION METHOD MUST BE SUBMITTED TO STRUCTURE ENGINEERING APPROVAL PRIOR TO INSTALLATION.

# LIGHTING CONTROL EXEMPTION

PER IECC 505.2.2 ADDITIONAL CONTROLS.. 505.2.2.1 LIGHT REDUCTION CONTROLS EXEMPTION #5: SPACES THAT USE LESS THAN 0.6 WATTS PER SQUARE FOOT (6.5 W/m2).

(8 FIXTURES X 40-WATTS) 320 / TOTAL SQ/FT 680 = 0.47 Watts per square foot

# AUTOMATIC CONTROL EXEMPTION

PER IECC 505.2.2 ADDITIONAL CONTROLS..

505.2.2.2 AUTOMATIC LIGHTING SHUTOFF BUILDINGS LARGER THAN 5,000 SQUARE FEET (465m2) SHALL BE EQUIPPED WITH AN AUTOMATIC LIGHTING CONTROL DEVICE.

TOTAL BUILDING 680 SQFT = < 5,000 SQFT = NO AUTO CONTROL REQUIRED

## LIGHTING PLAN KEYED NOTES (X

PROVIDE DIMMING SWITCH ON WALL FOR EXTERIOR LED STRIP LIGHTING. COORDINATE EXACT LOCATION WITH OWNER/ ARCHITECT PRIOR TO INSTALLATION.

- NITE-LITE/EMERGENCY EGRESS LIGHT SHALL BE CIRCUITED TO UNSWITCHED LEG OF LOCAL LIGHT CIRCUIT.
- PROVIDE LIGHT SWITCH ON WALL FOR EXTERIOR WALL/ SITE FIXTURE. COORDINATE EXACT LOCATION WITH OWNER/ ARCHITECT PRIOR TO INSTALLATION
- PROVIDE SWITCH ON WALL FOR ILLUMINATED MONUMENT SIGN AND BUILDING SIGNS COORDINATE EXACT LOCATION WITH OWNER/ ARCHITECT PRIOR TO INSTALLATION.
- PROVIDE SWITCH ON WALL FOR ILLUMINATED MENU BOARD/ SPEAKER. COORDINATE EXACT LOCATION WITH OWNER/ ARCHITECT PRIOR TO INSTALLATION. VERIFY EXACT POWER REQUIREMENTS PRIOR TO ROUGH-IN.
- EXIT LIGHT SHALL BE CIRCUITED TO UNSWITCHED LEG OF LOCAL LIGHT CIRCUIT. PROVIDE CHEVRONS AS NEEDED.
- SHOW WINDOWS RECEPTACLE TO BE INSTALLED PER N.E.C. 210.62 & 220.14(G).

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**ELECTRICAL** LIGHTING PLAN & DETAILS

KIOSK PROTOTYPE: 4.1 PROTOTYPE MAY 2022

ISSUE DATE: 08/14/2023 PROJECT NO.

230522 DRAWN BY:

CHECKED BY:

SHEET NO.




4 DRIVE THRU SIDE EXTERIOR ELEVATION

SCALE: 1/4" = 1'-0"



FRONT EXTERIOR ELEVATION



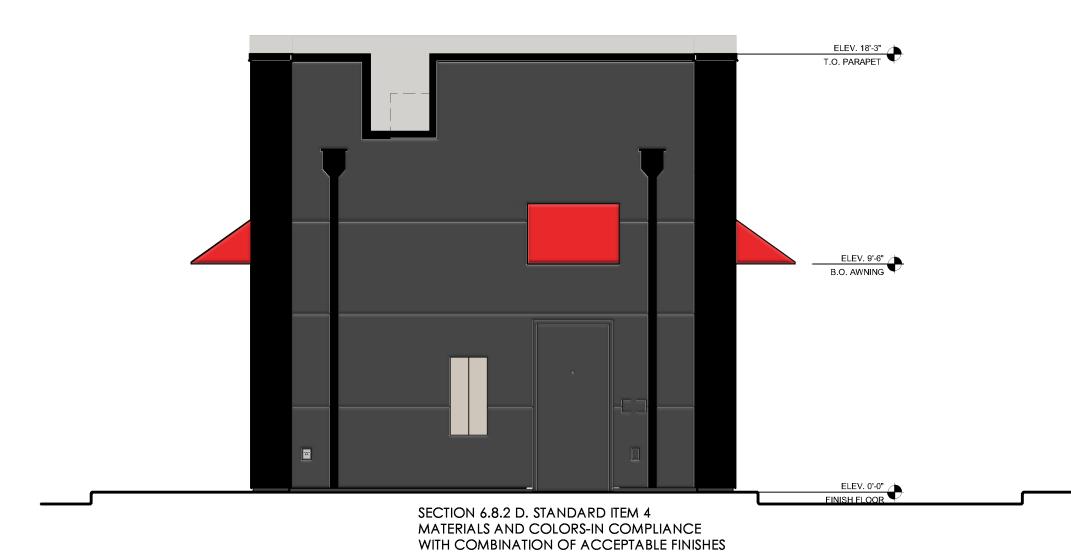

BACK EXTERIOR ELEVATION


| SCALE: 1/4" = 1'-0"

MATERIALP	ERCENTAC	SES
DRIVE THRU SIDE	EXTERIOR ELE	VATION
TOTAL WALL AREA	723 SQ. FT.	100%
STUCCO - INKWELL	0 SQ. FT.	0%
STUCCO - SKYLINE STEEL	1441 SQ. FT.	199%
CARBON LEDGE STONE	252 SQ. FT.	35%
FIBERON COMPOSITE CLADDING	147 SQ. FT.	20%
FENESTRATION	95 SQ. FT.	13%
TRIMS	74 SQ. FT.	10%
_		

MATERIALP	ERCENTAC	SES
BACK EXTER	RIOR ELEVATIO	N
TOTAL WALL AREA	357 SQ. FT.	100%
STUCCO - INKWELL	250 SQ. FT.	70%
STUCCO - SKYLINE STEEL	0 SQ. FT.	0%
CARBON LEDGE STONE	0 SQ. FT.	0%
FIBERON COMPOSITE CLADDING	0 SQ. FT.	0%
DOOR	24 SQ. FT.	7%
TRIMS	83 SQ. FT.	23%
	•	

MATERIALP	PERCENTAC	GES
FRONT EXTE	RIOR ELEVATION	NC
TOTAL WALL AREA	347 SQ. FT.	100%
STUCCO - INKWELL	0 SQ. FT.	0%
STUCCO - SKYLINE STEEL	0 SQ. FT.	0%
CARBON LEDGE STONE	162 SQ. FT.	47%
FIBERON COMPOSITE CLADDING	36 SQ. FT.	10%
FENESTRATION	113 SQ. FT.	33%
TRIMS	36 SQ. FT.	10%

ERCENTAC IOR ELEVATION 723 SQ. FT.	N
723 SQ. FT.	4000/
	100%
0 SQ. FT.	0%
144 SQ. FT.	20%
252 SQ. FT.	35%
147 SQ. FT.	20%
95 SQ. FT.	13%
74 SQ. FT.	10%
	144 SQ. FT. 252 SQ. FT. 147 SQ. FT. 95 SQ. FT.

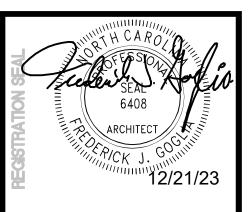

SK J. GOGLIA

ILCT, NCARB, RDI
AIG ROAD, SUITE 300
ST.



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 12/15/23 EXTERIOR REVISION
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EXTERIOR
COLOR
ELEVATIONS

6 S. MAIN ST.

OLESVILLE, NC 27571

ANCHISEE & STORE NUMBER:

COOTER'S COFFEE #562


S. JAVA FNTFRPRISES INC.

KIOSK PROTOTYPE:
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230522
DRAWN BY:
ANG, MD
CHECKED BY:

SHEET NO.

MD

A2.0

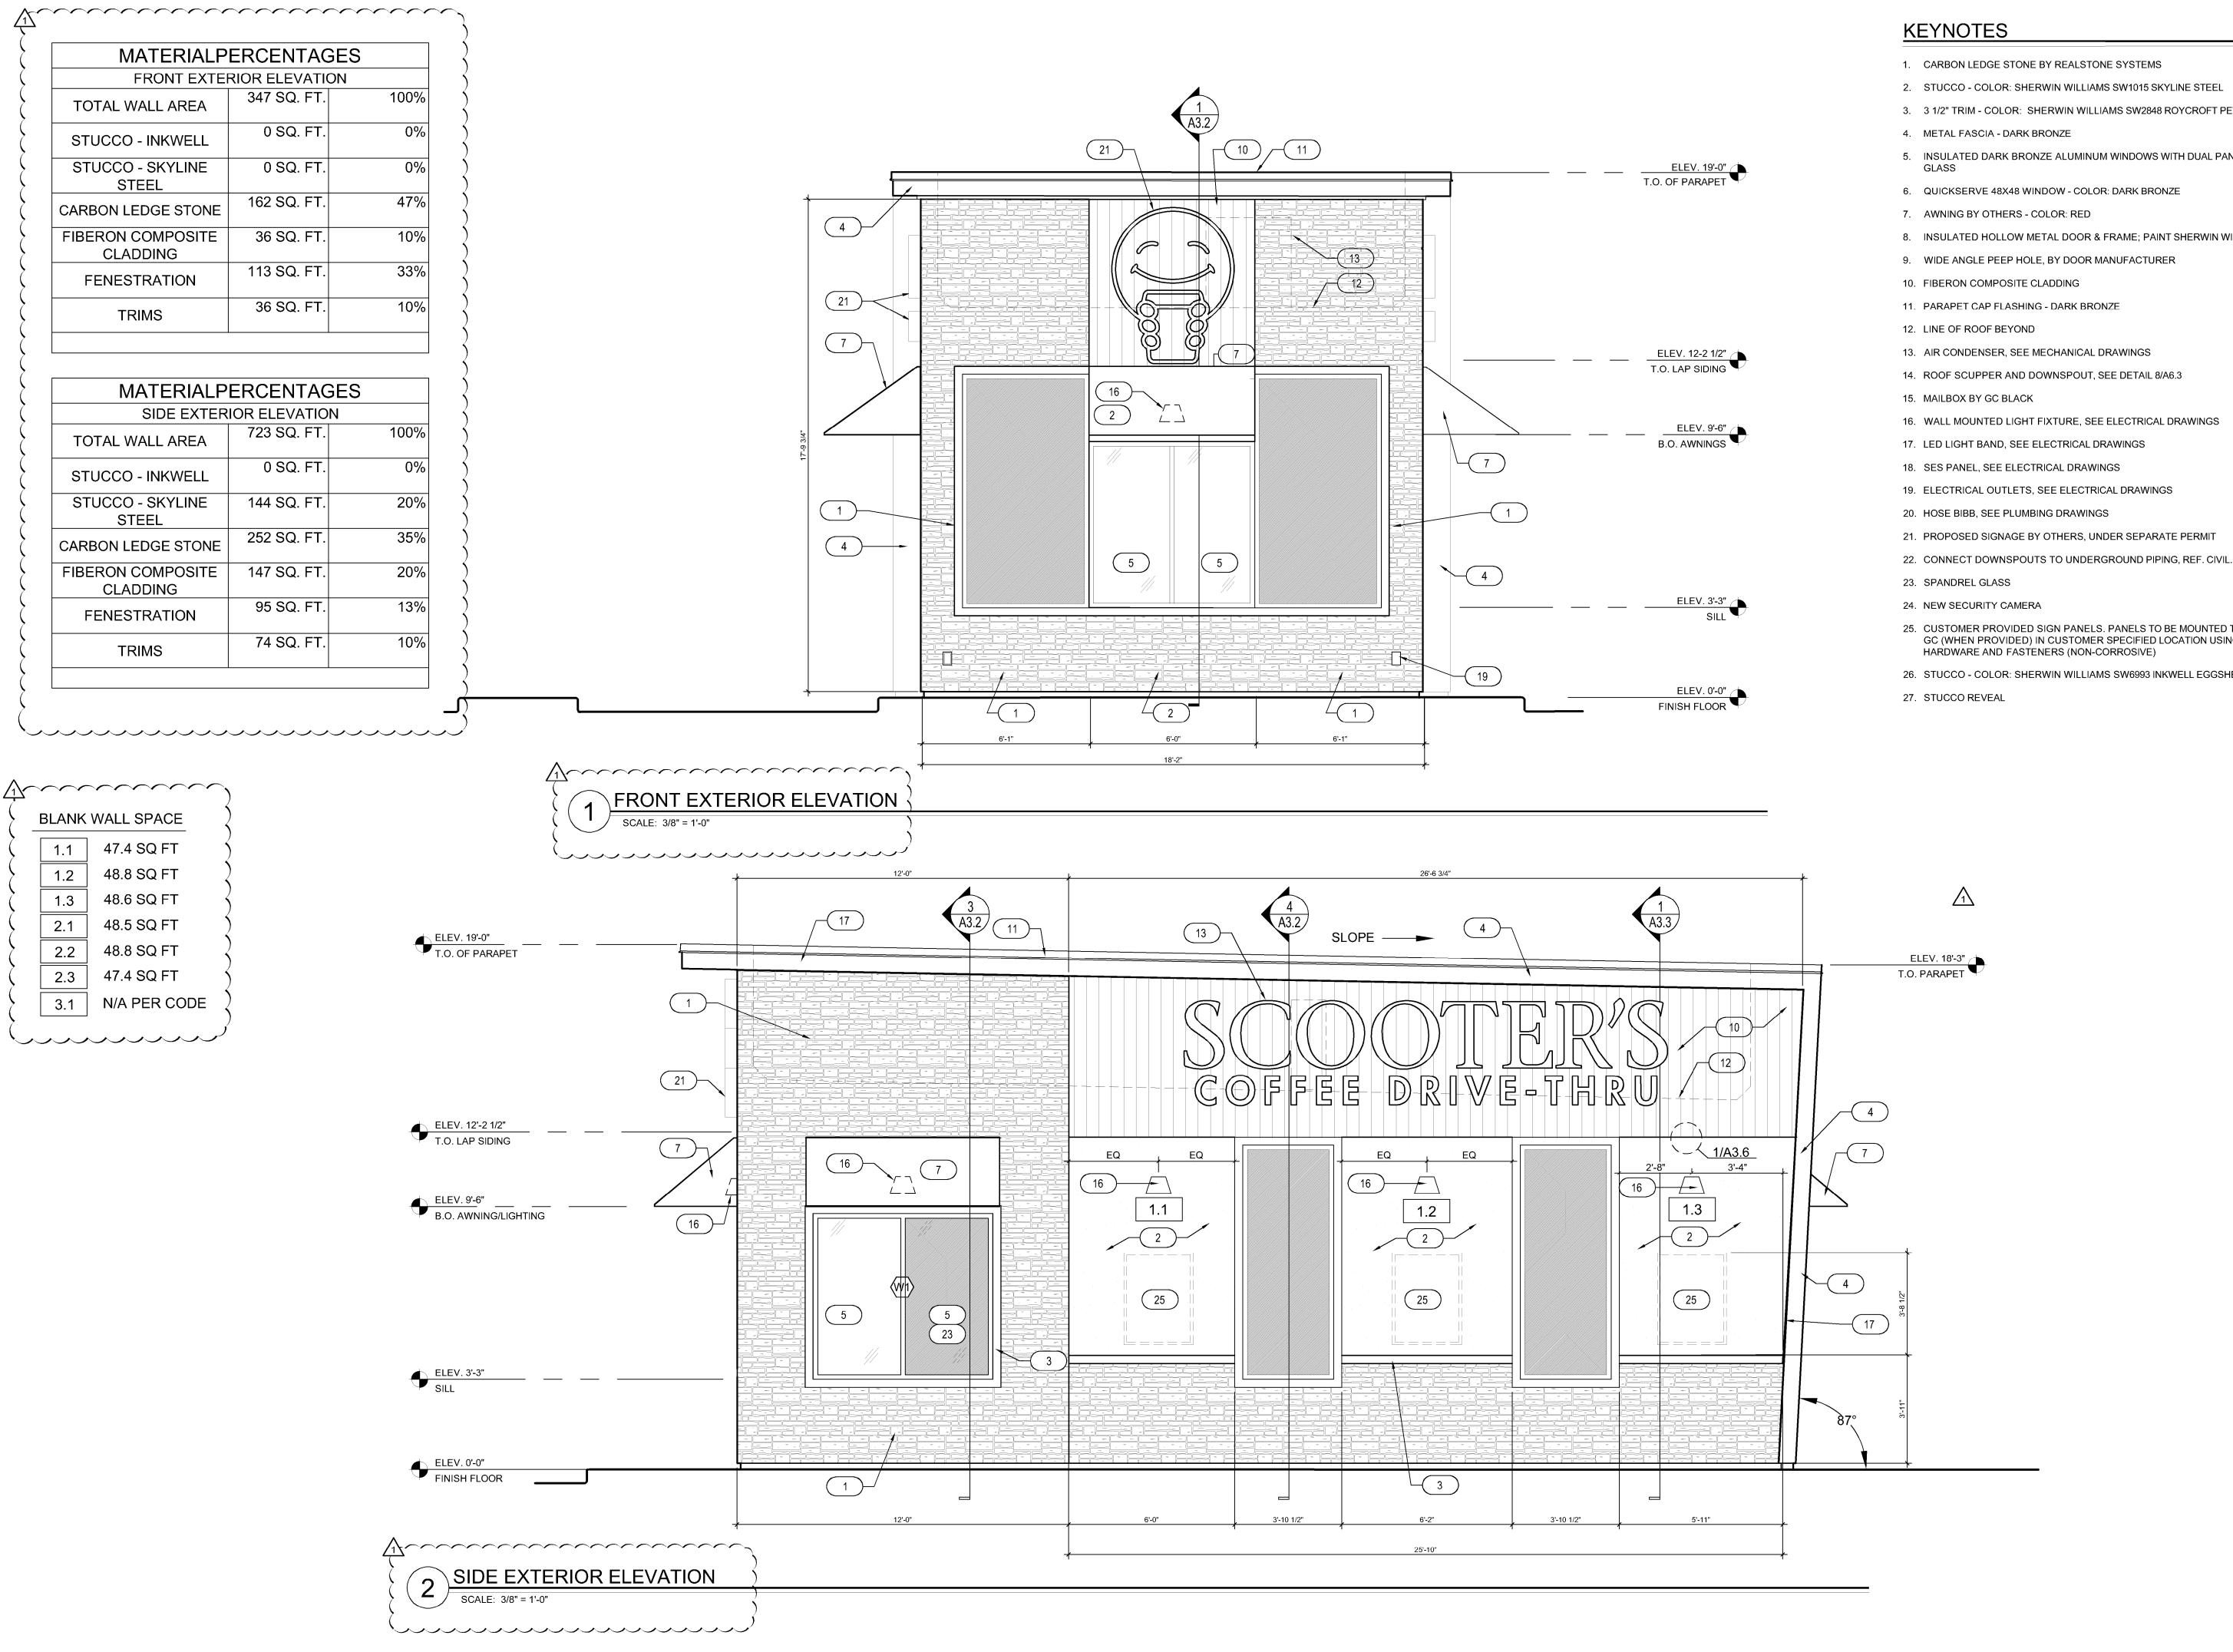

1. CARBON LEDGE STONE BY REALSTONE SYSTEMS



3. 3 1/2" TRIM - COLOR: SHERWIN WILLIAMS SW2848 ROYCROFT PEWTER

5. INSULATED DARK BRONZE ALUMINUM WINDOWS WITH DUAL PANE TEMPERED

6. QUICKSERVE 48X48 WINDOW - COLOR: DARK BRONZE

8. INSULATED HOLLOW METAL DOOR & FRAME; PAINT SHERWIN WILLIAMS SW6992

13. AIR CONDENSER, SEE MECHANICAL DRAWINGS

25. CUSTOMER PROVIDED SIGN PANELS. PANELS TO BE MOUNTED TO FASCIA BY GC (WHEN PROVIDED) IN CUSTOMER SPECIFIED LOCATION USING PROPER

26. STUCCO - COLOR: SHERWIN WILLIAMS SW6993 INKWELL EGGSHELL FINISH

"12/21/23


TITLE: EXTERIOR ELEVATIONS

FRANCHISEE & STORE NUMBER: SCOOTER'S COFFEE #562 P&S JAVA ENTERPRISES, INC PROJECT ADDRESS: 306 S. MAIN ST. ROLESVILLE, NC 27571

KIOSK PROTOTYPE: 4.1 PROTOTYPE MAY 2022 ISSUE DATE: 08/14/2023 PROJECT NO. 230522 DRAWN BY: NES, ANG CHECKED BY: SW

SHEET NO.


A2.1

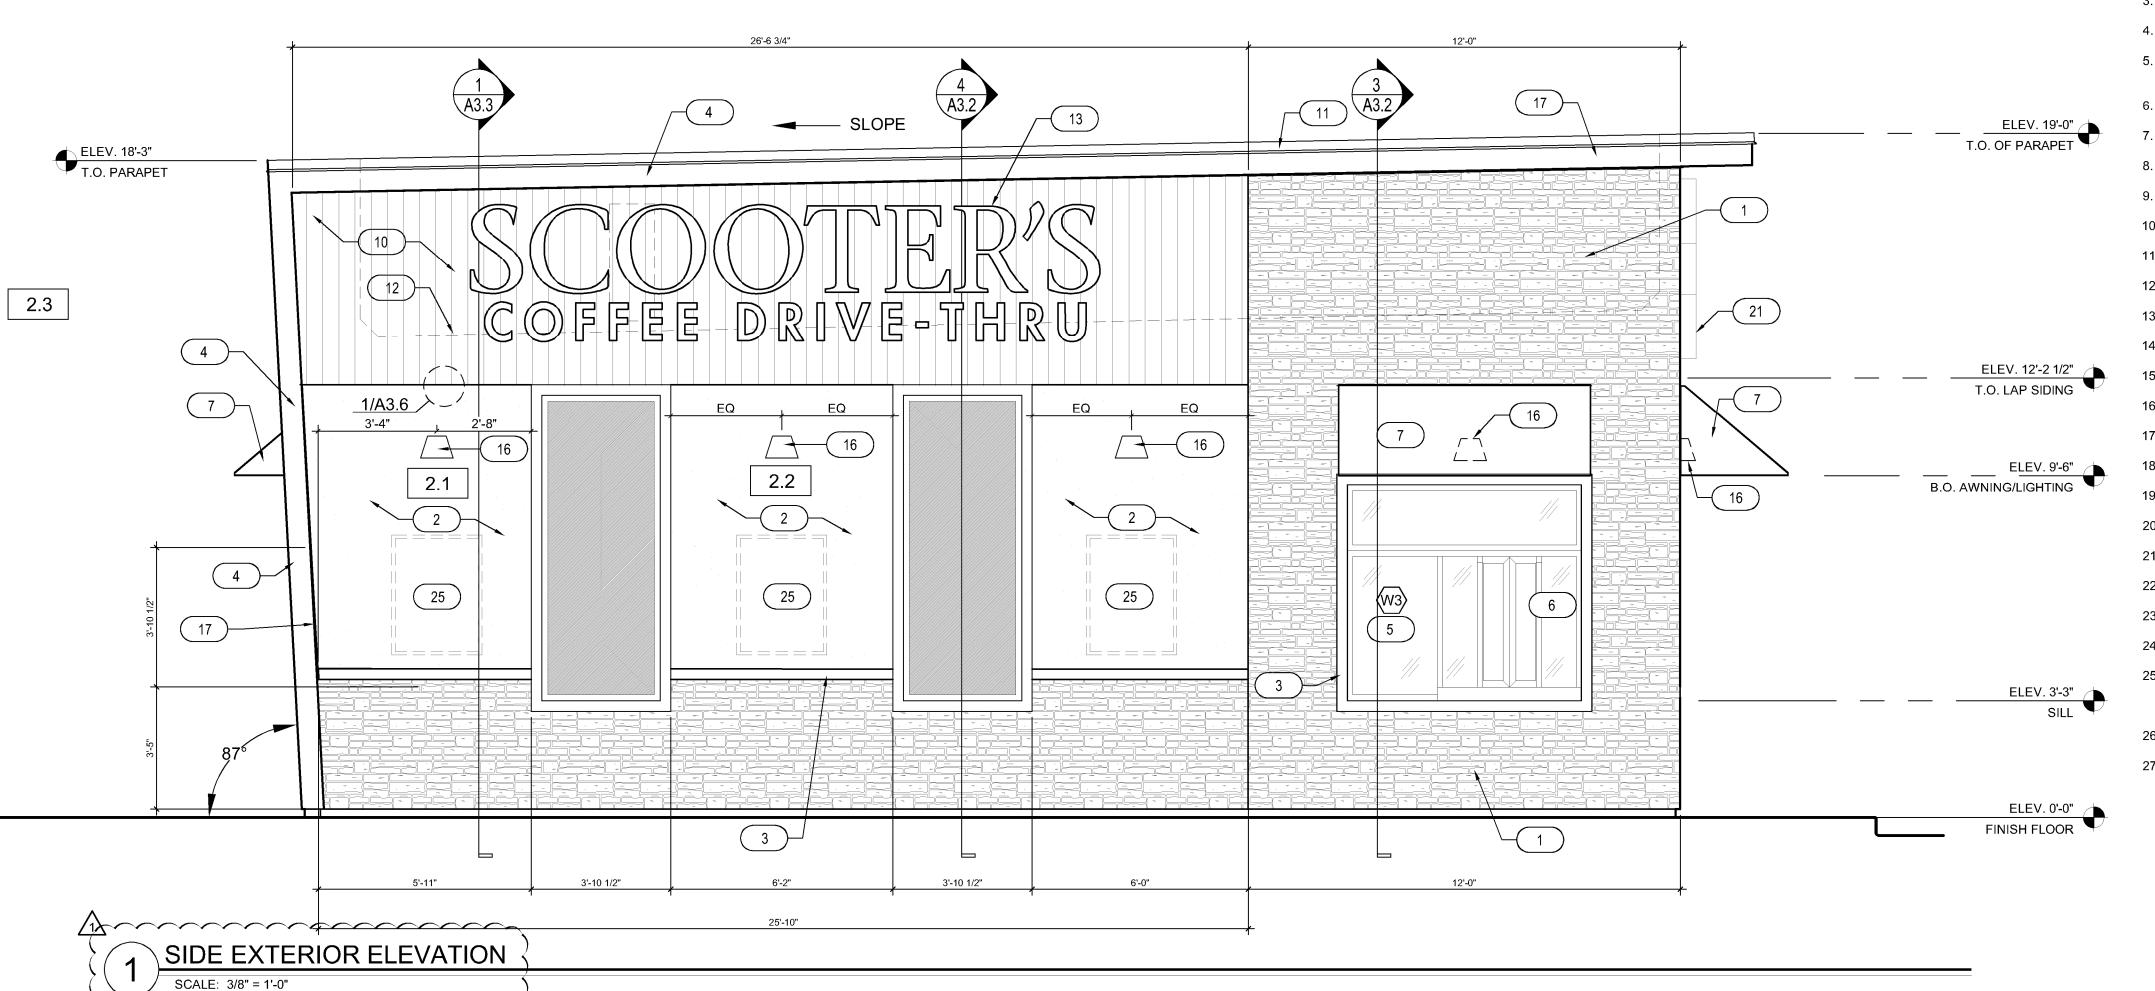

$\Delta$			<b>\</b>
( _	BLANK	WALL SPACE	
<b>\</b>	1.1	47.4 SQ FT	3
	1.2	48.8 SQ FT	$\mathcal{L}$
	1.3	48.6 SQ FT	3
	2.1	48.5 SQ FT	$\mathcal{L}$
	2.2	48.8 SQ FT	$\langle \cdot \rangle$
	2.3	47.4 SQ FT	$\frac{1}{2}$
	3.1	N/A PER CODE	)
			,}

MATERIALP	ERCENTAG	ES
DRIVE THRU SIDE I	EXTERIOR ELE\	/ATION
TOTAL WALL AREA	723 SQ. FT.	100%
STUCCO - INKWELL	0 SQ. FT.	0%
STUCCO - SKYLINE STEEL	1441 SQ. FT.	199%
CARBON LEDGE STONE	252 SQ. FT.	35%
FIBERON COMPOSITE CLADDING	147 SQ. FT.	20%
FENESTRATION	95 SQ. FT.	13%
TRIMS	74 SQ. FT.	10%

	ERCENTAGES	
BACK EXTER	IOR ELEVATION	
TOTAL WALL AREA	357 SQ. FT.	100%
STUCCO - INKWELL	250 SQ. FT.	70%
STUCCO - SKYLINE STEEL	0 SQ. FT.	0%
CARBON LEDGE STONE	0 SQ. FT.	0%
FIBERON COMPOSITE CLADDING	0 SQ. FT.	0%
DOOR	24 SQ. FT.	7%
TRIMS	83 SQ. FT.	23%

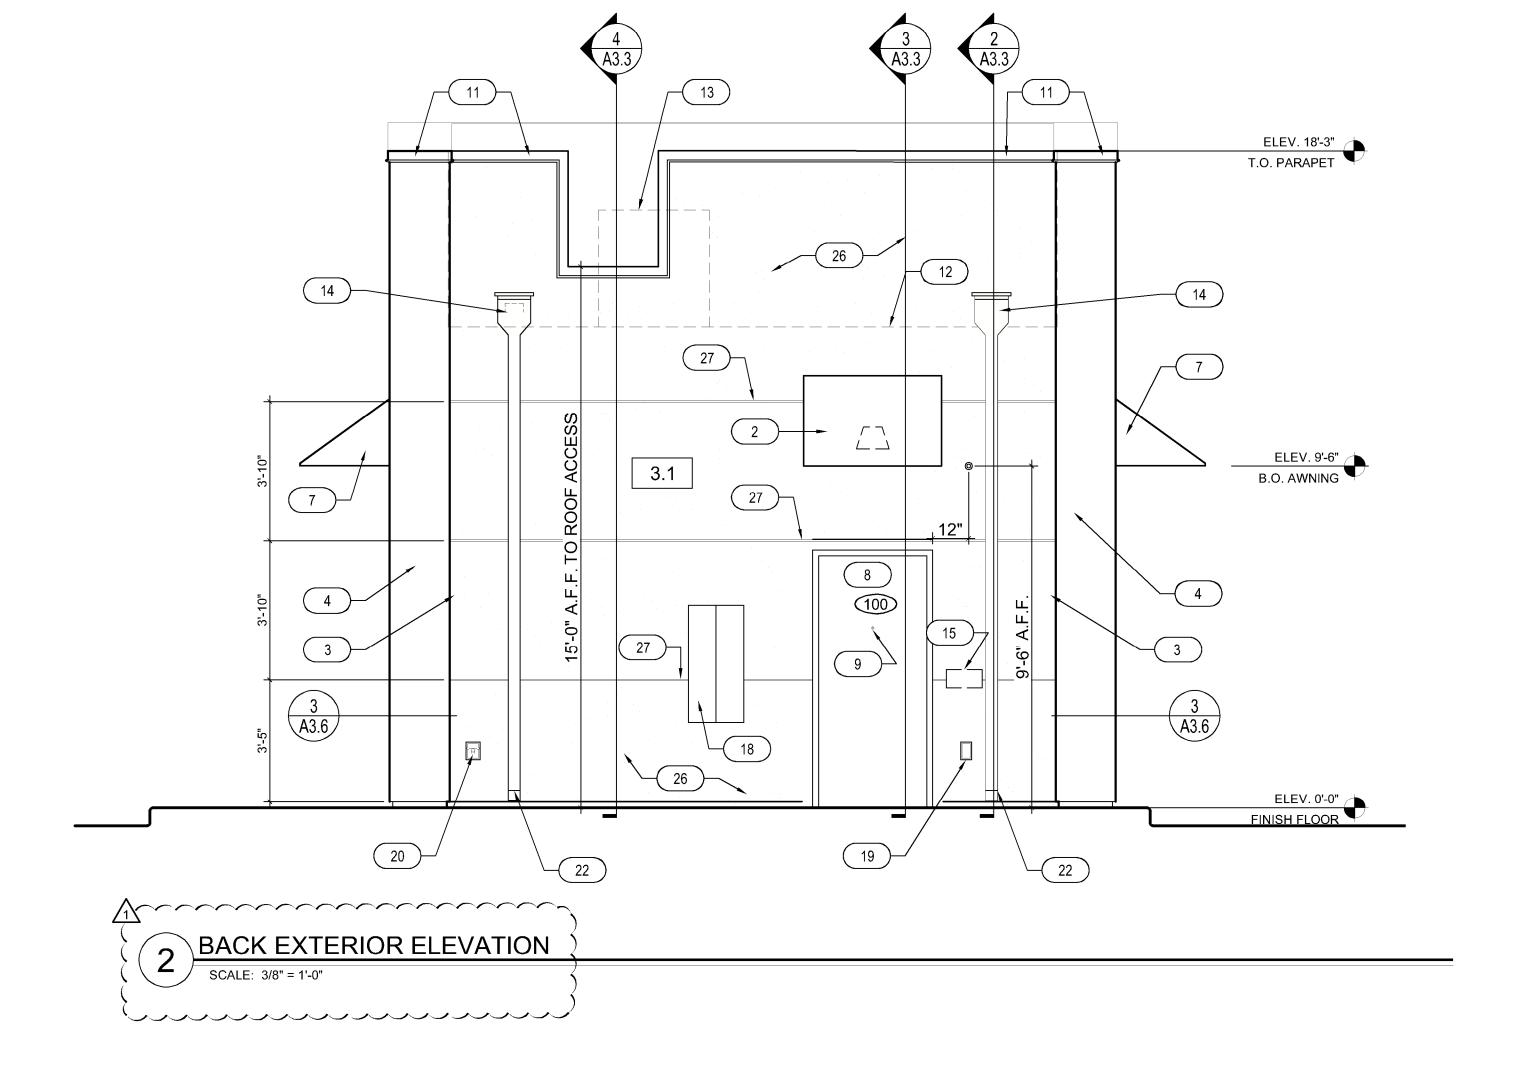

## **KEYNOTES**

- 1. CARBON LEDGE STONE BY REALSTONE SYSTEMS
- 2. STUCCO COLOR: SHERWIN WILLIAMS SW1015 SKYLINE STEEL
- 3. 3 1/2" TRIM COLOR: SHERWIN WILLIAMS SW2848 ROYCROFT PEWTER
- 4. METAL FASCIA DARK BRONZE
- 5. INSULATED DARK BRONZE ALUMINUM WINDOWS WITH DUAL PANE TEMPERED GLASS
- 6. QUICKSERVE 48X48 WINDOW COLOR: DARK BRONZE
- 7. AWNING BY OTHERS COLOR: RED
- 8. INSULATED HOLLOW METAL DOOR & FRAME; PAINT SHERWIN WILLIAMS SW6992
- 9. WIDE ANGLE PEEP HOLE, BY DOOR MANUFACTURER
- 10. FIBERON COMPOSITE CLADDING
- 11. PARAPET CAP FLASHING DARK BRONZE
- 12. LINE OF ROOF BEYOND
- 13. AIR CONDENSER, SEE MECHANICAL DRAWINGS
- 14. ROOF SCUPPER AND DOWNSPOUT, SEE DETAIL 8/A6.3
- 15. MAILBOX BY GC BLACK
- 16. WALL MOUNTED LIGHT FIXTURE, SEE ELECTRICAL DRAWINGS
- 17. LED LIGHT BAND, SEE ELECTRICAL DRAWINGS
- 18. SES PANEL, SEE ELECTRICAL DRAWINGS
- 19. ELECTRICAL OUTLETS, SEE ELECTRICAL DRAWINGS
- 20. HOSE BIBB, SEE PLUMBING DRAWINGS
- 21. PROPOSED SIGNAGE BY OTHERS, UNDER SEPARATE PERMIT
- 22. CONNECT DOWNSPOUTS TO UNDERGROUND PIPING, REF. CIVIL.
- 23. SPANDREL GLASS
- 24. NEW SECURITY CAMERA
- 25. CUSTOMER PROVIDED SIGN PANELS. PANELS TO BE MOUNTED TO FASCIA BY GC (WHEN PROVIDED) IN CUSTOMER SPECIFIED LOCATION USING PROPER HARDWARE AND FASTENERS (NON-CORROSIVE)
- 26. STUCCO COLOR: SHERWIN WILLIAMS SW6993 INKWELL EGGSHELL FINISH
- 27. STUCCO REVEAL




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12/21/23

CK J. GOGLI RDI 300 ST. LOUIS, MO 6

ARCHITECT, NCARB, RD 1950 CRAIG ROAD, SUITE 300 PH. (314) 415-2400 FAX (



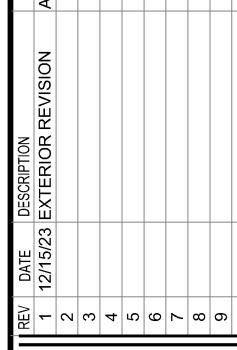

EXTERIOR ELEVATIONS

16 S. MAIN ST.

DLESVILLE, NC 27571

ANCHISEE & STORE NUMBER:

COOTER'S COFFEE #562

S JAVA ENTERPRISES. INC

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A2.2